150 GRANT AVE / 123 SHERMAN AVE / 2501 PARK BLVD PALO ALTO, CA



PLANNING RESUBMITTAL #2 02.04.2022

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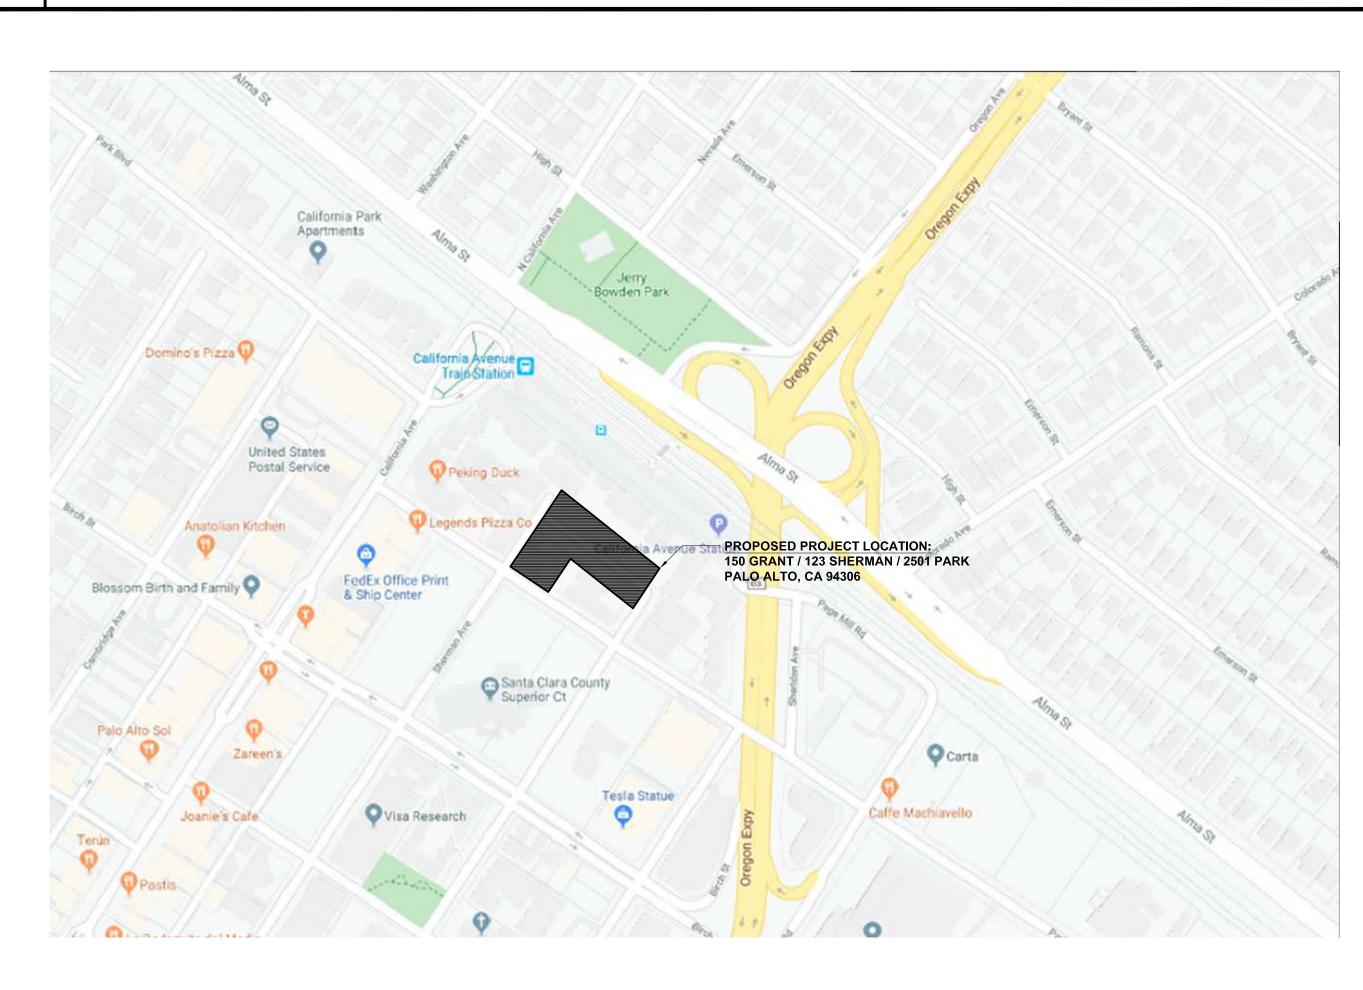
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PROJECT INFORMATION / ZONING COMPLIANCE **ZONING:** CC(2)(R) REGIONAL / COMMUNITY COMMERCIAL SUBDISTRICT (2) / RETAIL (COMBINING) BIKE PARKING REQUIRED (PAMC 18.52.040 TABLE 1 REQUIREMENTS): 1/2,500 SF OFFICE (20 BIKES FOR 48,074 SF, 80% (16) LONG-TERM + 20% (4) SHORT-TERM) 1/2,000 SF RETAIL / PERMITTED USES (2 BIKES FOR 3,871 SF, 20% (1) LONG-TERM + 80% (1) SHORT-TERM) **APNS:** 150 GRANT AVE (124-29-020), 123 SHERMAN AVE (124-29-013), 2501 PARK BLVD (124-29-012) LAND USE (PAMC 18.16.040 TABLE 1): SHORT-TERM (RACKS) BIKE PARKING REQUIRED = 5 BIKES PROFESSIONAL & GENERAL BUSINESS OFFICES LONG-TERM (SECURED ENCLOSURE) BIKE PARKING REQUIRED = 17 BIKES MEDICAL OFFICES (<5,000 SF) RETAIL INCLUDING EAT-IN RESTAURANTS **BIKE PARKING REQUIRED (CGC REQUIREMENTS):** SHORT-TERM (RACKS) FOR 5% OF PARKING TO BE PROVIDED PER CGC 5.106.4.1.1 (E) LOT AREA: 150 GRANT AVE: 26,143 SF 9 BIKES REQ. (5% OF 172 STALLS) 123 SHERMAN AVE: 3,111 SF 2501 PARK BLVD: 5,130 SF LONG-TERM (SECURED ENCLOSURE WITHIN GROUND FLOOR PARKING AREA) FOR 5% OF PARKING **TOTAL SITE AREA: 34,384 SF** TO BE PROVIDED PER CGC 5.106.4.1.2 = 9 BIKES REQ. (5% OF 172 STALLS) MAX. SITE COVERAGE (PAMC 18.16.060 TABLE 3): NONE REQUIRED BIKE PARKING PROVIDED (BASED ON MOST-STRINGENT PER ABOVE): 45% EXISTING (15,523 SF / 34,384 SF) SHORT-TERM (RACKS) BIKE PARKING PROVIDED: 16 BIKES / 8 DUAL RACKS (SEE L1.1 & A2.1) LONG-TERM (SECURED ENCLOSURE) BIKE PARKING PROVIDED: 17 BIKES (SEE A2.1) 86% PROPOSED (29,681 SF / 34,384 SF) MAX. BUILDING HEIGHT (PAMC 18.16.060 TABLE 3): 37' MAX ALLOWED / PROPOSED (3 STORIES) (SEE A3.- BUILDING ELEVATIONS / SECTIONS FOR MORE INFORMATION / DIMENSIONS) SETBACKS (PAMC 18.16.060 TABLE 3): FRONT YARD (PARK BLVD): 0-10' TO CREATE AN 8'-12' EFFECTIVE SIDEWALK WIDTH 2'-31.5' PROVIDED (GROUND FLOOR) & 0' AT FLOORS 2/3 ABOVE, WITH AN EFFECTIVE 7'-6" ± SIDEWALK WIDTH (TO MATCH ADJACENT PROPERTY AT 2555 PARK RECENTLY REDEVELOPED) REAR YARD: NONE REQUIRED* / 10' PROVIDED (P2 - FLOOR 1) & 20' PROVIDED (FLOORS 2-3) INTERIOR SIDE YARDS: NONE REQUIRED / 0' - 1' PROVIDED AS NEEDED FOR CONSTRUCTABILITY (ALL LEVELS) STREET SIDE YARDS (SHERMAN AVE / GRANT AVE): NONE REQUIRED* 0' PROVIDED (FLOORS 2-3), PORTION OPPOSITE CC(2)(R) ONLY) @ SHERMAN AVE. 10' MIN. REQ.* / PROVIDED (ENTIRE P2 - FLOOR 1 & FLOORS 2-3 @ PORTION OPPOSITE RM-40 ONLY) @ SHERMAN AVE. 0' PROVIDED (ALL FLOORS, PORTION OPPOSITE CC(2)(R) ONLY) @ GRANT AVE. 10' MIN. REQ. * / 13'-6" PROVIDED (ALL FLOORS, PORTION OPPOSITE RM-40 ONLY) @ GRANT AVE. * 10' MINIMUM YARD FOR LOT LINES ABUTTING OR OPPOSITE RESIDENTIAL / RESIDENTIAL PC DISTRICTS (PROPOSED PROJECT ABUTS RM-40 AT REAR LOT LINE & IS OPPOSITE RM-40 AT PORTIONS OF BOTH GRANT & SHERMAN AVES) **BUILD-TO-LINES:** MIN. 50% FRONTAGE BUILT TO SETBACK, MIN. 33% SIDE STREETS BUILT TO SETBACK FRONTAGE (PARK BLVD) PROVIDED: 50'-7" OF 95' BUILT TO SETBACK (~53.2%, 50% MIN. REQ.) SIDE STREET (SHERMAN AVE.) PROVIDED: ~158'-10" OF ~191'-3" BUILT TO SETBACK (~83.1%, 33% MIN. REQ.) SIDE STREET (GRANT AVE.) PROVIDED: ~44'-8" OF ~100'-4" BUILT TO SETBACK (~44.52%, 33% MIN. REQ.) DAYLIGHT PLANE: NONE REQUIRED (ONLY REQUIRED FOR LOT LINES ABUTTING ONE OR MORE RESIDENTIAL ZONE DISTRICTS OTHER THAN RM-40 OR PC ZONE, HEIGHT & SLOPE TO MATCH MOST RESTRICTIVE RESIDENTIAL ZONE ABUTTING THE SITE LINE IN (E) BUILDING AREA: 150 GRANT AVE: ~7,915 SF + ~1,703 SF (~9,618 SF TOTAL) 123 SHERMAN AVE: ~754 SF + ~1,810 SF (~2,564 SF TOTAL) 2501 PARK BLVD: ~3,341 SF **TOTAL (E) OFFICE AREA: 15,523 SF** PROPOSED FLOOR AREA: RETAIL / PERMITTED USES AREA: 3,871 SF 2,798 (LOBBY, ELEVATORS, STAIRS, TRASH ROOM, MAIN ELECTRICAL ROOM) FIRST FLOOR OFFICE AREA SECOND FLOOR OFFICE AREA: 22,638 SF THIRD FLOOR OFFICE AREA: 22,638 SF TOTAL OCCUPIED FLOOR AREA: 51,945 SF UNOCCUPIED FIRST FLOOR COVERED (ONLY) PARKING AREA: 16,729 SF TOTAL FLOOR AREA: 68,674 SF **NET OFFICE AREA: 48,074 SF** PROPOSED PARKING AREA: P2/P1 LEVEL = 28,570 SF EA. (2 LEVELS): FIRST FLOOR COVERED + SURFACE PARKING AREA (INCL. EXT. STAIR): 19,759 SF TOTAL PARKING AREA: **FAR ALLOWED (PAMC 18.16.060 TABLE 3):** 2.0:1 (68,768 SF MAX.) FAR PROPOSED: 1.99:1 (68,674 SF), SEE ABOVE FOR SUMMARY (EXCLUDES AMENITY FITNESS / SHOWERS IN GARAGE PER PAMC 18.04.030 65B(V)) TOTAL AMENITY AREA EXCLUDED FROM FAR & PARKING = 901 SF (~1.3 % FLOOR AREA, LESS THAN 5% ALLOWED) PARKING REQUIRED (PAMC 18.52.040 TABLE 1): 1/250 SF OFFICE (193 TOTAL STALLS FOR 48,074 SF) 1/200 SF RETAIL / PERMITTED USES (20 TOTAL STALLS FOR 3,871 SF) 213 STALLS REQUIRED FOR 51,945 SF OCCUPIED FLOOR AREA 20% TDM REDUCTION: 171 STALLS REQUIRED PARKING PROPOSED: TOTAL 172 STALLS (8 ADA + 147 OFFICE + 17 RETAIL) P2 LEVEL: 82 TOTAL OFFICE STALLS * 34 STD STALLS * 24 PUZZLES (48 STALLS) P1 LEVEL: 50 TOTAL OFFICE STALLS * 50 STD STALLS (INCLUDING 33 FUTURE EV + 1 FUTURE AMBULATORY EV) FIRST FLOOR: 40 TOTAL STALLS, 8 ADA + 17 RETAIL / PERMITTED USES + 15 OFFICE STALLS * 6 STD ADA STALLS (INCL 1 ADA EVSE) * 2 VAN ADA STALLS (INCL. 1 VAN ADA EVSE) * 4 STALLS (ADA ACCESS AISLES PER PAMC 18.52.040(b)(8) * 7 STD EVSE STALLS * 21 CAV STALLS LOADING PARKING (1 LOADING STALL REQ. PER PAMC 18.52.040 TABLE 3 (FOR LESS THAN 100,000 SF), 12'X45'X15' CLEAR HT: 1 LOADING STALL PROPOSED AT PARK BLVD (SEE A1.1 & TR0.0) ACCESSIBLE PARKING REQUIRED / PROVIDED (INCLUDED IN COUNTS ABOVE): 6 ADA REQUIRED (FOR 151-200 TOTAL STALLS PER CBC 11B-208.2) * 5 STD ADA + 1 VAN ADA PROVIDED (PER CBC 11B-208.2.4) DESIGNATED CAV PARKING REQUIRED / PROVIDED (INCLUDED IN COUNTS ABOVE): 21 CAV STALLS (12% OF TOTAL STALLS PER CGC TABLE A5.106.5.1.2) EV PARKING REQUIRED / PROVIDED (INCLUDED IN COUNTS ABOVE): 43 EVSE STALLS (25% OF TOTAL STALLS PER PAMC 16.14.430) 34 CONDUIT ONLY (20% 'FUTURE EV'), INCLUDING: * 33 STD FUTURE EVSE * 1 AMBULATORY FUTURE EVSE (FOR 26 TO 50 FUTURE INSTALLED EVS PER CBC TABLE 11B-228.3.2.1) FUTURE VAN AMBULATORY & STD EVSES TO BE LOCATED ON P1 LEVEL 9 EVSE INSTALLED (5% OF TOTAL STALLS PER PAMC 16.14.430), INCLUDING: * 7 STD EVSE * 1 VAN EVSE ADA (FOR 26 TO 50 FUTURE / INSTALLED EVS PER CBC TABLE 11B-228.3.2.1) * 1 STD EVSE ADA (FOR 26 TO 50 FUTURE / INSTALLED EVS PER CBC TABLE 11B-228.3.2.1) VAN ADA EVSE & STD ADA EVSE LOCATED ON FIRST FLOOR





VICINITY MAP

SMITH DEVELOPMENT

150 GRANT / 123 SHERMAN / 2501 PARK PALO ALTO, CA 94306



ISSUES AND REVISIONS NO. DATE DESCRIPTION

05.25.21 PLANNING SUBMITTAL
08.31.21 PLANNING RESUBMITTAL #1
02.04.22 PLANNING RESUBMITTAL #2

PROJECT NUMBER

SHEET TITLE

PROJECT INFORMATION


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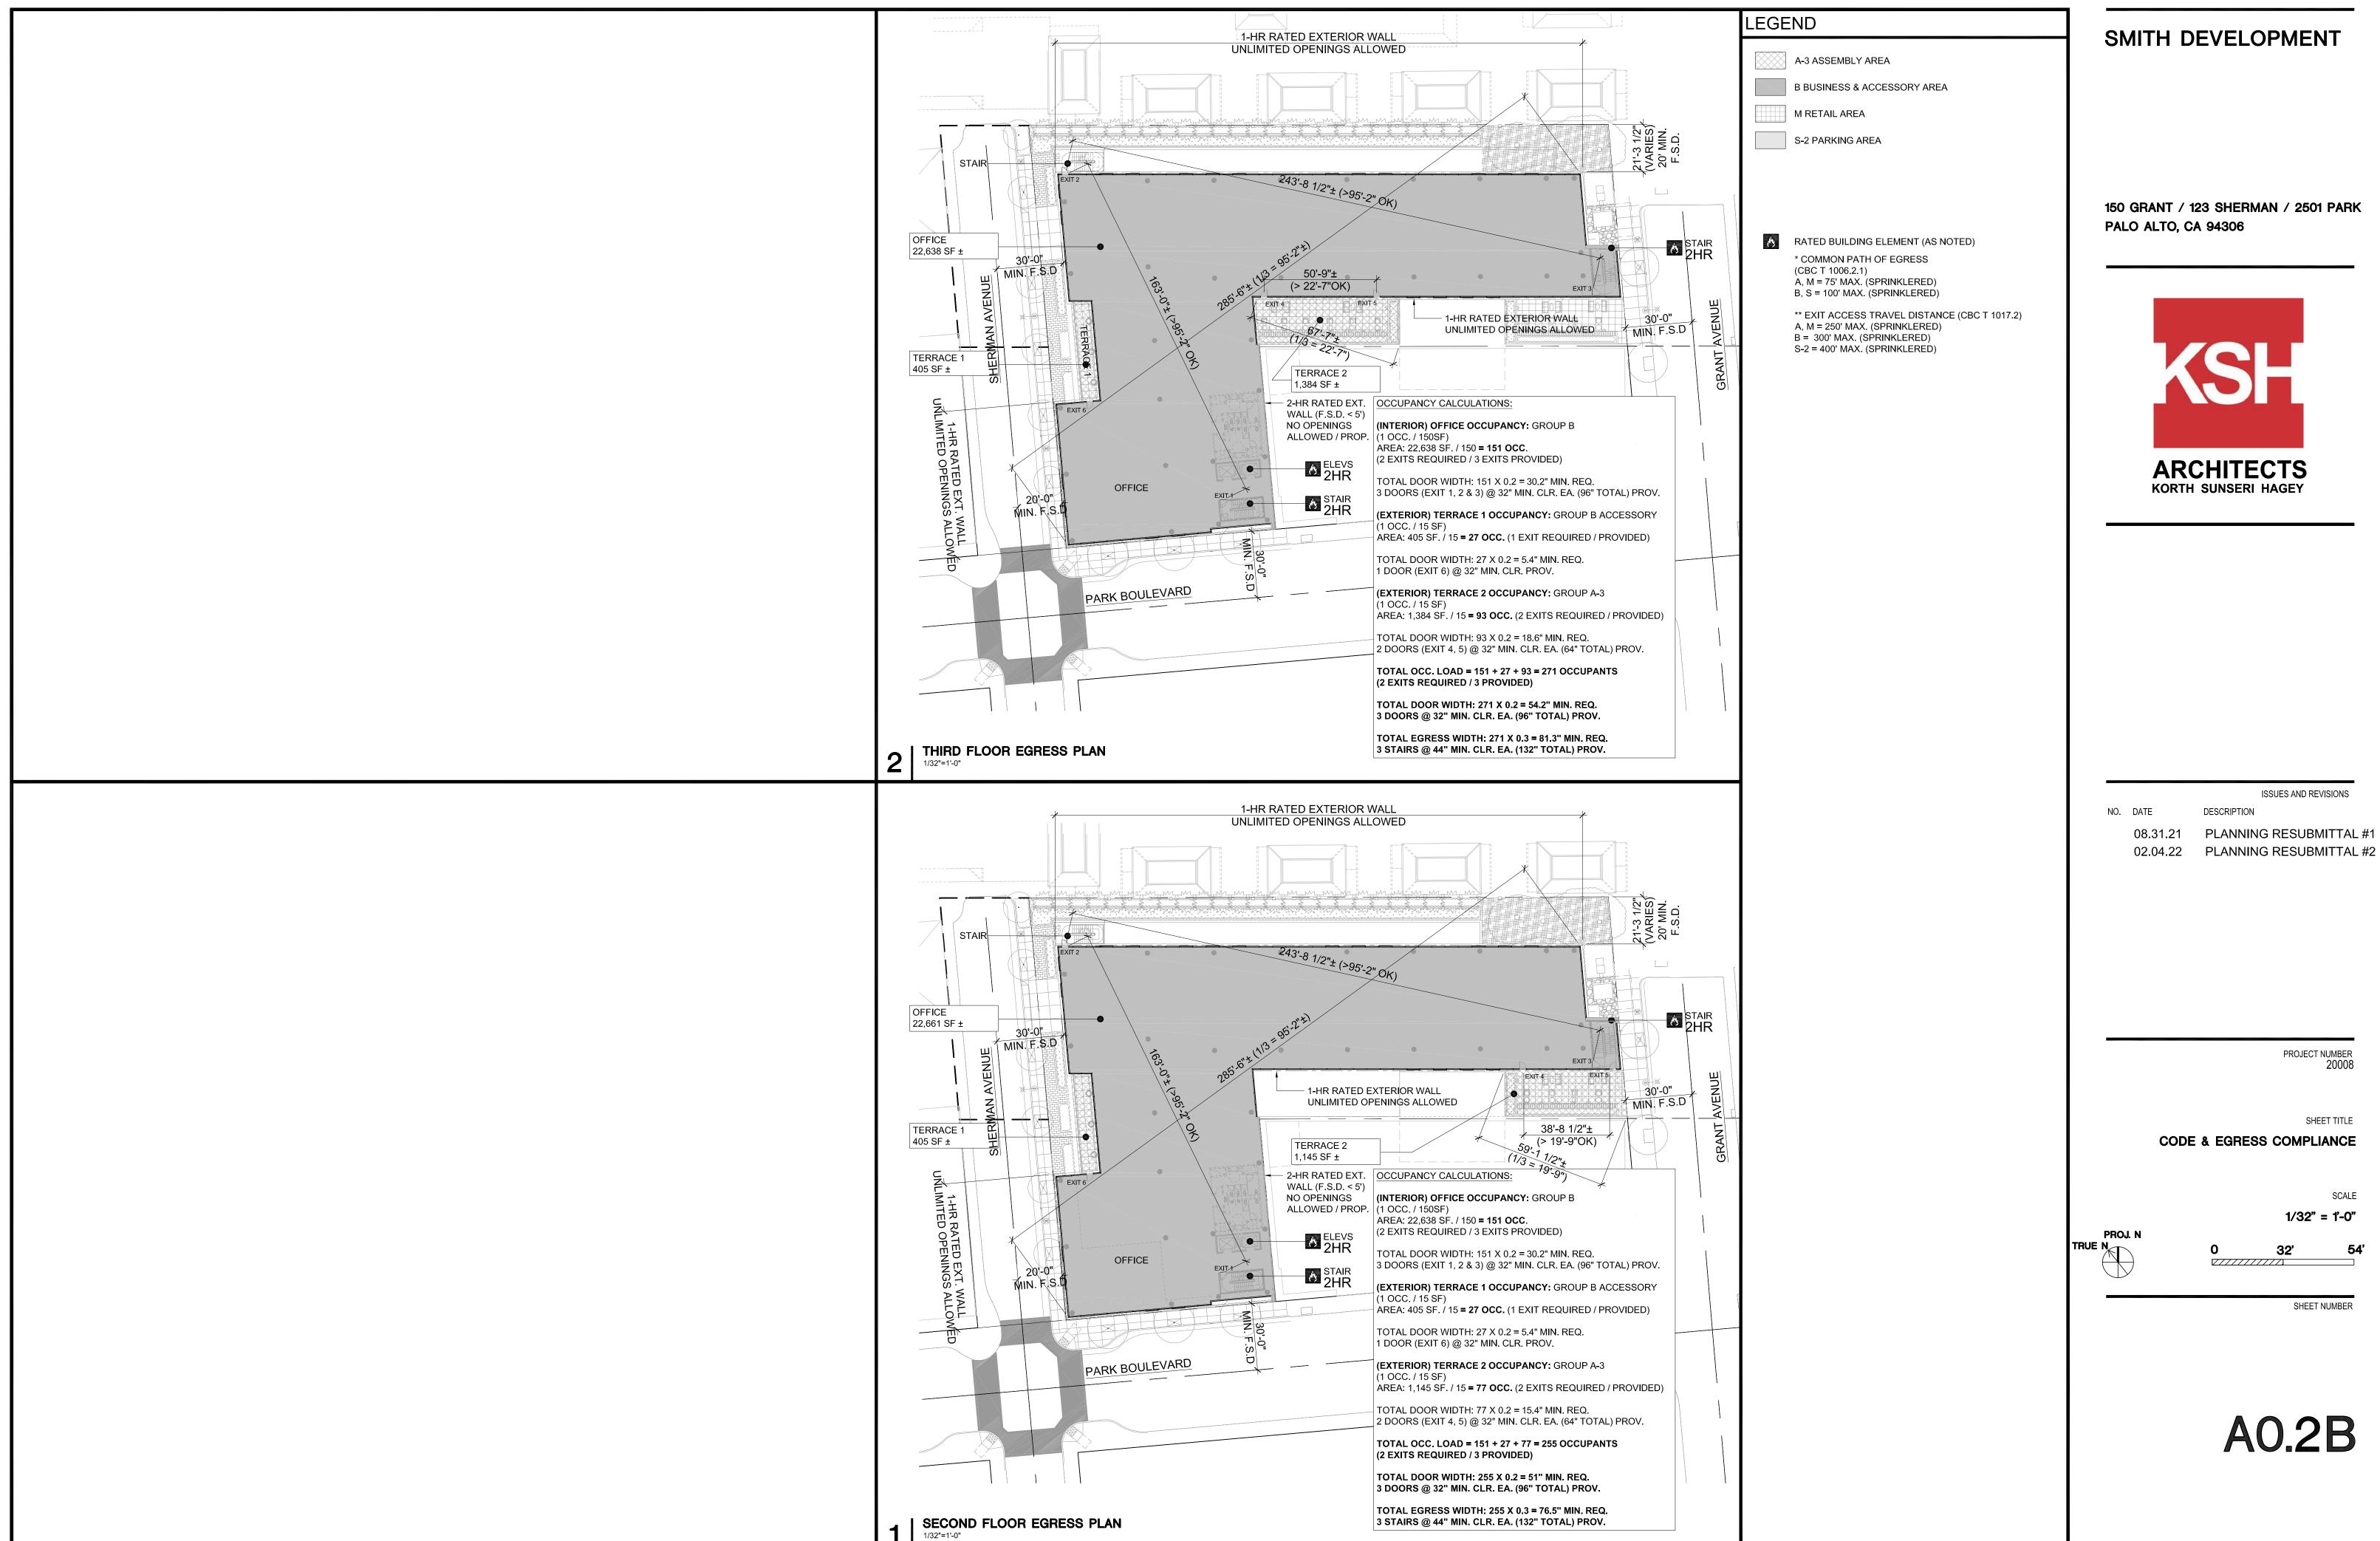
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TYPICAL PARKING LEVEL (P1) EGRESS PLAN, P2 LEVEL SIM.



150 GRANT / 123 SHERMAN / 2501 PARK



ISSUES AND REVISIONS

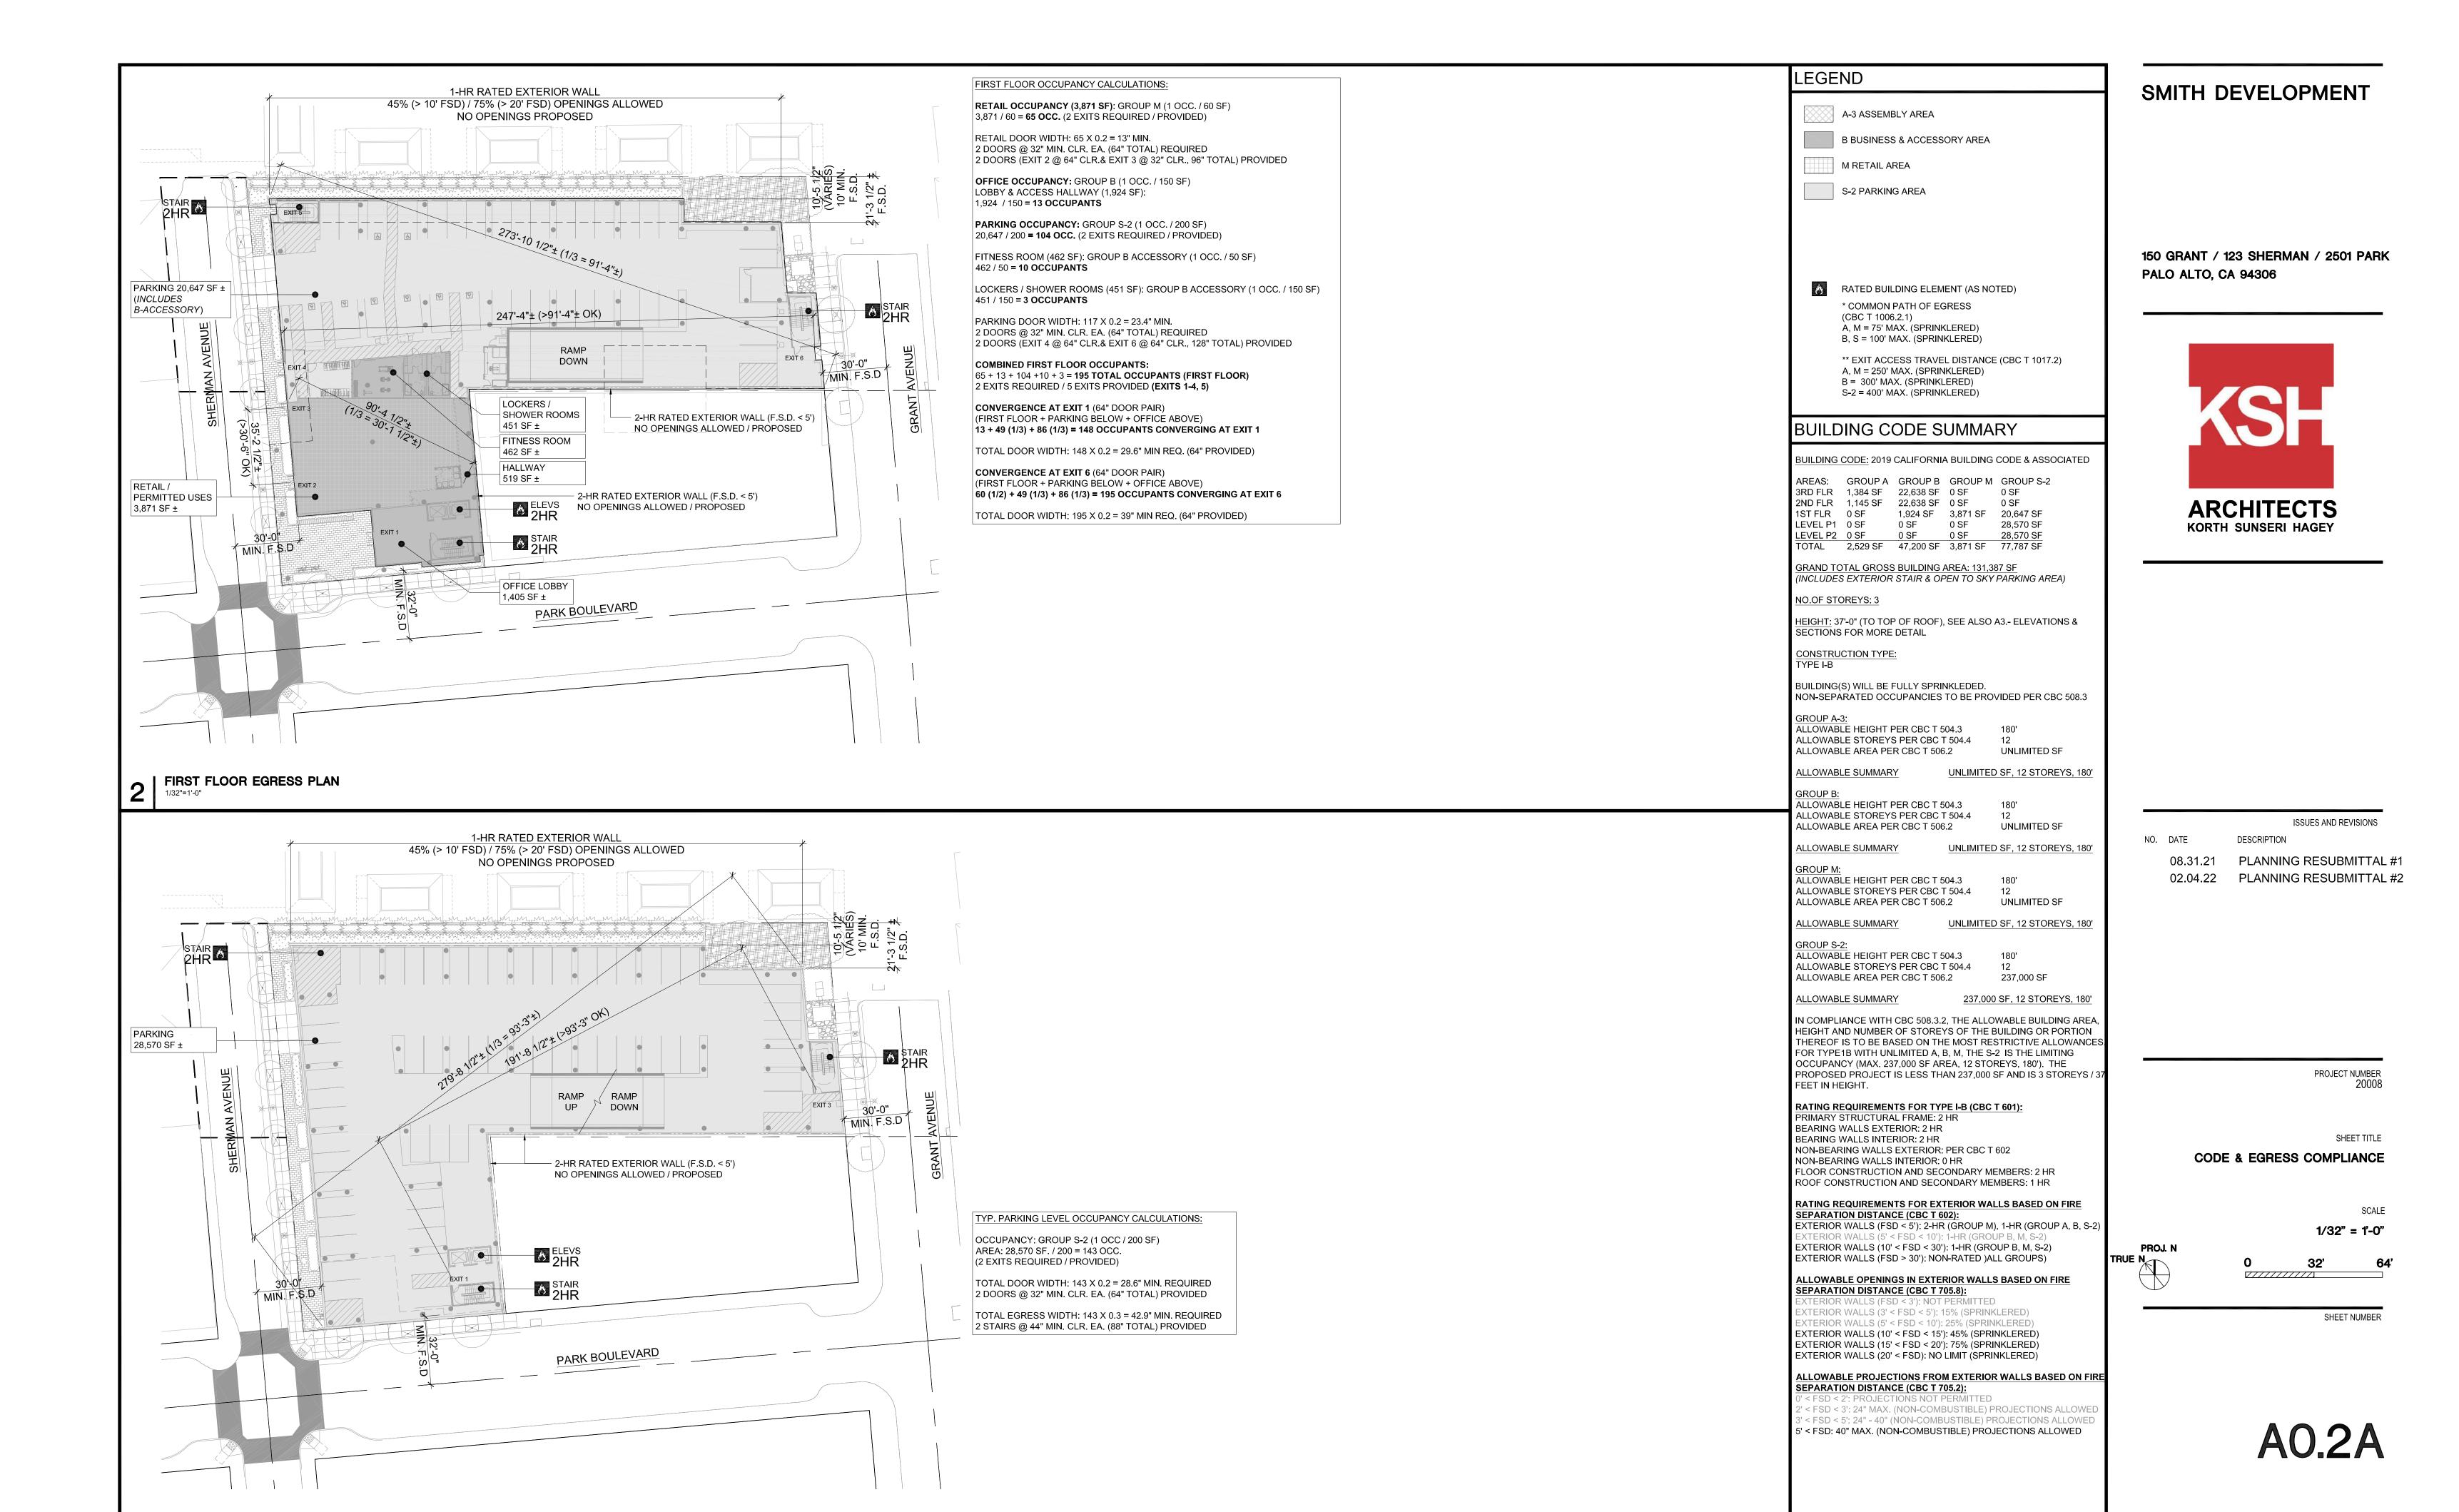
08.31.21 PLANNING RESUBMITTAL #1

PROJECT NUMBER 20008

SHEET TITLE CODE & EGRESS COMPLIANCE

SCALE

1/32" = 1'-0"

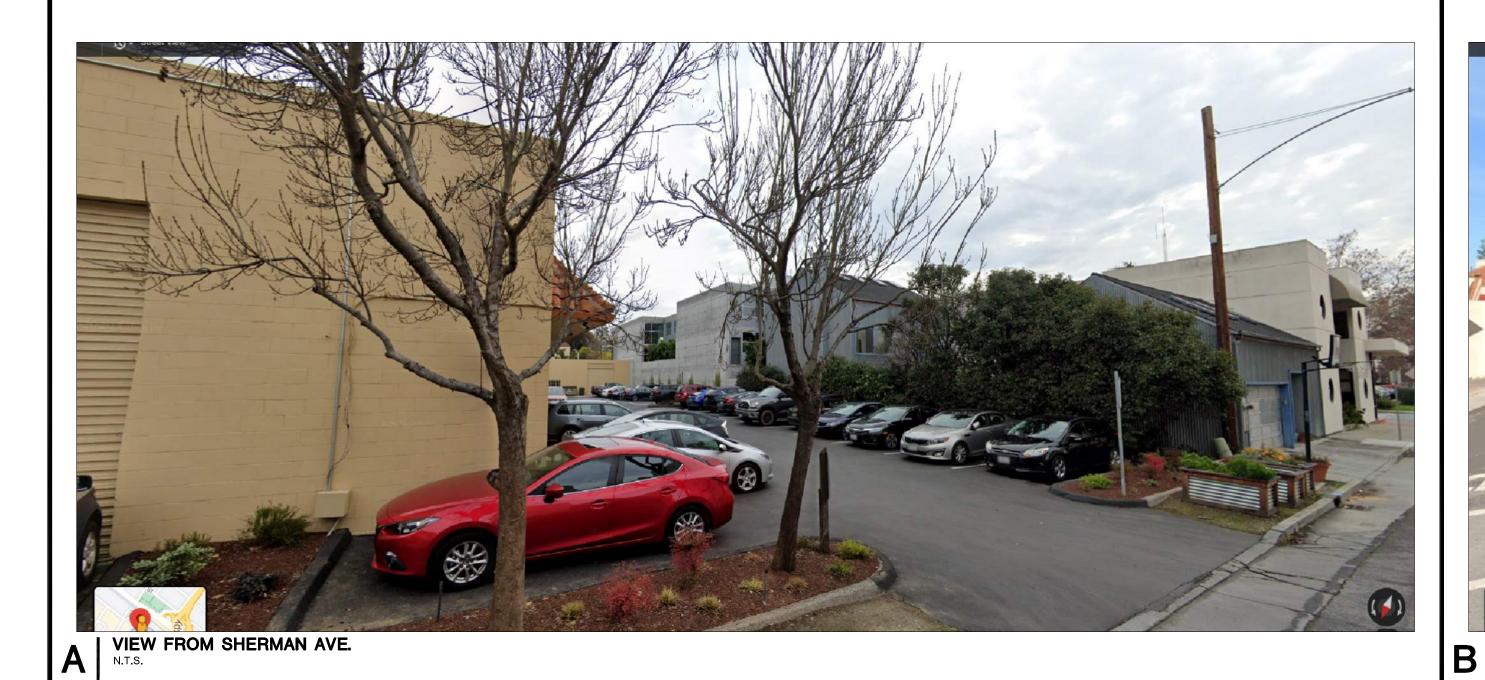



150 GRANT / 123 SHERMAN / 2501 PARK PALO ALTO, CA 94306







ISSUES AND REVISIONS
NO. DATE DESCRIPTION

05.25.21 PLANNING SUBMITTAL

08.31.21 PLANNING RESUBMITTAL #1
02.04.22 PLANNING RESUBMITTAL #2

PROJECT N

SHEET TITLE

EXISTING SITE PHOTOS

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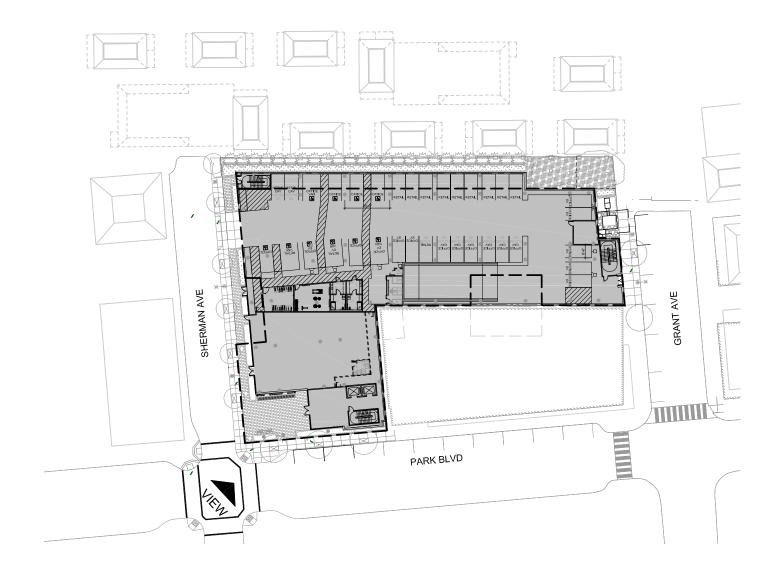
A0.3







VIEW FROM CORNER OF SHERMAN AVE. & PARK BLVD.



KEY PLAN - PROPOSED SITE

SMITH DEVELOPMENT

150 GRANT / 123 SHERMAN / 2501 PARK PALO ALTO, CA 94306



ISSUES AND REVISIONS

05.25.21 PLANNING SUBMITTAL

08.31.21 PLANNING RESUBMITTAL #1

02.04.22 PLANNING RESUBMITTAL #2

PROJECT NUMB

SHEET TITLE

PROPOSED PERSPECTIVE

SCALE


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SHEET NUMBER

R1/



VIEW FROM CORNER OF SHERMAN AVE. & PARK BLVD.

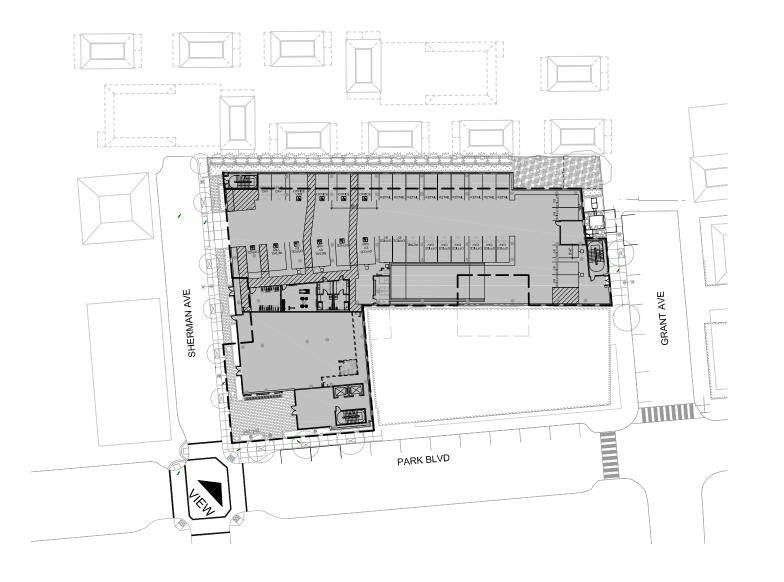

KEY PLAN - PROPOSED SITE

SMITH DEVELOPMENT

150 GRANT / 123 SHERMAN / 2501 PARK PALO ALTO, CA 94306



ISSUES AND REVISIONS

05.25.21 PLANNING SUBMITTAL

08.31.21 PLANNING RESUBMITTAL #1 02.04.22 PLANNING RESUBMITTAL #2

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PROPOSED PERSPECTIVE

AS NOTED

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SHEET NUMBER

R1F



150 GRANT / 123 SHERMAN / 2501 PARK PALO ALTO, CA 94306



ISSUES AND REVISIONS

08.31.21 PLANNING RESUBMITTAL #1 02.04.22 PLANNING RESUBMITTAL #2

PROJECT NUMB

SHEET TITLE

PROPOSED PERSPECTIVE


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SHEET NUMBER

R2A

VIEW FROM CORNER OF GRANT AVE. & PARK BLVD.



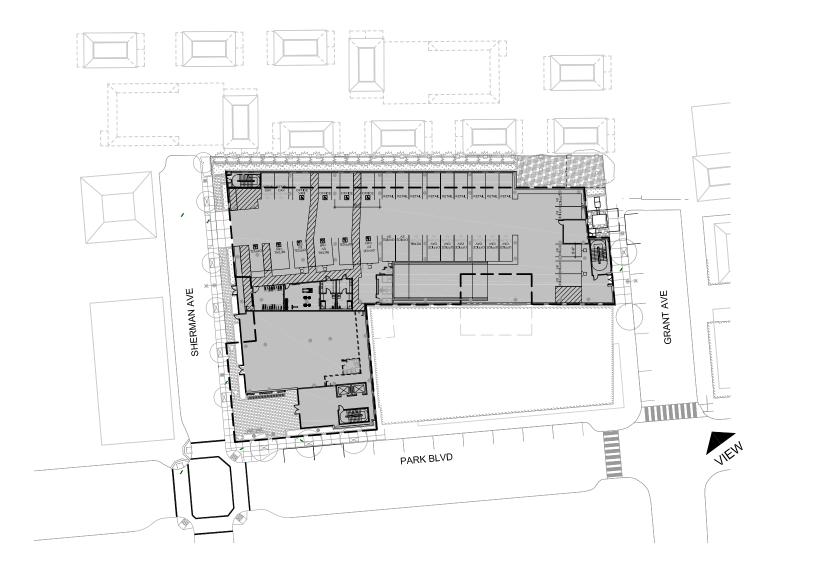

150 GRANT / 123 SHERMAN / 2501 PARK PALO ALTO, CA 94306



ISSUES AND REVISIONS

08.31.21 PLANNING RESUBMITTAL #1 02.04.22 PLANNING RESUBMITTAL #2

PROJECT NUMB 200

SHEET TITLE

PROPOSED PERSPECTIVE


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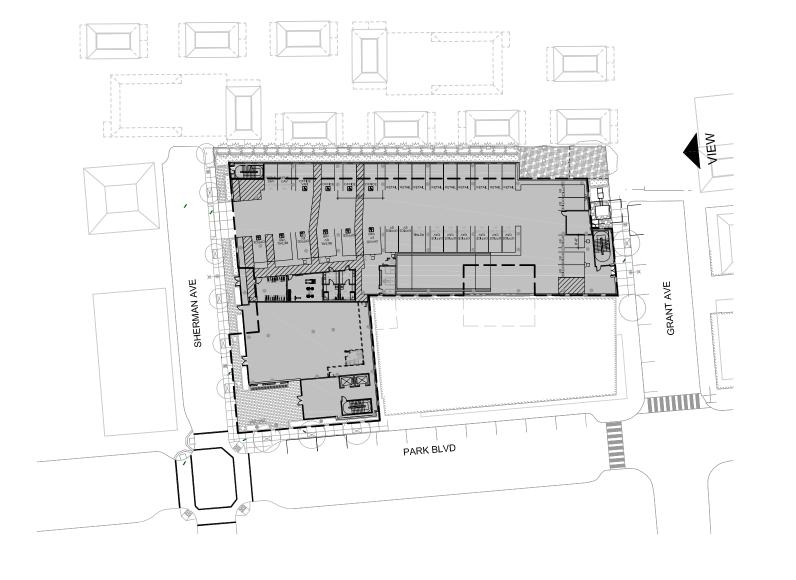
R2B

VIEW FROM CORNER OF GRANT AVE. & PARK BLVD.





VIEW FROM END OF GRANT AVE

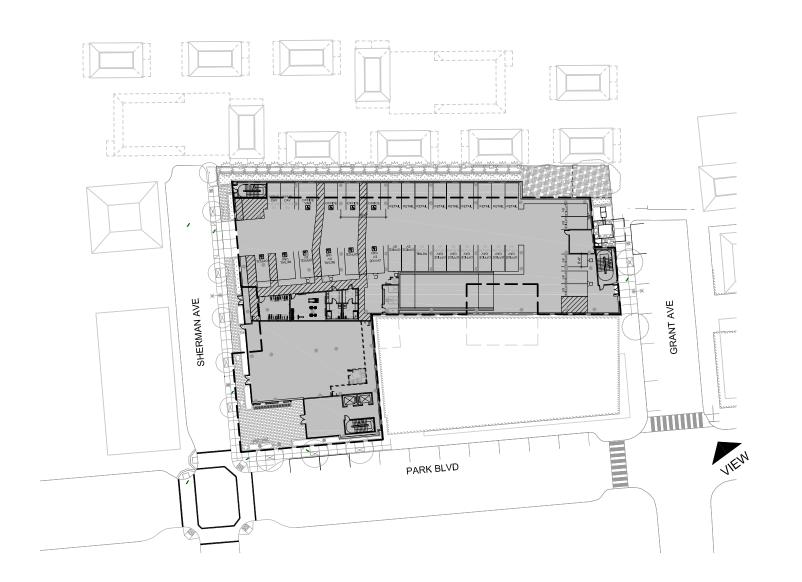

KEY PLAN - PROPOSED SITE

SMITH DEVELOPMENT

150 GRANT / 123 SHERMAN / 2501 PARK PALO ALTO, CA 94306



ISSUES AND REVISIONS

02.04.22 PLANNING RESUBMITTAL #2

PROJECT NUI

SHEET TITLE

PROPOSED PERSPECTIVE

AS NOTED

PROJ. N

SHEET NUMBER

R3A



150 GRANT / 123 SHERMAN / 2501 PARK PALO ALTO, CA 94306



ISSUES AND REVISIONS

02.04.22 PLANNING RESUBMITTAL #2

PROJECT NUMBE

SHEET TITLE

PROPOSED PERSPECTIVE

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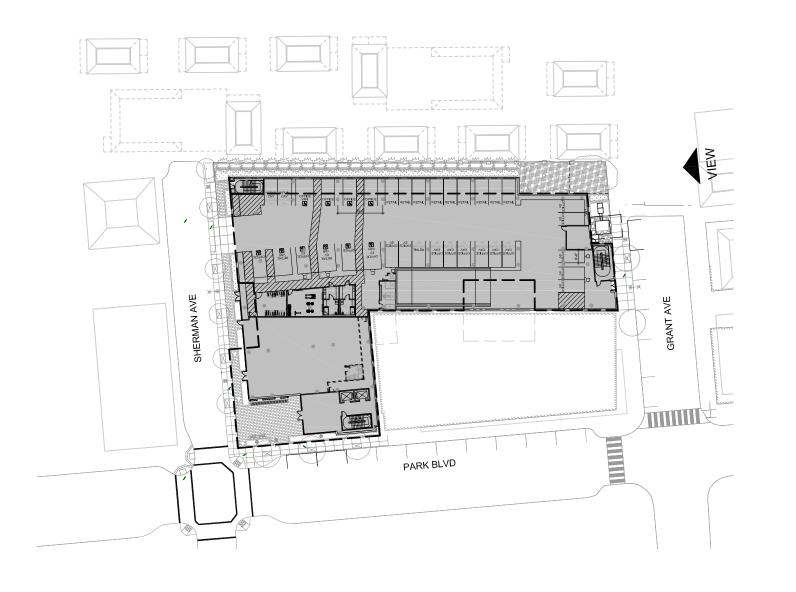
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SHEET NUMBER

R3B

VIEW FROM END OF GRANT AVE



KEY PLAN - PROPOSED SITE



AERIAL VIEW FROM PARK BLVD.& SHERMAN AVE.

SMITH DEVELOPMENT

150 GRANT / 123 SHERMAN / 2501 PARK PALO ALTO, CA 94306



ISSUES AND REVISIONS

05.25.21 PLANNING SUBMITTAL 08.31.21 PLANNING RESUBMITTAL #1

02.04.22 PLANNING RESUBMITTAL #2

PROJECT NUMB 200

SHEET TITLE

PROPOSED PERSPECTIVE

AS NOTED

SHEET NUMBER

SHERMAN AVE

KEY PLAN - PROPOSED SITE PLAN



AERIAL VIEW FROM PARK BLVD. & GRANT AVE.

SMITH DEVELOPMENT

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ISSUES AND REVISIONS

05.25.21 PLANNING SUBMITTAL
08.31.21 PLANNING RESUBMITTAL #1

02.04.22 PLANNING RESUBMITTAL #2

PROJECT NUMB 200

SHEET TITLE

PROPOSED PERSPECTIVE

SCALE

AS NOTED

AO NOTE

SHEET NUMBER

R

PARK BLVD

PARK BLVD

KEY PLAN - PROPOSED SITE PLAN
1/64"=1'-0"



AERIAL VIEW FROM GRANT AVE.

SMITH DEVELOPMENT

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ISSUES AND REVISIONS

05.25.21 PLANNING SUBMITTAL 08.31.21 PLANNING RESUBMITTAL #1

02.04.22 PLANNING RESUBMITTAL #2

PROJECT NUMBE 2000

SHEET TITLE

PROPOSED PERSPECTIVE


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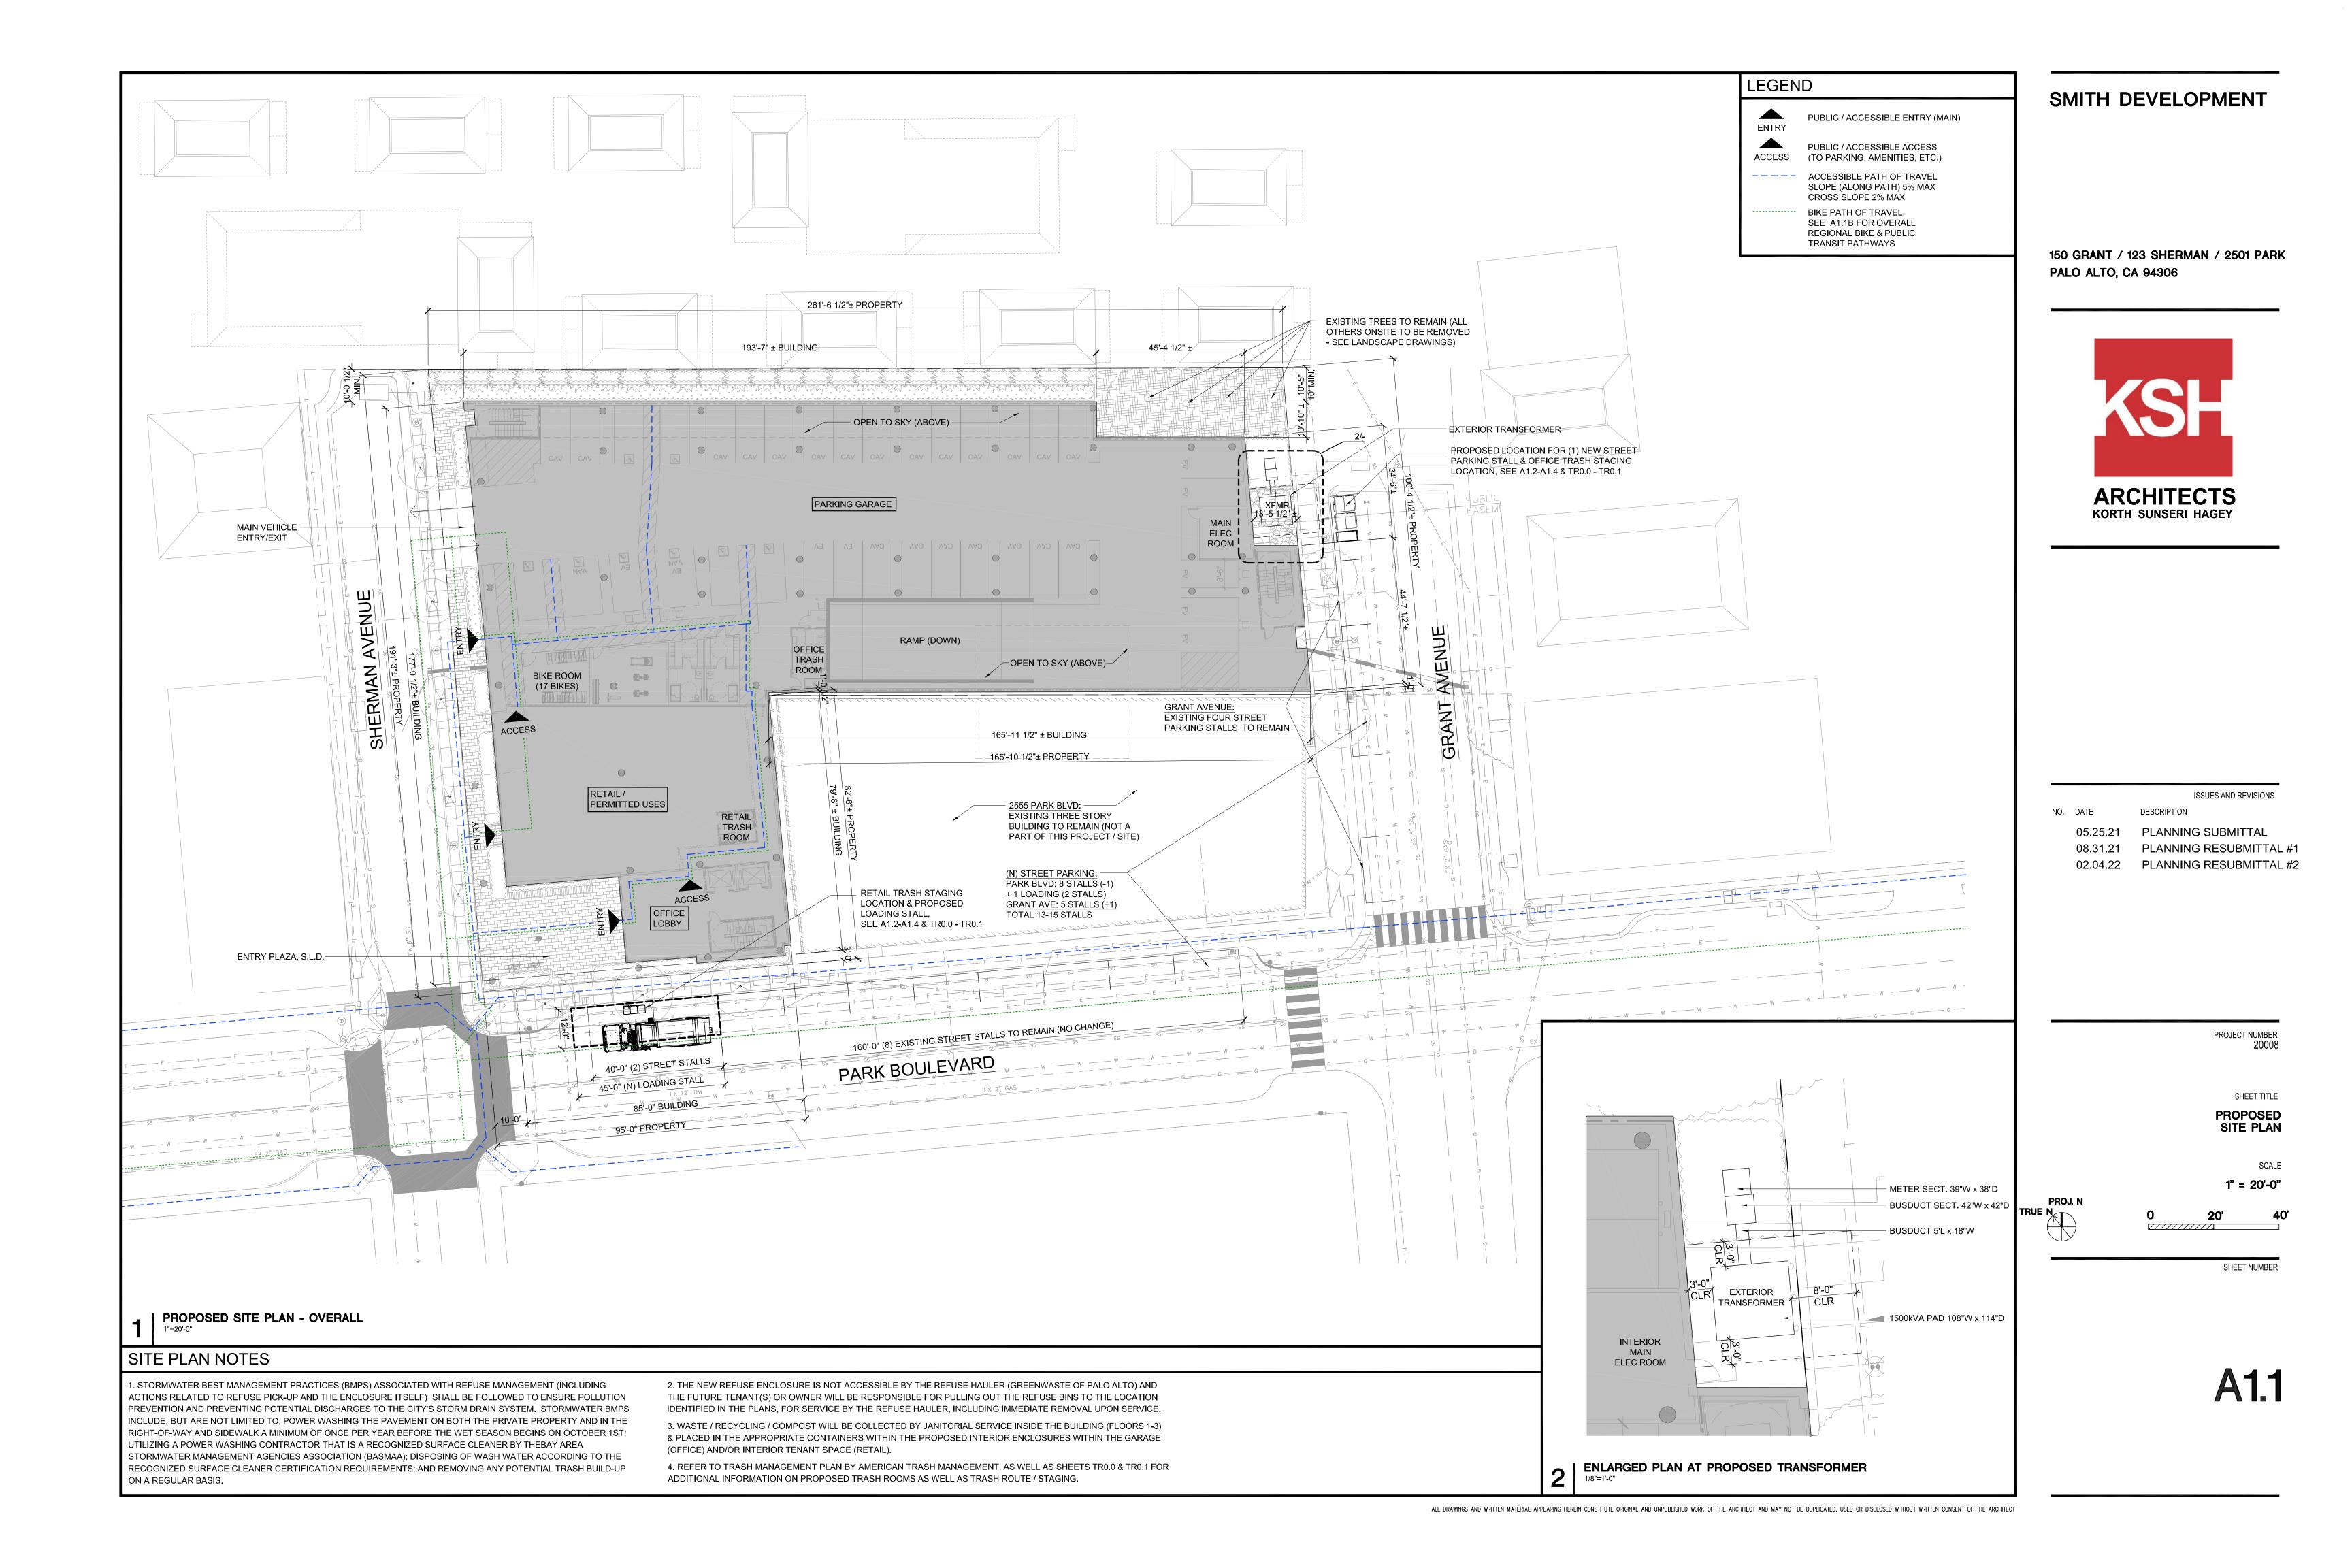
PARK BLVD


PARK BLVD

KEY PLAN - PROPOSED SITE PLAN
1/64"=1'-0"



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DRAFT-SMITH-DRAFT 123 Sherman Palo Alto, CA Trash Management Plan

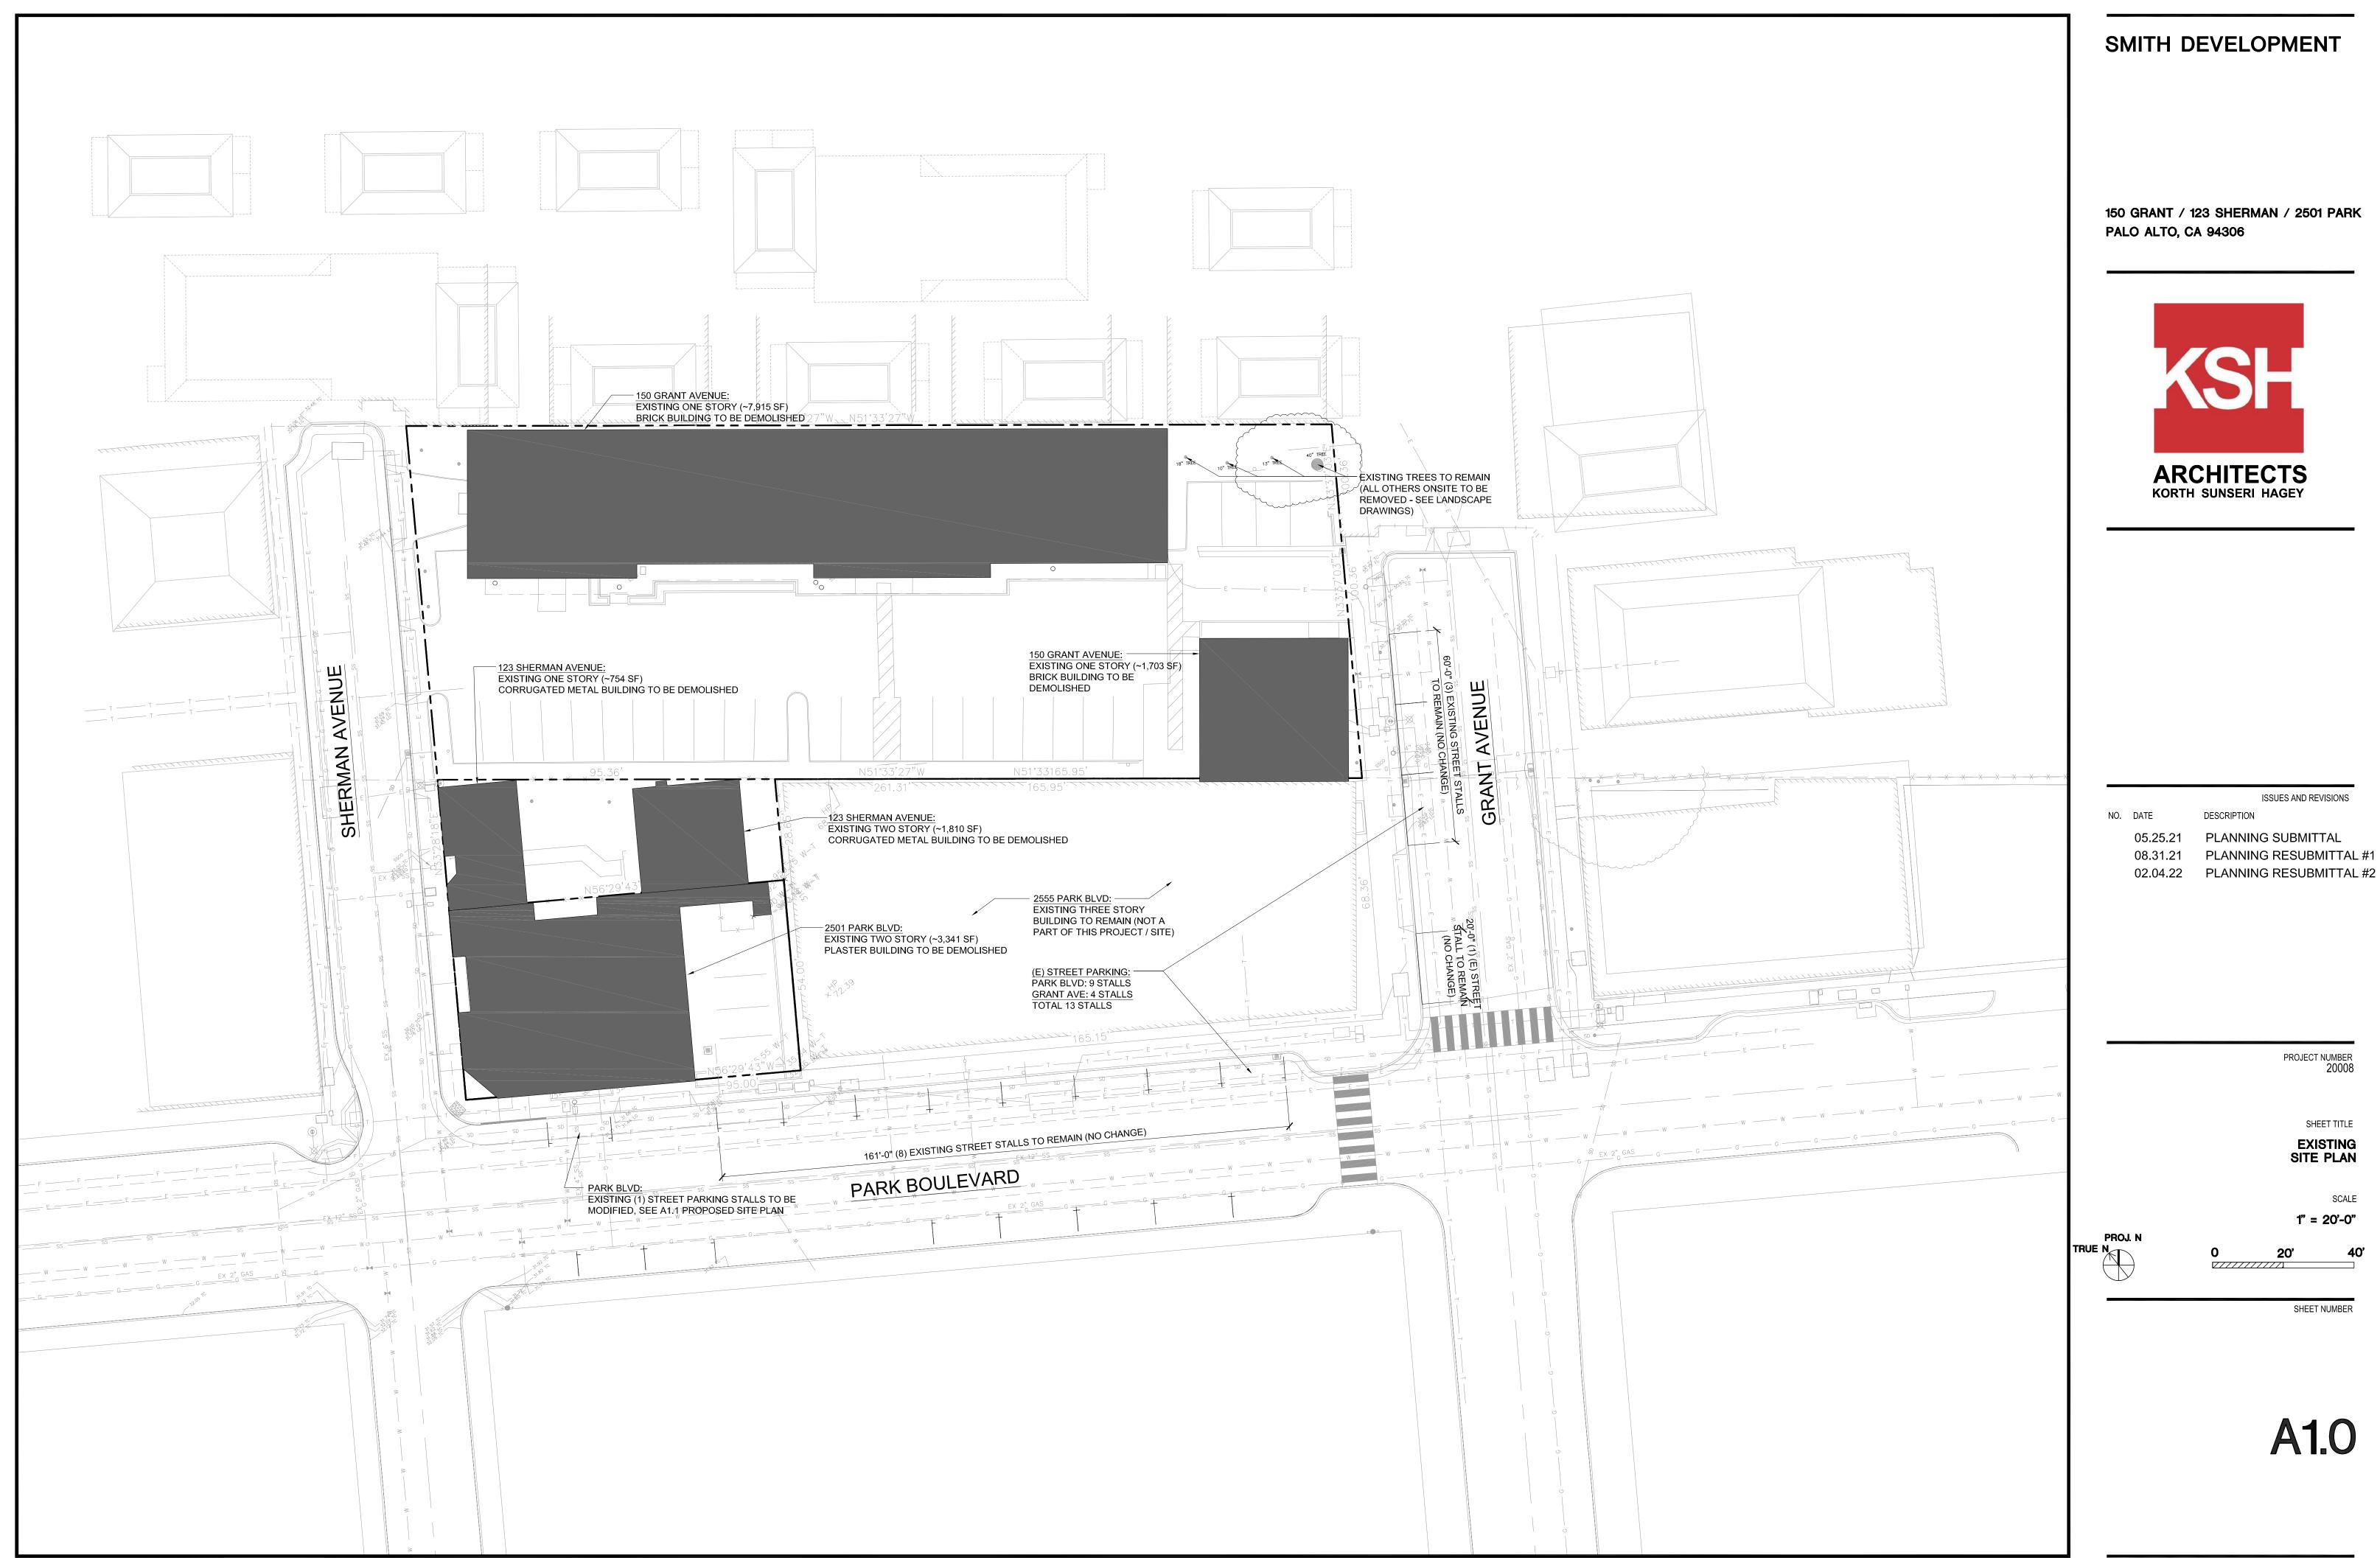Task: Design a waste and recycling system for a mixed-used office project with 52,000 square feet of office space with a potential future full-service cafeteria and 3,800 square feet of ground floor retail space that minimizes costs, staffing requirements and environmental impacts, while providing convenient trash disposal for the building's residents. Please note the word "trash" when used in this plan covers both waste and recycling.

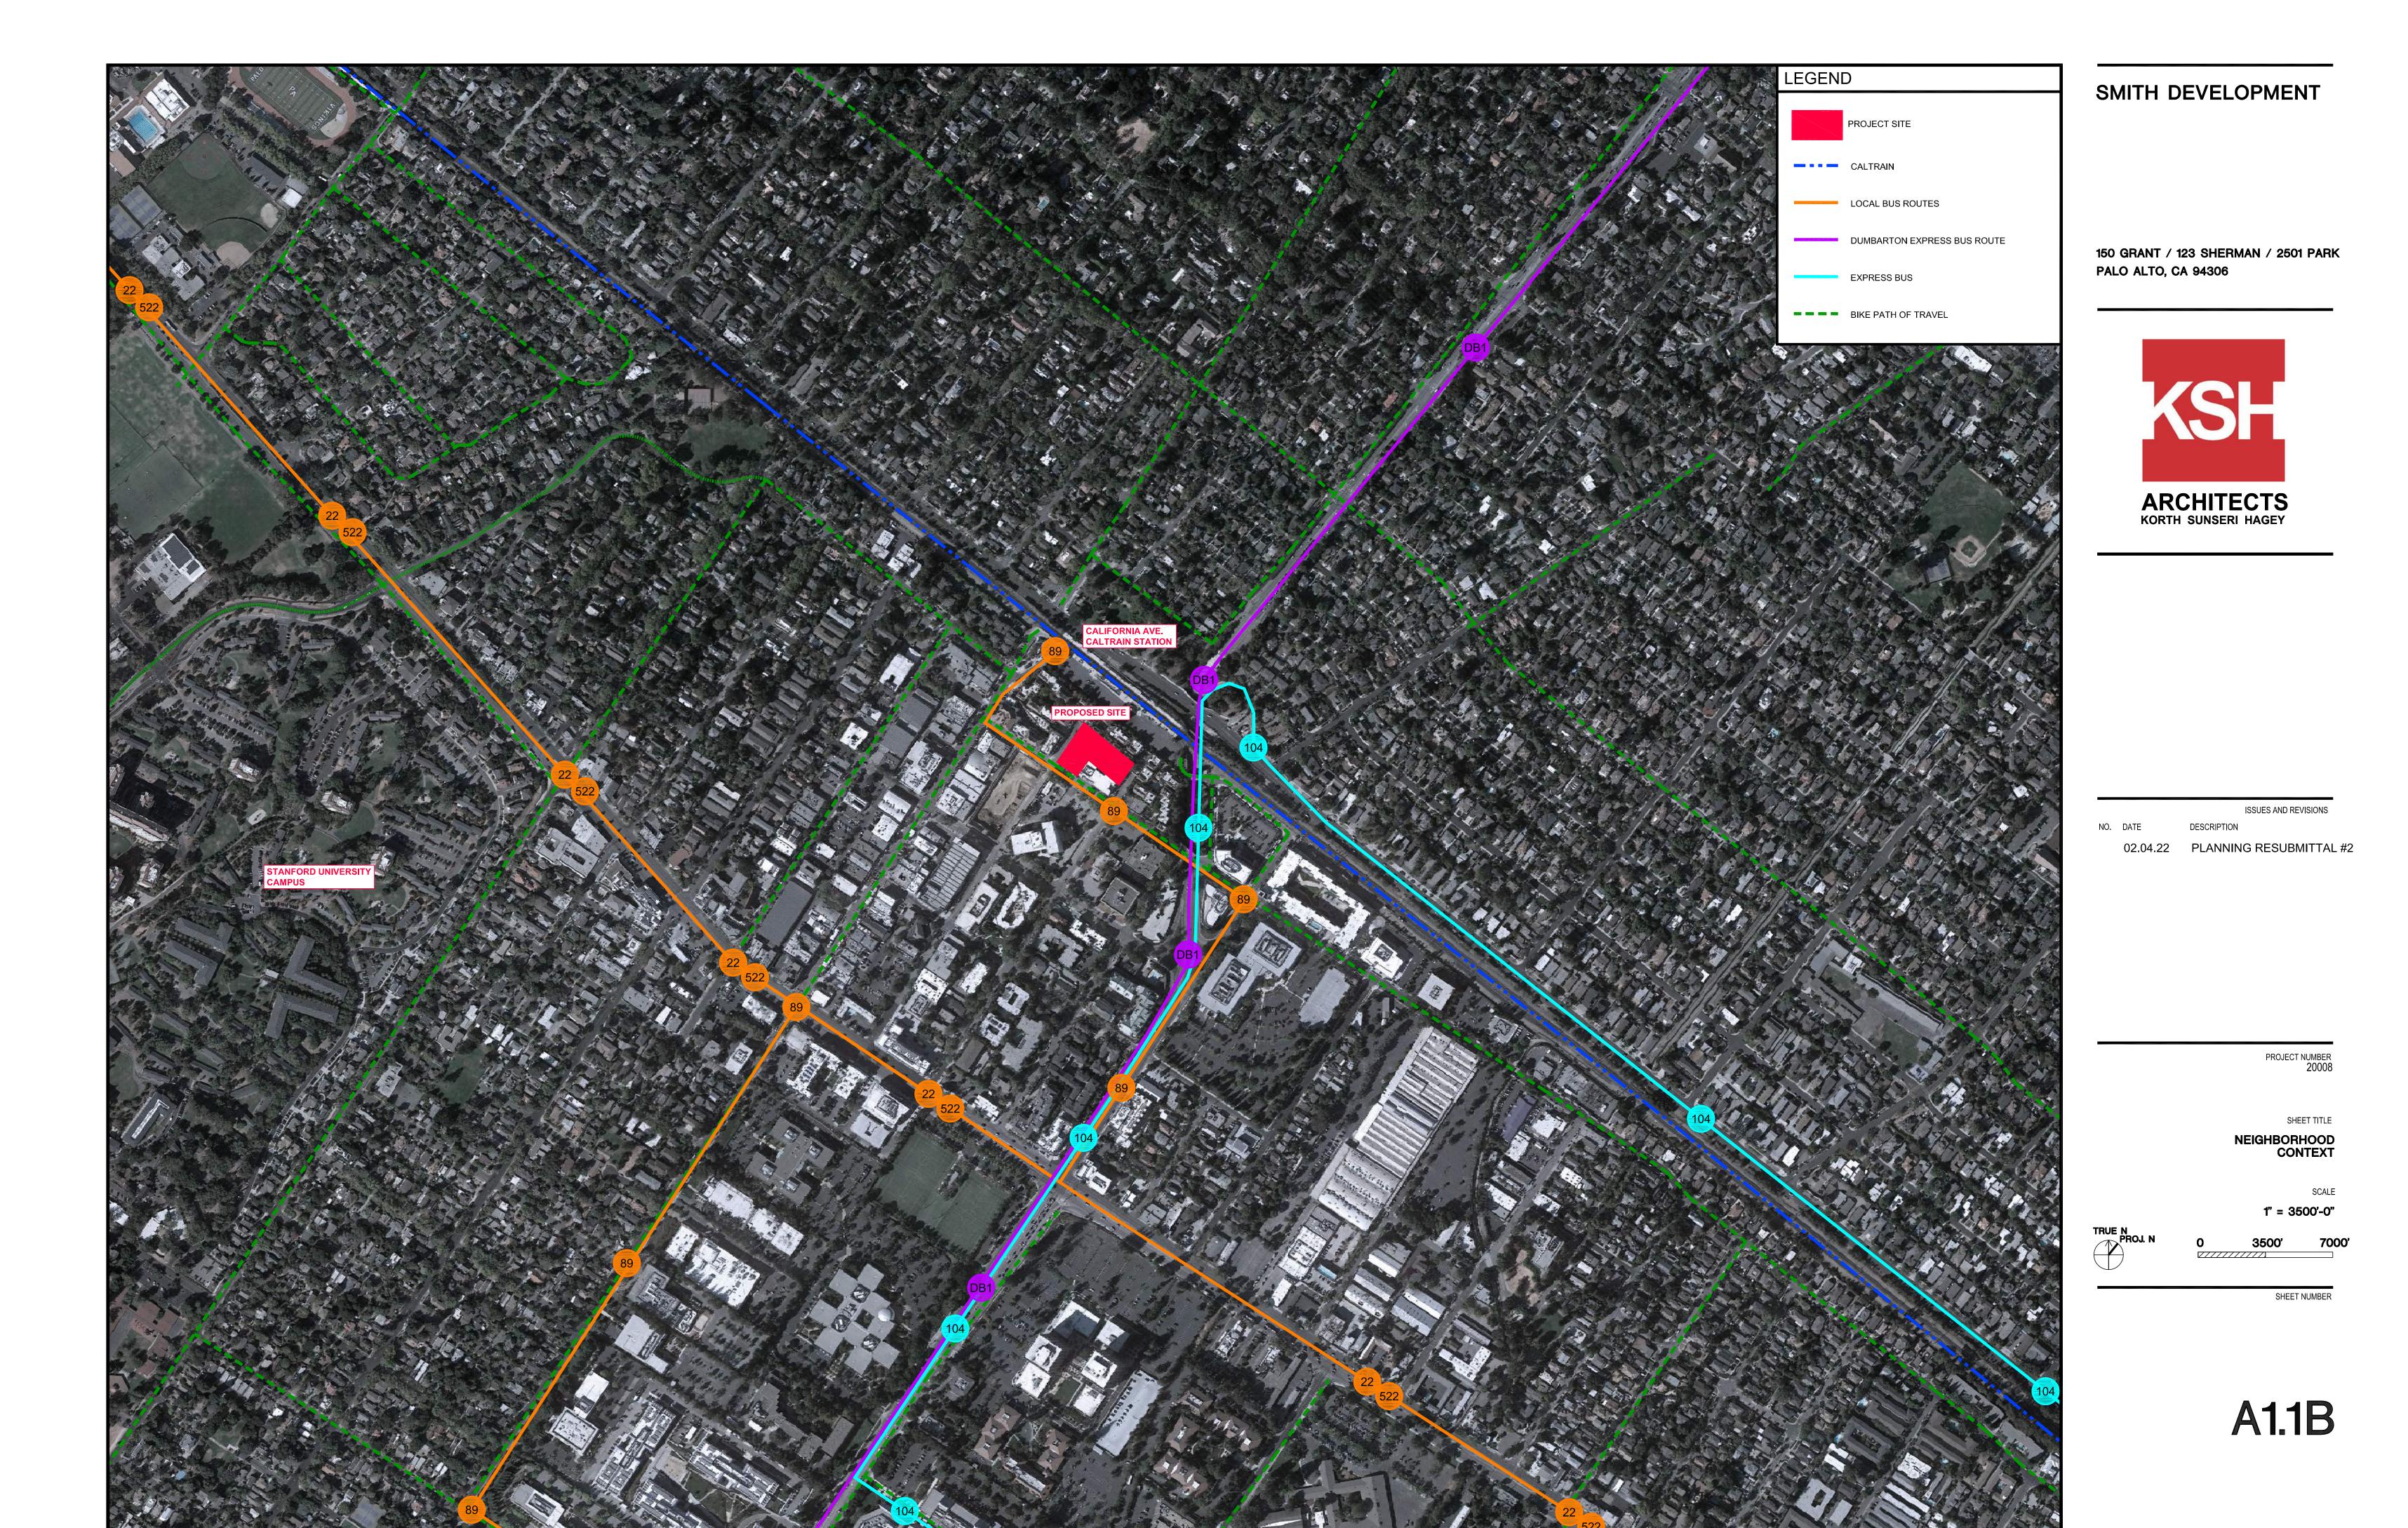Waste and Recycling Removal: The City of Palo Alto has granted GreenWaste of Palo Alto a license to provide residential and commercial Waste and Recycling services to residents and businesses located within the city and county. This license is a de facto exclusive franchise for trash removal for any property located within city limits. Rates have not been adjusted since 2016. GreenWaste provides three types of service: waste, commingled recycling and compost collection.

City Council has approved the Recycling and Composting Ordinance. Starting January 1, 2017 businesses generating 2 or more cubic yards of garbage per week will be required to subscribe to recycling and compost services, as well as sort all waste into the appropriate containers. Currently, commercial customers generating 8 or more cubic yards of garbage per week, multifamily buildings, and food service establishments are already composting and recycling under the Ordinance.

Palo Alto Municipal Code 5.20.030 (b) states that "all persons shall separate their refuse according to its characterization as solid waste, compostable materials or recyclable materials."

Additionally, Palo Alto has a noise ordinance, 9.10.030 Residential property noise limits that states (a) No person shall produce, suffer or allow to be produced by any machine, animal or device, or any combination of same, on residential property, a noise level more than six dB above the local ambient at any point outside of the property plane.

(b) No person shall produce, suffer or allow to be produced by any machine, animal, or device, or any combination of same, on multi-family residential property, a noise level more than six dB above the local ambient three feet from any wall, floor, or ceiling inside any dwelling unit on the same property, when the windows and doors of the dwelling unit are closed, except within the dwelling unit in which the noise source or sources may be located. (Ord. 4634 § 2 (part), 2000)

NOTE: While Palo Alto has this noise ordinance but given the data we have on trash truck noise, every location in the city with trash collection violates this rule.

State and Local Recycling Mandates: Statewide the passage of AB341 (July 1st, 2012) and subsequent AB1826 required all business that have more than 5 residential units or generate more than 4 cubic yards of municipal solid waste to separate recyclable and compostable materials from the waste stream. This law directs local jurisdictions to implement recycling and composting regulations and programs.

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Thursday, February 3, 2022



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Office Trash Volume Projections:

Studies cited by CalRecycle estimate office building trash generation at 5.44 lb. of trash per 1000 SF, nearly 70% of which can be diverted. Although past studies had low diversion rates for office buildings, more recent evidence points to large increases in diversion, as firms and their employees become more active recyclers. (This is supported both by outside studies and ATM's data). It is assumed, therefore, comparable diversion rates for this office space will hold.

Using these metrics, the following levels of waste, recyclables and compost are projected for the office space in this project.

Below is a summary of projected loose trash volumes. See detail analysis on pages 13-14.

	SF	Loose Waste Volume CY/WK	Loose Recycle Volume CY/WK	Loose Compost Volume CY/WK	Total # of Waste 4CY Bins/WK	Total # of Recycle 4CY Bins/WK	Total # of Compost 2CY Bins/WK
Office	52,000	5.3	8.8	2.3	2	2	1
Cafeteria	N/A	9.4	8.3	3.8	2	2	2
Total	52,000	14.7	17.2	6.0	4	4	4

Commercial Retail:

Below is a summary of weekly projected loose trash volumes for 100% retail space. See detailed analysis on page 15. Please note restaurants generate considerably more trash than non-F&B retail.

	SF	Loose Waste Volume CY/WK	Loose Recycle Volume CY/WK	Loose Compost Volume CY/WK	Total # of Waste 96G Carts/WK*	Total # of Recycle 96G Carts/WK*	Total # of Compost 64G Carts/WK*
Retail	3,800	0.9	1.1	0.1	2	2	1



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that compost be collected in a 2CY loose container.


Recommended Trash Handling System:

disposed in 4CY loose container bins.

loose bin service for both buildings.

collection area.

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Page 2 of 16

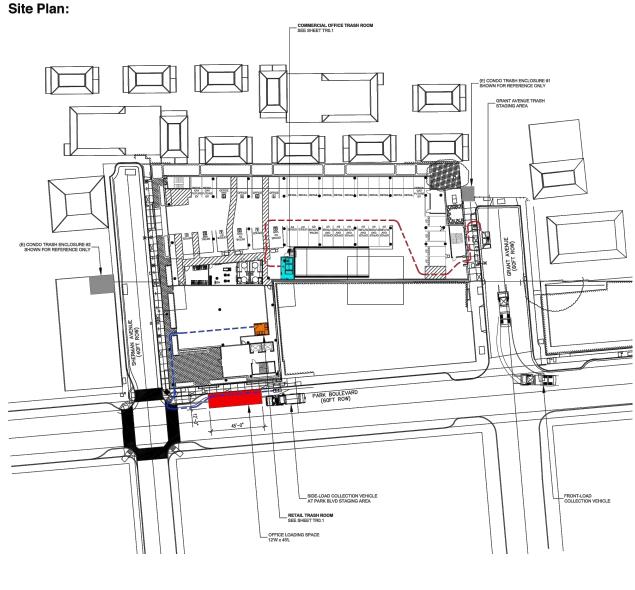To comply with City ordinances, the project residential trash will be collected in 3 different streams: Waste, Mixed Recyclables (paper, cardboard & containers) and Compost (food & organic materials).

Waste & Mixed Recycling. We recommend that all office, cafeteria waste and mixed recycling be

Compost. Because of the relatively high volume of food waste the cafeteria produce, it is recommended

Container Recommendation: Due to the size of the building and projected trash loads compactors are not currently recommended for this project. The relatively low projected residential trash loads indicate

Office Trash. The janitorial staff for the office component of the project will be responsible for moving the

office waste, recycling and compost to the trash room for disposal. The office janitorial staff will be

accessing the trash room in the late evening on weeknights. A path of travel has been designed for janitorial staff to move trash from the office service elevators through a corridor to the trash

Commercial Trash. We recommend the tenant handle trash within their own net rentable space. Waste, recycling and compost will be deposited by staff into into 96-gallon toter carts. The commercial

1. Moving Trash: Require commercial tenants who have any wet trash to move all solid waste and recycling in bag

recycling into the communal trash compactors or bins. The use of bags is required to avoid leaks. Virtually all

management will fine the tenant and arrange for the clean up at the tenants expense. No vent hood filters or floor

used oil. Oil must be stored within the tenant space. No oil can be moved in open containers on the property. All spills if they do happen must be immediately cleaned up or the property management will fine the tenant and arrange for the clean up at the tenant's expense. Used cooking oil cannot be stored in the communal trash room

removed from the property by the tenant at the tenant's expense. (Exclude all non-standard solid waste disposal). Anything that is not typically disposed of on a regular basis (at least every quarter) must be handled directly by the

20 gallons or less. The plastic bags which will make it easy for commercial tenants to put their waste and

2. <u>Cleanup</u>: Tenants will be responsible for keeping the common areas clean. Any sewer blockage will be the

responsibility of the tenant. All spills if they do happen must be immediately cleaned up or the property

3. Cooking Oil & Fat Disposal: Tenants producing used cooking oil to arrange and pay for a service to collect this

4. Bulky Items: Disposal of any large bulky items that do not easily fit within the communal trash bins must be

tenants should be required to follow the Commercial Trash Rules as defined below:

tenants fall into this category since they regularly throw away old partially full drink cups.

RECOMMENDED RETAIL COMMERCIAL TENANT TRASH RULES

mats will be cleaned on site including the communal trash room.

(it stinks and when it is communal you get a mess).

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Specific Project Design Issues & Recommendations: There are several critical trash system design

First, waste and recycling must be collected in 3 streams (waste, recycling, compost) to meet the State requirements of AB341 and AB1826.

Second, the office projection levels assumes a full-service cafeteria is programed. We recommend front load loose bin service based on trash volume projections and local service availability.

Third, we recommend staging occur on Grant Avenue. Front load bins require 25' vertical clearance which are typically used in a project of this size. Bins must be moved by staff to this location so the trash bins to be emptied by Green Waste with minimal impact on the residents and the project's neighbors. Servicing on Grant will require the service truck to back out of the dead end aisles.

Fourth, we recommend commercial retail tenants be responsible for handling their own trash within their own leasable space. Separation prevents commercial trash disposal costs being passed directly to the office tenants. Additionally, ownership can require retail tenants subscribe to push-pull service to minimize trash staging along Park.

Fifth, add 1 CFM/SF mechanical ventilation per CBC, floor drain, hose bib and odor control to the trash collection rooms.

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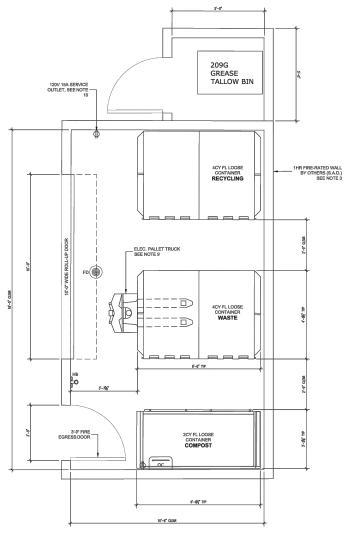
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Office Trash Room Layout

Note: If a cafeteria is ultimately elected for the office, space must be designated for grease tallow bin.



COMMERCIAL OFFICE TRASH ROOM PLAN

ISSUES AND REVISIONS

PLANNING SUBMITTAL 05.25.21

PLANNING RESUBMITTAL #1 PLANNING RESUBMITTAL #2 02.04.22

PROJECT NUMBER

SHEET TITLE

PROPOSED TRASH ROOM & TRASH MANAGEMENT PLAN

> SCALE 1/8" = 1'-0"

TRUE N

SHEET NUMBER

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5. Hazardous Materials: Tenants are responsible for arranging and paying for the disposal of all Hazardous Material

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Thursday, February 3, 2022




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Commercial Retail Trash Closet Layout



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GreenWaste Bins and Carts



1. Section 44 31 00 - Odor Control 2. Section 41 63 23 - Electric Pallet Jack Bin Mover

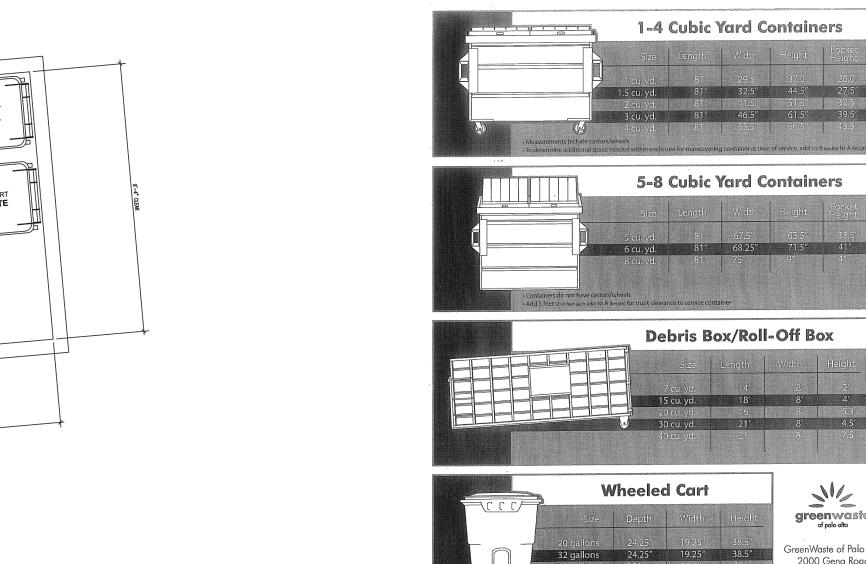D40 PALLET TRUCK

BIG JOE D40 PALLET TRUCK

4000 LBS CAPACITY TURNING RADIUS: 45.5"

Trash System Equipment Specifications: - Provided separately, listed below:

4CY CONTAINER

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Trash Bin Moving:

Project using 4CY Container

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Waste, Recycling and Compost Analysis: (Rates reflect the rate increase effective July 1, 2016) Below is a comparative analysis of the disposal and labor costs of handling waste and recycling in loose versus compacted bins. Please note that the projections below are estimates derived from actual audits of comparable office projects in California. They are not guaranteed. They are to be used for planning purposes only and may be higher or lower than projected.

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TOTAL MAIN OFFICE - WASTE AND RECYCLING SYSTEM ANALYSIS WITH CAFETERIA
Square Feet 52 000

Square reel	52,000	
% Office Recycling OCC	40%	
% Cafeteria Recycling OCC	75%	
Compaction Ratio	4	to 1
Staff Labor Rate	\$21.00	per hour - 1 person
Time move bins	0.25	hr to move to unloading area & back
# of Trash Rooms	1	
FL Compacted Waste Service	4	cubic yard front load bins
FL Compacted Recycle Service	4	cubic yard front load bins
FL Compacted Compost Service	2	cubic yard front load bins
RO Compacted Waste Service	10	cubic yard roll-off compactor
RO Compacted Recycle Service	10	cubic yard roll-off compactor
RO Compacted Compost Service	10	cubic yard roll-off compactor
Loose Waste Service	4	cubic yard front load bins
Loose Recycle Service	4	cubic yard front load bins
Loose Compost Service	2	cubic yard front load bins

COST BENEFIT CALCULATION	PROJECTED PROJECTED		
SERVICE-Waste	Loose	Compacted-F	Compacted-FL
SERVICE-Recycling	Loose	Loose	Compacted-FL
SERVICE-Compost	Loose	Loose	Loose
Loose Waste Volume - CY	14.7		
Compacted Waste Volume - CY		3.7	3.7
Loose Recycling Volume - CY	17.2		
Compacted Recycling Volume -	CY	4.3	4.3
Loose Compost Volume - CY	6.0	6.0	6.0
Compacted Compost Volume - 0	CY		
Waste Bins/week	4	1	1
Recycling Bins/week*	4	2	2
Compost Bins/week	4	4	4
Containers/week/trash room	12	7	7
SYSTEM CAPITAL COST	\$0.00	\$24,655.00	\$49,310.00
WASTE COST/MONTH	\$2,448.09	\$1,269.56	\$1,269.56
RECYCLING COST/MONTH	\$0.00	\$0.00	\$0.00
COMPOST COST/MONTH	\$1,041.04	\$1,041.04	\$1,041.04
TRASH COST/MONTH	\$3,489.13	\$2,310.60	\$2,310.60
COMPACTION SAVINGS/MONT	1 \$0.00	\$1,178.53	\$1,178.53
STAFF LABOR COST/MONTH	\$272.79	\$159.13	\$159.13
STAFF SAVINGS/MONTH	\$0.00	\$113.66	\$0.00
NET MONTHLY TRASH COSTS	\$3,761.92	\$2,469.73	\$2,469.73
Monthly Trash Cost per SF	\$0.07	\$0.05	\$0.05
I	,		

* Loose 4CY Recycling Bins rounded down

PAYBACK-MONTHS

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1HR FIRE-RATED WALL BY OTHERS (S.A.D.) SEE NOTE 3 96G CART WASTE 120V 15A SERVICE _ OUTLET, SEE NOTE 10

RETAIL TRASH ROOM PLAN SCALE: ½" = 1'-0"

2'-5¾" TYP

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greenwaste of polo ofto

enWaste of Palo Alto

2000 Geng Road Palo Alto, CA 94303

650.493.4894

Sample Office Building Trash Service Schedule

Note that all schedules to be determined by hauler, building management, and actual trash levels.

Office With Full Service Cafeteria

	Monday	Tuesday	Wednesday	Thursday	Friday	Saturday	Sunday
4CY Loose Waste	1	1	1	1			
4CY Loose Recycle	1	1	1	1			
2CY Loose Compost	1		1		1		
Total	3	2	3	2	1	0	0

ommercial R	etailService	Schedul
	Monday	Tuesday

	Monday	Tuesday	Wednesday	Thursday	Friday	Saturday	Sunday
96G Loose Waste	2						
96G Loose Recycle	2						
64G Loose Compost	1						
Total	5	0	0	0	0	0	0

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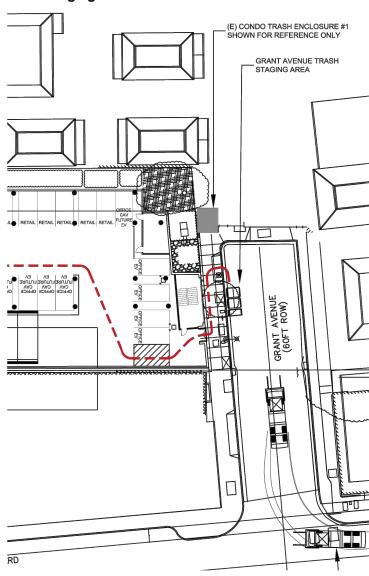
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Trash Service Location:

Commercial office staging should take place on the curb cut on Grant Avenue. This is a safe and convenient location for staging bins so they can be pulled and emptied by the hauler with minimal impact on the residents and the project's neighbors. Trash bins will be moved by building staff to and from this staging location on service days.

We recommend the retail trash be serviced on Park Boulevard. Staff can either bring the bins out to Park Boulevard for staging or management can require the tenant subscribe to push-pull service at an additional cost.

Trash Staging Area:



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ISSUES AND REVISIONS

PLANNING SUBMITTAL 05.25.21 PLANNING RESUBMITTAL #1

02.04.22 PLANNING RESUBMITTAL #2

PROJECT NUMBER

SHEET TITLE

TRASH MANAGEMENT PLAN

SCALE

N.T.S.



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OFFICE WASTE AND RE	CYCLING SYSTEM ANAI	LYSIS
ASSUMPTIONS:	Square Feet	52,00
	11 /1 /000 05	

Square Feet	52,000	
Lbs/day per 1000 SF	5.44	
% waste	30%	
% recycling	50%	
% compost	20%	
waste lb/CY	80	
recycling lb/CY	80	
compost lb/CY	125	
Compaction Ratio	4	to 1

	ompaction hatio	4	ιO
COST BENEFIT CALCULATION	PROJECTED	PROJECTED	
SERVICE-Waste	Loose	Compacted	
SERVICE-Recycling	Loose	Compacted	
Loose Waste Volume - CY	5.3		
Compacted Waste Volume - CY		1.3	
Loose Recycling Volume - CY	8.8		
Compacted Recycling Volume - C	CY	2.2	
Loose Compost Volume - CY	2.3		
Compacted Compost Volume - C	Υ	0.6	

OFFICE CAFETERIA WASTE AND RECYCLING SYSTEM ANALYSIS ASSUMPTIONS: Square Feet 52,000

ICE CAI ETE	THA WASTE AND THE CICENIA C	TO LIVI AIV
UMPTIONS:	Square Feet	52,000
	Square Feet per Employee	195
	Meals per Employee Per Day	1.5
	lb. per meal	1
	% waste	37.5%
	% recycling	25%
	% compost	37.5%
	waste lb/CY	80
	recycling lb/CY	60
	compost lb/CY	200
	Compostion Potio	4

Co	ompaction Hatio	4
COST BENEFIT CALCULATION	PROJECTED	PROJECTE
SERVICE-Waste	Loose	Compacted
SERVICE-Recycling	Loose	Compacted
Loose Waste Volume - CY	9.4	
Compacted Waste Volume - CY		2.3
Loose Recycling Volume - CY	8.3	
Compacted Recycling Volume - C	Υ	2.1
Loose Compost Volume - CY	3.8	
Compacted Compost Volume - CY	′	0.9

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Containers/week/trash room

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COMMERCIAL RETAIL/ Permitted Uses SYSTEM ANALYSIS

ASSUMPTIONS:	Square Feet	3,800	
	Restaurant %	100%	
	Retail %	100%	
	Cafe trash	1.25	lbs/sf/wk
	Retail trash	0.05	lbs/sf/wk
% recycl	ed - Restaurant	50%	
% compo	st - Restaurant	20%	
% re	ecycled - Retail	50%	
% c	ompost - Retail	10%	
Res	taurant wastes:	125	lb. per loose cubic yards
	Retail wastes:	84	lb. per loose cubic yards
	compost:	200	lb. per loose cubic yards
	recyclables:	84	lb. per loose cubic yards
Co	mpaction Ratio	4	to 1
	pacted Service	2	cubic yard front load bins
	Waste Service	3	cubic yard front load bins
Loose Re	ecycling Service	3	cubic yard front load bins
Loose C	ompost Service	2	cubic yard front load bins
	Waste Service	0.475	cubic yard carts (64G toter carts)
Loose Re	ecycling Service	0.475	cubic yard carts (64G toter carts)
Loose C	ompost Service	0.32	cubic yard carts (64G toter carts)
COST BENEFIT CALCULATION	F&B Option	Retail	
SERVICE-Waste	Loose	Loose	
SERVICE-Recycling	Loose	Loose	
Loose Waste Volume - CY	11.4	0.9	
Compacted Waste Volume - CY			
Loose Recycling Volume - CY	28.3	1.1	
Compacted Recycling Volume - CY	(
Loose Compost Volume - CY	4.8	0.1	
Compacted Compost Volume - CY	,		
Waste Bins/week	4	2	
Recycling Bins/week	10	2	
Compost Bins/week	3	1	
		_	



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City: Franchise:	Palo Alto GreenWaste	Key Charge	\$15.00		
Multi-Family/Commercial Loo	se Front Load Wa	ste Rates:			
Frequency/Size: x/wk-CY Size	2	3	4	64G Cart	
1 x Week	\$309.02	\$437.20	\$581.41	\$73.25	
2 x Week	\$638.63	· '	\$1,174.26	\$163.66	
3 x Week	\$970.54		\$1,825.48	\$254.08	
4 x Week	\$1,301.30	. ,	\$2,448.09	\$344.49	
5 x Week	\$1,630.91		\$3,068.40		
6 x Week	\$1,961.67		\$3,689.87	\$525.33	
Multi-Family/Commercial Com Frequency/Size: x/wk-CY Size 1	\$634.78	4	95: 		
Compost Carts		64-gal cart	96-gal cart	2CY	
1 x Week		\$58.60	\$87.90	\$247.21	
2 x Week		\$130.96	\$189.53	\$510.90	
3 x Week		\$203.26	T	\$776.43	
4 x Week		\$275.60		\$1,041.04	
5 x Week		\$347.93	\$494.42	\$1,304.73	
6 x Week		\$420.26	\$596.06	\$1,569.34	
O X WEEK					
Stationary Compactor Cost	\$21,360.00	A1000, 1-4C	□ Y Towable bins, tax,	ship Install	
			" Y Towable bins, tax, Y Towable bins, tax,		

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Appendix: Projected Waste and Recycling Levels:

Restaurants. CalRecycle (Waste Disposal and Diversion Findings for Selected Industry Groups, 2006), estimates restaurants generate 6537 lb. of trash per employee per year. Using this information, the following are projected waste and recycling levels for restaurant tenants.

Diversion levels, conservative (50%) vs. optimal (75%). The CalRecycle study estimated 2/3s of restaurant materials are disposed of as municipal solid waste (MSW) (66% for fast food restaurants and 68% for standard restaurants). Their study also shows that <u>potentially</u> a very high percentage of these non-diverted materials (68% for fast food and 83% for other food retailing establishments) are recyclables.

Restaurant employee assumptions are based on the Restaurant Industry Operations Report, compiled by Deloitte for the National Restaurant Association in 2010.

Food Services Retailer	Employees	PROJ trash per week (lb.)	Waste (35% of trash)	Recycling (40% of trash)	Compost (25% of trash)
Restaurant Large	30	3,771	1,320	1,509	943
Restaurant Moderate	23	2,891	1,012	1,157	723
Restaurant Small	18	2,263	792	905	566
Restaurant QSR	15	1,886	660	754	471
Restaurant Cafe	10	1,257	440	503	314

Because the descriptive terms in the industry report are vague and difficult to apply to each individual restaurant space in a project, for the purposes of our analysis we have assumed that a 'large' restaurant is 3,000 square feet or 1 employee per 100 square feet of F&B space. Using the 6,537 lb/trash/year/ employee metric, this results in a proxy metric of 1.25 lb/day/square foot. This estimate, however, is only a tool and is not guaranteed. Actual trash generation may be higher or lower.

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Other assumptions: waste 125 lbs/cubic yard, recycle 84 lbs/cubic yard, compost 200 lbs/cubic yard.

ISSUES AND REVISIONS

DESCRIPTION

SMITH DEVELOPMENT

150 GRANT / 123 SHERMAN / 2501 PARK

ARCHITECTS
KORTH SUNSERI HAGEY

PALO ALTO, CA 94306

05.25.21 PLANNING SUBMITTAL
08.31.21 PLANNING RESUBMITTAL #1
02.04.22 PLANNING RESUBMITTAL #2

PROJECT NUMBER 20008

SHEET TITLE

TRASH MANAGEMENT PLAN

SCALE

SHEET NUMBER

A1.4

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Thursday, February 3, 2022

PROJECTED OFFICE ONLY TRASH COLLECTION SCHEDULE / WK								
SERVICE	М	Т	W	Т	F	S	SU	
LOOSE WASTE (4CY)	1		1					
LOOSE RECYCLE (4CY)		1		1				
COMPOST (2CY)	1							
TOTAL	2	1	1	1	0	0	0	

TRASH ROUTE / STAGING PLAN

GROUND LEVEL

PROJECTED OF		/ CAFE		RASH	COLLE	CTION	,
SERVICE	М	Т	w	Т	F	S	SU
LOOSE WASTE (4CY)	1	1	1	1			
LOOSE RECYCLE (4CY)	1	1	1	1			
COMPOST (2CY)	1		1		1		
TOTAL	3	2	3	2	1	0	0

PROJECTED RETAIL TRASH SCHEDULE / WK								
SERVICE	М	Т	W	Т	F	S	SU	
LOOSE WASTE (96G)	2							
LOOSE RECYCLE (96G)	2							
COMPOST (64G)	1							
TOTAL	5	0	0	0	0	0	0	

SHEET NOTES.

TRASH ROUTE / STAGING PLAN. GROUND LEVEL.

- 1. STAFF TO TRANSPORT FRONT-LOAD CONTAINERS TO STAGING AREA WITH ELECTRIC PALLET TRUCK. 4000LB CAPACITY WITH 45.5" TURNING RADIUS. 120V 15A SERVICE OUTLET REQUIRED.
- 2. NOTE THAT TOTER CARTS WILL BE SERVICED BY SIDE-LOAD COLLECTION VEHICLE AND CONTAINERS WILL BE SERVICED BY FRONT-LOAD COLLECTION VEHICLE. STAFF SHALL STAGE TOTER CARTS AND CONTAINERS ON SEPARATE DAYS.

GENERAL NOTES.

- 1. ANY DESIGNS OR SOLUTIONS SHOWN IN DRAWING, EITHER DIRECT OR IMPLIED, ARE HEREBY CLARIFIED AS EXAMPLES AND SHALL NOT BE CONSIDERED COMPLETE DESIGNS FOR CONSTRUCTION. THESE DRAWINGS ARE INTENDED TO SUPPLEMENT THE SUBMITTAL PACKAGE FROM ARCHITECT.
- 2. ANY PARTIAL INFORMATION, OMISSIONS, OR INACCURATE DESCRIPTIONS OF WORK SHOWN IN DRAWINGS, WHICH ARE NECESSARY TO PERFORM THE SCOPE OF WORK, SHALL NOT RELIEVE THE CONTRACTOR FROM COMPLETION OF WORK. ALL WORK SHALL BE PERFORMED TO SATISFY THE MINIMUM REQUIREMENTS OF THE CURRENT APPLICABLE BUILDING CODES.
- 3. CONTRACTOR SHALL FIELD VERIFY ALL DIMENSIONS AND CONDITIONS PRIOR TO START OF CONSTRUCTION. THE ARCHITECT SHALL BE PROMPTLY NOTIFIED OF

ROOM TO TRASH STAGING AREA ON GRANT AVENUE.

STAGING AREA ON PARK BOULEVARD.



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SMITH DEVELOPMENT

150 GRANT / 123 SHERMAN / 2501 PARK

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ISSUES AND REVISIONS

NO. DATE DESCRIPTION 08.31.21 PLANNING RESUBMITTAL #1 02.04.22 PLANNING RESUBMITTAL #2

PROJECT NUMBER 20008

SHEET TITLE


TRASH ROUTE / **STAGING PLAN**

As Indicated

SHEET NUMBER

TR0.0

SCALE: 1/32" = 1'-0"

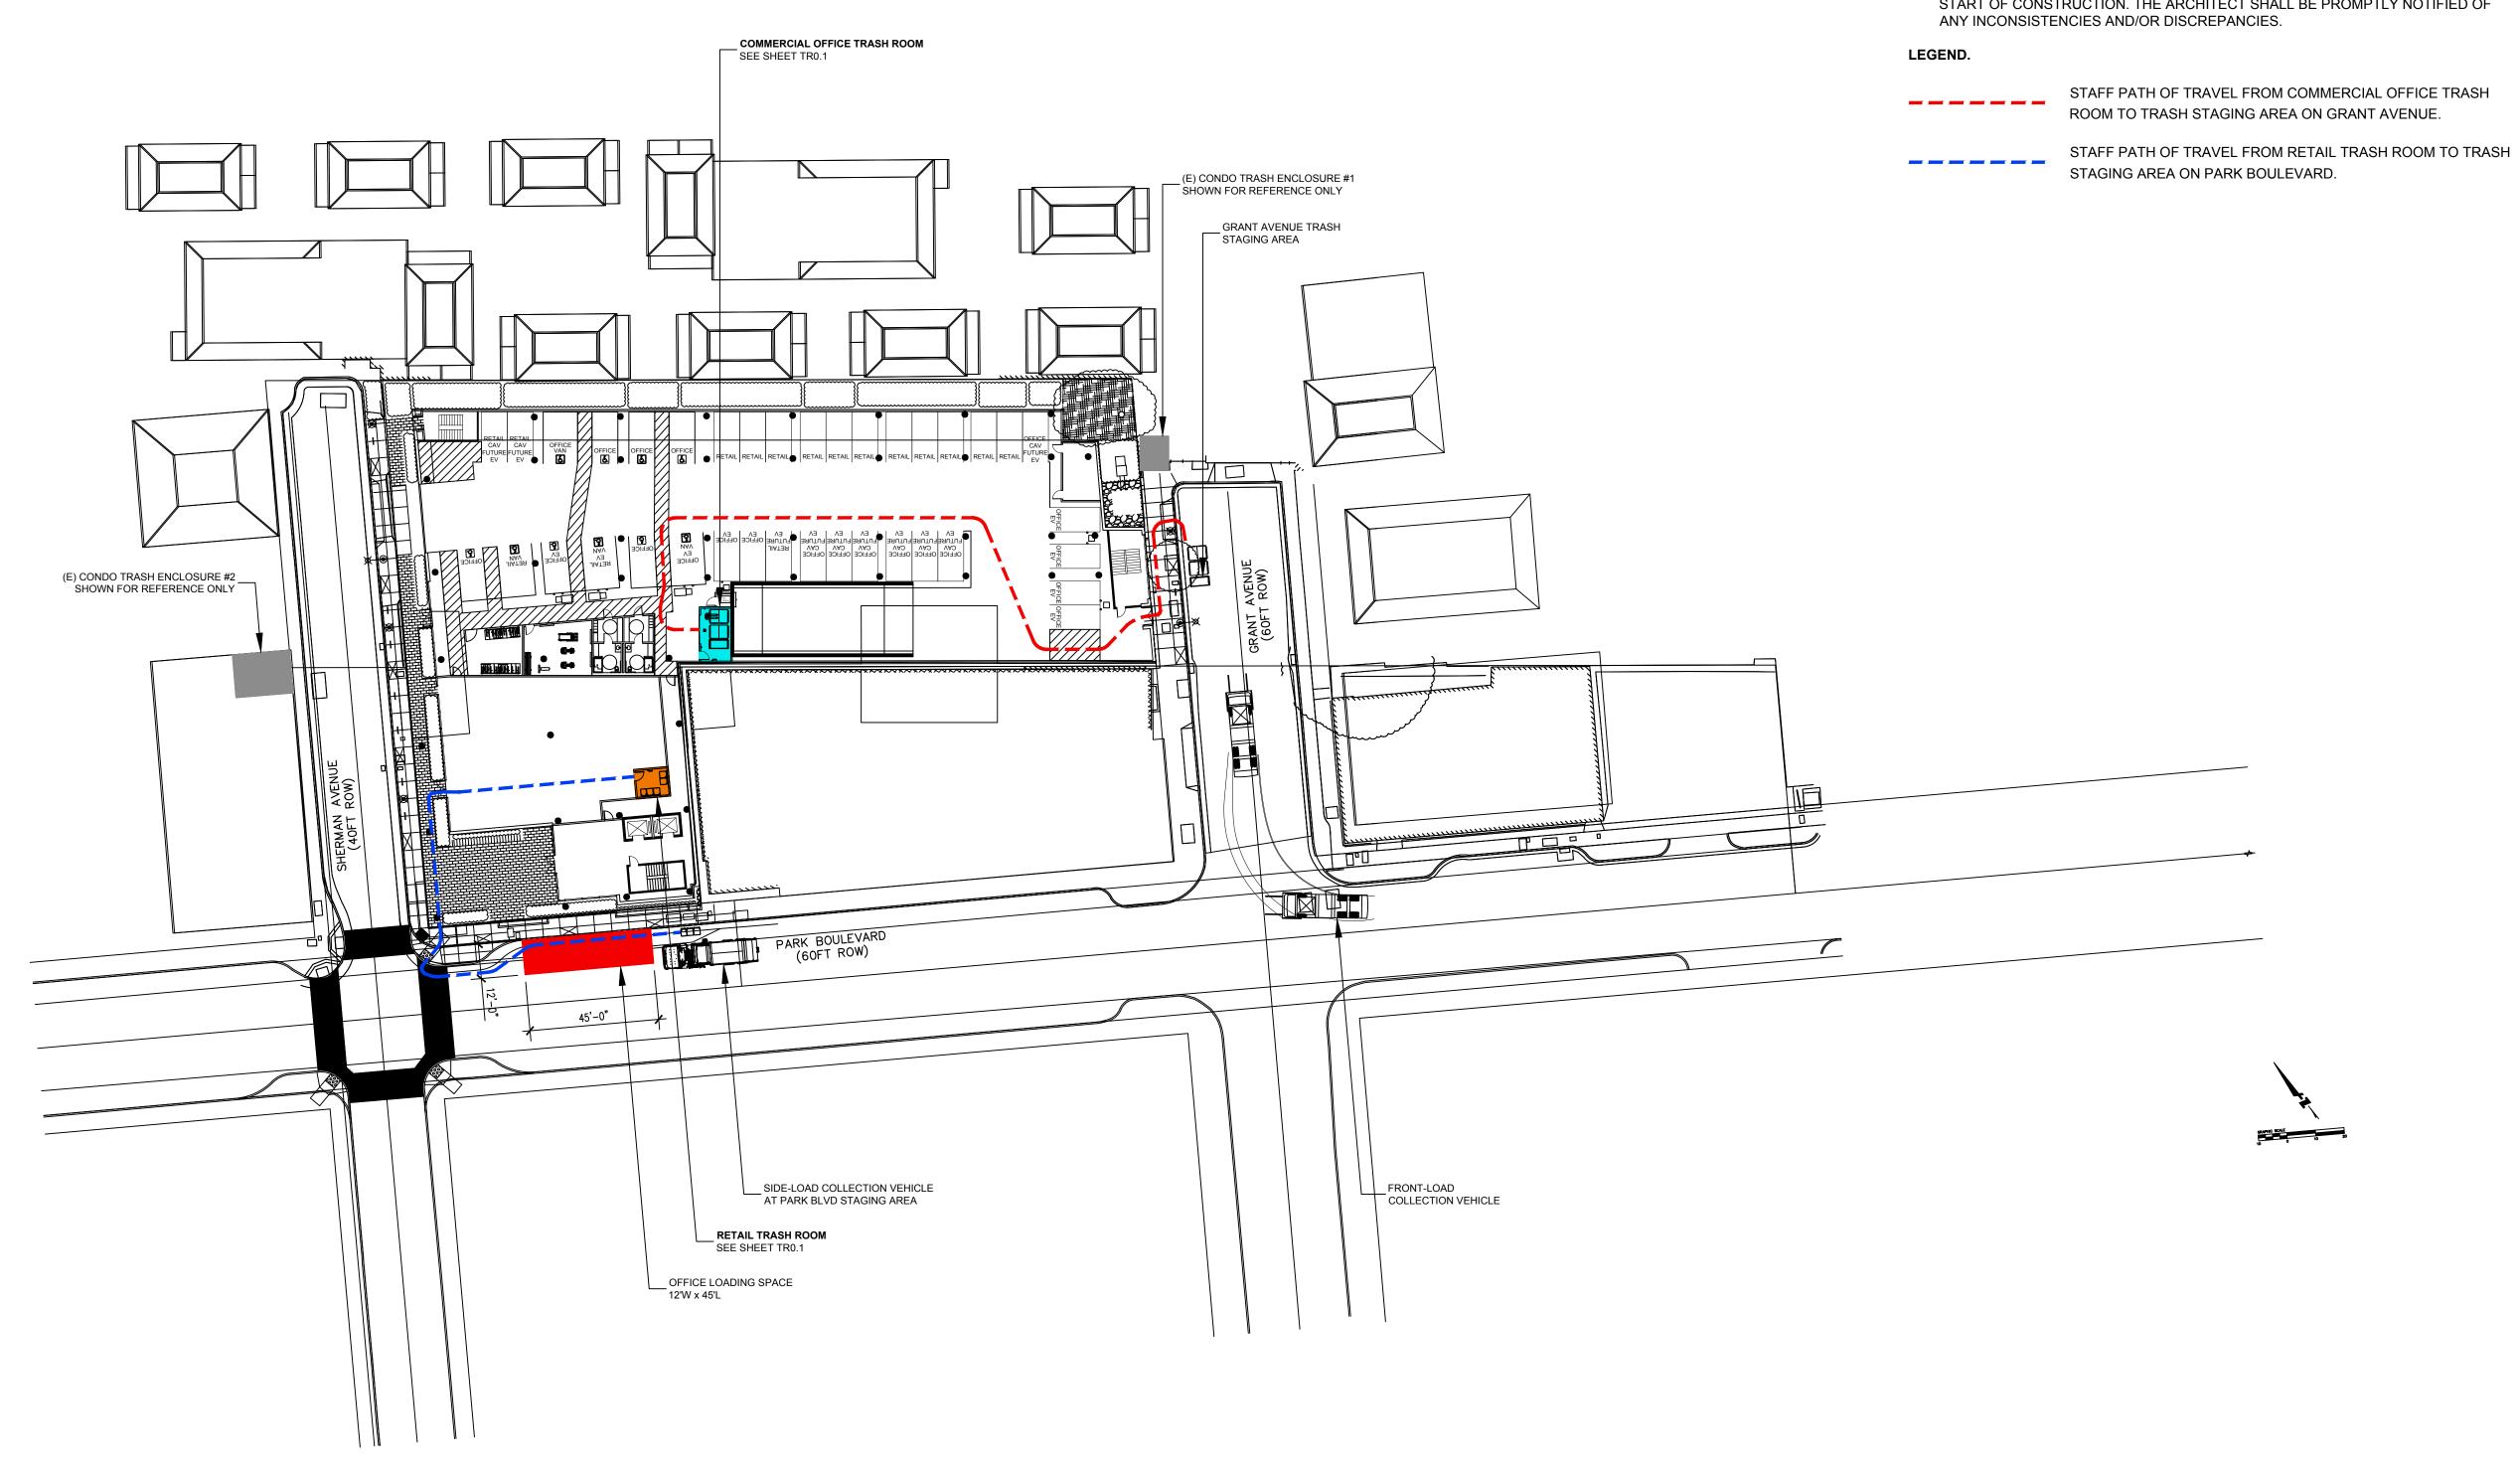

PROJECTED OFFICE ONLY TRASH COLLECTION SCHEDULE / WK									
SERVICE	М	Т	W	Т	F	S	SU		
LOOSE WASTE (4CY)	1		1						
LOOSE RECYCLE (4CY)		1		1					
COMPOST (2CY)	1								
TOTAL	2	1	1	1	0	0	0		

PROJECTED OFFICE W/ CAFETERIA TRASH COLLECTION SCHEDULE / WK									
SERVICE M T W T F S SU									
LOOSE WASTE (4CY)	1	1	1	1					
LOOSE RECYCLE (4CY)	1	1	1	1					
COMPOST (2CY)	1		1		1				
TOTAL	3	2	3	2	1	0	0		

PROJECTED RETAIL TRASH SCHEDULE / WK								
SERVICE	М	Т	W	Т	F	S	SU	
LOOSE WASTE (96G)	2							
LOOSE RECYCLE (96G)	2							
COMPOST (64G)	1							
TOTAL	5	0	0	0	0	0	0	

SHEET NOTES.

OFFICE TRASH ROOMS. GROUND LEVEL.

- TRASH COLLECTION ROOMS ARE 1HR FIRE-RATED RESTRICTED ACCESS.
 FLOOR SHALL BE FINISHED WITH WATERPROOF DECK COATING. FLOOR TO HAVE
- MINIMAL SLOPE (1° MAX) AND FLOOR DRAIN.
 3. WALLS SHALL BE FINISHED WITH WASHABLE WATERPROOF SURFACE SUCH AS
- FRP OR HIGH-GLOSS ENAMEL PAINT 8'-0" AFF.
- ROOM SHALL BE MECHANICALLY VENTILATED WITH (1) CFM/SF PER 2019 CBC.
 AT COMMERCIAL OFFICE TRASH PROVIDE 10'-0" WIDE ROLL-UP DOOR FOR
- TRANSFERRING CONTAINERS AND 3'-0" NFPA COMPLIANT FIRE EGRESS DOOR.

 6. AT RETAIL TRASH PROVIDE 3'-0" NFPA COMPLIANT FIRE EGRESS DOOR.
- 7. OC: ODOR CONTROL UNIT SHALL BE WALL-MOUNTED 60" AFF. 120V 15A SERVICE OUTLET REQUIRED.
- 8. HB: HOT AND COLD HOSE BIBB SHALL BE WALL-MOUNTED 60" AFF.
- PROVIDE ELECTRIC PALLET TRUCK FOR TRANSFERRING CONTAINERS. 4000LB CAPACITY WITH 45.5" TURNING RADIUS. 120V 15A SERVICE OUTLET REQUIRED.
 PROVIDE (1) UNDEDICATED 120V 15A SERVICE OUTLET REQUIRED FOR STAFF
- MAINTENANCE PURPOSE.

GENERAL NOTES.

- ANY DESIGNS OR SOLUTIONS SHOWN IN DRAWING, EITHER DIRECT OR IMPLIED, ARE HEREBY CLARIFIED AS EXAMPLES AND SHALL NOT BE CONSIDERED COMPLETE DESIGNS FOR CONSTRUCTION. THESE DRAWINGS ARE INTENDED TO SUPPLEMENT THE SUBMITTAL PACKAGE FROM ARCHITECT.
- ANY PARTIAL INFORMATION, OMISSIONS, OR INACCURATE DESCRIPTIONS OF WORK SHOWN IN DRAWINGS, WHICH ARE NECESSARY TO PERFORM THE SCOPE OF WORK, SHALL NOT RELIEVE THE CONTRACTOR FROM COMPLETION OF WORK. ALL WORK SHALL BE PERFORMED TO SATISFY THE MINIMUM REQUIREMENTS OF THE CURRENT APPLICABLE BUILDING CODES.
- CONTRACTOR SHALL FIELD VERIFY ALL DIMENSIONS AND CONDITIONS PRIOR TO START OF CONSTRUCTION. THE ARCHITECT SHALL BE PROMPTLY NOTIFIED OF ANY INCONSISTENCIES AND/OR DISCREPANCIES.



PALO ALTO, CA 94306

SMITH DEVELOPMENT

150 GRANT / 123 SHERMAN / 2501 PARK

AMERICAN TRASH MANAGEMENT, INC.

1900 Powell Street, Suite 220 Emeryville, CA 94608 P: 415.292.5400 F: 415.292.5410 www.trashmanage.com

ISSUES AND REVISIONS

NO. DATE DESCRIPTION

08.31.21 PLANNING RESUBMITTAL #1

02.04.22 PLANNING RESUBMITTAL #2

PROJECT NUMBER 20008


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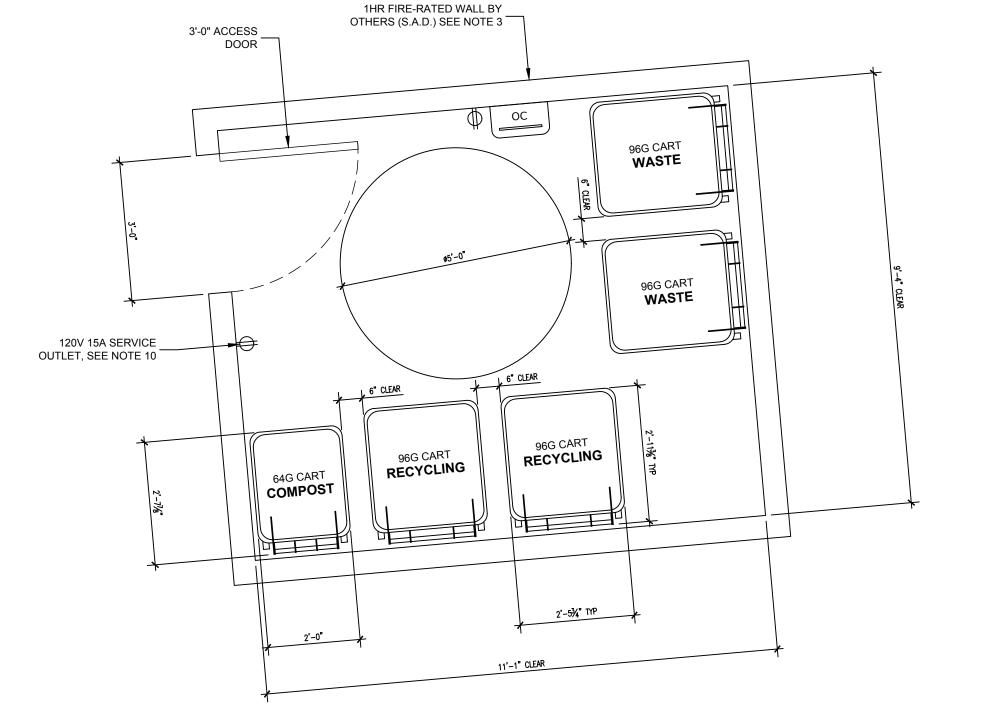
TRASH ROOM PLANS

SCALE
As Indicated

SHEET NUMBER

TR0.1



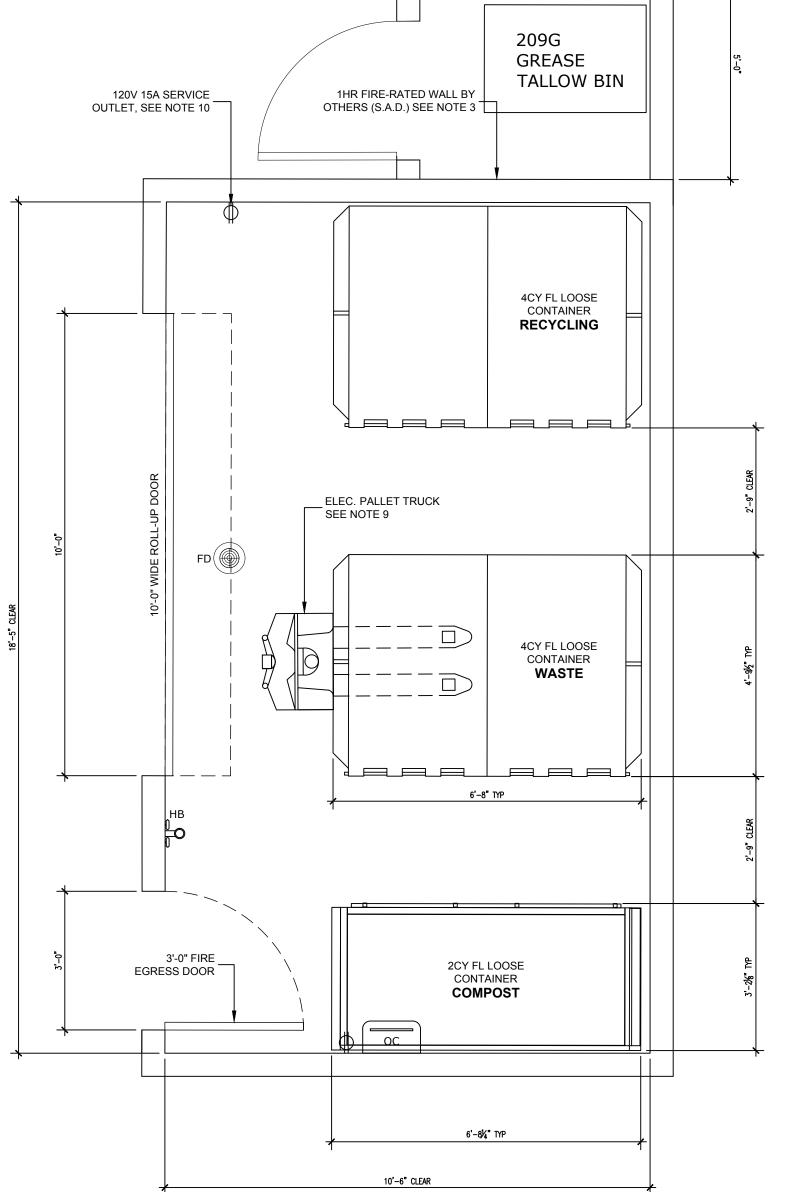

COMMERCIAL OFFICE TRASH ROOM PLAN

GROUND LEVEL SCALE: ½" = 1'-0"

RETAIL TRASH ROOM PLAN

GROUND LEVEL SCALE: ½" = 1'-0"



P2 PARKING LEVEL

SMITH DEVELOPMENT

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ISSUES AND REVISIONS DESCRIPTION

05.25.21 PLANNING SUBMITTAL

PLANNING RESUBMITTAL #1

02.04.22 PLANNING RESUBMITTAL #2

PROJECT NUMBER 20008

SHEET TITLE

PROPOSED PLAN PARKING PLAN P2


3/32" = 1'-0"

SCALE

SHEET NUMBER

A2.P2

P2 LEVEL (82 TOTAL OFFICE STALLS)
24 LIFTS (48 STALLS) (9' X 17.5') WITH 6'-11" DEEP PIT & 13'-6" CLEAR HEIGHT 4 STD 90-DEGREE STALL (8.5' X 17.5') WITH 25' DRIVE AISLE 30 STD 90-DEGREE STALLS (9' X 17.5') WITH 24' DRIVE AISLE

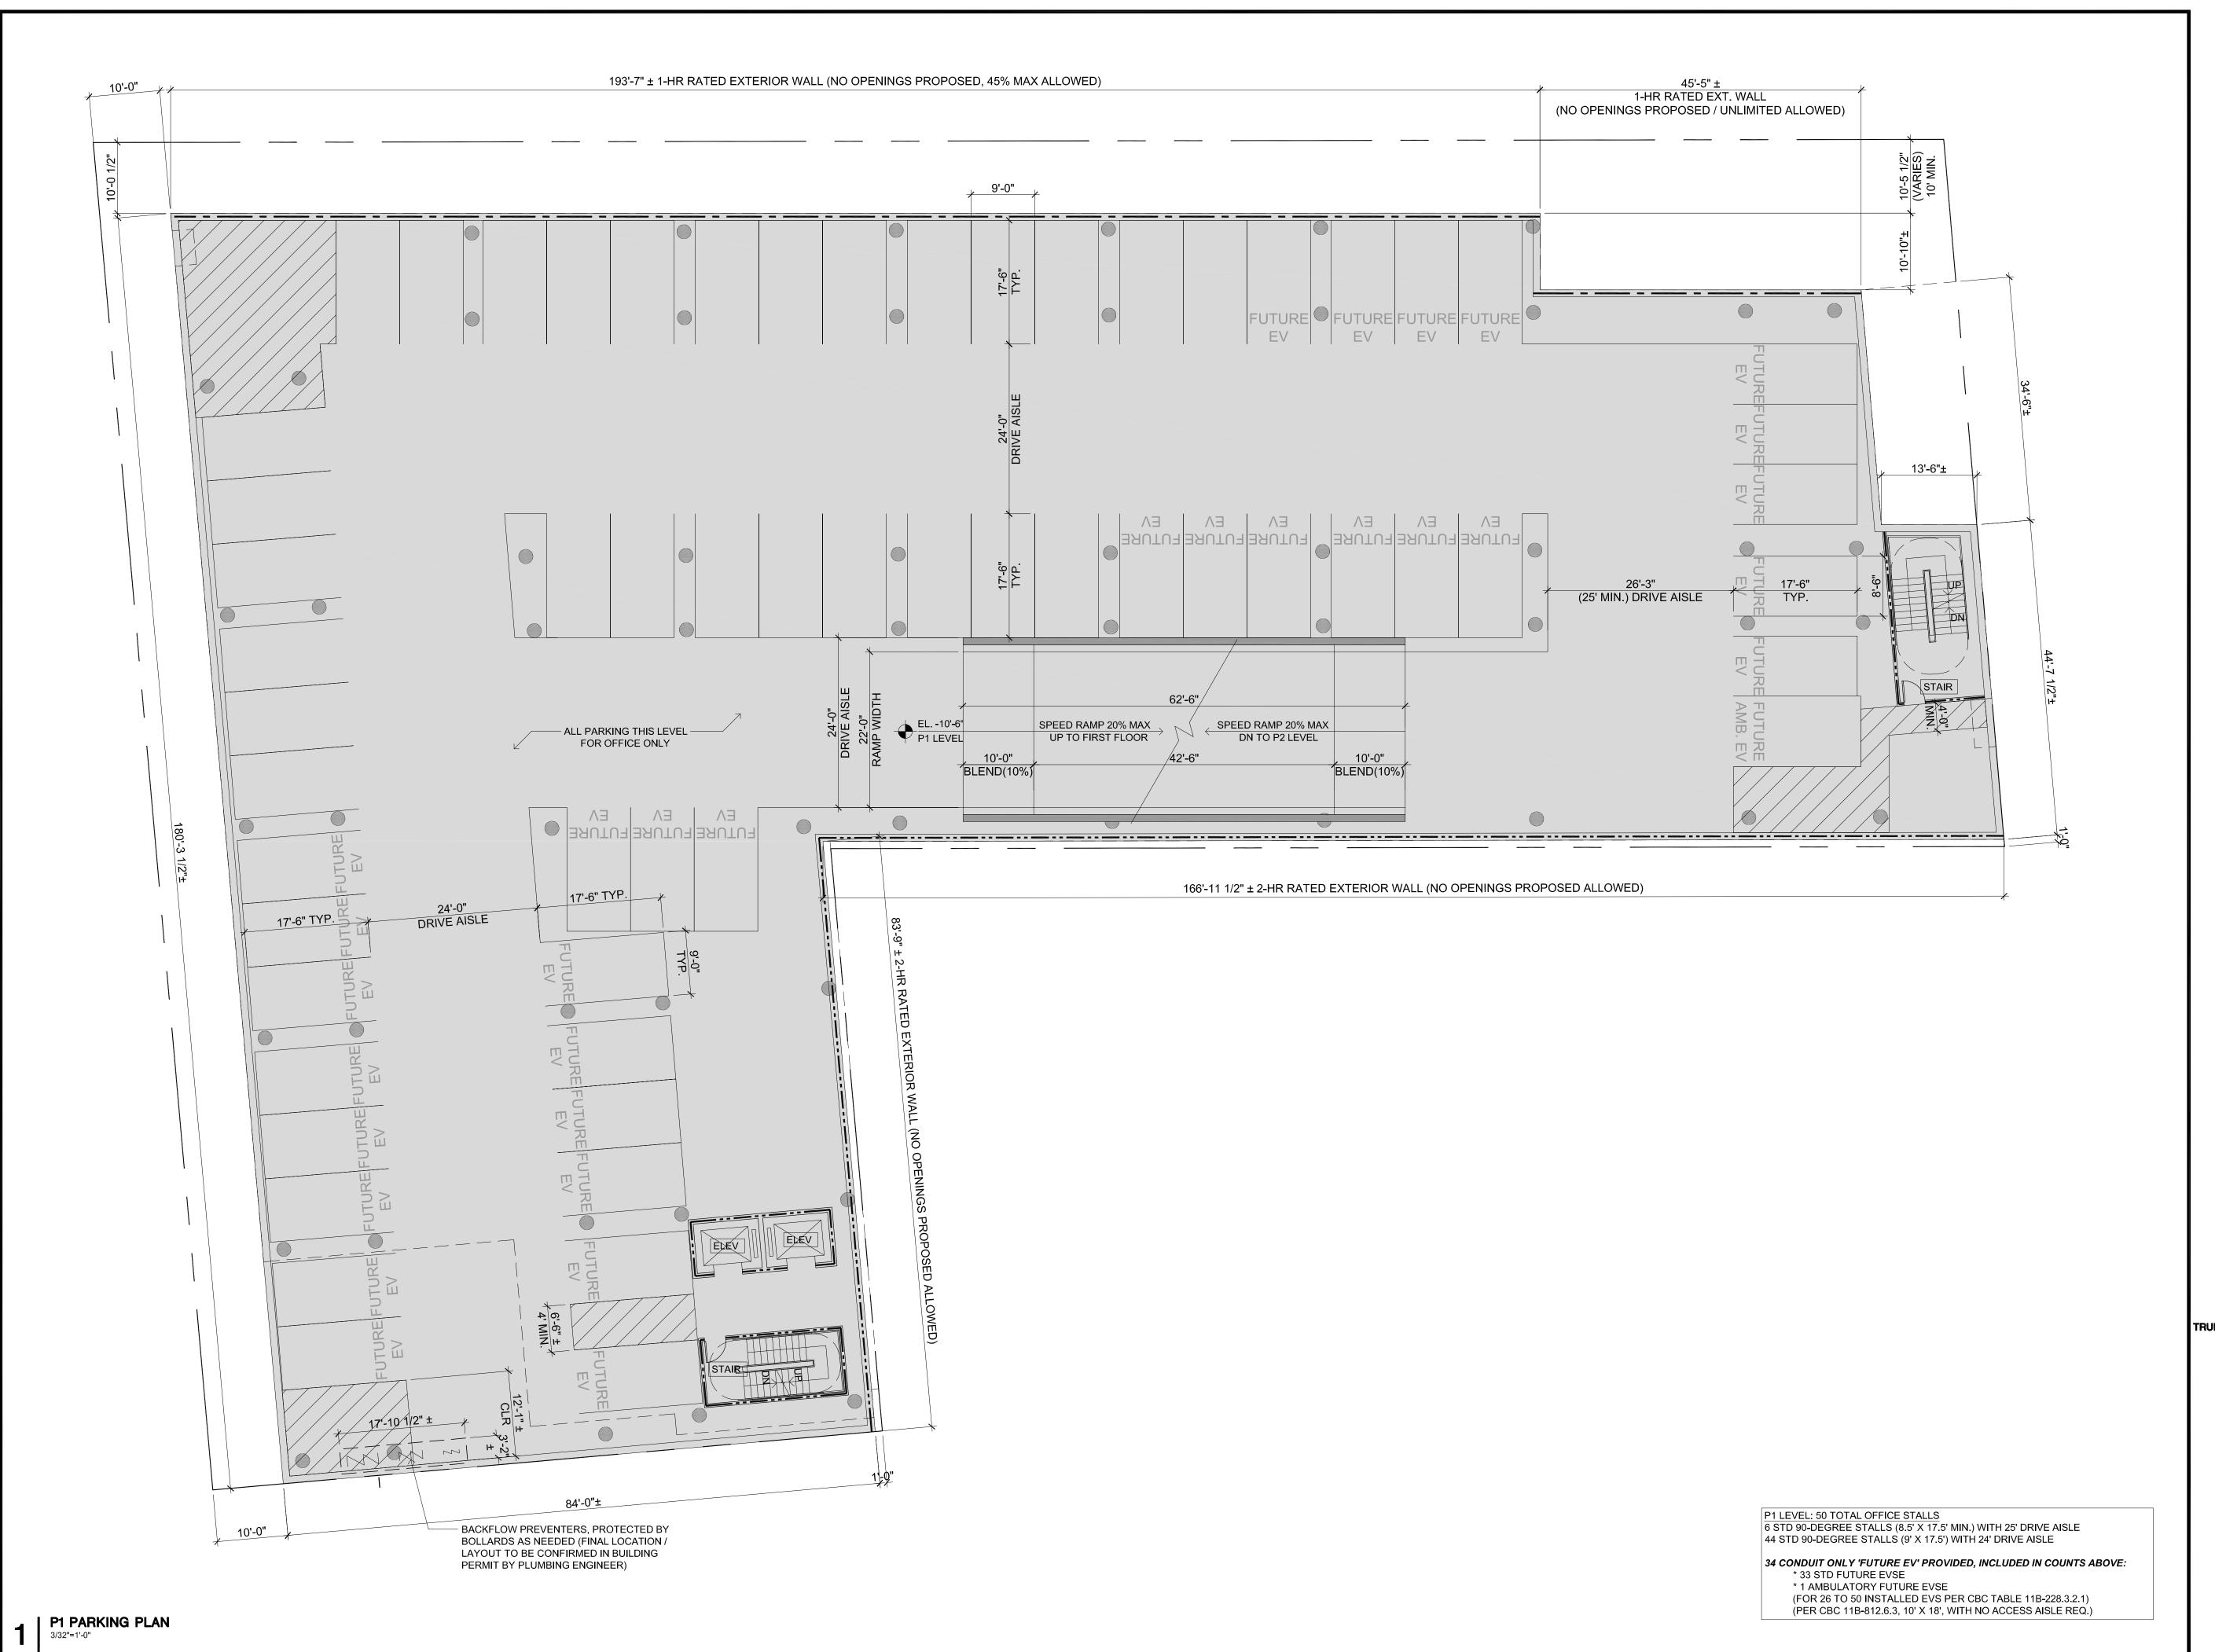

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ISSUES AND REVISIONS

05.25.21 PLANNING SUBMITTAL

08.31.21 PLANNING RESUBMITTAL #1


02.04.22 PLANNING RESUBMITTAL #2

PROJECT NUMBER 20008

SHEET TITLE

PROPOSED PLAN PARKING PLAN P1

SCALE 3/32" = 1'-0"

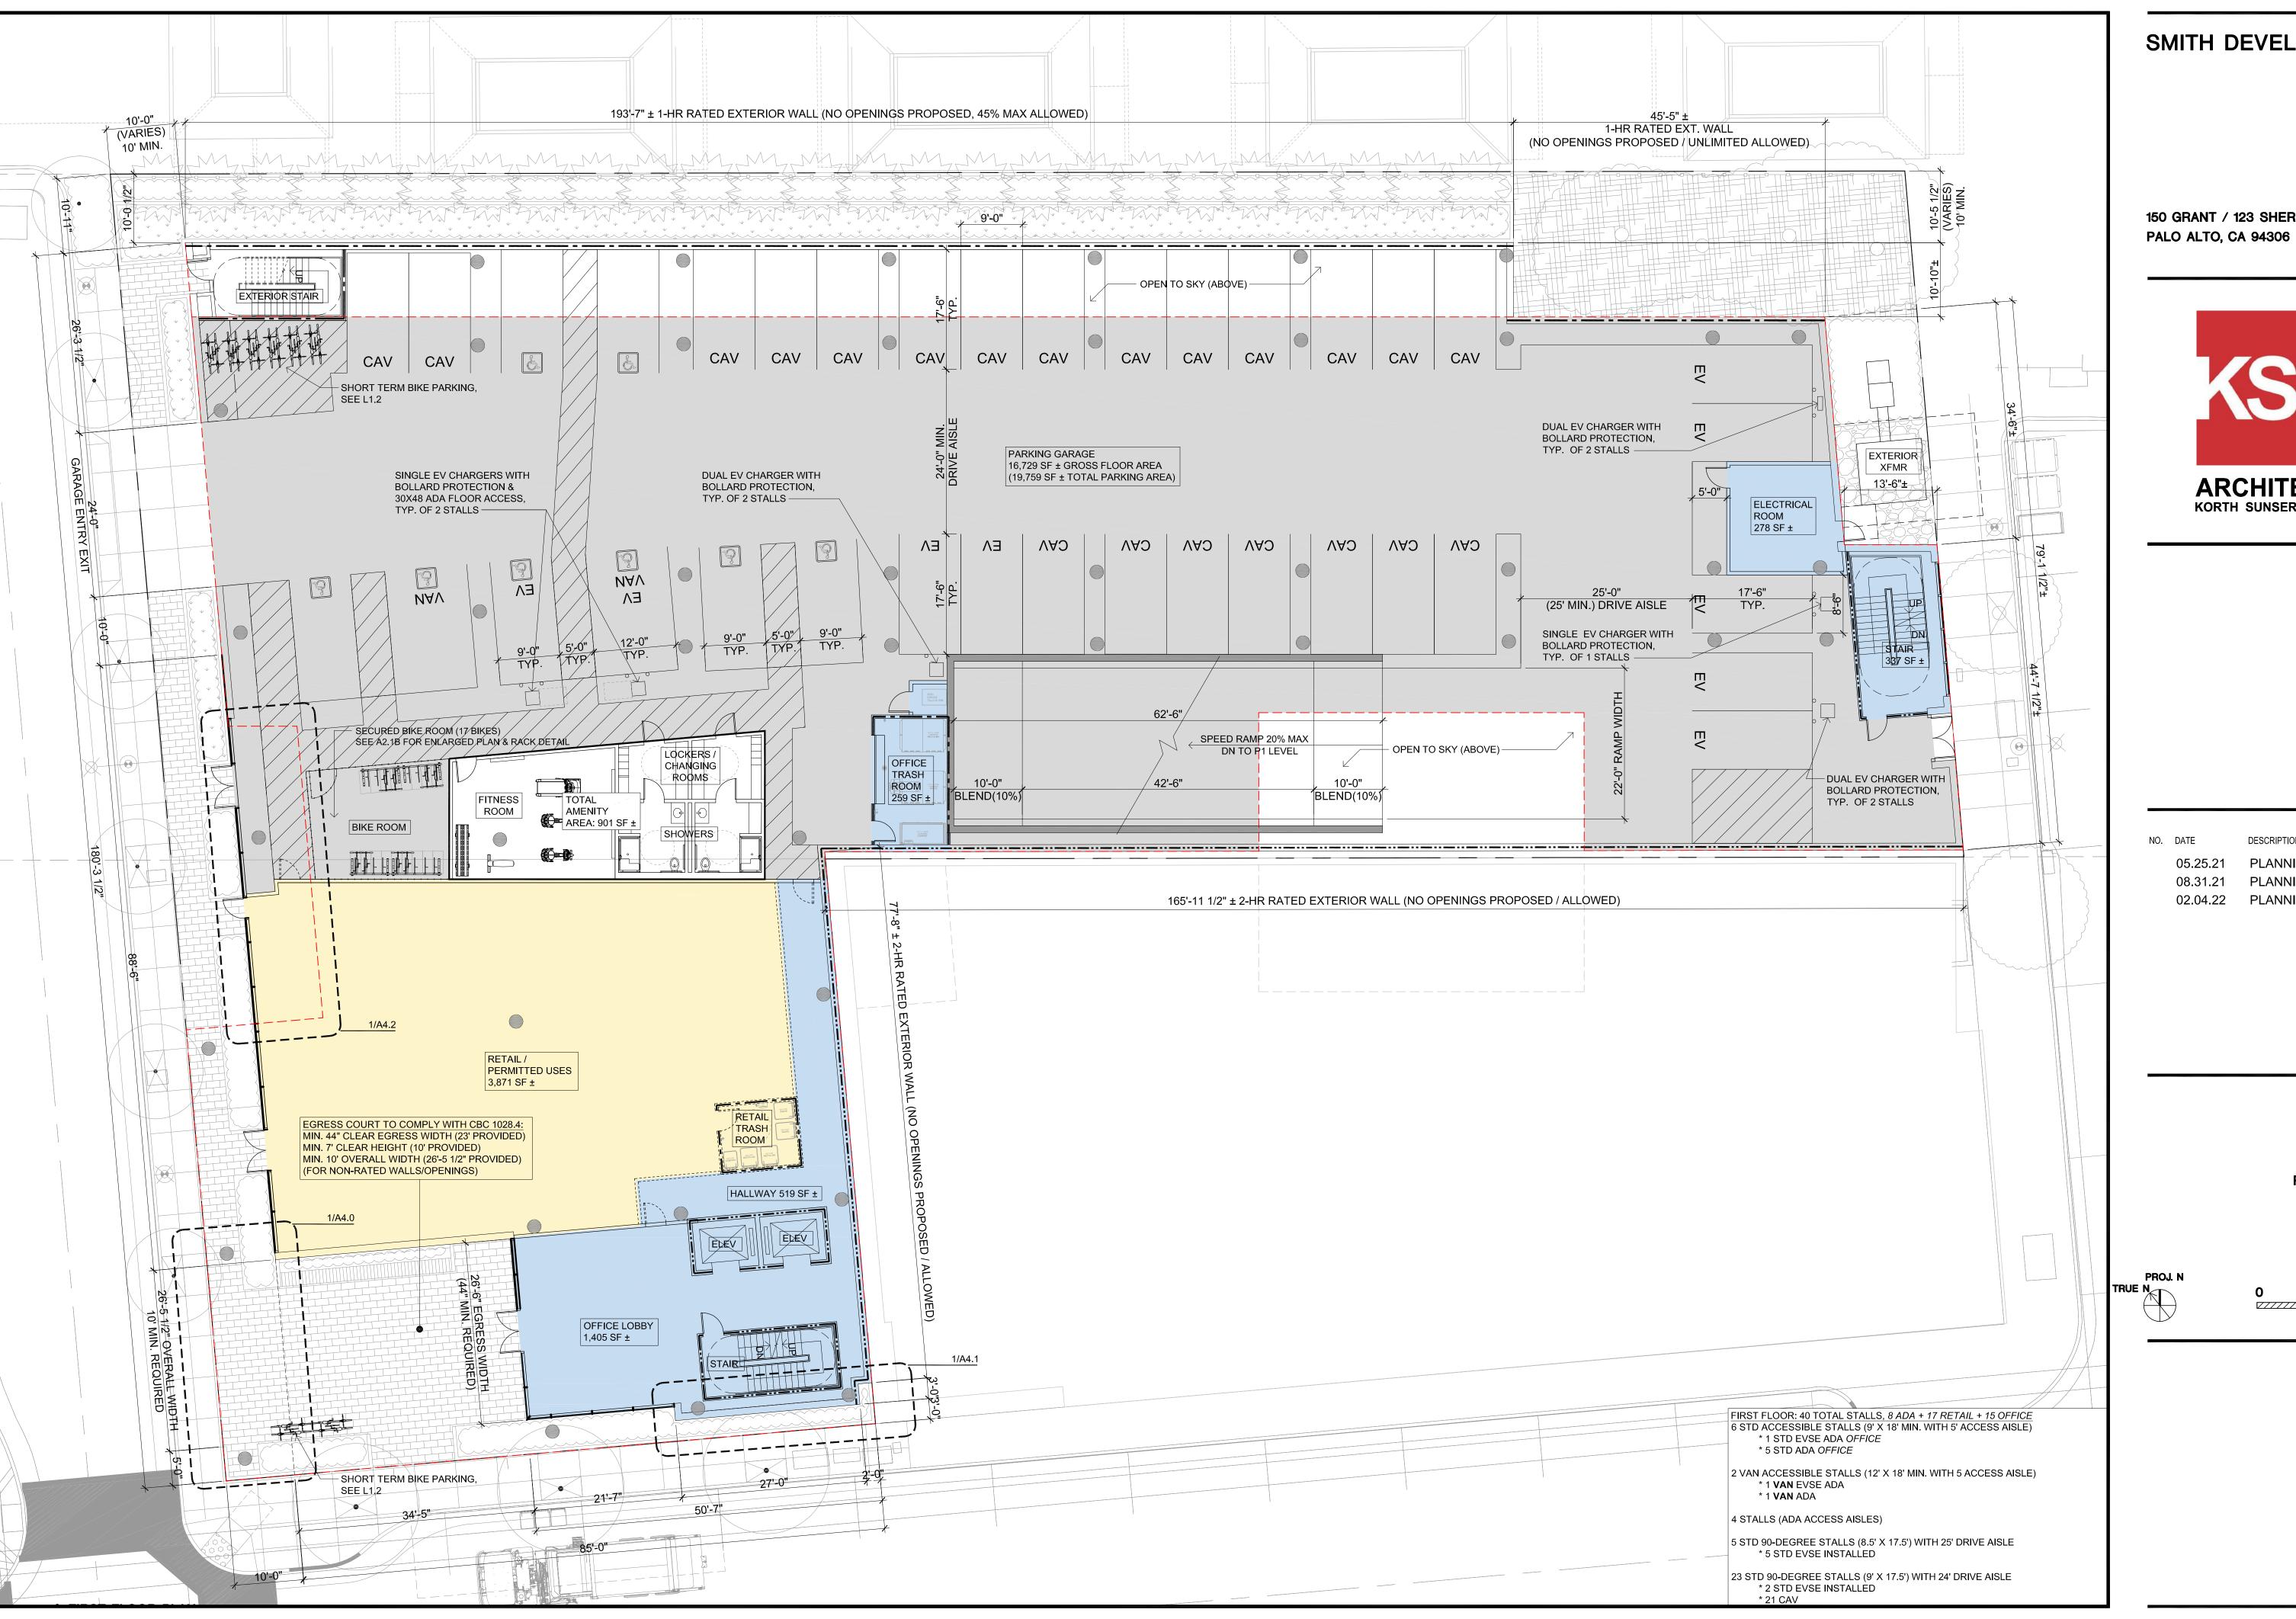

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ISSUES AND REVISIONS

05.25.21 PLANNING SUBMITTAL 08.31.21 PLANNING RESUBMITTAL #1

02.04.22 PLANNING RESUBMITTAL #2

PROJECT NUMBER

SHEET TITLE

PROPOSED PLAN FIRST FLOOR

SCALE

3/32" = 1'-0"





Example shown above is a 4-unit section.

Lengths may vary based on your space.

Ultra Space Saver Squared

Single Sided Parts

Dero's Ultra Space Saver Squared offers high-security, vertical bike parking. Adjustable sliding arms make it easy for customers to best utilize their space. It also creates flexibility to make sure bike spacing follows city requirements as they evolve. Pipecutter resistant squared steel tubing makes the Ultra Space Saver Squared more secure than the original Ultra Space Saver.

Patent D774,441

©2021

Installation

The Ultra Space Saver Squared has several steps for installation.

Note that the single and double sided setups and parts are different.

Make sure you follow the instructions according to the model you

Ultra Space Saver Squared


Recommended Base Materials:

Solid concrete is the best base material for installation. Make sure nothing is underneath the base material that could be damaged by drilling (i.e. post-tension cable). Use the 3.75" wedge anchors that are included to install the rack into the concrete (wall anchors are 3").


Installation:

Sort out the parts to the rack and identify each of them accordingly. The 1" carriage bolts are for assembly of the rack and the 3.75" wedge anchors are for mounting the rack to the floor.

Reading your Dero designed layout

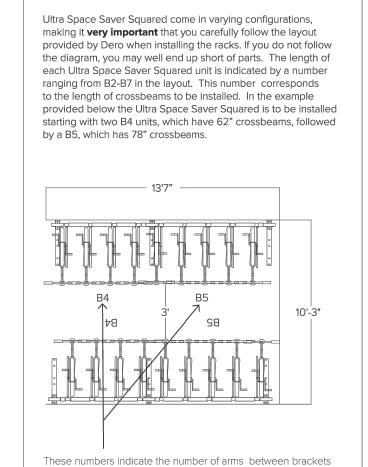

for each Ultra Space Saver Squared unit to be installed.

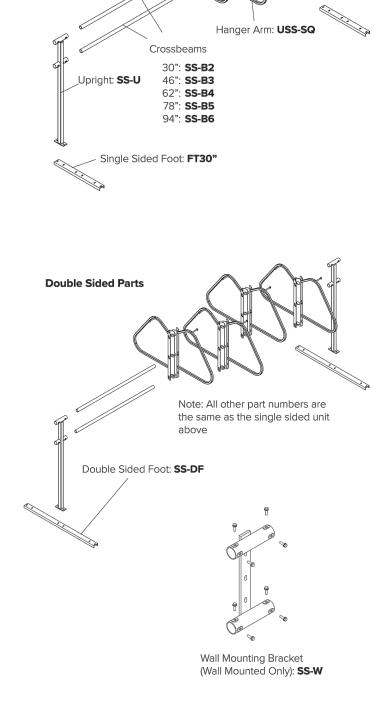

min. ceiling 87"

57.5"


56"

47.5"

116"

Setbacks

Ultra Space Saver Squared **Submittal Sheet** Modular construction 1 bike per arm Hanger: 1" square tube with steel slider head with tamperproof locking bolts. Upright: 2" square tube. Feet: AISI C3 x 4.1 galvanized steel channel. Crossbeams: 2" sched. 40 galvanized pipe. Black Powder Coat (Interior Use) Our interior powder coat finish assures a high level of adhesion and durability for indoor use by following these 1. Sandblast 2. Final thick TGIC polyester powder coat Black Powder Coat (Exterior Use) Additional Cost Our exterior powder coat finish assures a high level of adhesion and durability for outdoor or exposed air use by following these steps: 1. Sandblast 2. Epoxy primer electrostatically applied 3. Final thick TGIC polyester powder coat Floor mount Ultra Space Saver Squared have steel channel feet (30" for single sided and 56" for double sided units) which must be Ultra Space Saver Squared sections anchored to the floor. vary in length to fit most spaces A wall mounted unit which contains special brackets is also available for CMU or solid concrete walls. Cannot be used on sheetrock without additional support. Include wheel stops Optional wheel stops are available for an ____ additional cost 21'8" As a general guideline, the above space can fit approximately 60 bicycles. The Ultra Space Saver Squared parks one bike every 16" with a typical bike extending out 42" from the wall.

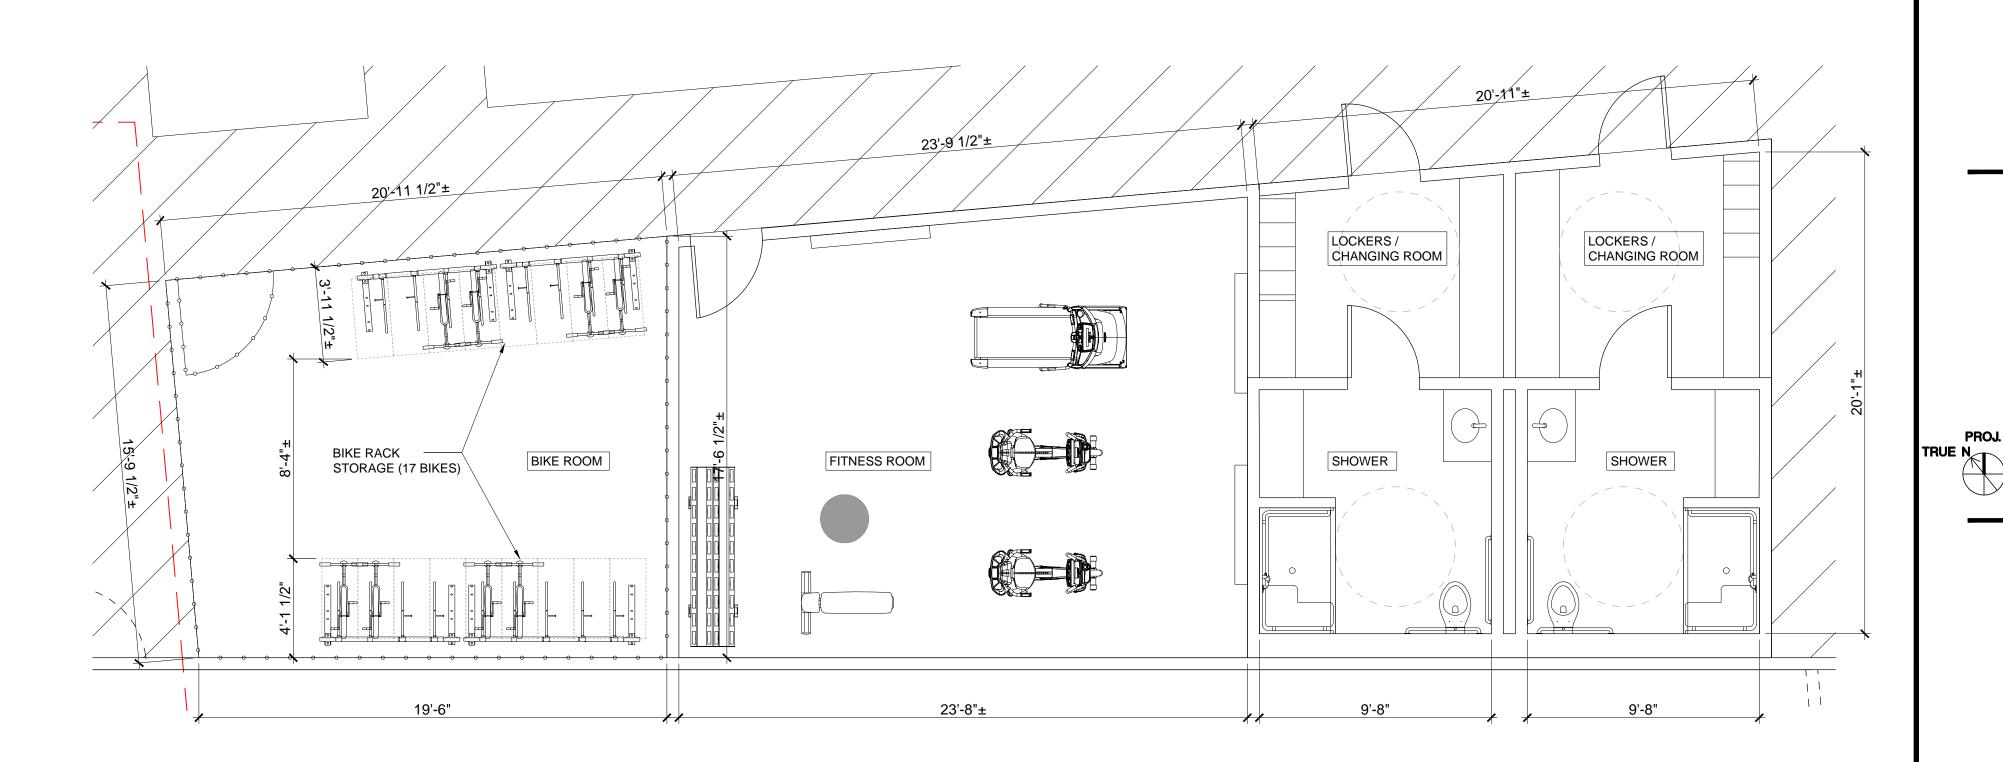

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ISSUES AND REVISIONS

TE DESCRIPTION

02.04.22 PLANNING RESUBMITTAL #2

PROJECT NUMBER

SHEET TITLE

LONG TERM BIKE STORAGE

SCALE


1/4" = 1'-0"

0 4'-0" 8'-

SHEET NUMBER

A2.1B

ENLARGED BIKE ROOM & SHOWER / CHANGING ROOM & GYM PLAN

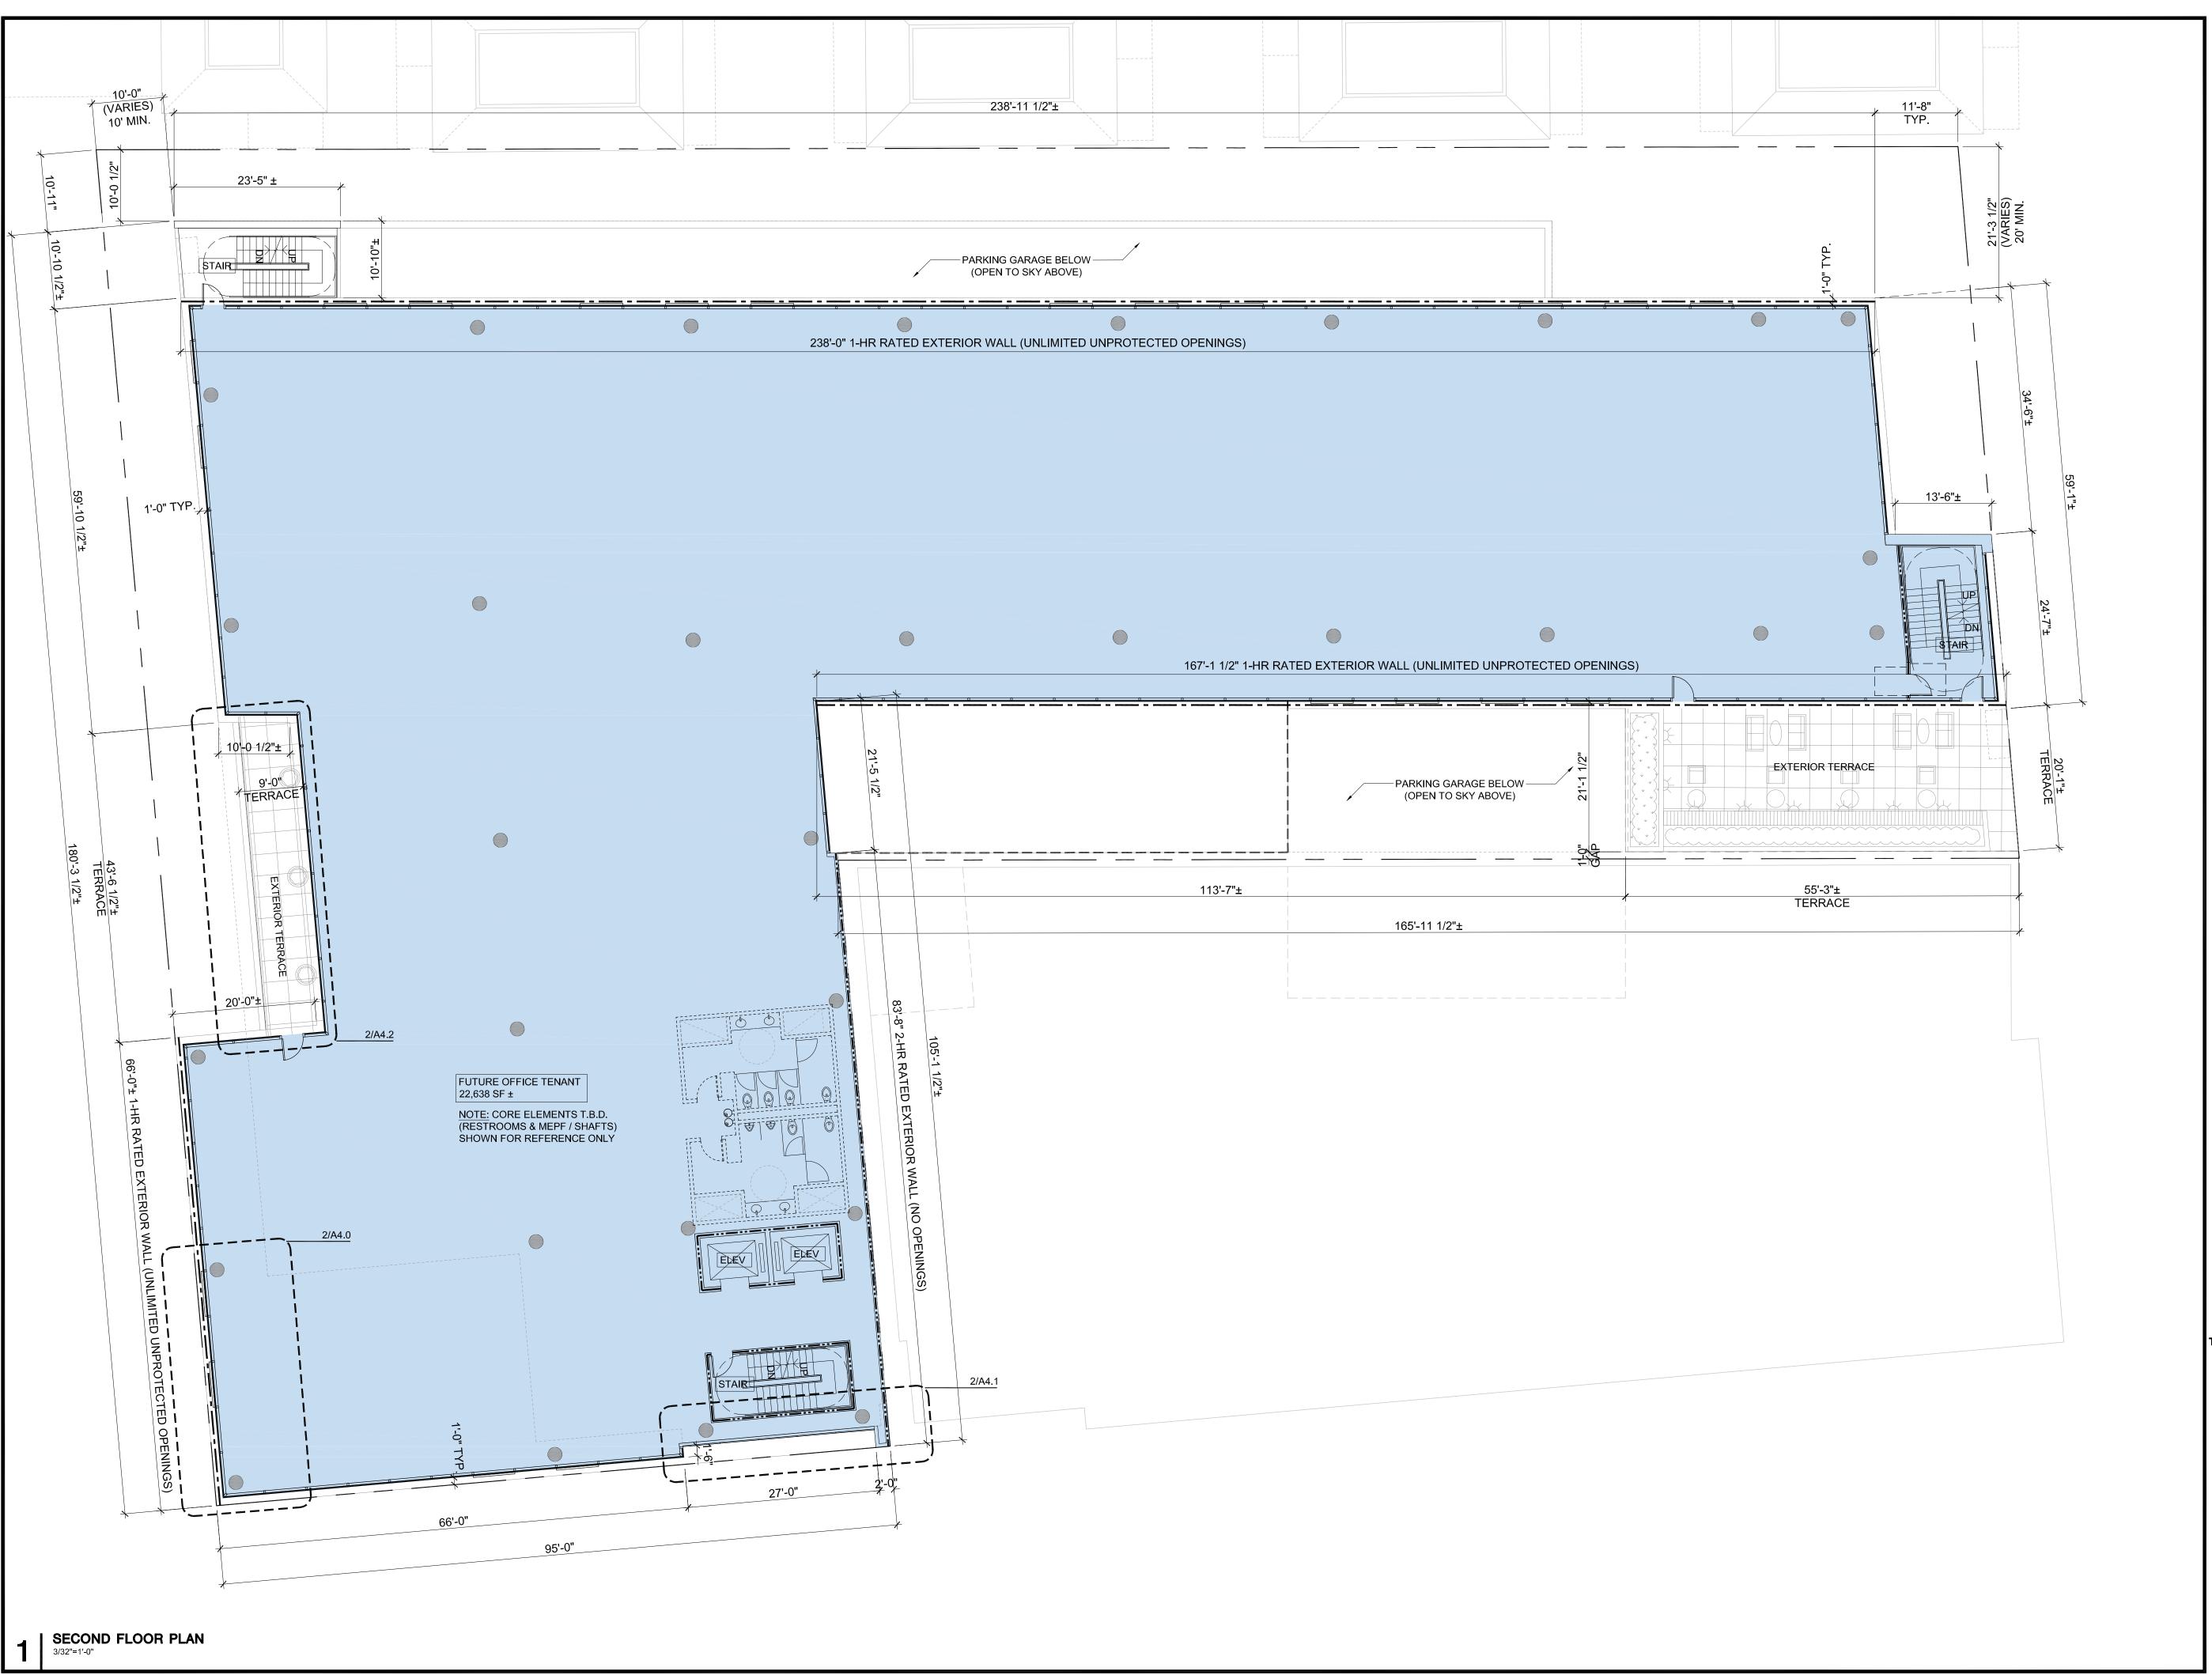

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ISSUES AND REVISIONS

05.25.21 PLANNING SUBMITTAL PLANNING RESUBMITTAL #1


02.04.22 PLANNING RESUBMITTAL #2

SHEET TITLE

PROPOSED PLAN SECOND FLOOR

3/32" = 1'-0"

SCALE

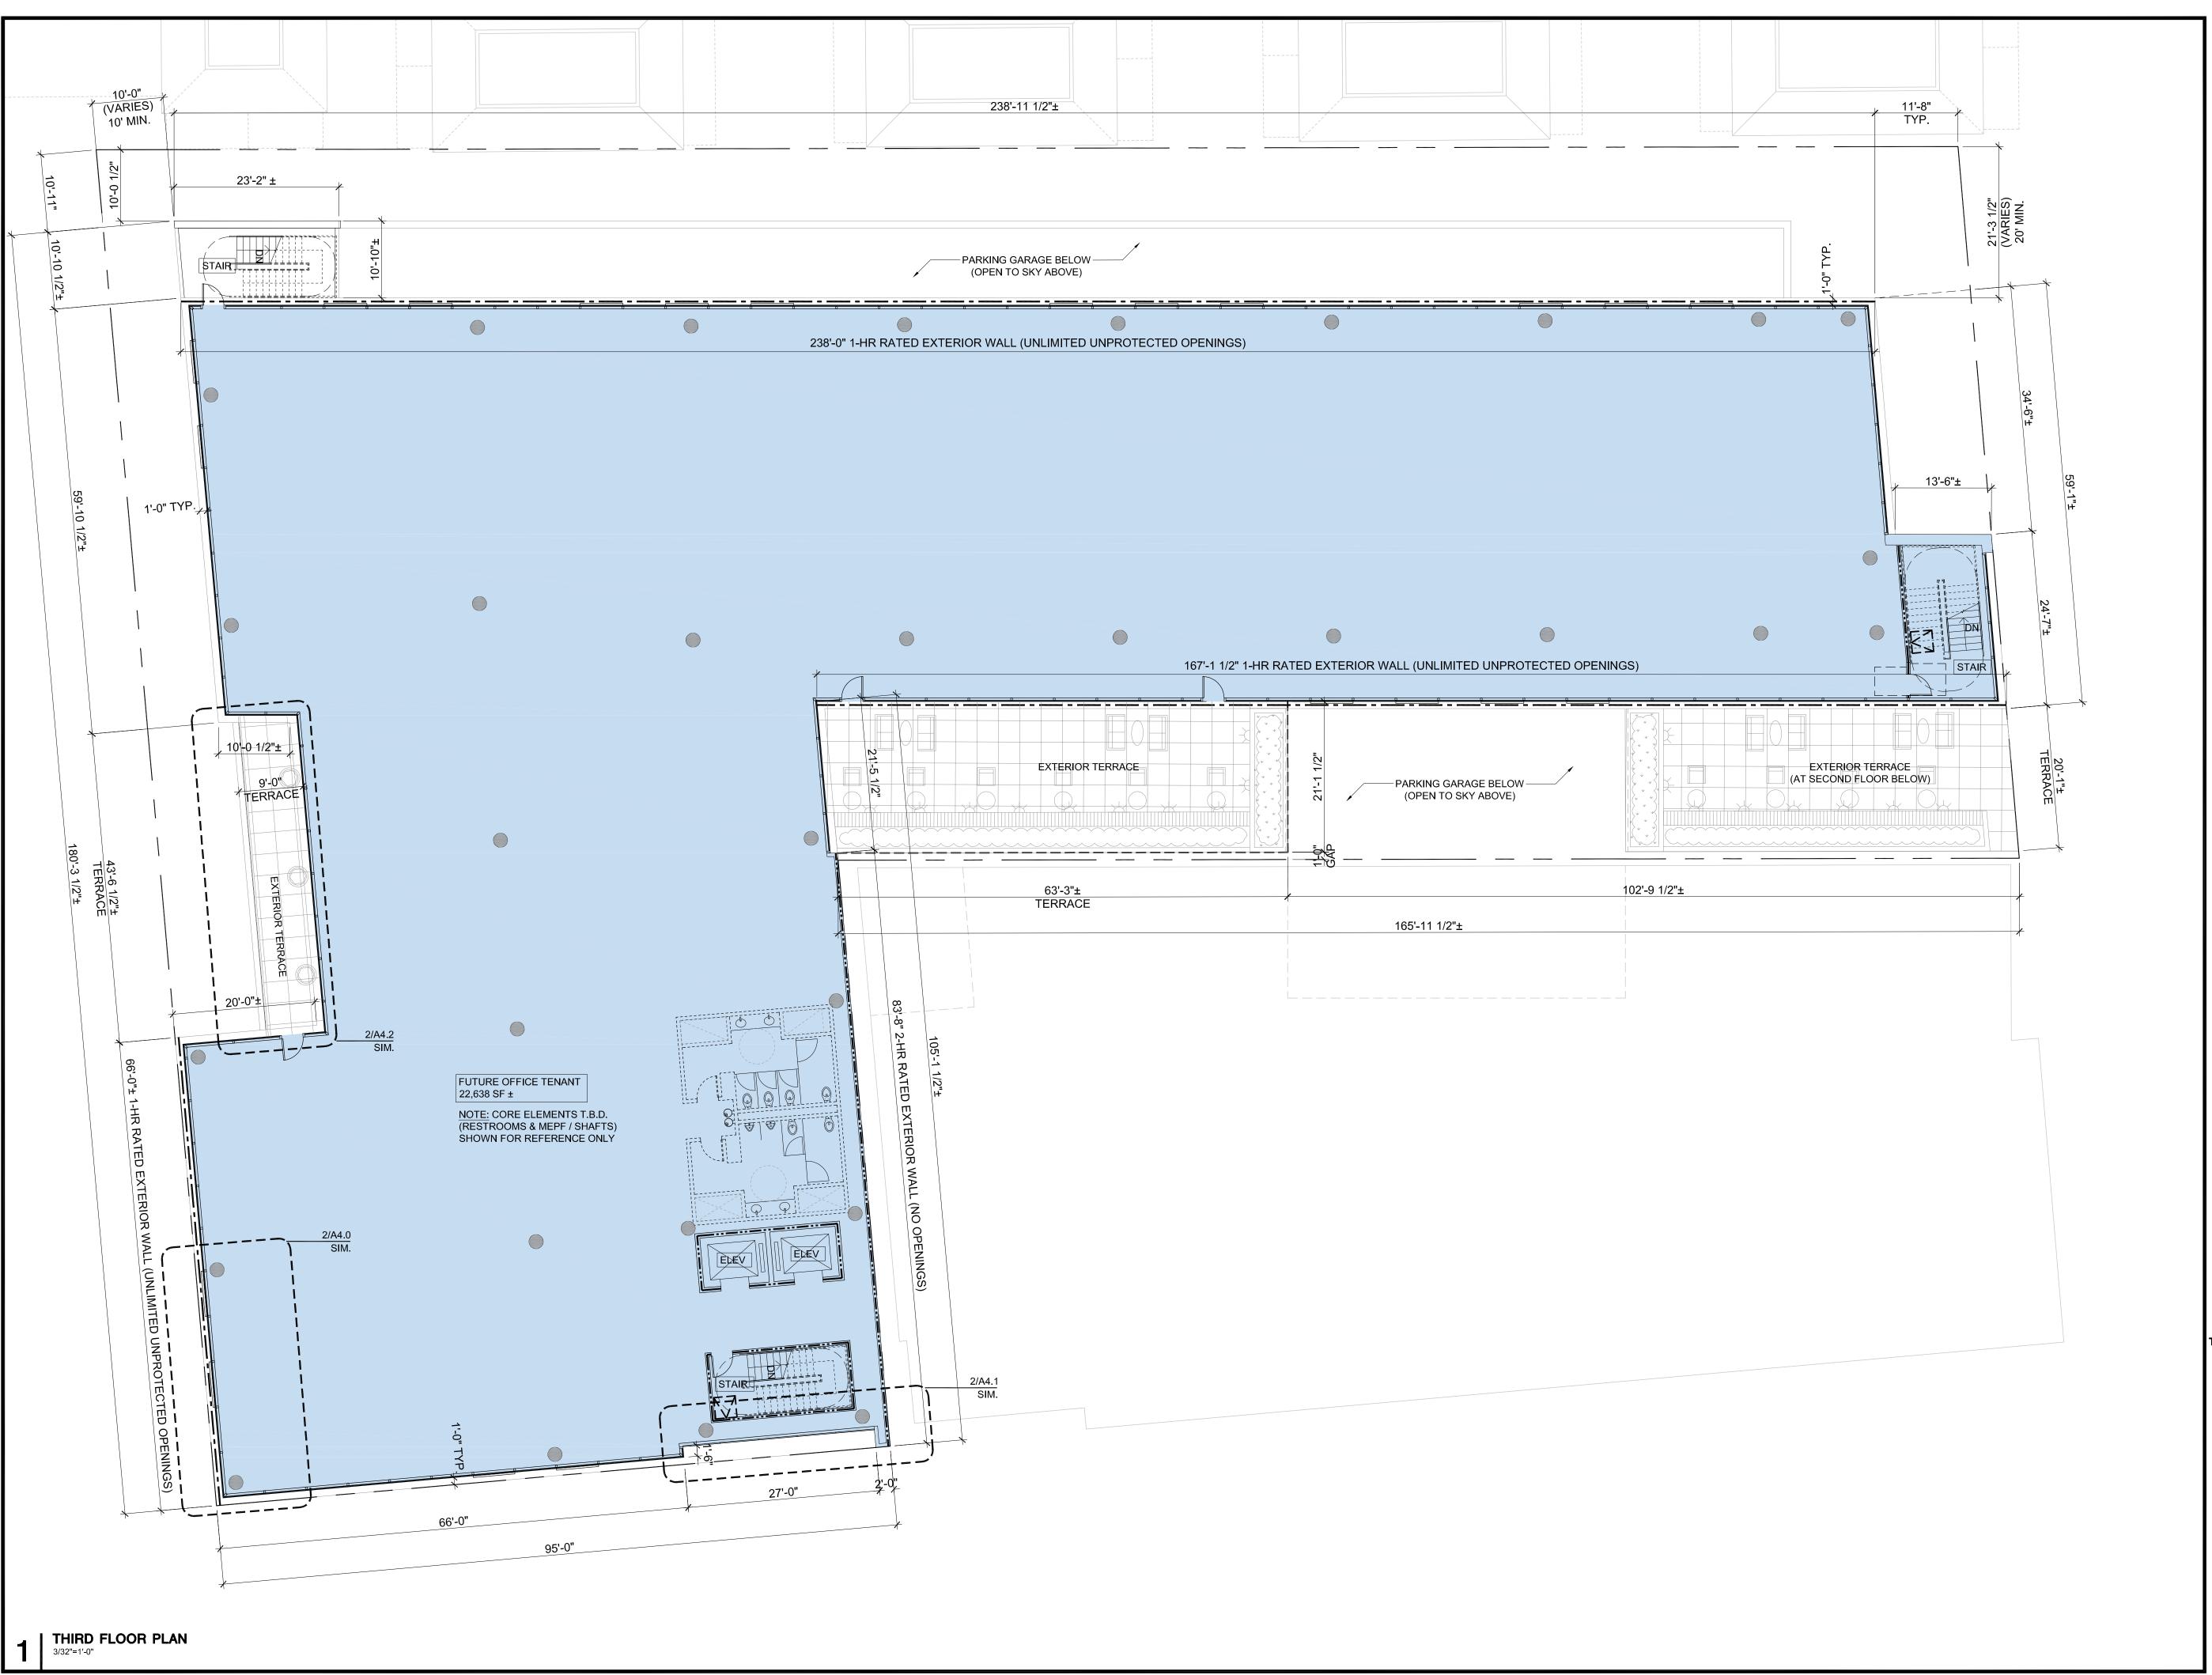

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ISSUES AND REVISIONS

05.25.21 PLANNING SUBMITTAL PLANNING RESUBMITTAL #1


02.04.22 PLANNING RESUBMITTAL #2

SHEET TITLE

PROPOSED PLAN THIRD FLOOR

SCALE

3/32" = 1'-0"

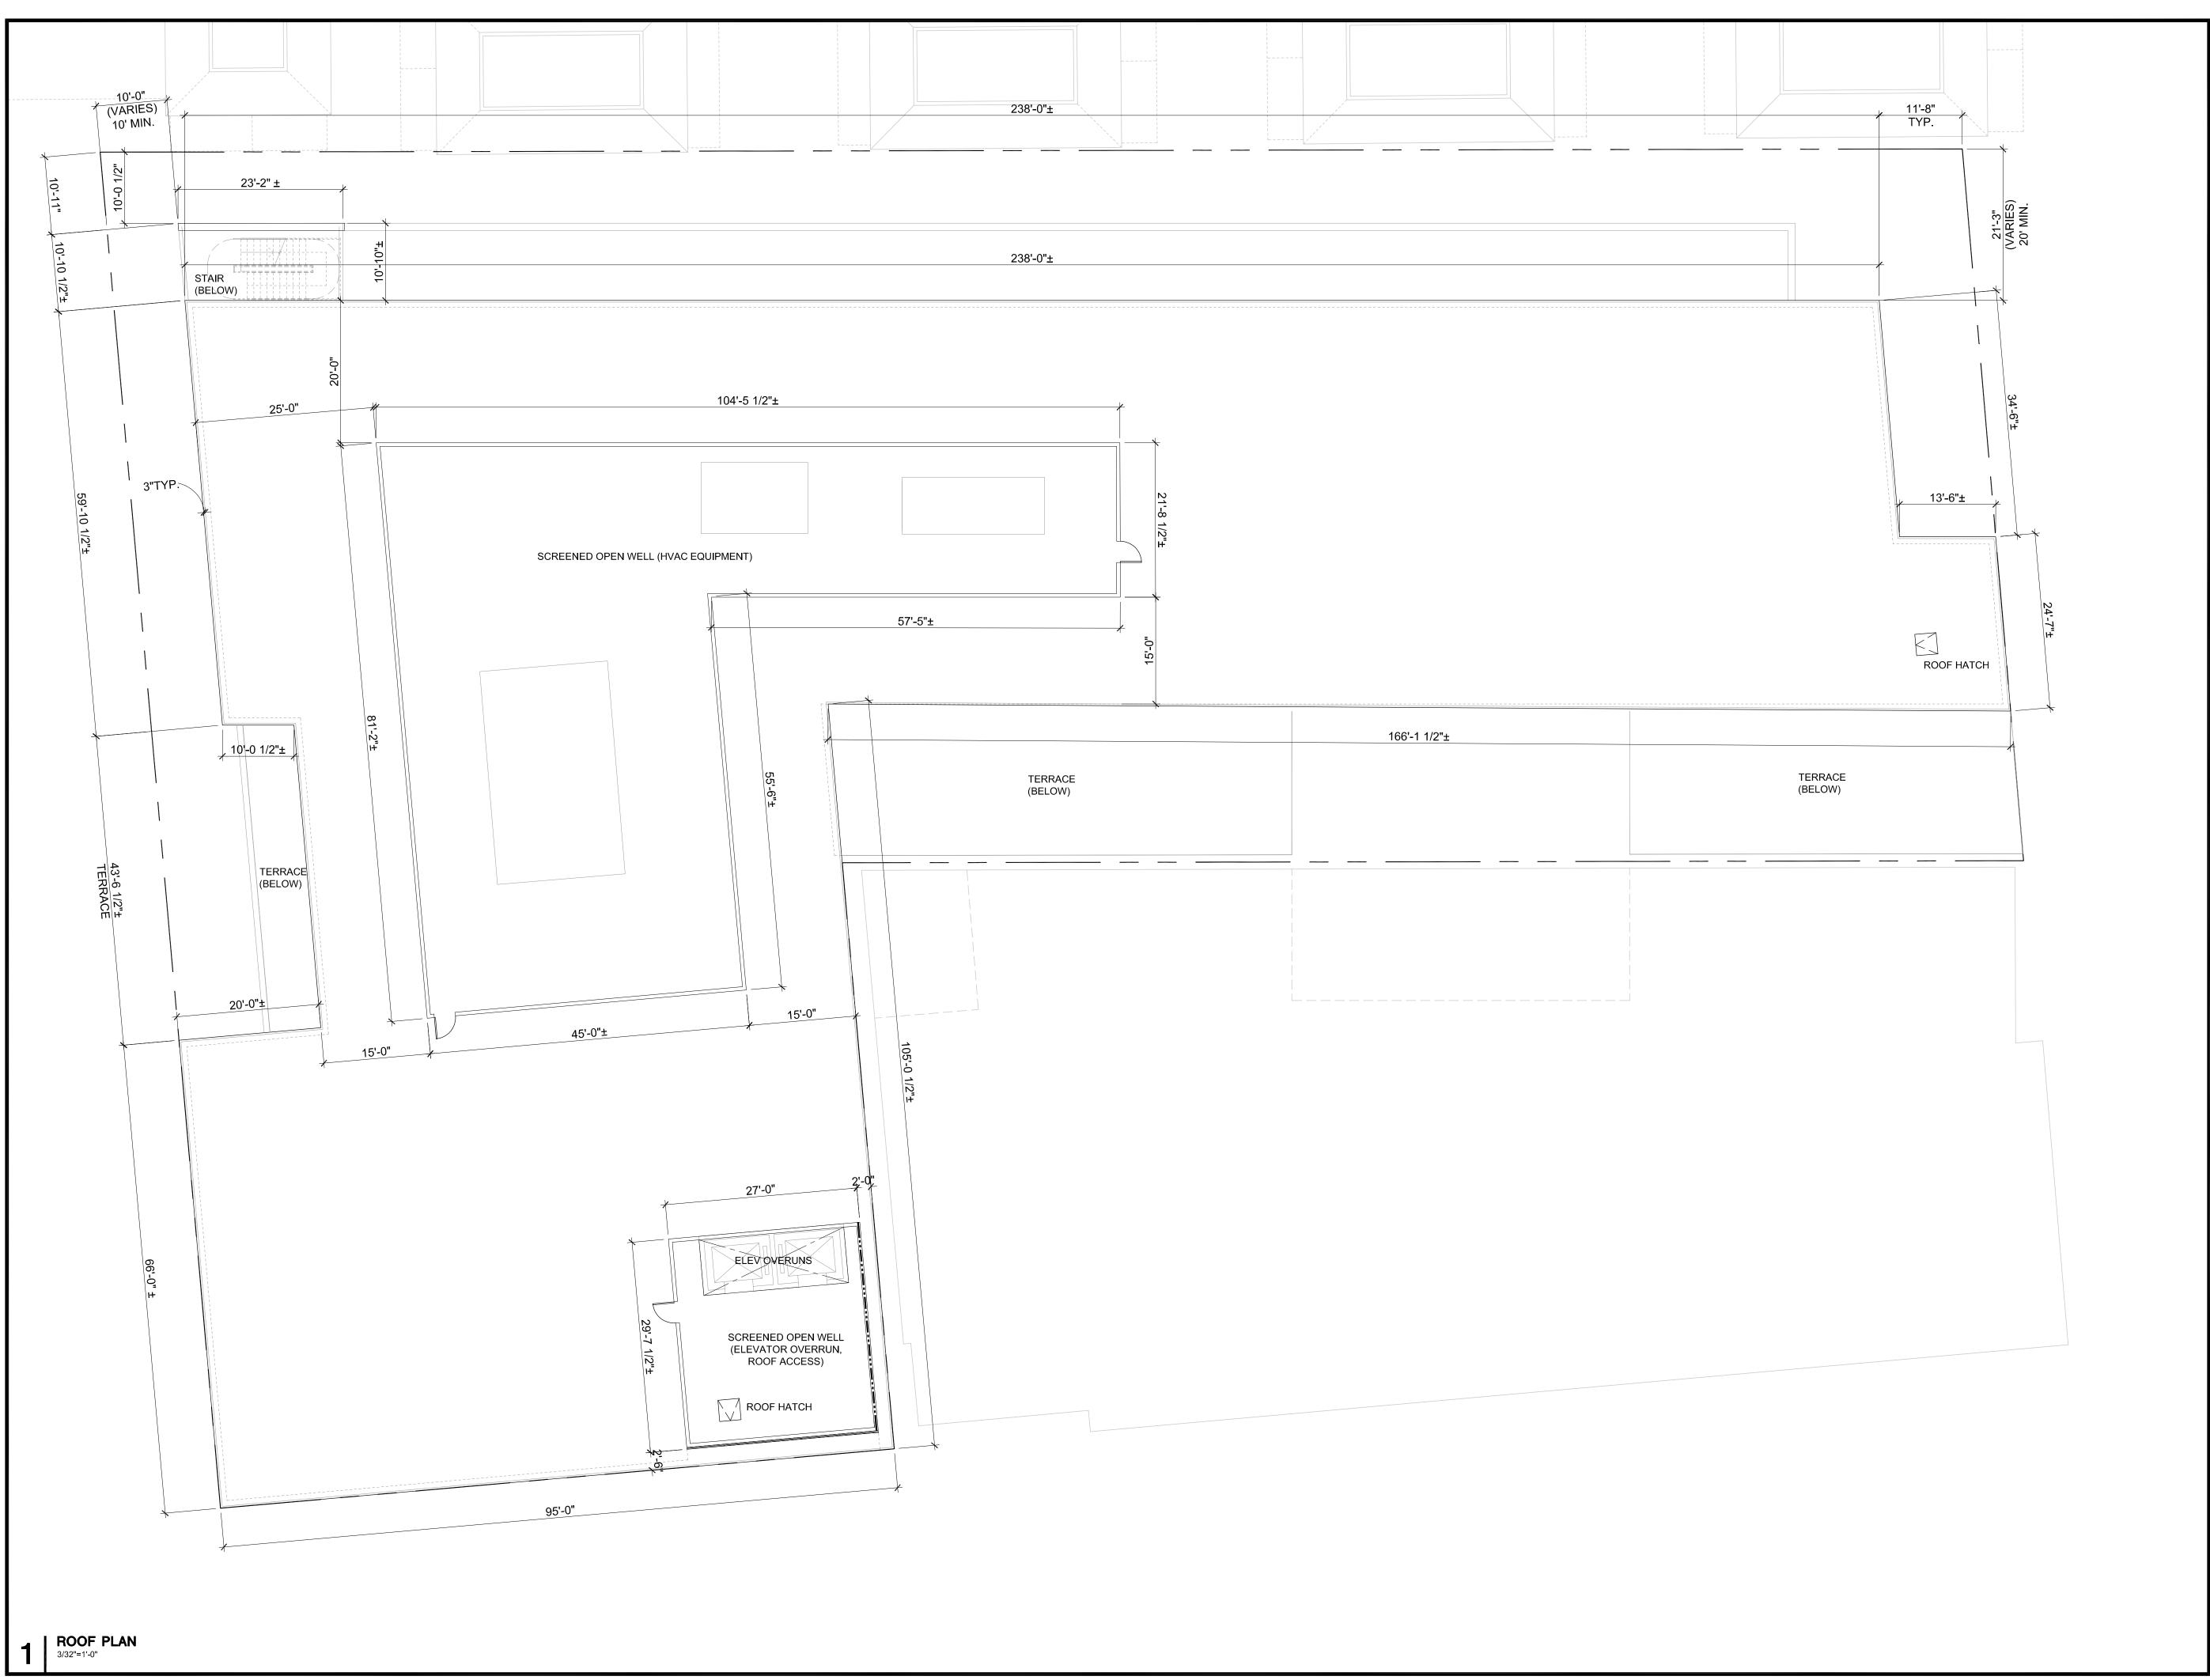

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ISSUES AND REVISIONS DESCRIPTION


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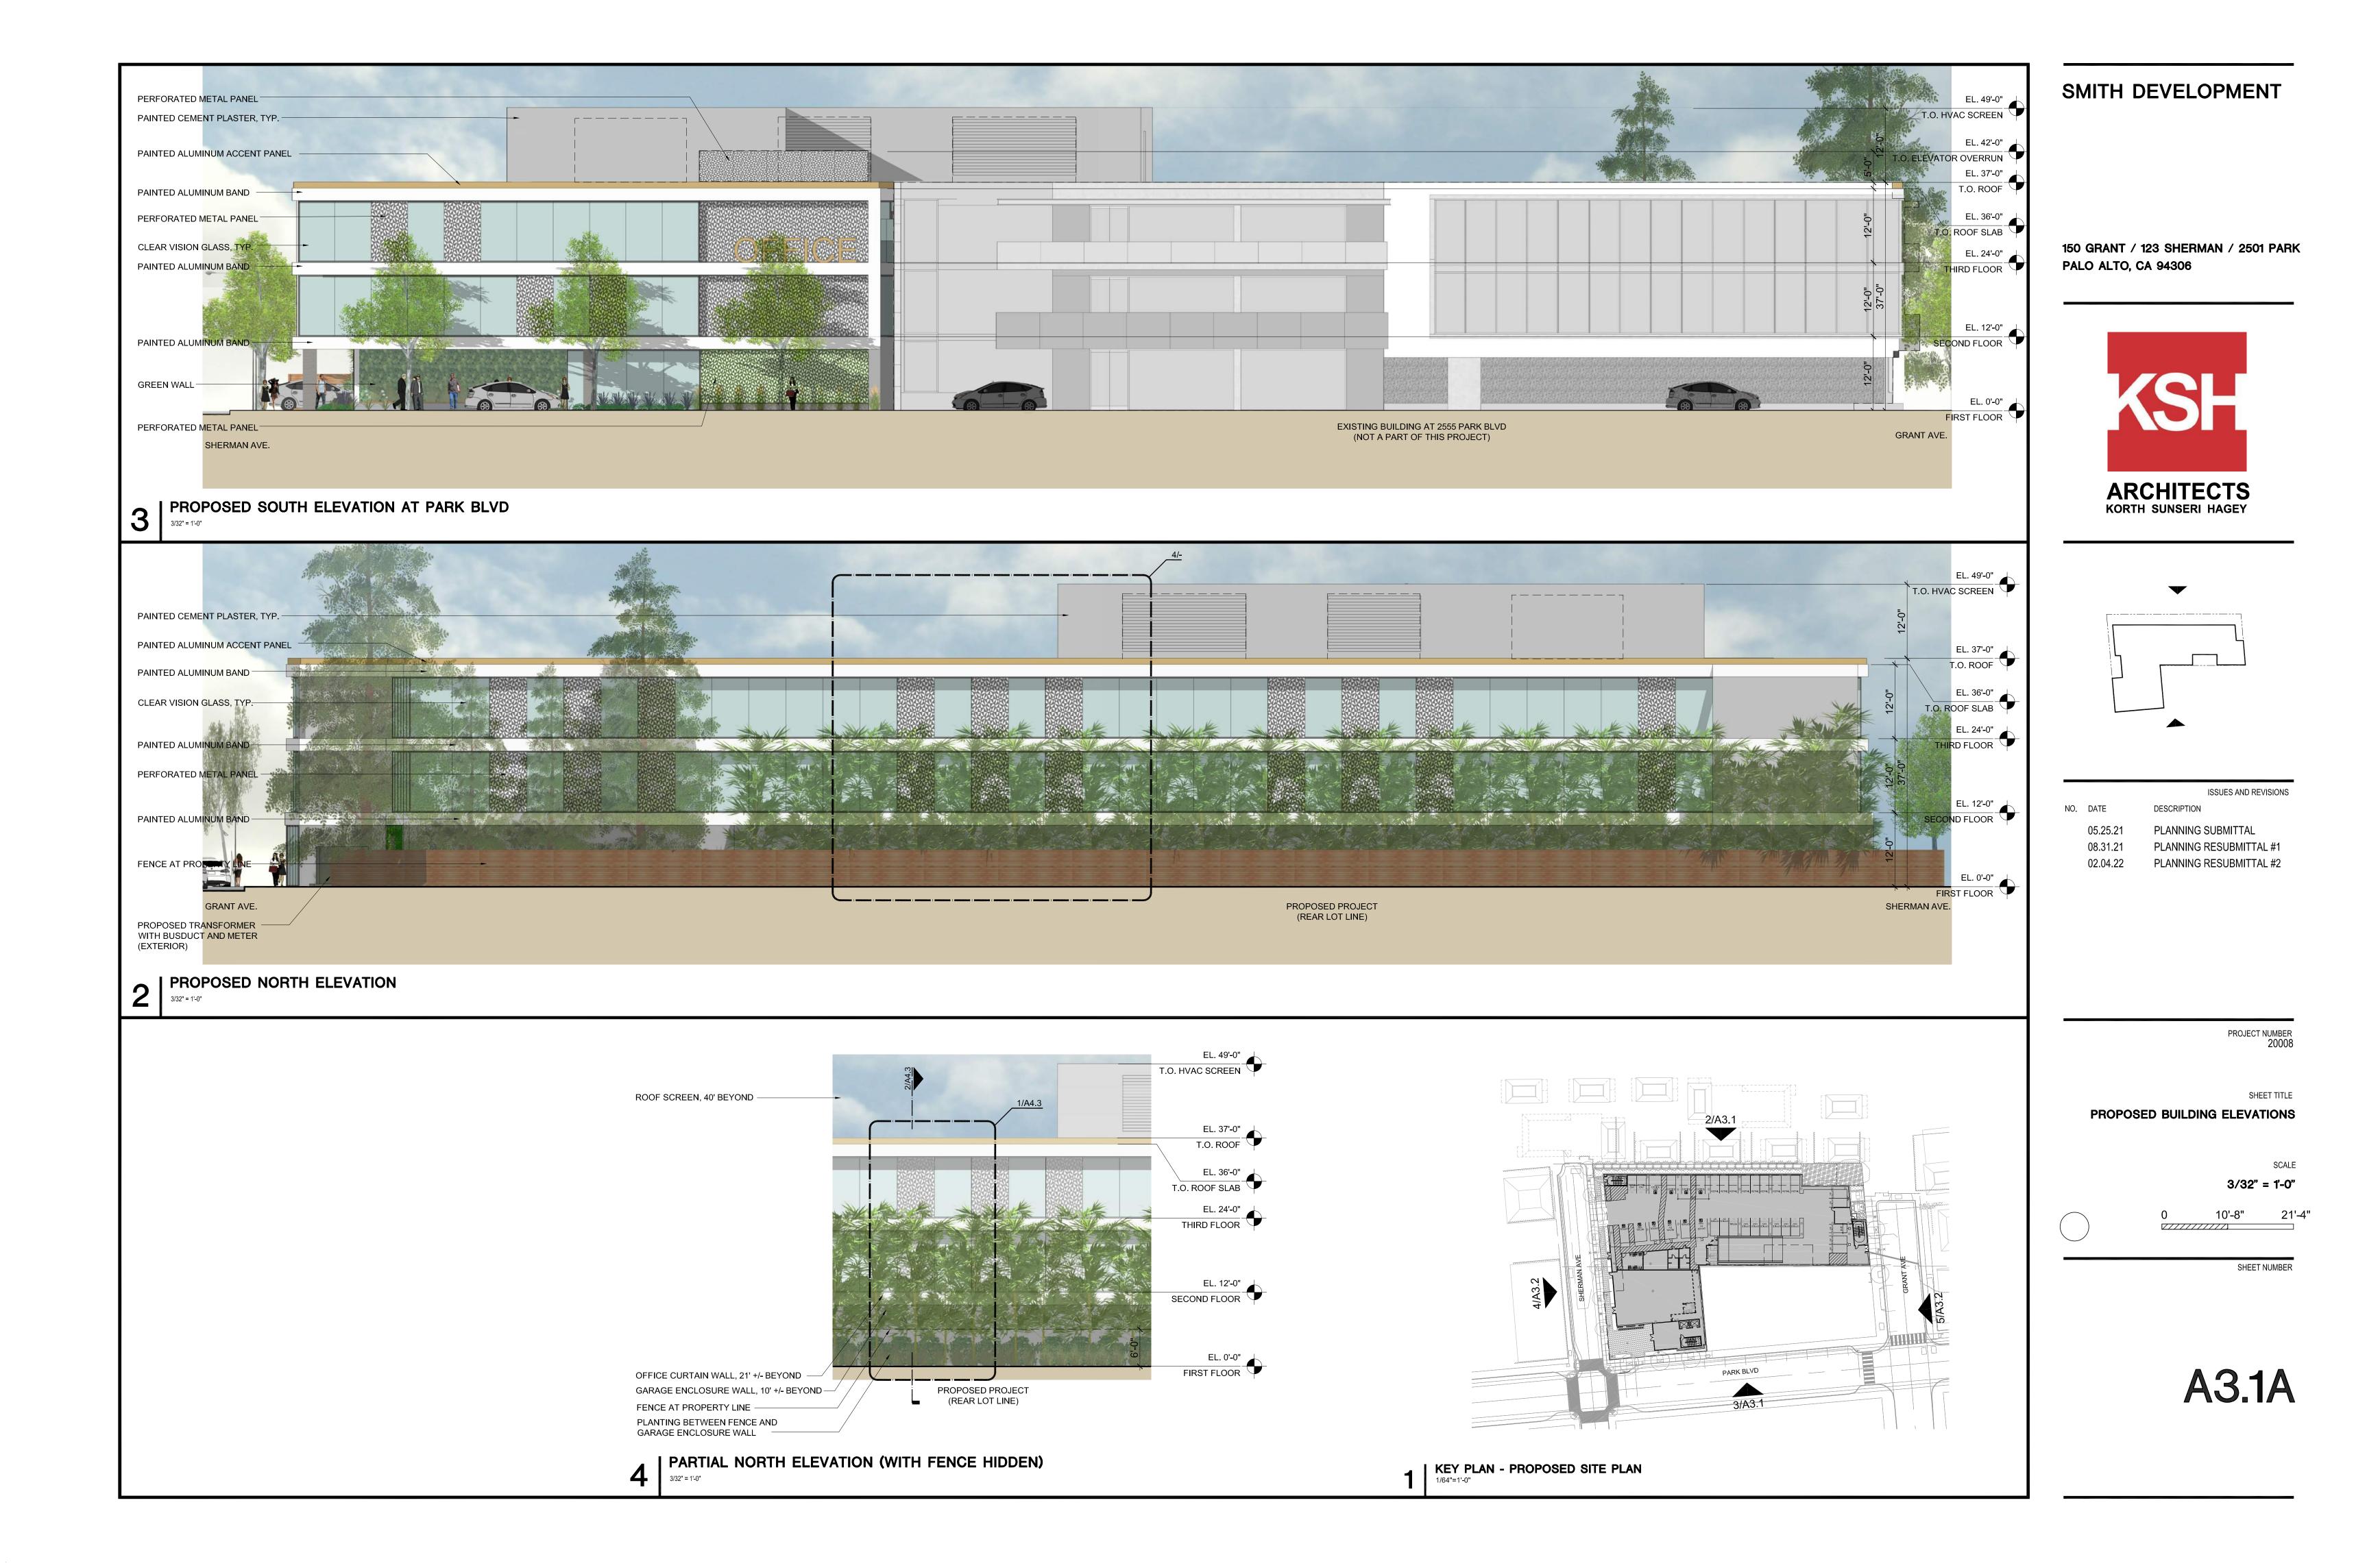
08.31.21 PLANNING RESUBMITTAL #1

02.04.22 PLANNING RESUBMITTAL #2

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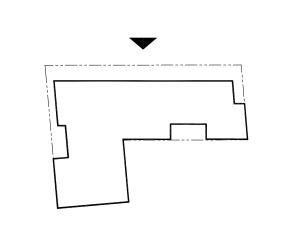
PROPOSED PLAN ROOF



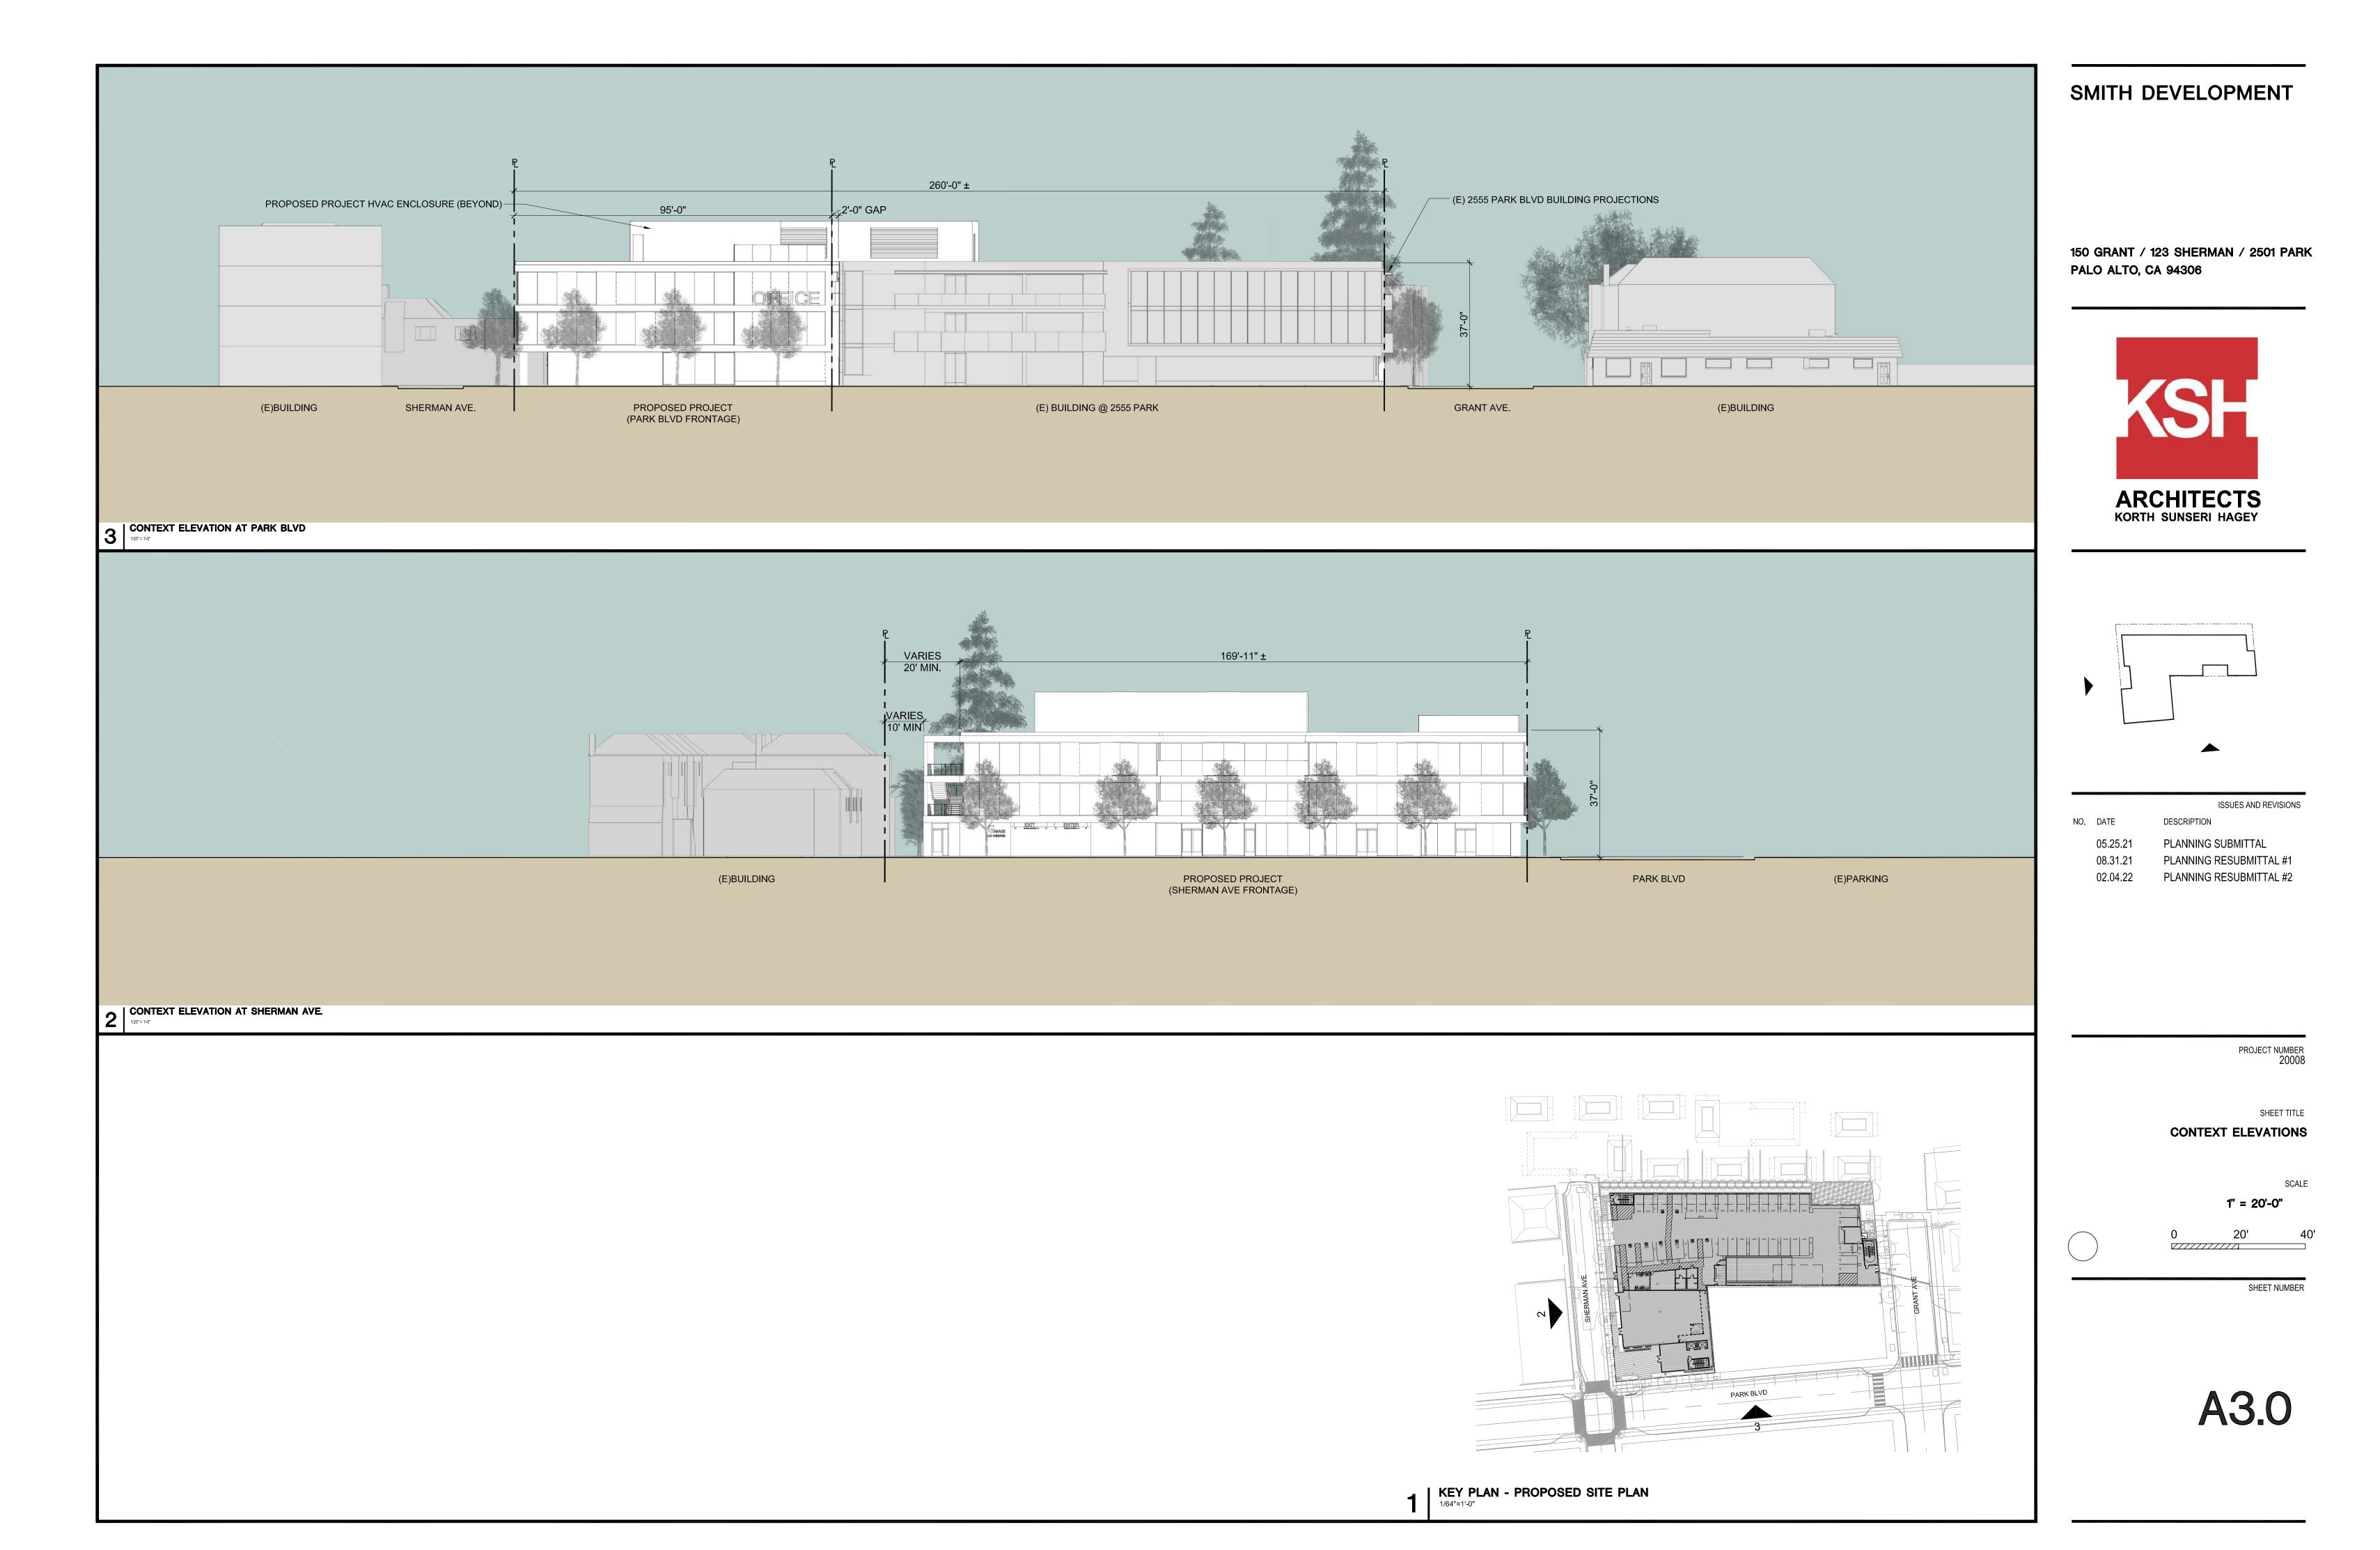

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ISSUES AND REVISIONS

DESCRIPTION


08.31.21 PLANNING RESUBMITTAL #1

PLANNING RESUBMITTAL #2

PROJECT NUM 20

PROPOSED BUILDING ELEVATIONS
AND PERSPECTIVE

SCALE 3/32" = 1'-0"

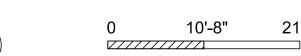

SHEET NUMBER


A3.1B





2 RESIDENTIAL CONTEXT PERSPECTIVE



PROPOSED NORTH ELEVATION - RESIDENTIAL CONTEXT

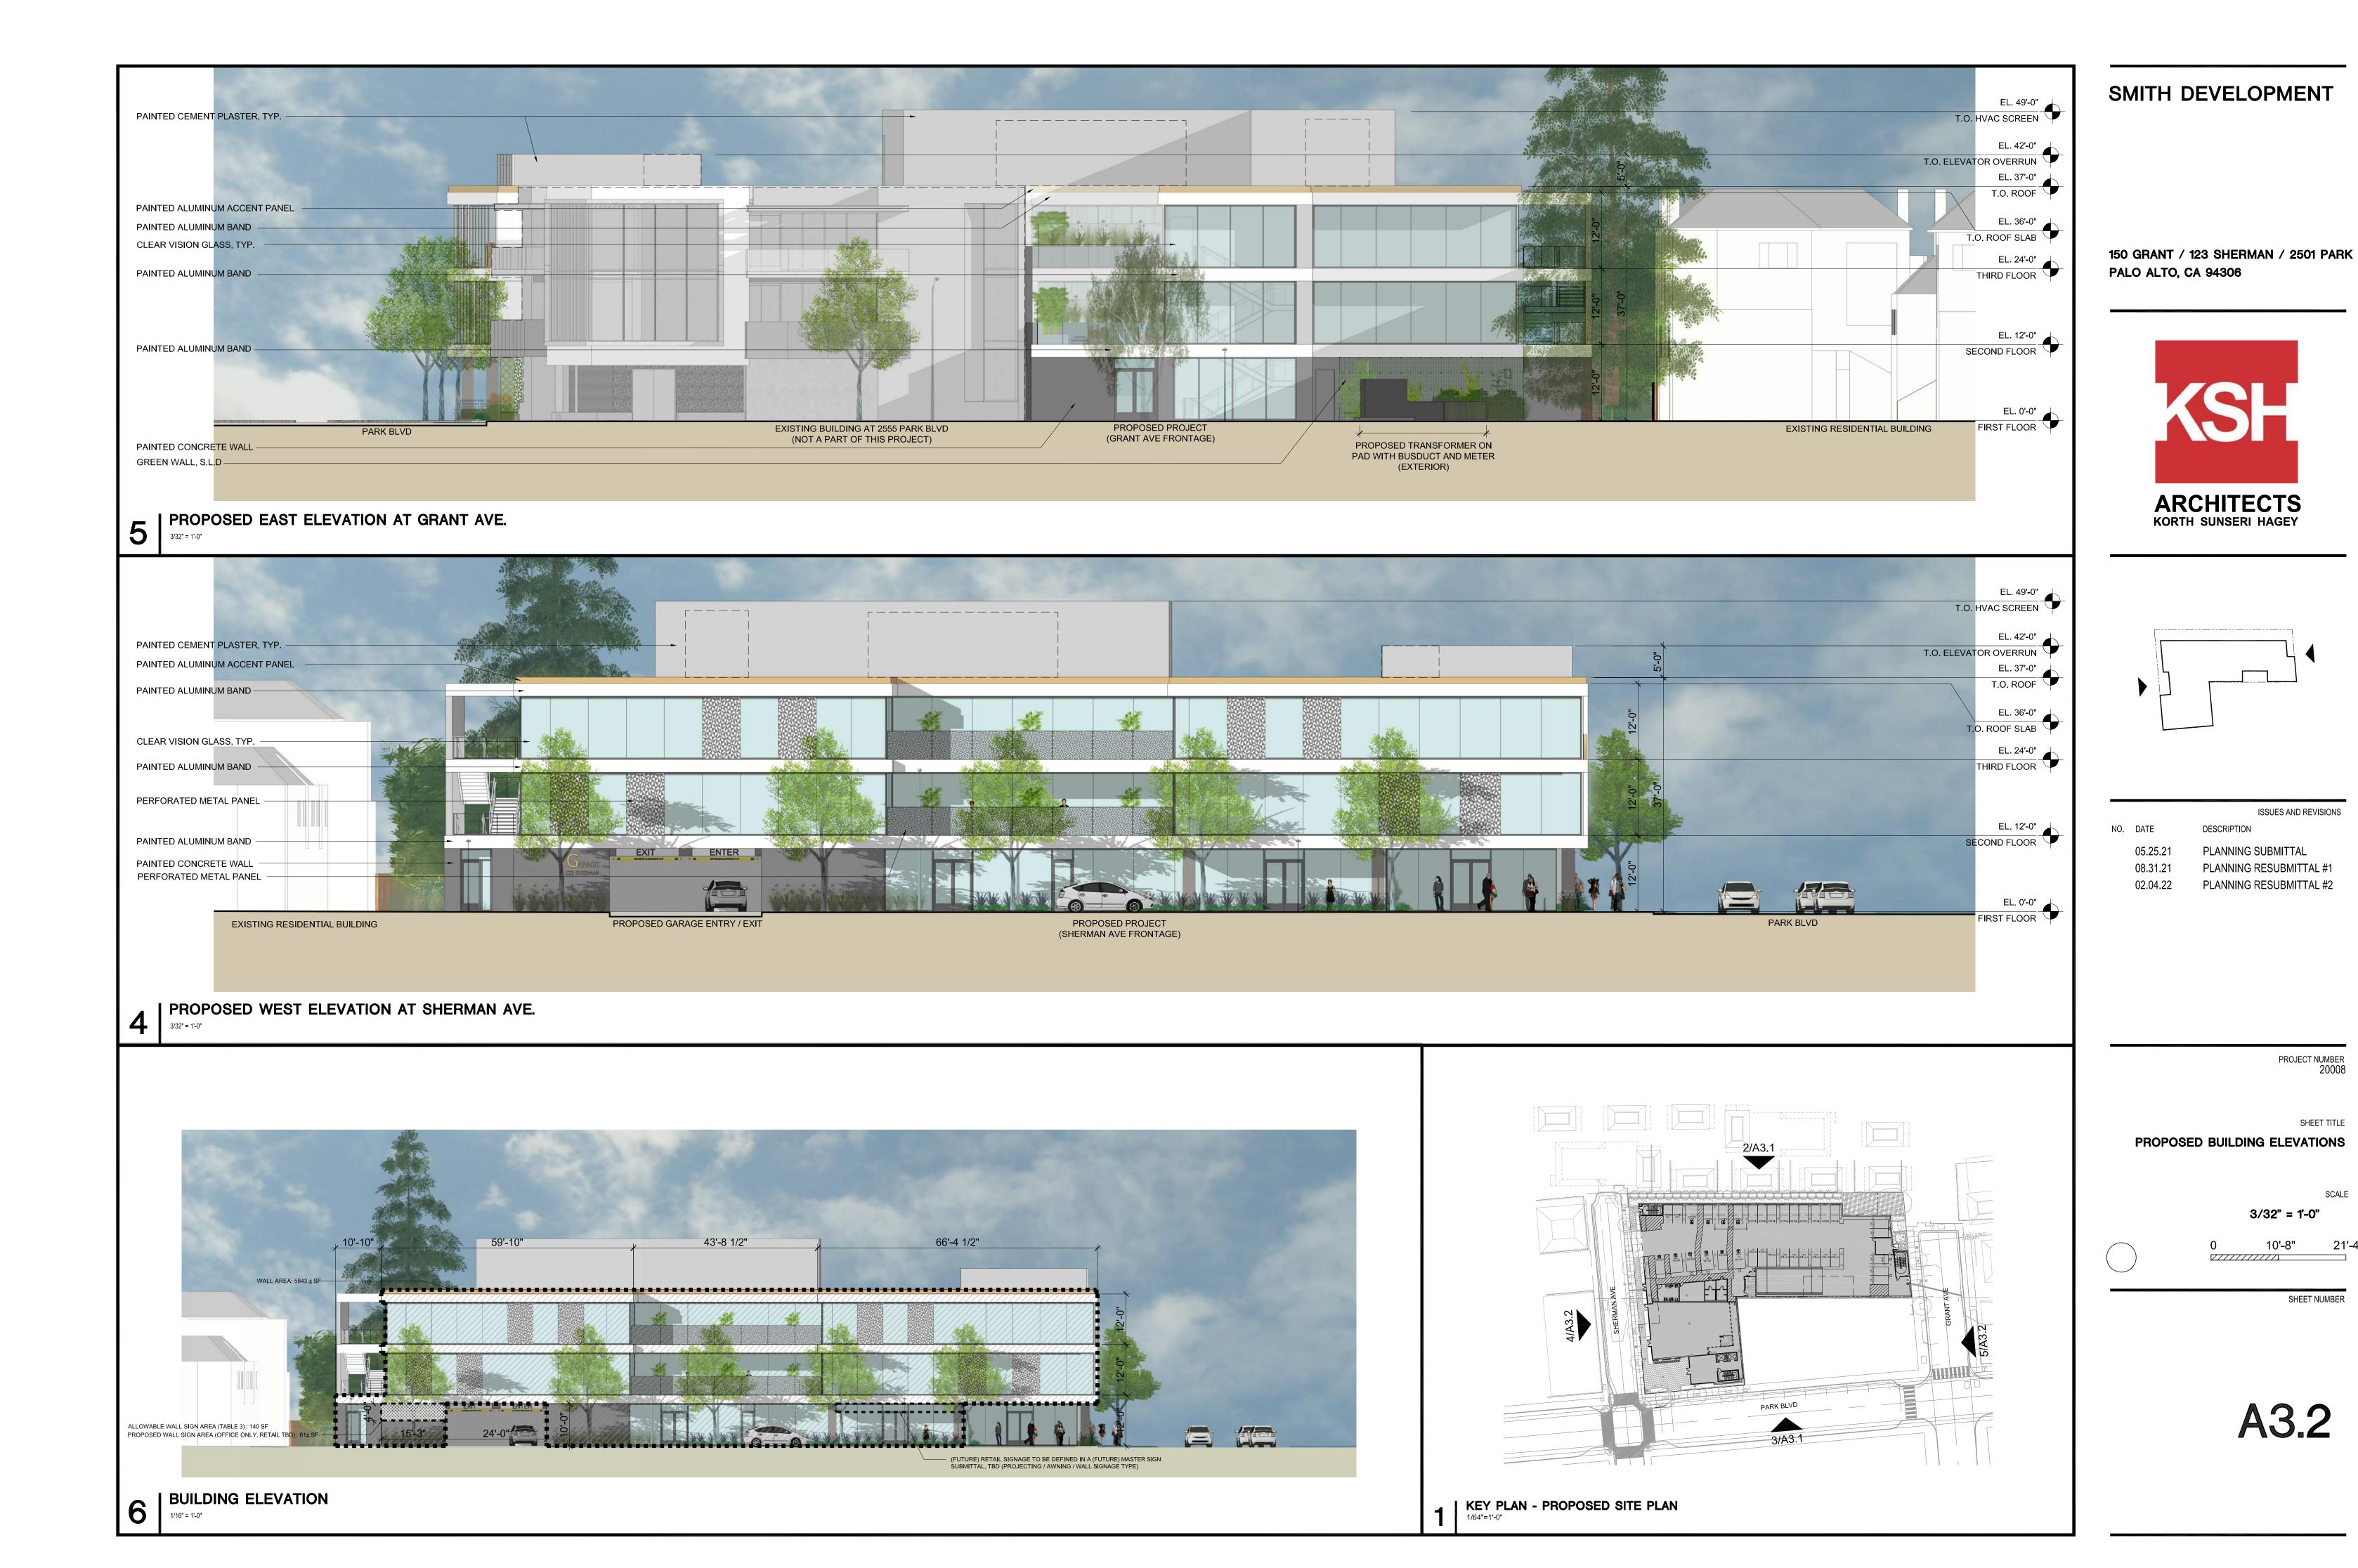


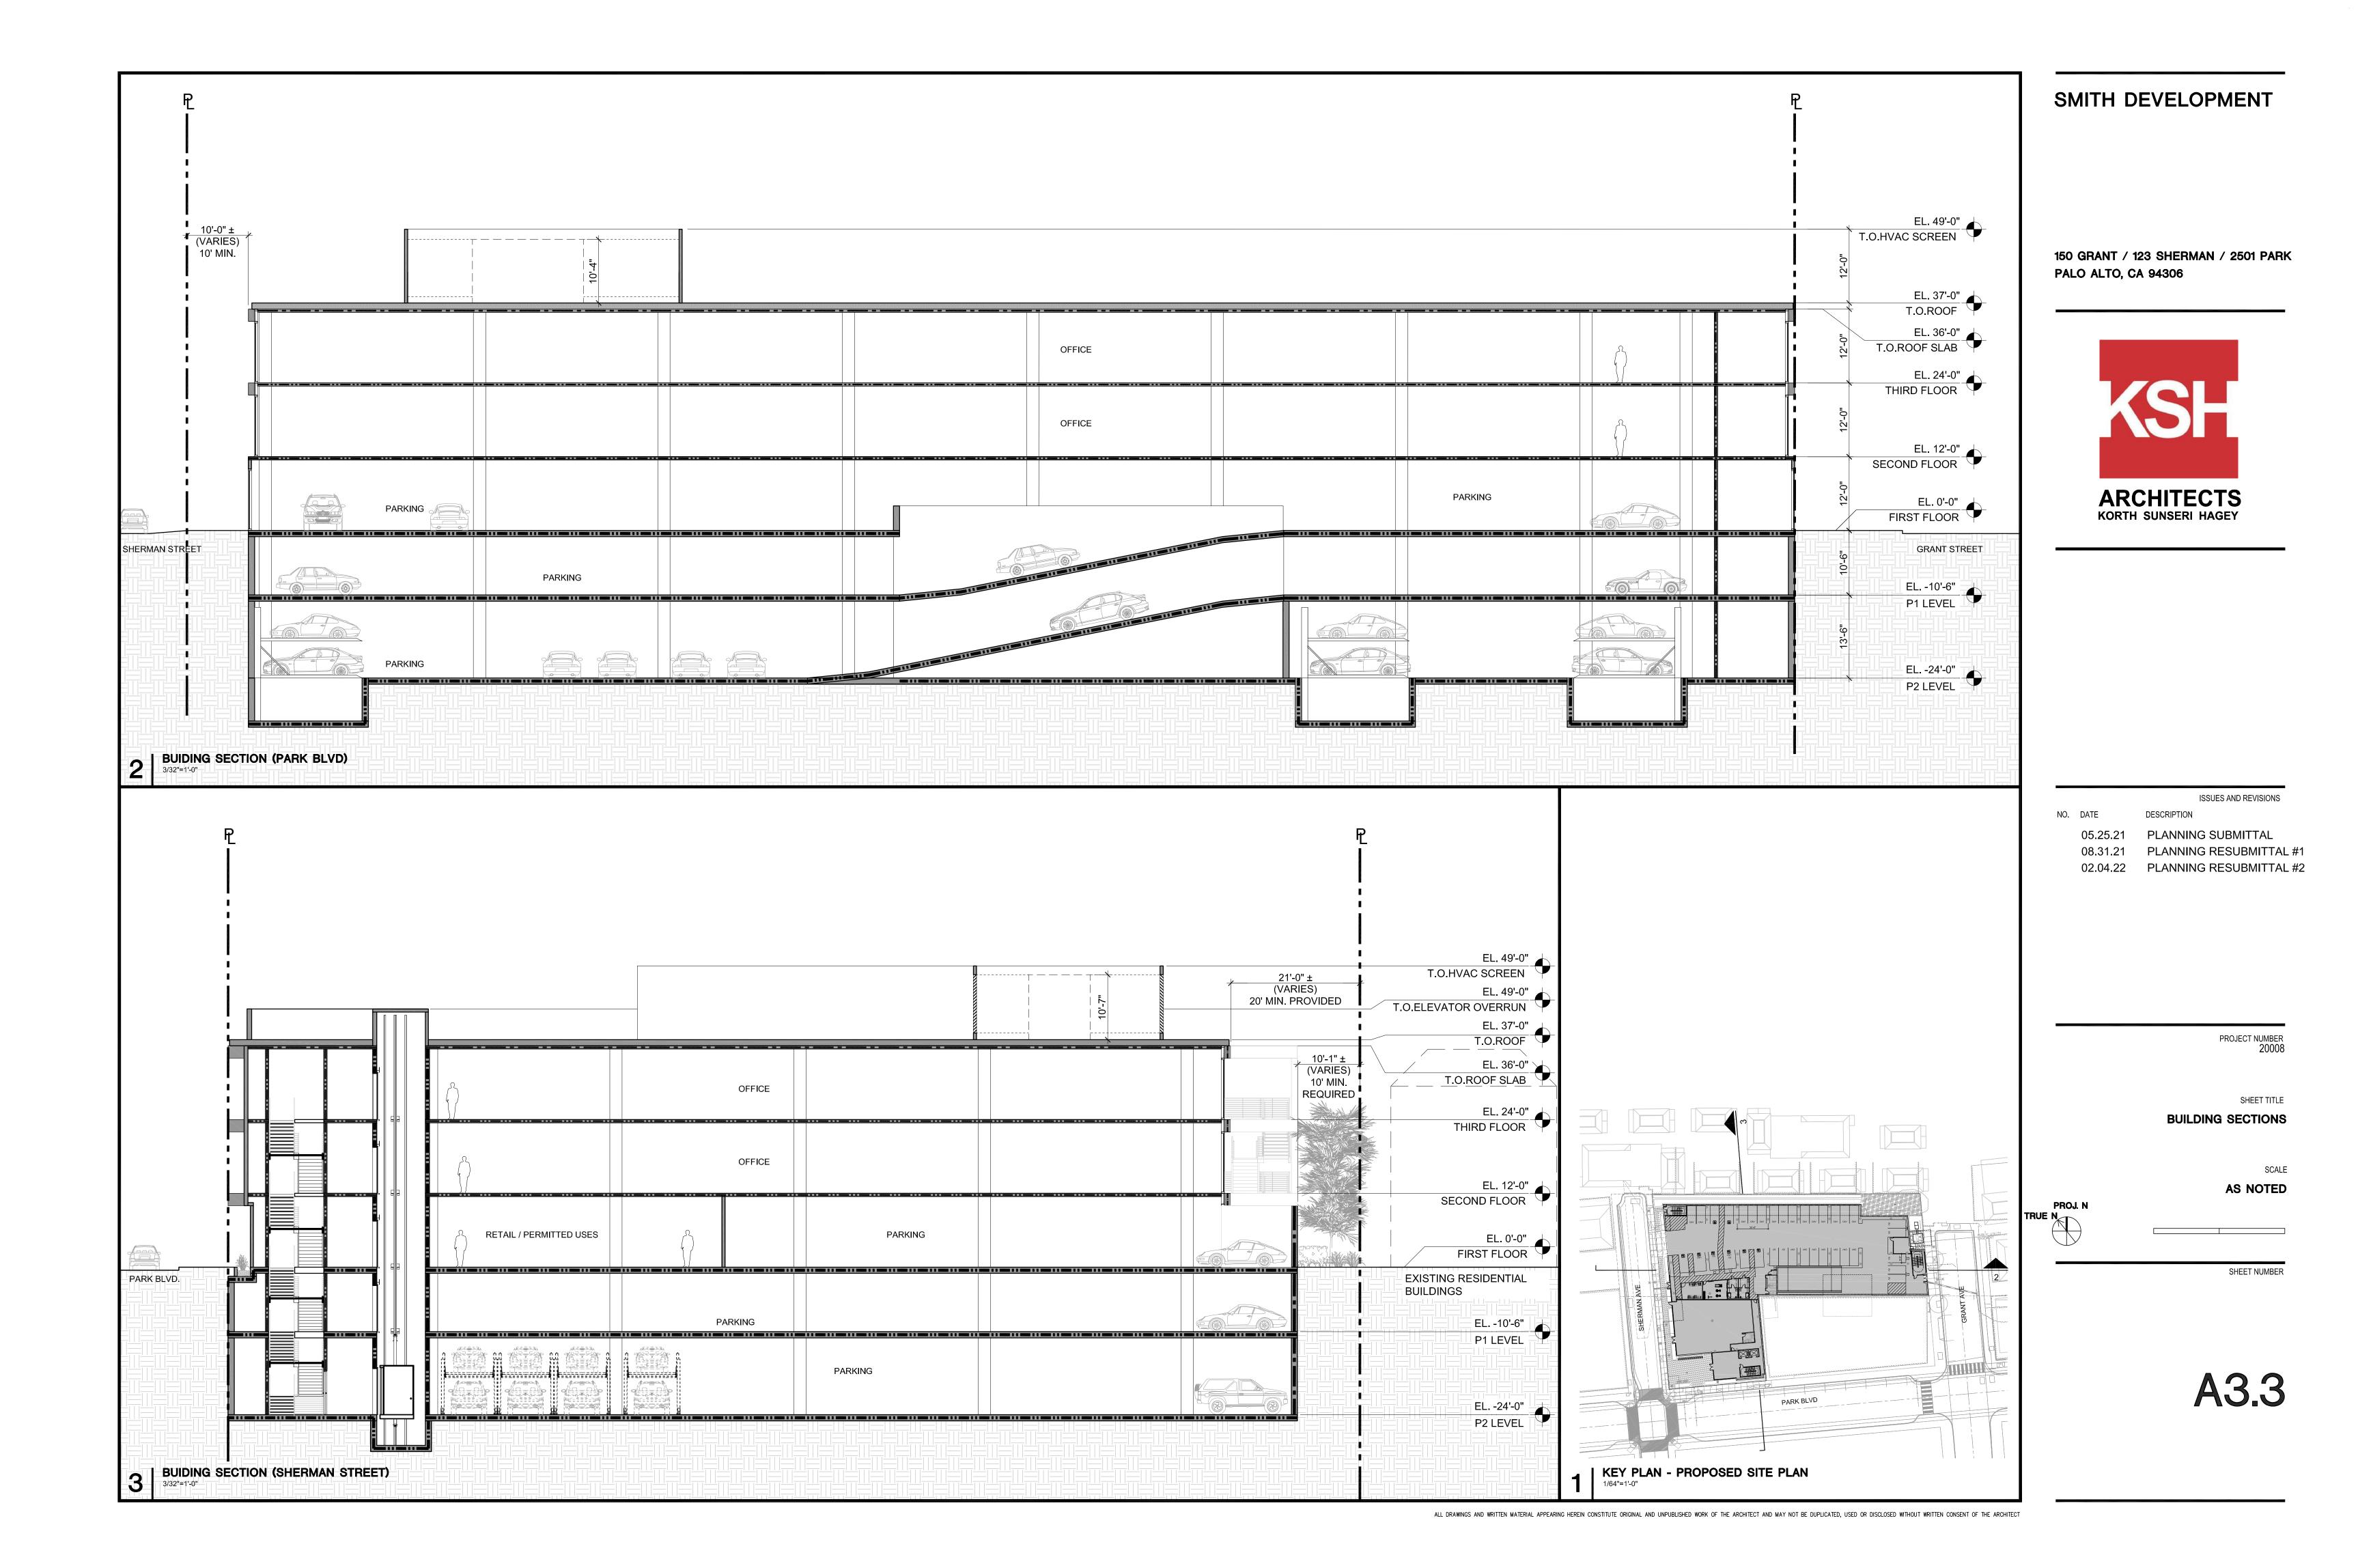

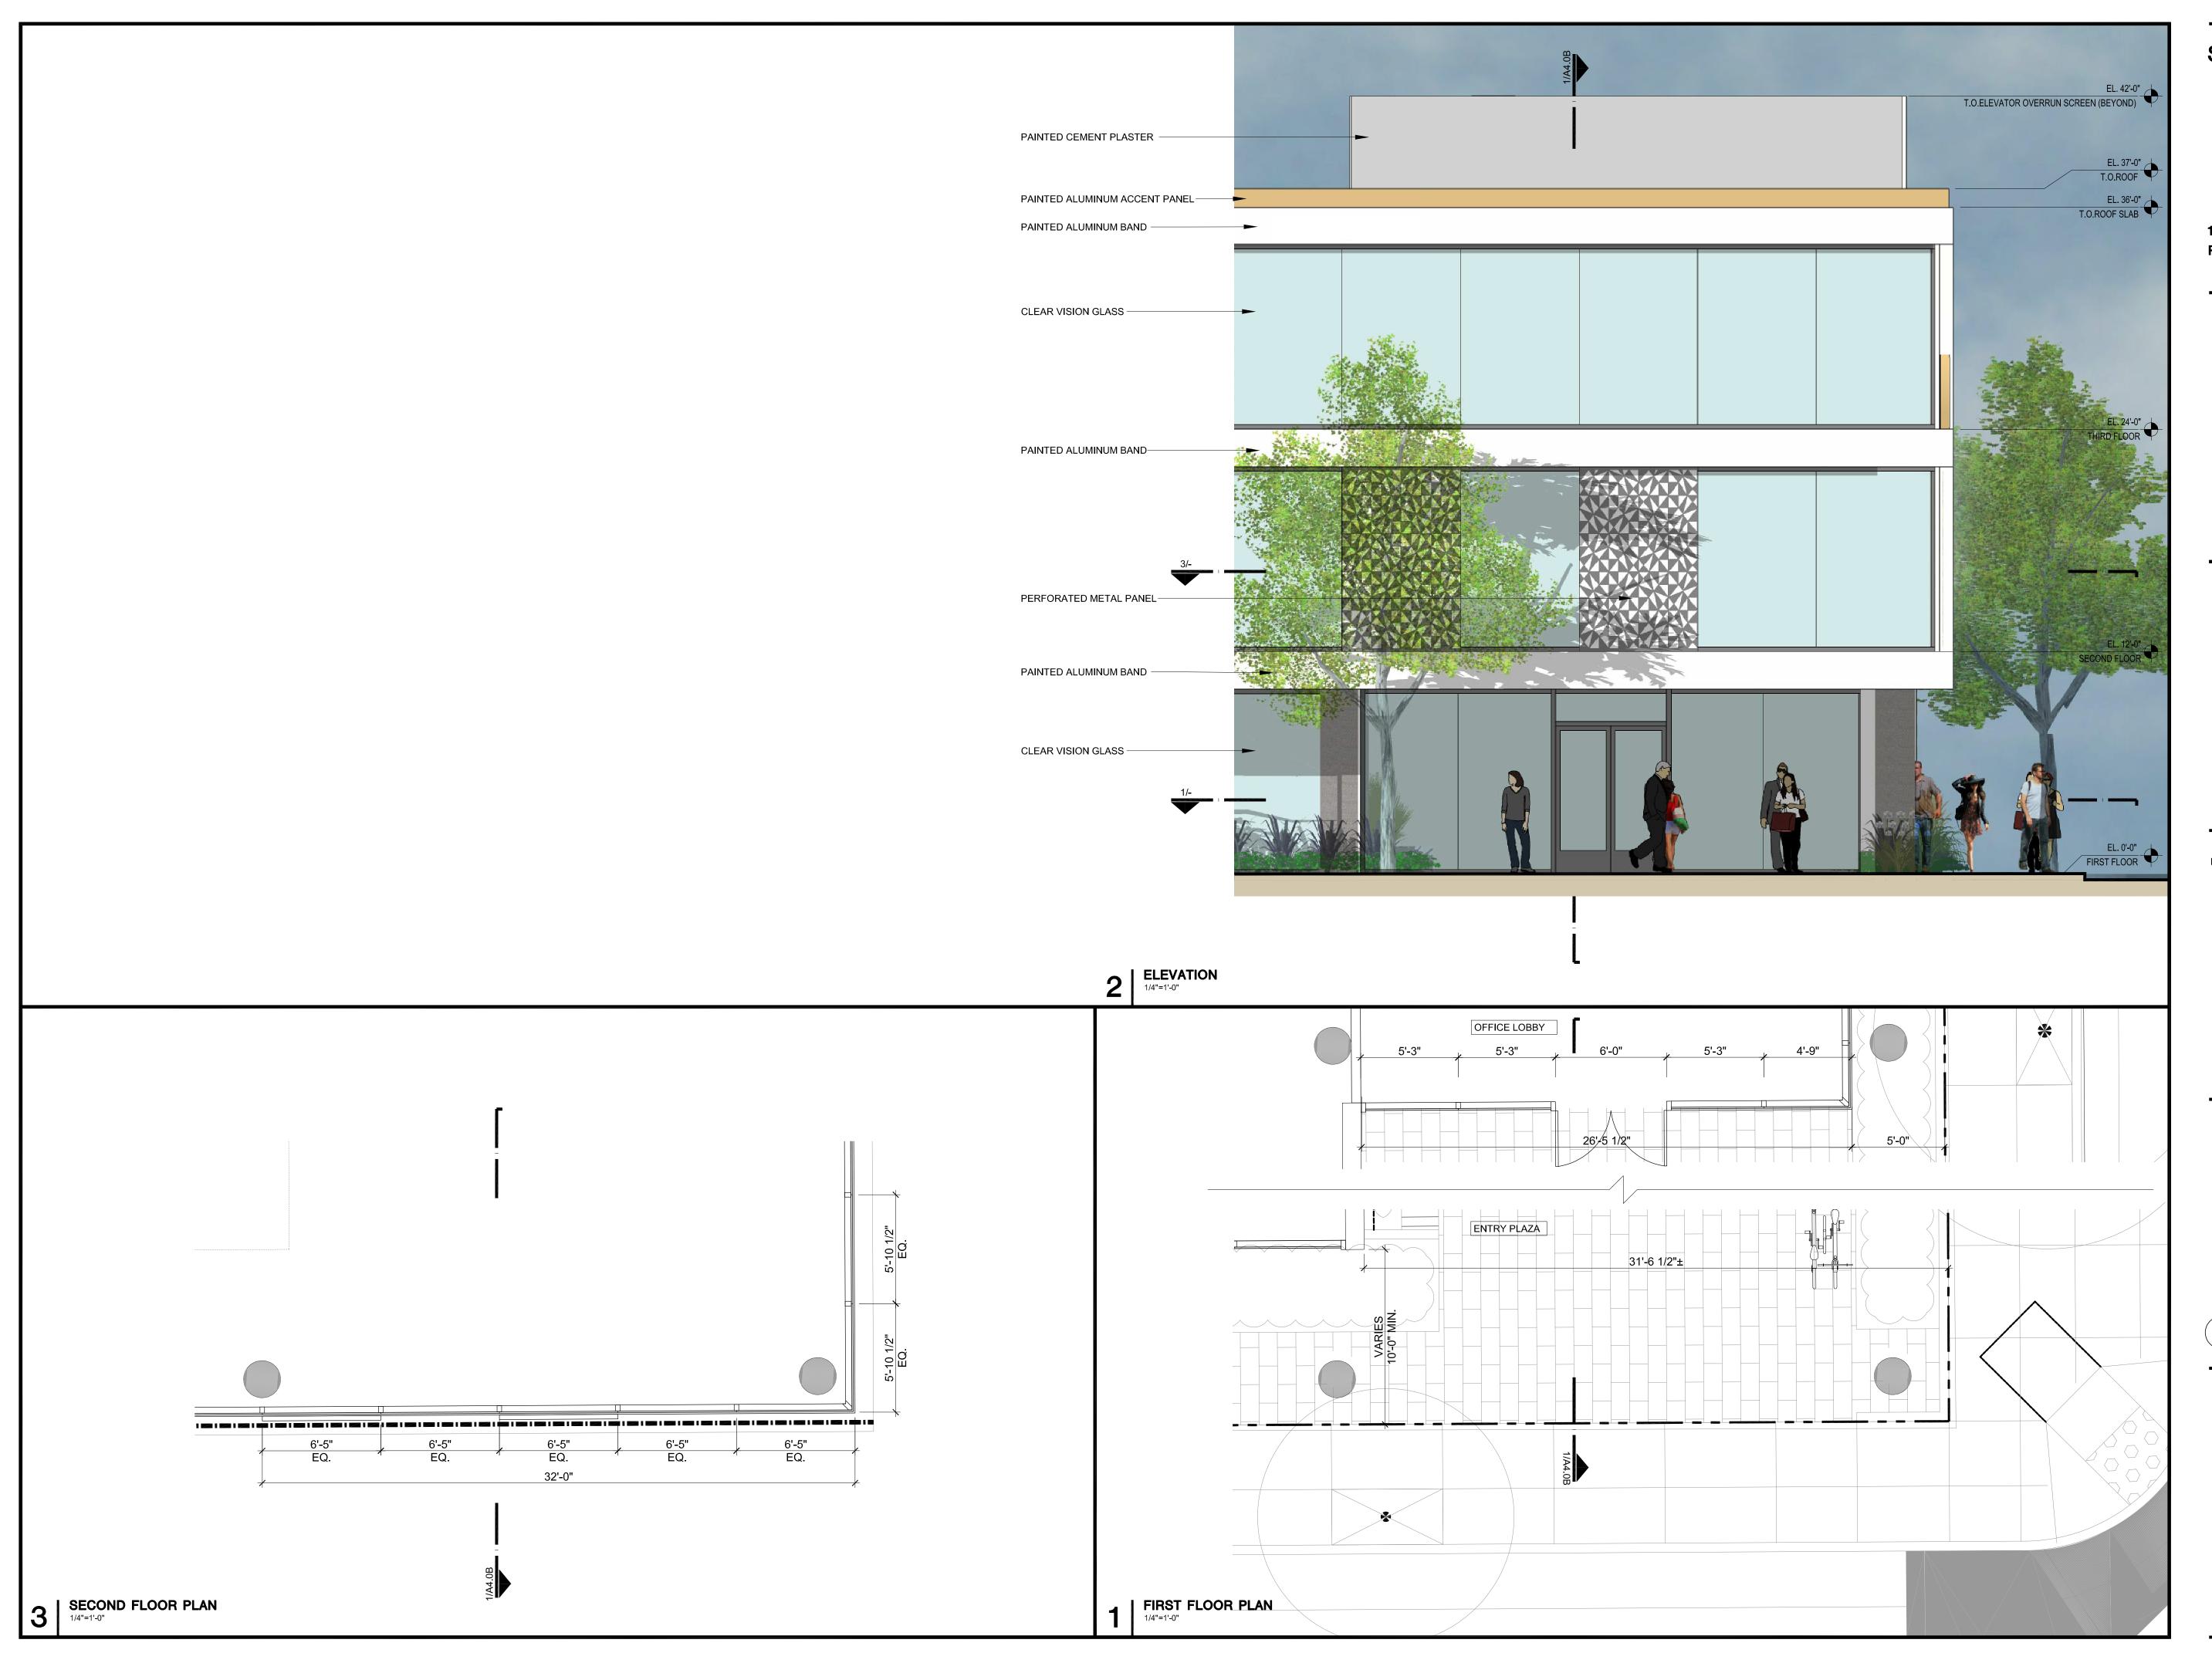

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ISSUES AND REVISIONS

05.25.21 PLANNING SUBMITTAL

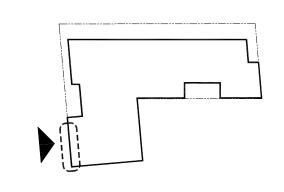08.31.21 PLANNING RESUBMITTAL #1 02.04.22 PLANNING RESUBMITTAL #2

PROJECT NUMBER 20008


SHEET TITLE
ENLARGED ELEVATION


SCA


1/4" = 1'-0" 4' 8'

SHEET NUMBER

A4.0A

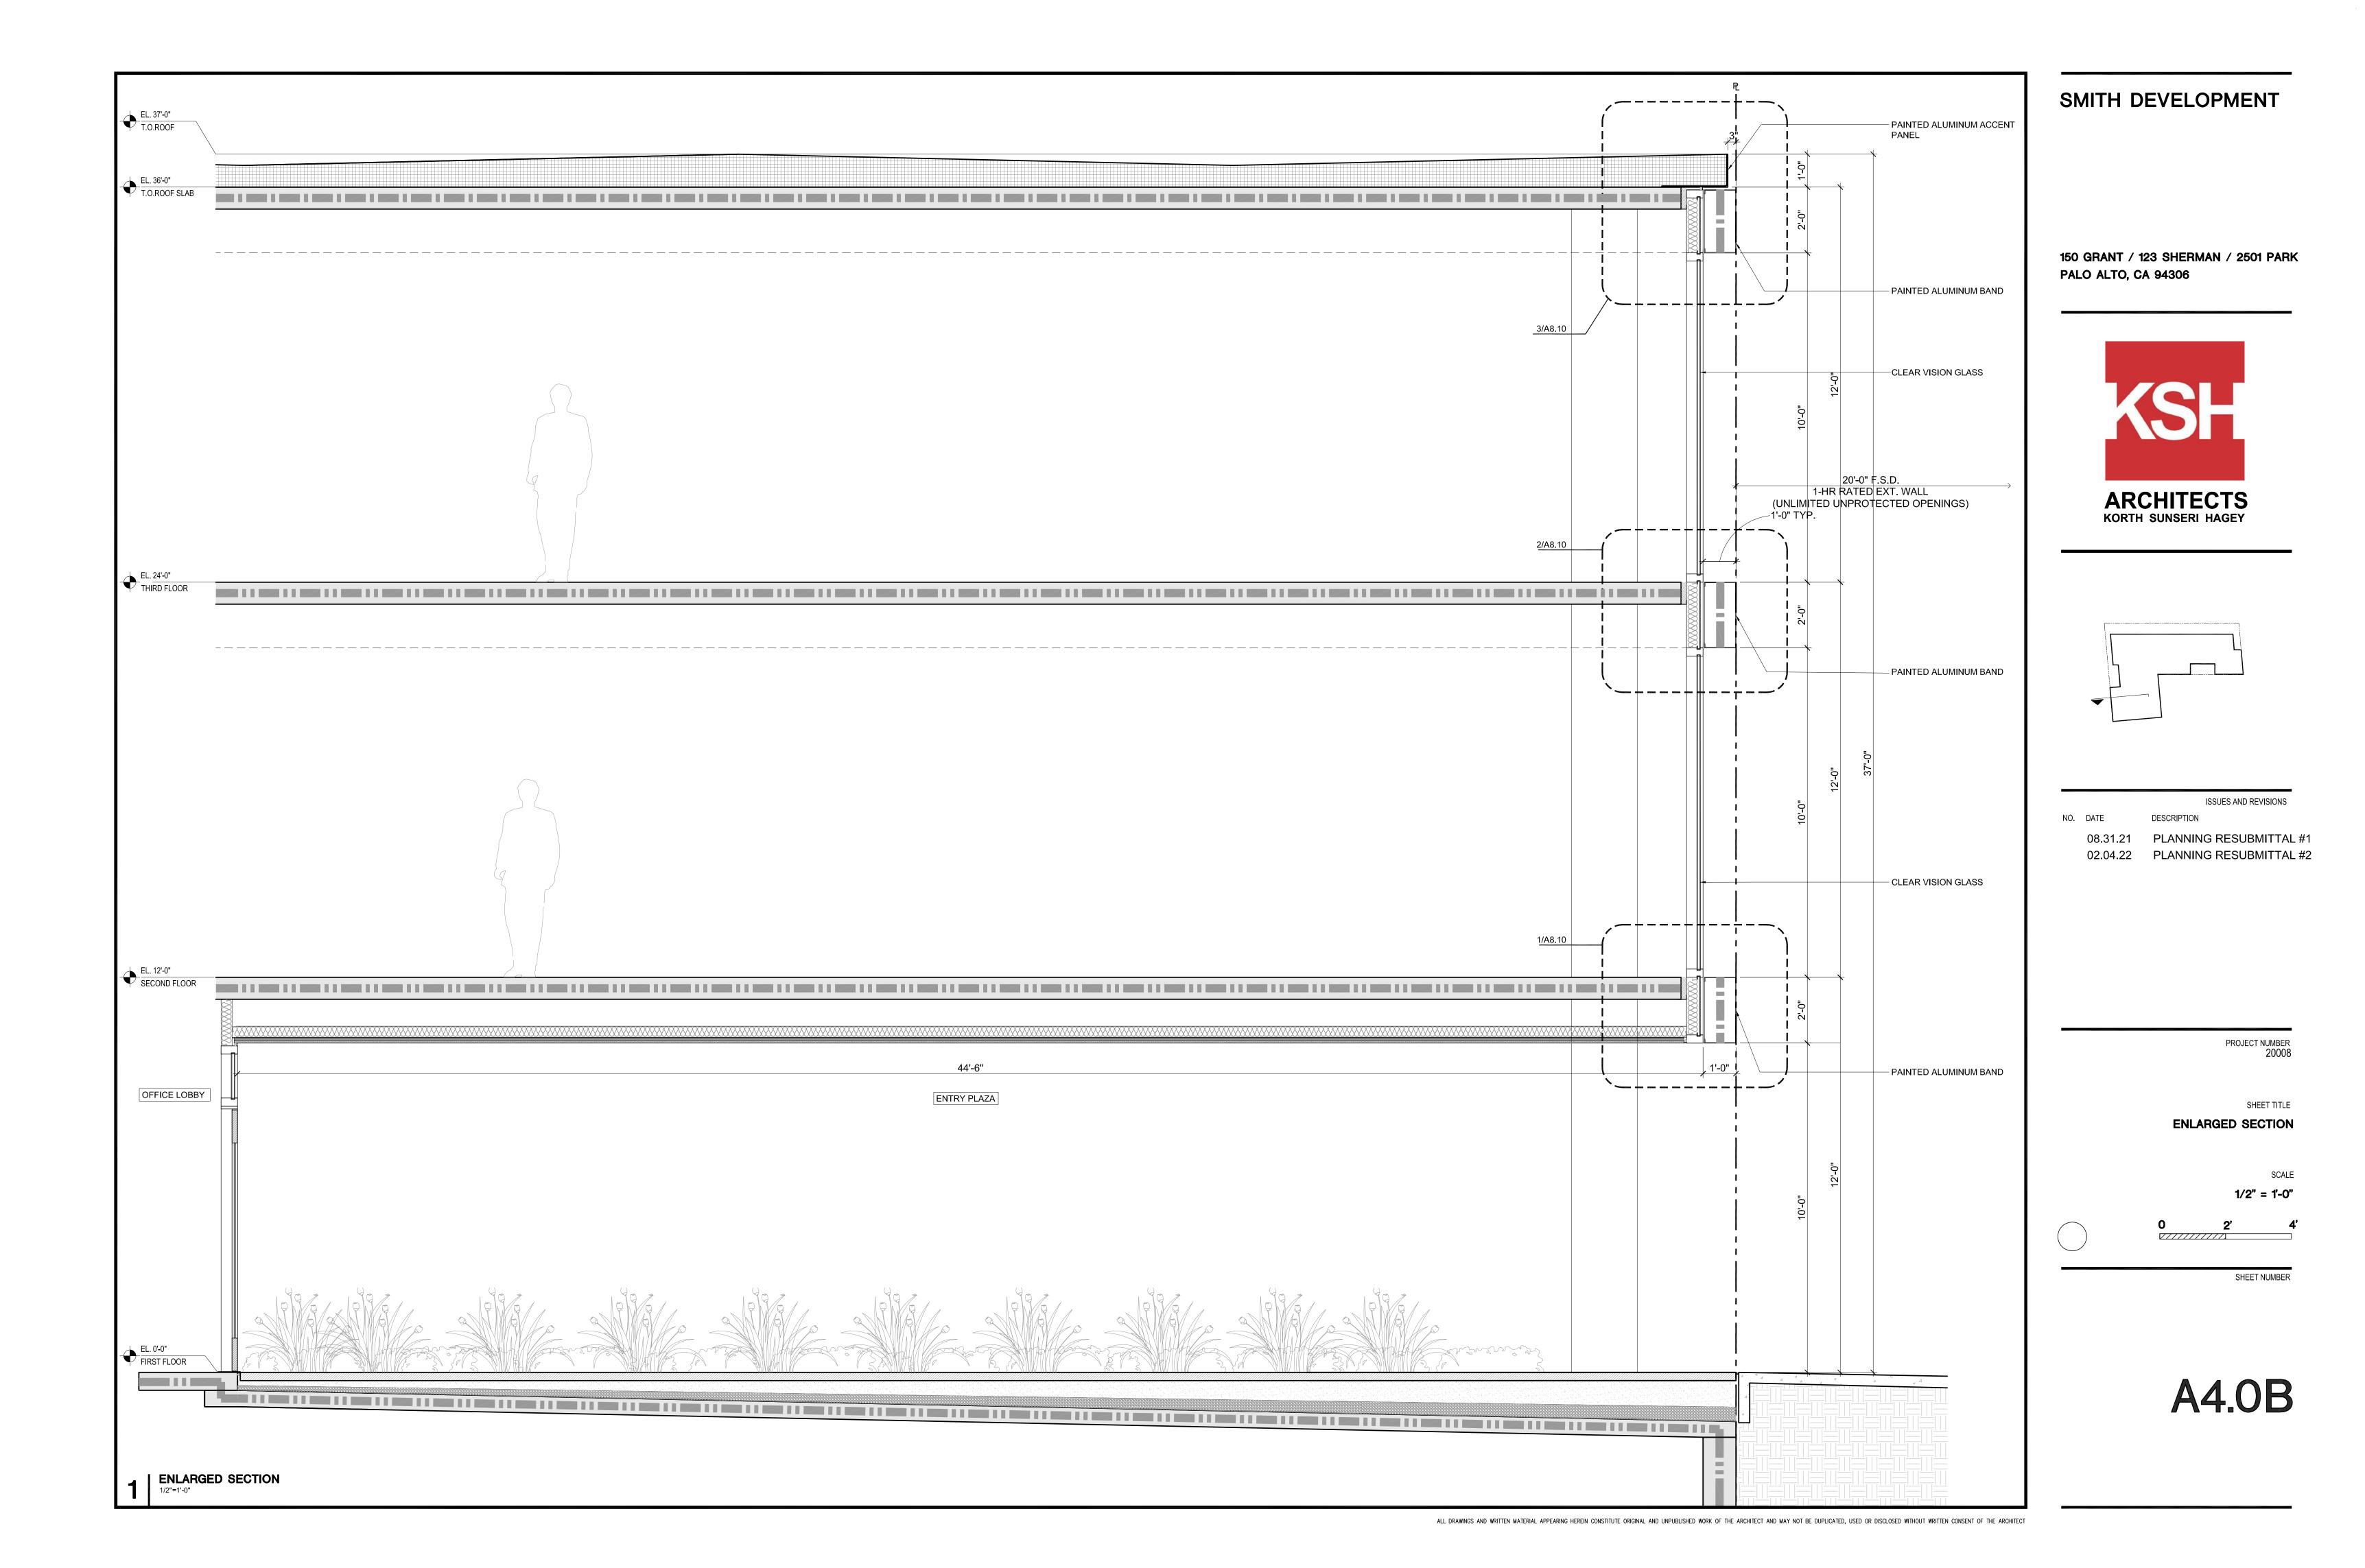


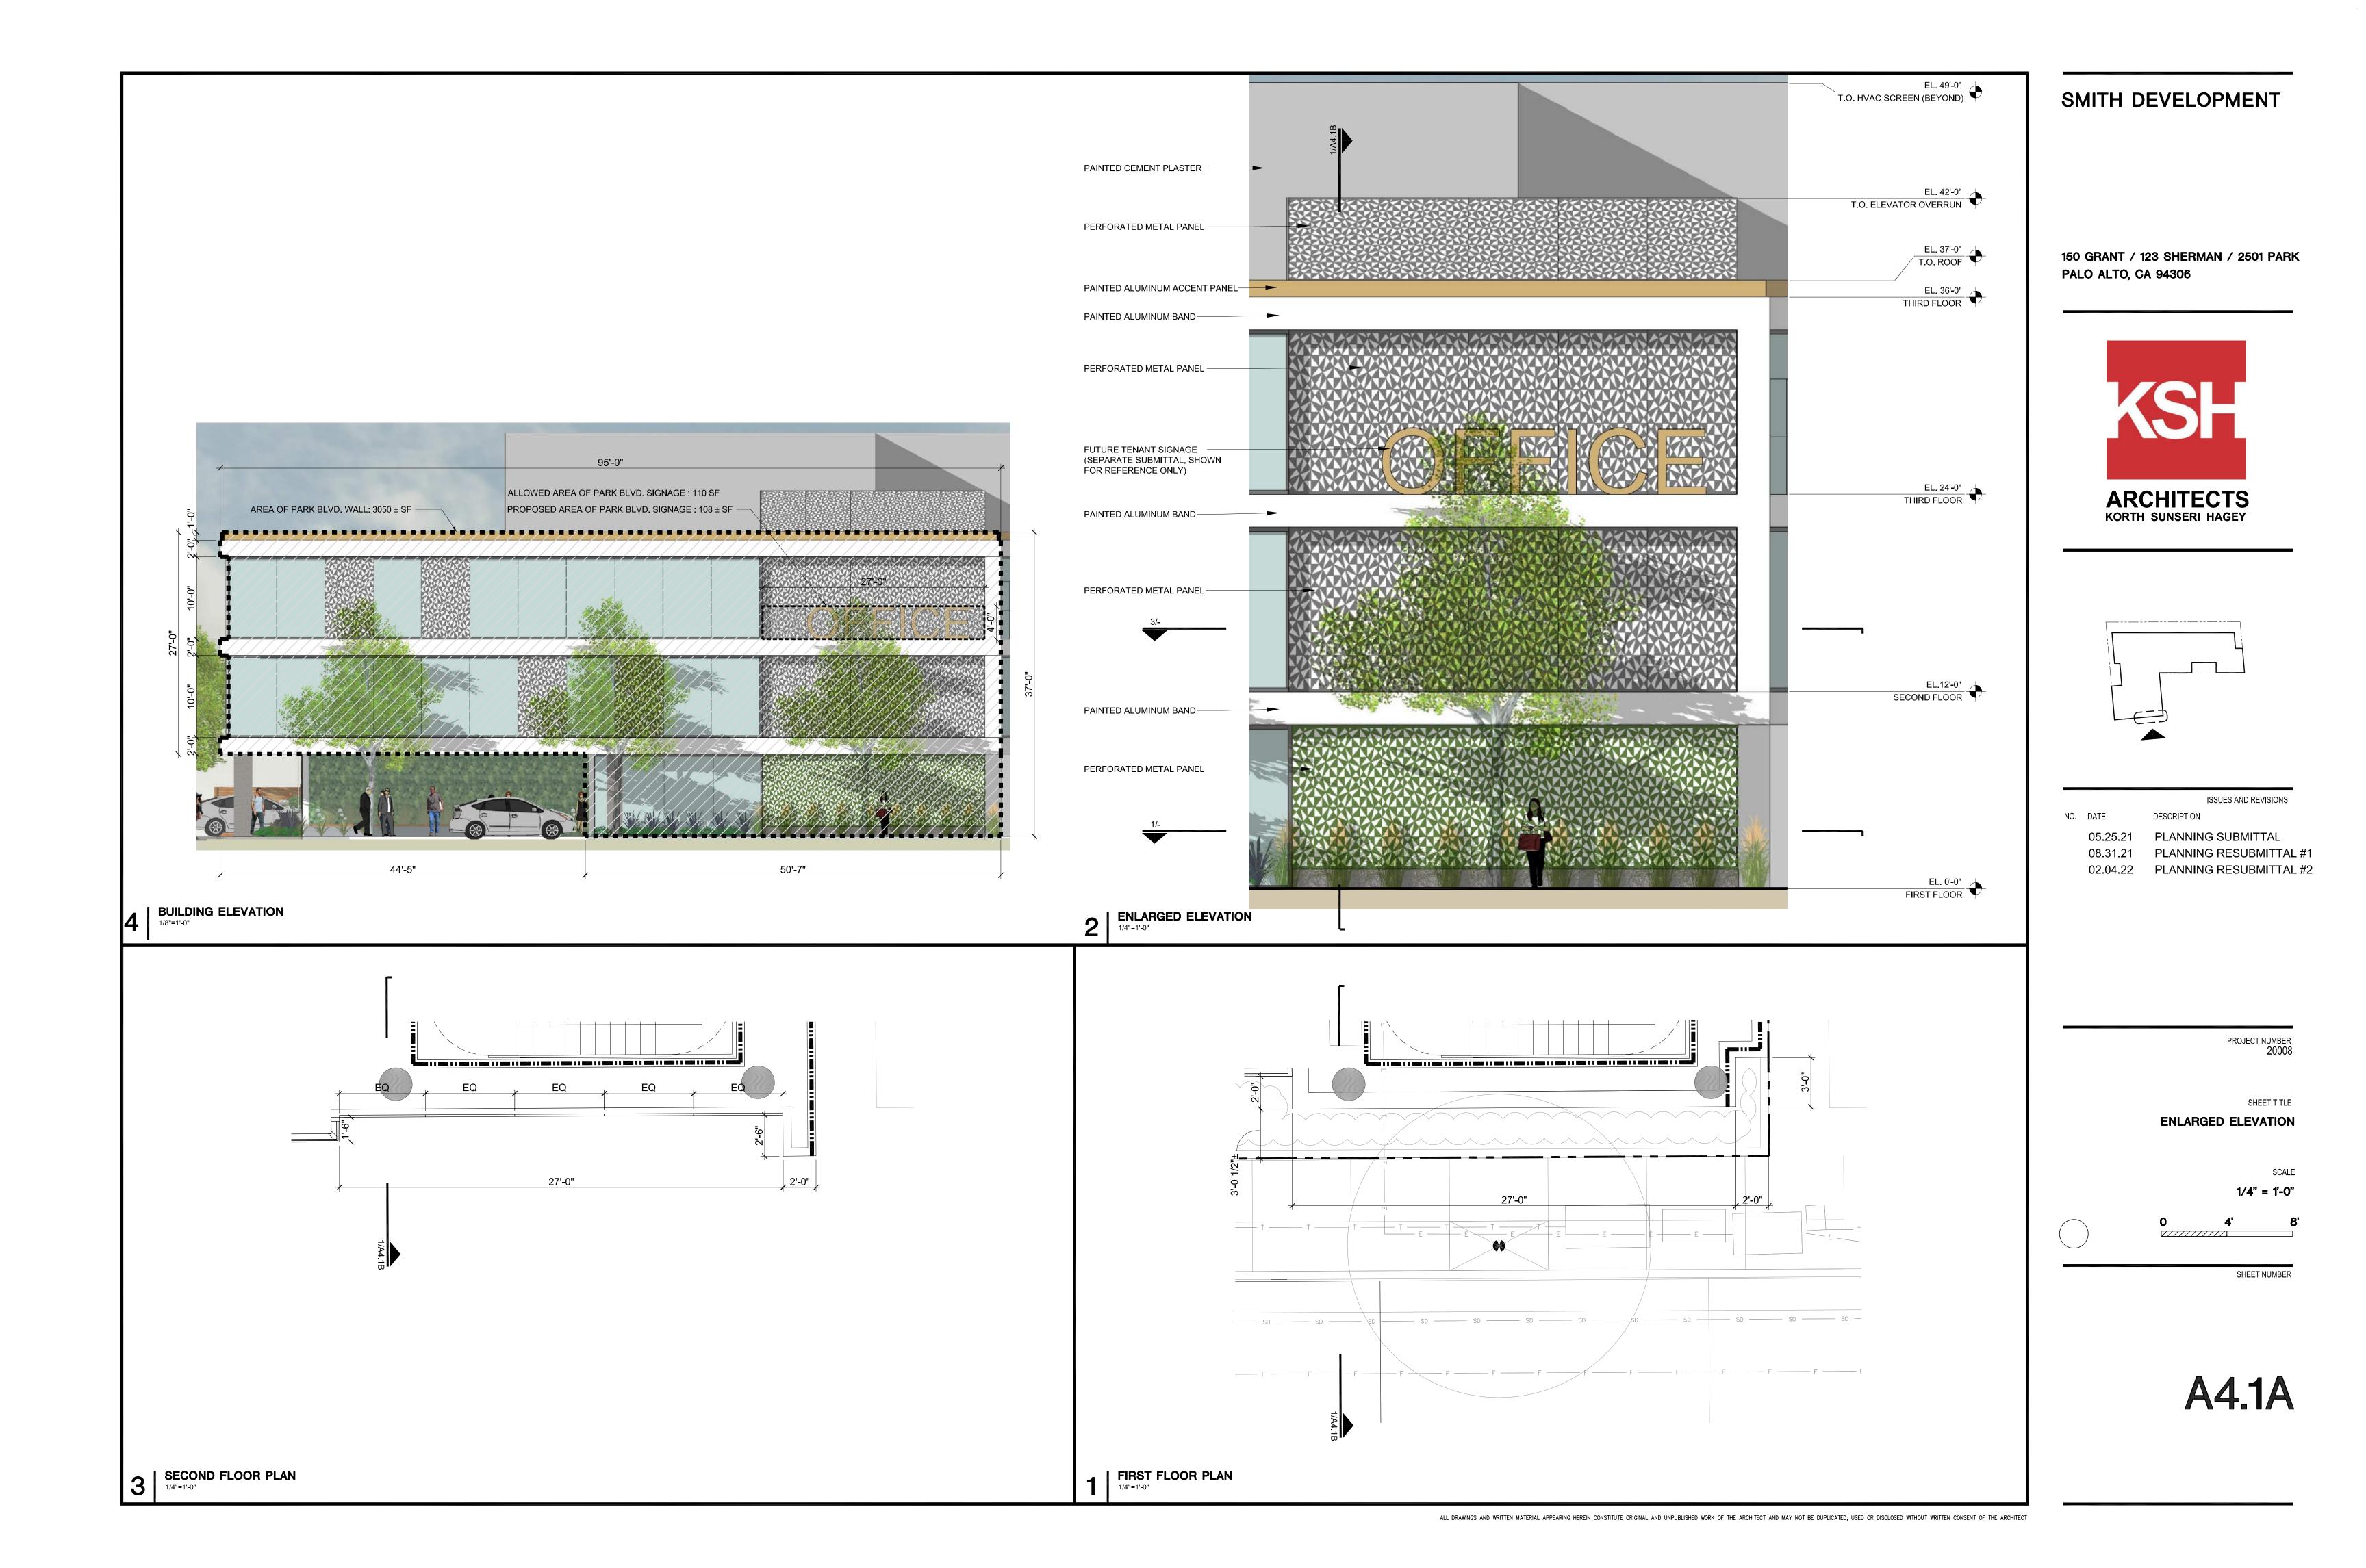

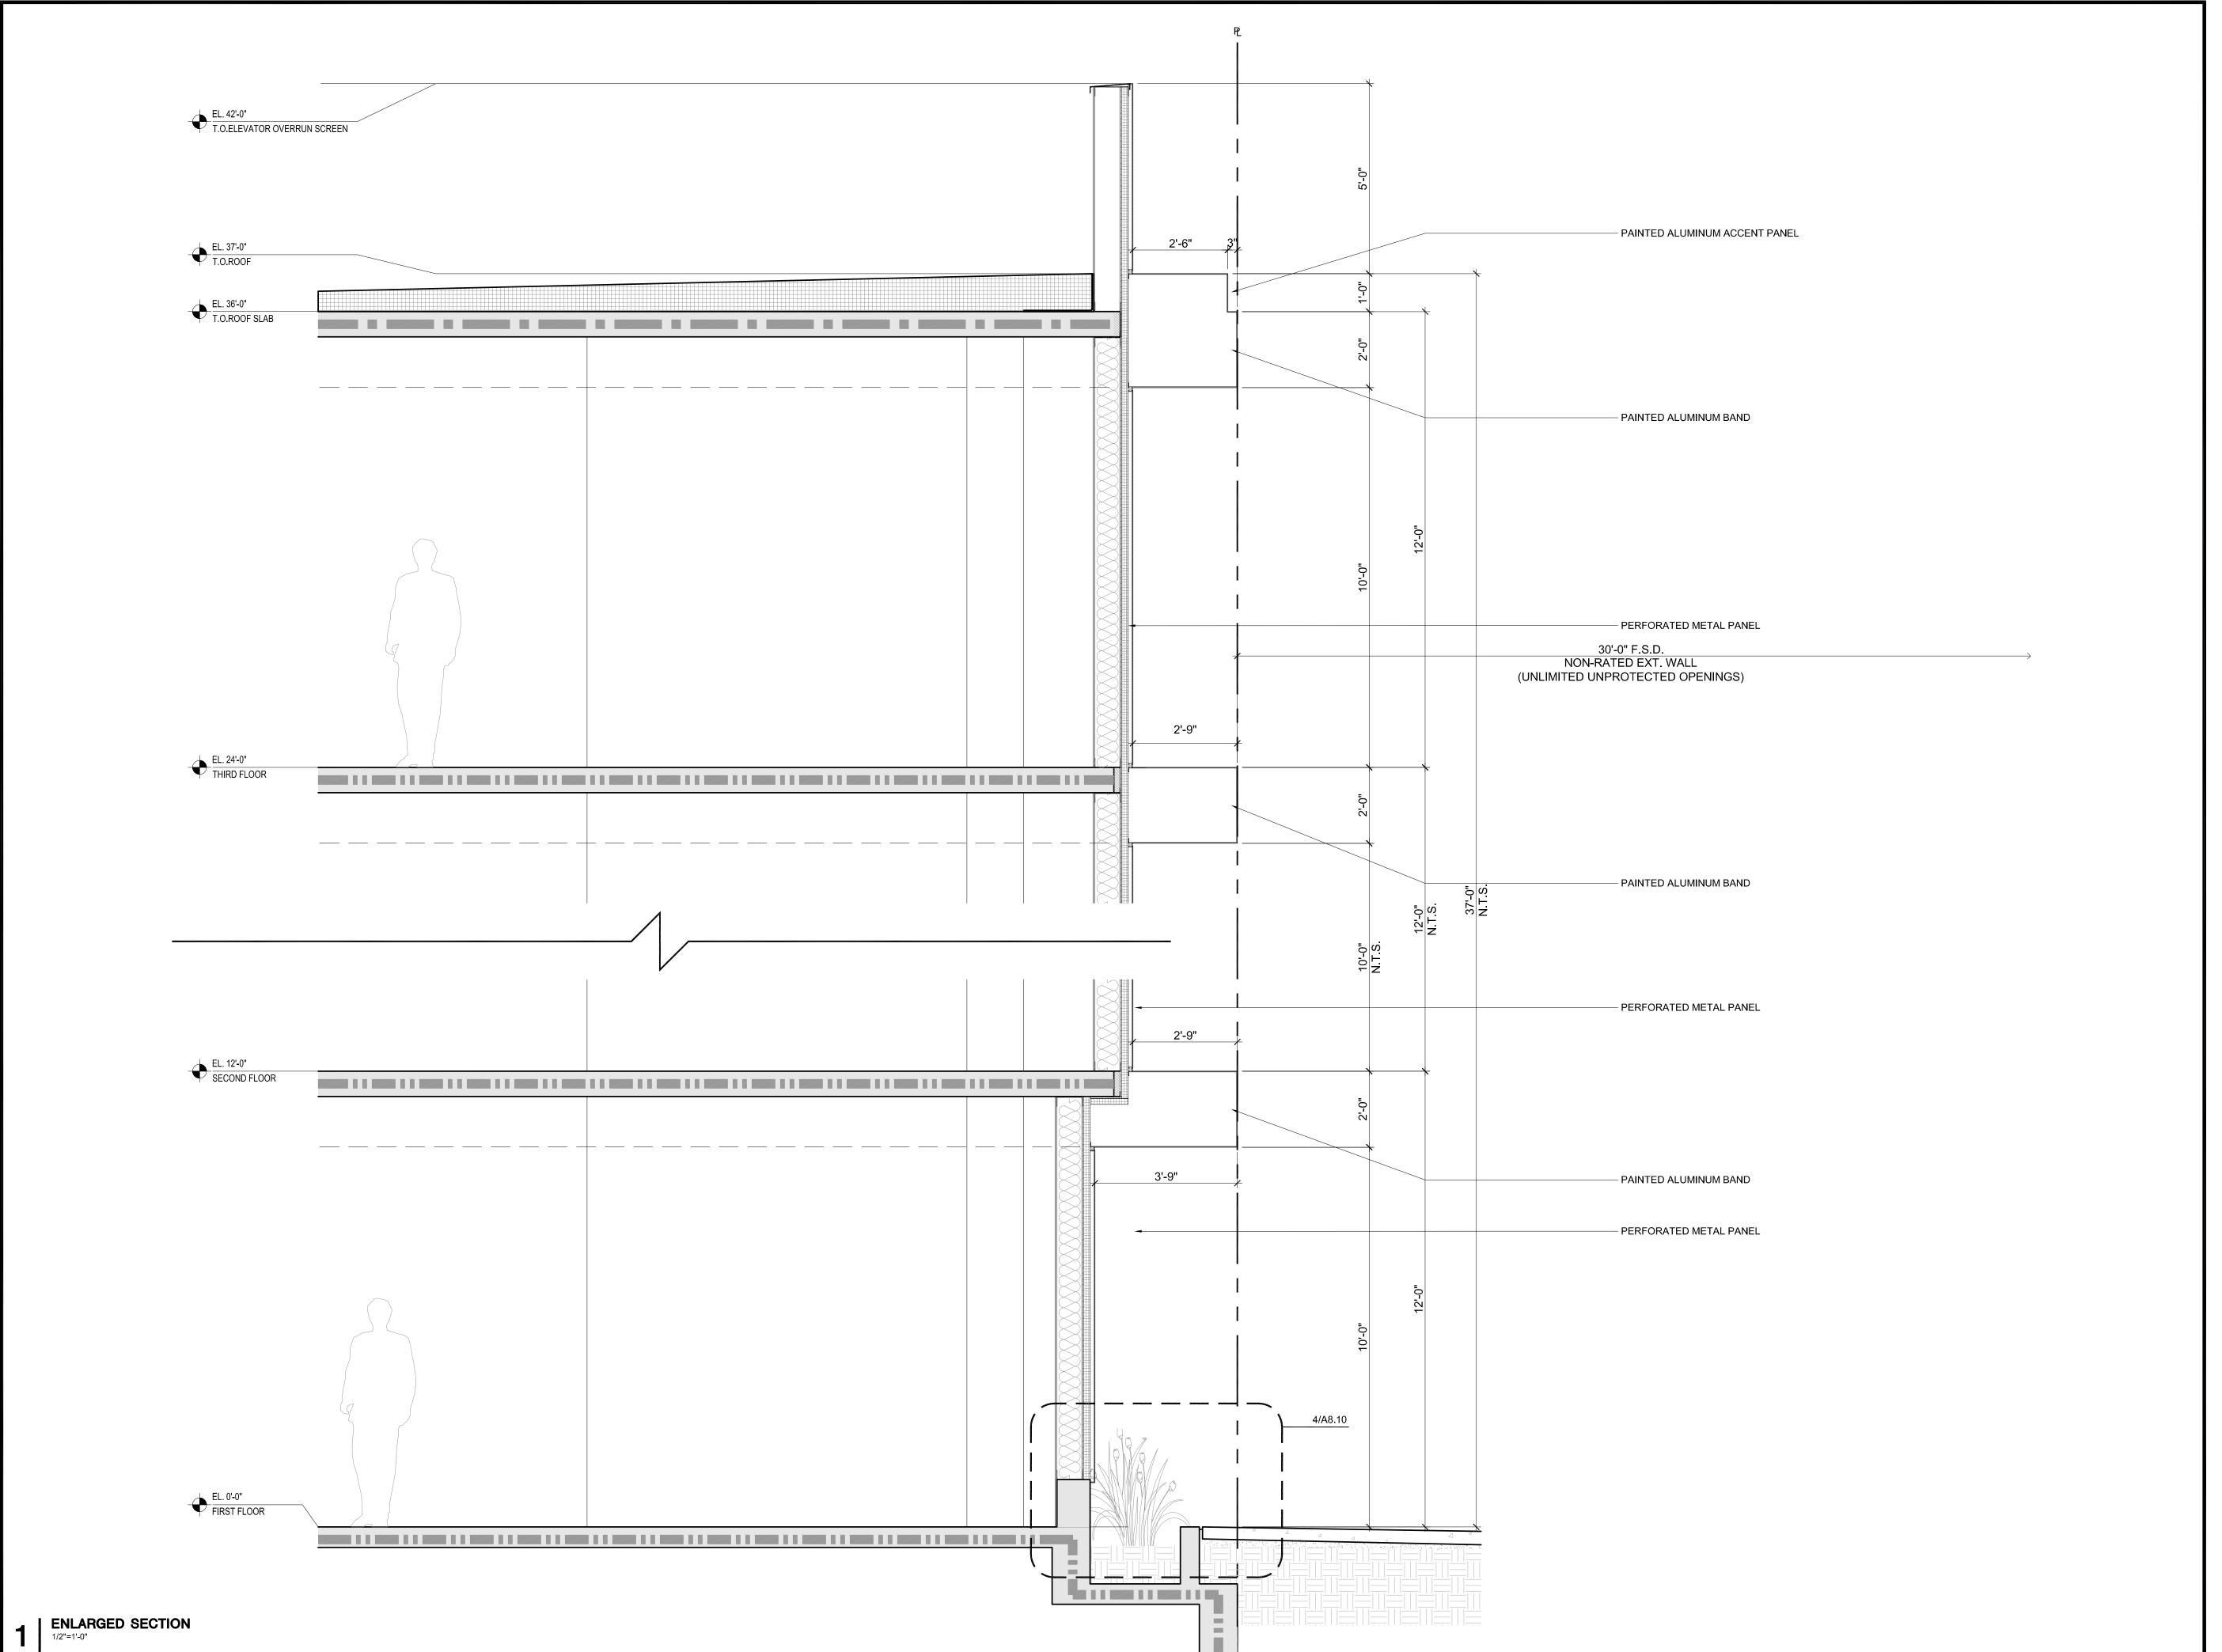

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ISSUES AND REVISIONS

NO. DATE DESCRIPTION

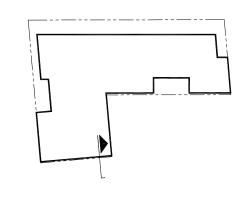08.31.21 PLANNING RESUBMITTAL #1
02.04.22 PLANNING RESUBMITTAL #2

PROJECT NUMB 200


ENLARGED SECTION

1/2" = 1'-0"

0 2' 4'

SHEET NUM


A41F

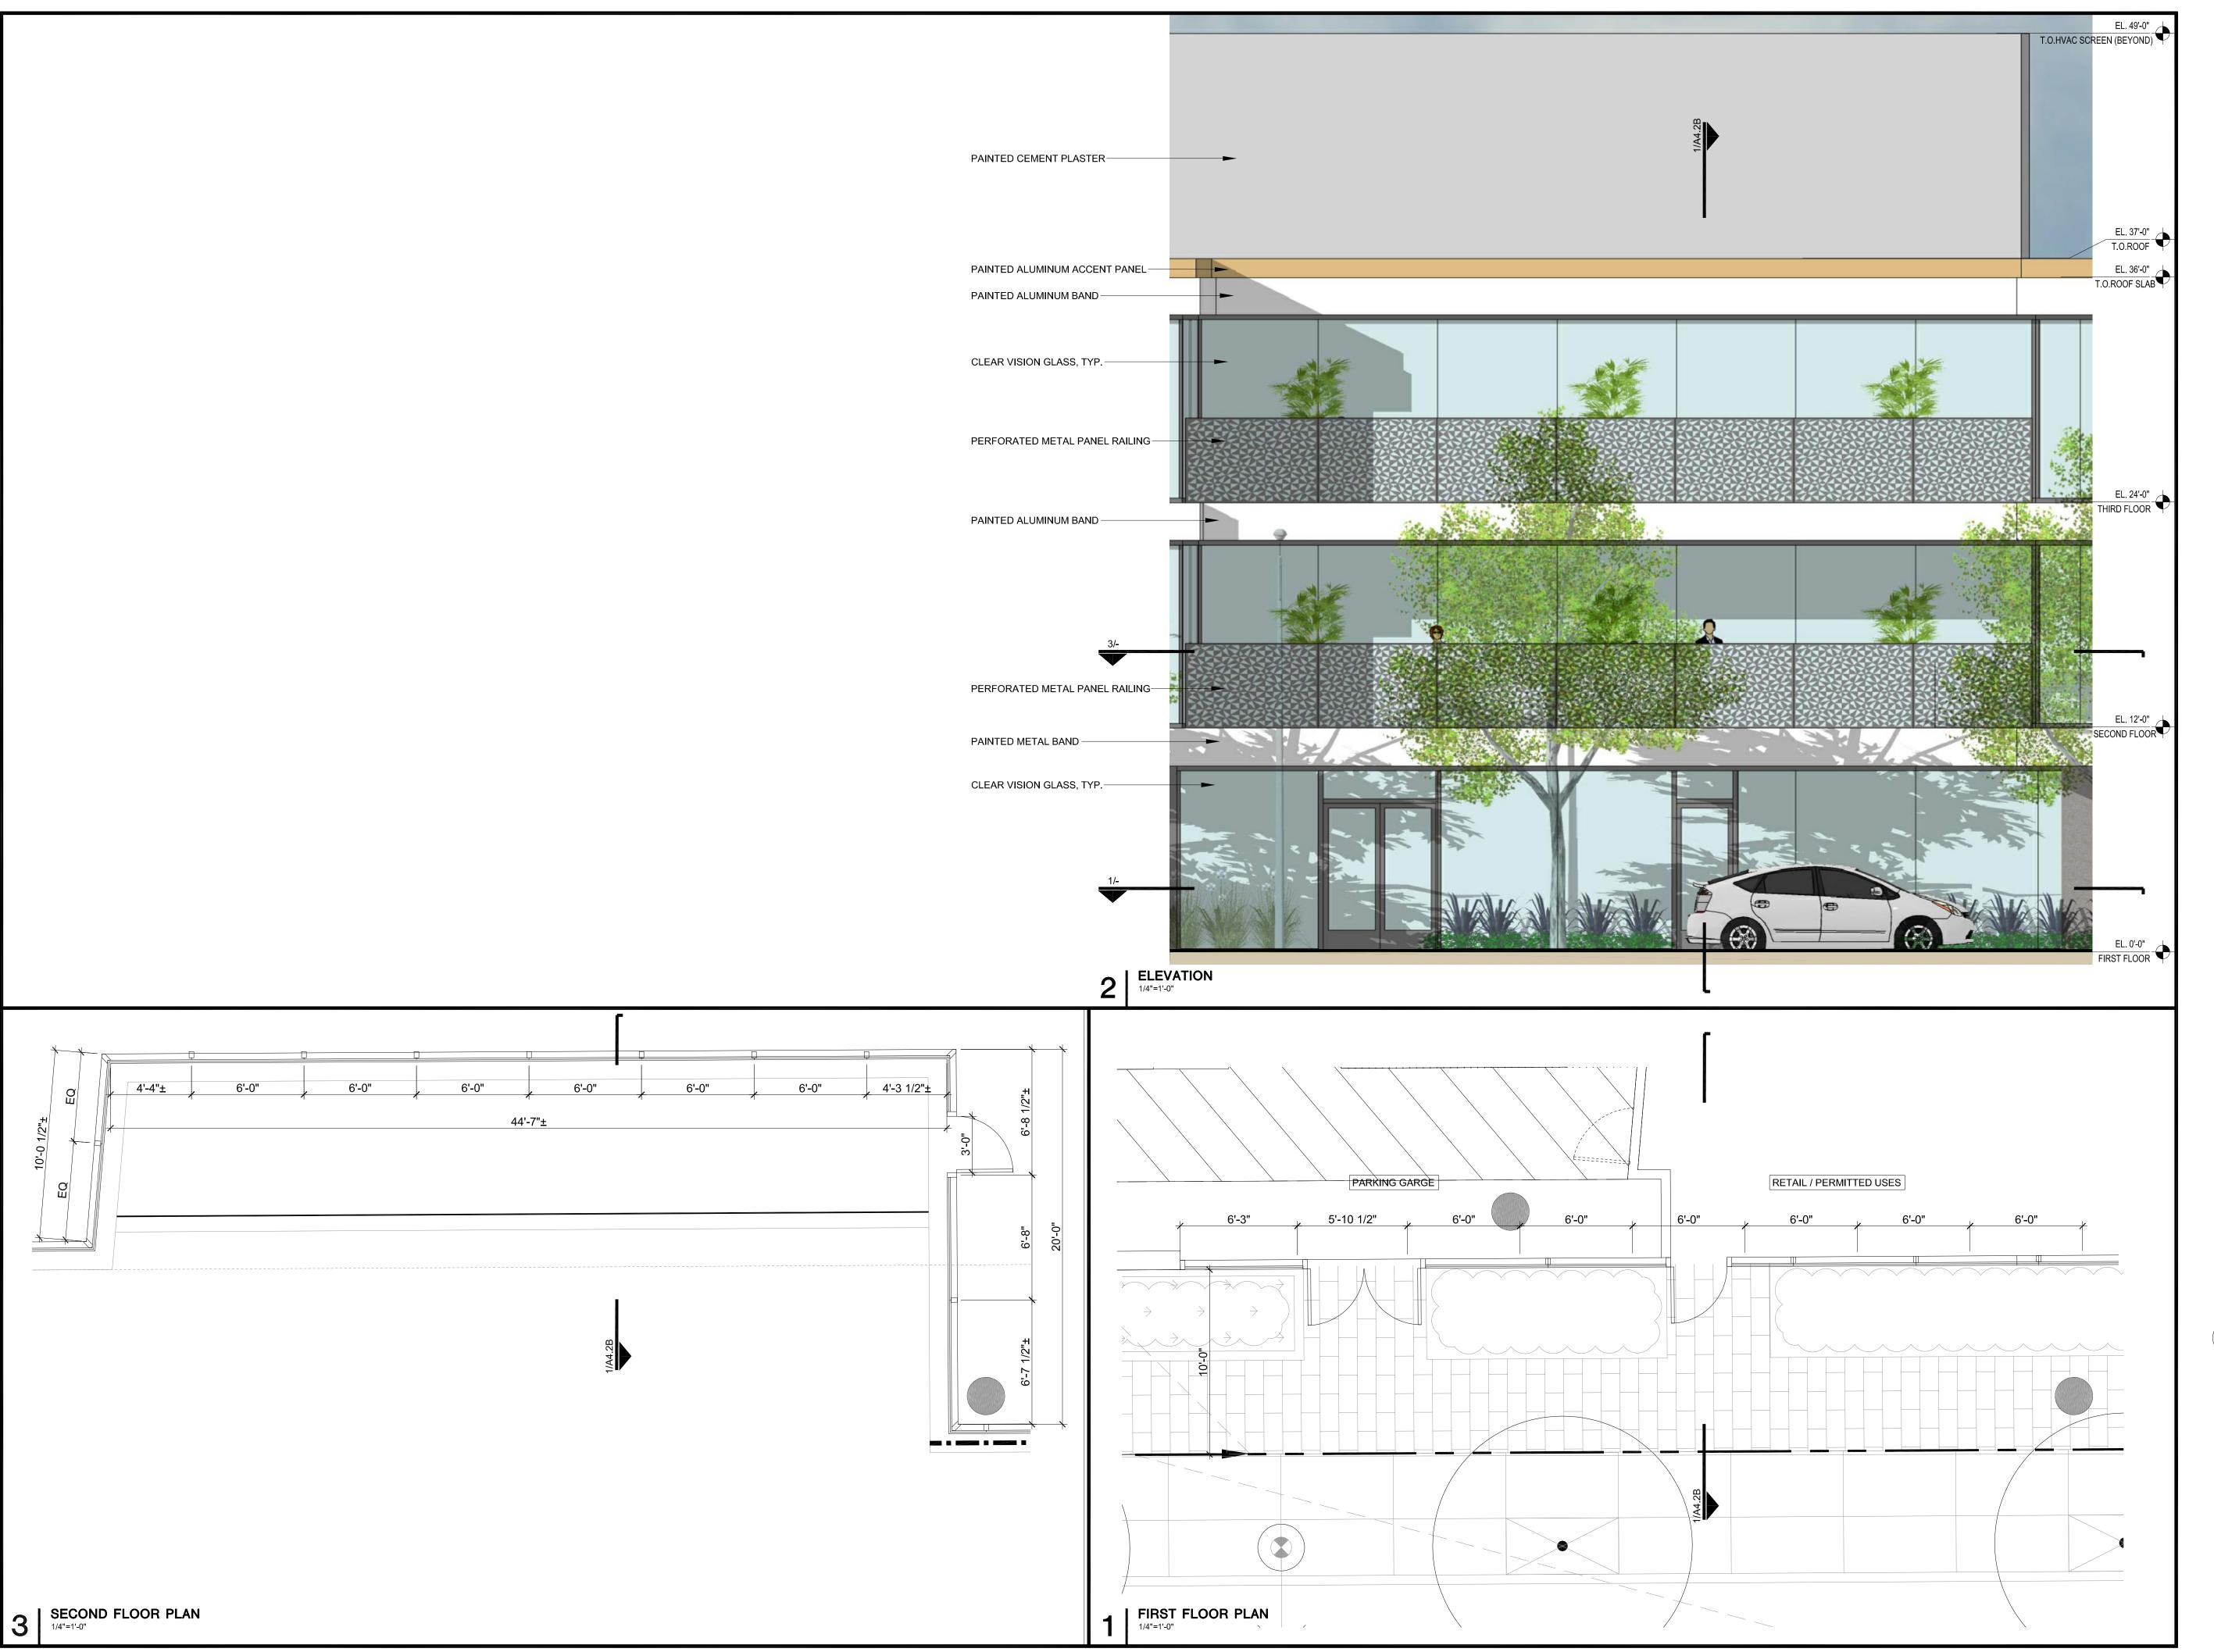

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ARCHITECTS
KORTH SUNSERI HAGEY



ISSUES AND REVISIONS

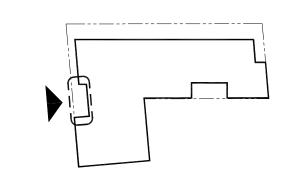DESCRIPTION 05.25.21 PLANNING SUBMITTAL

PLANNING RESUBMITTAL #1

02.04.22 PLANNING RESUBMITTAL #2

PROJECT NUMBER 20008


SHEET TITLE

ENLARGED ELEVATION

SCALE 1/4" = 1'-0"


SHEET NUMBER

A4.2A

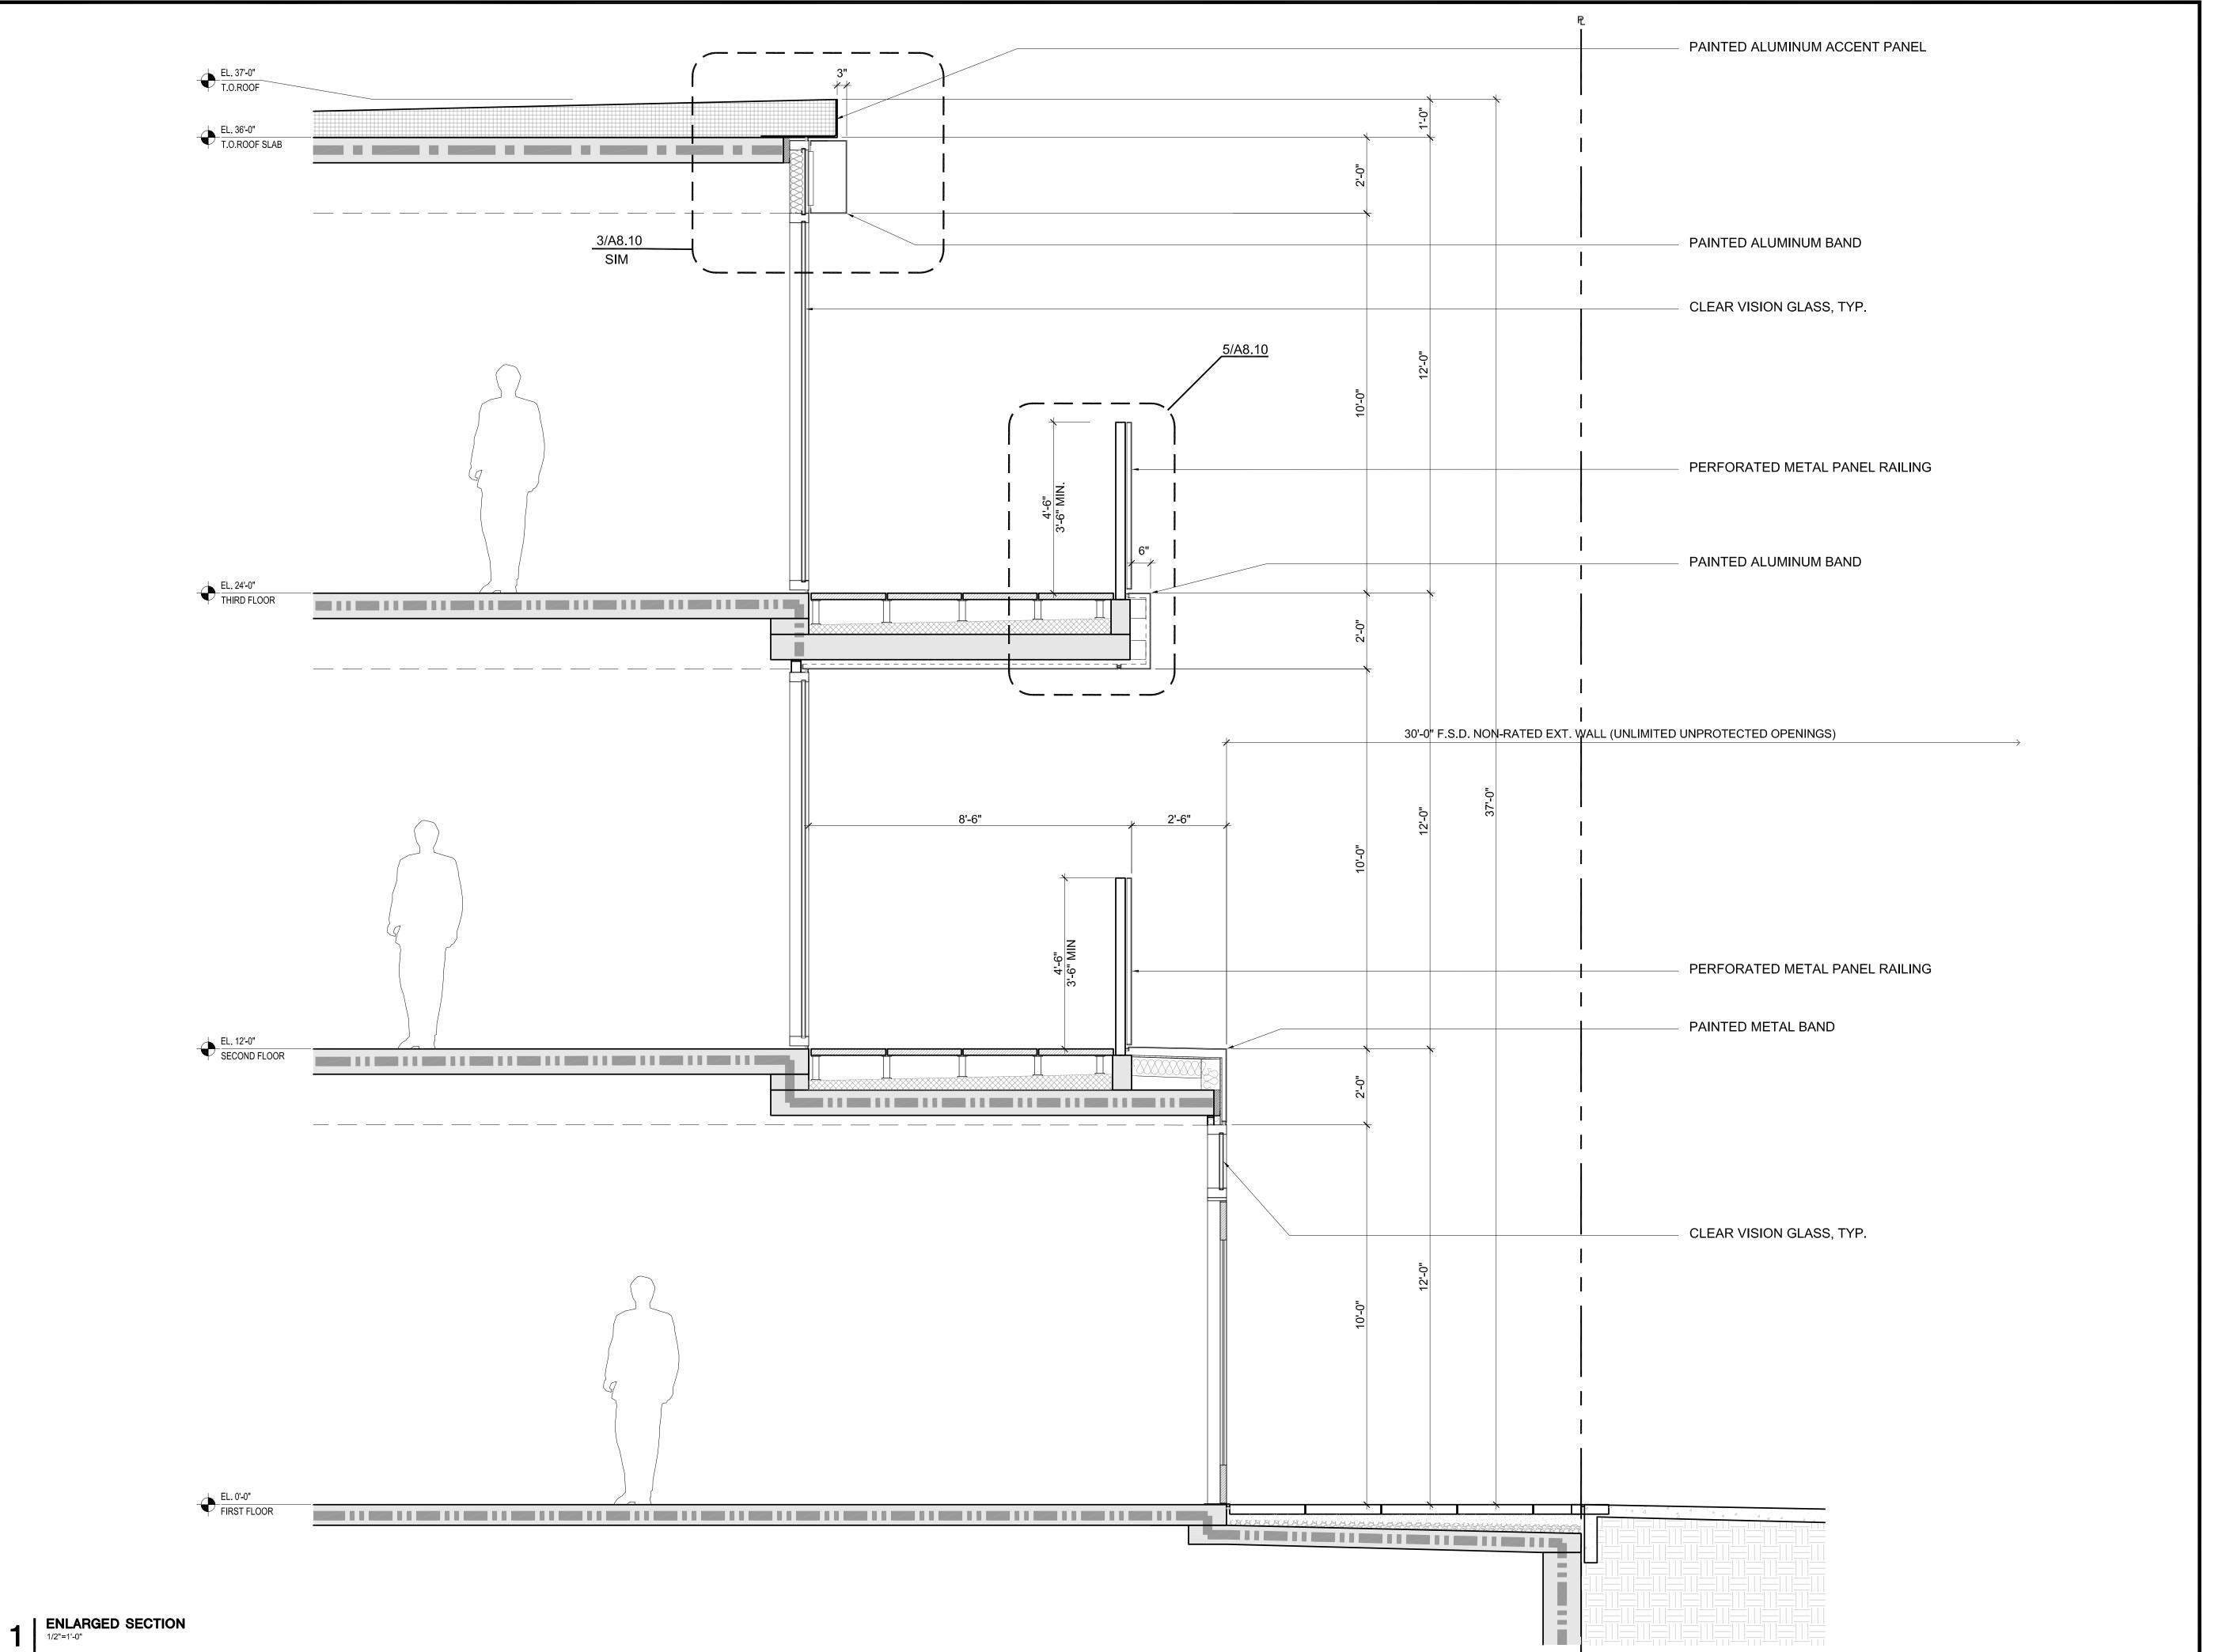

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ISSUES AND REVISIONS

NO. DATE DESCRIPTION

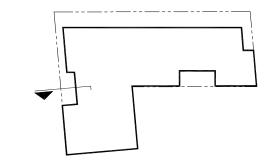08.31.21 PLANNING RESUBMITTAL #1

02.04.22 PLANNING RESUBMITTAL #2

PROJECT NUMBI 200

SHEET TIT


ENLARGED SECTION

SCALE 1/2" = 1'-0"

0 2'


SHEET NUMBI

A42E

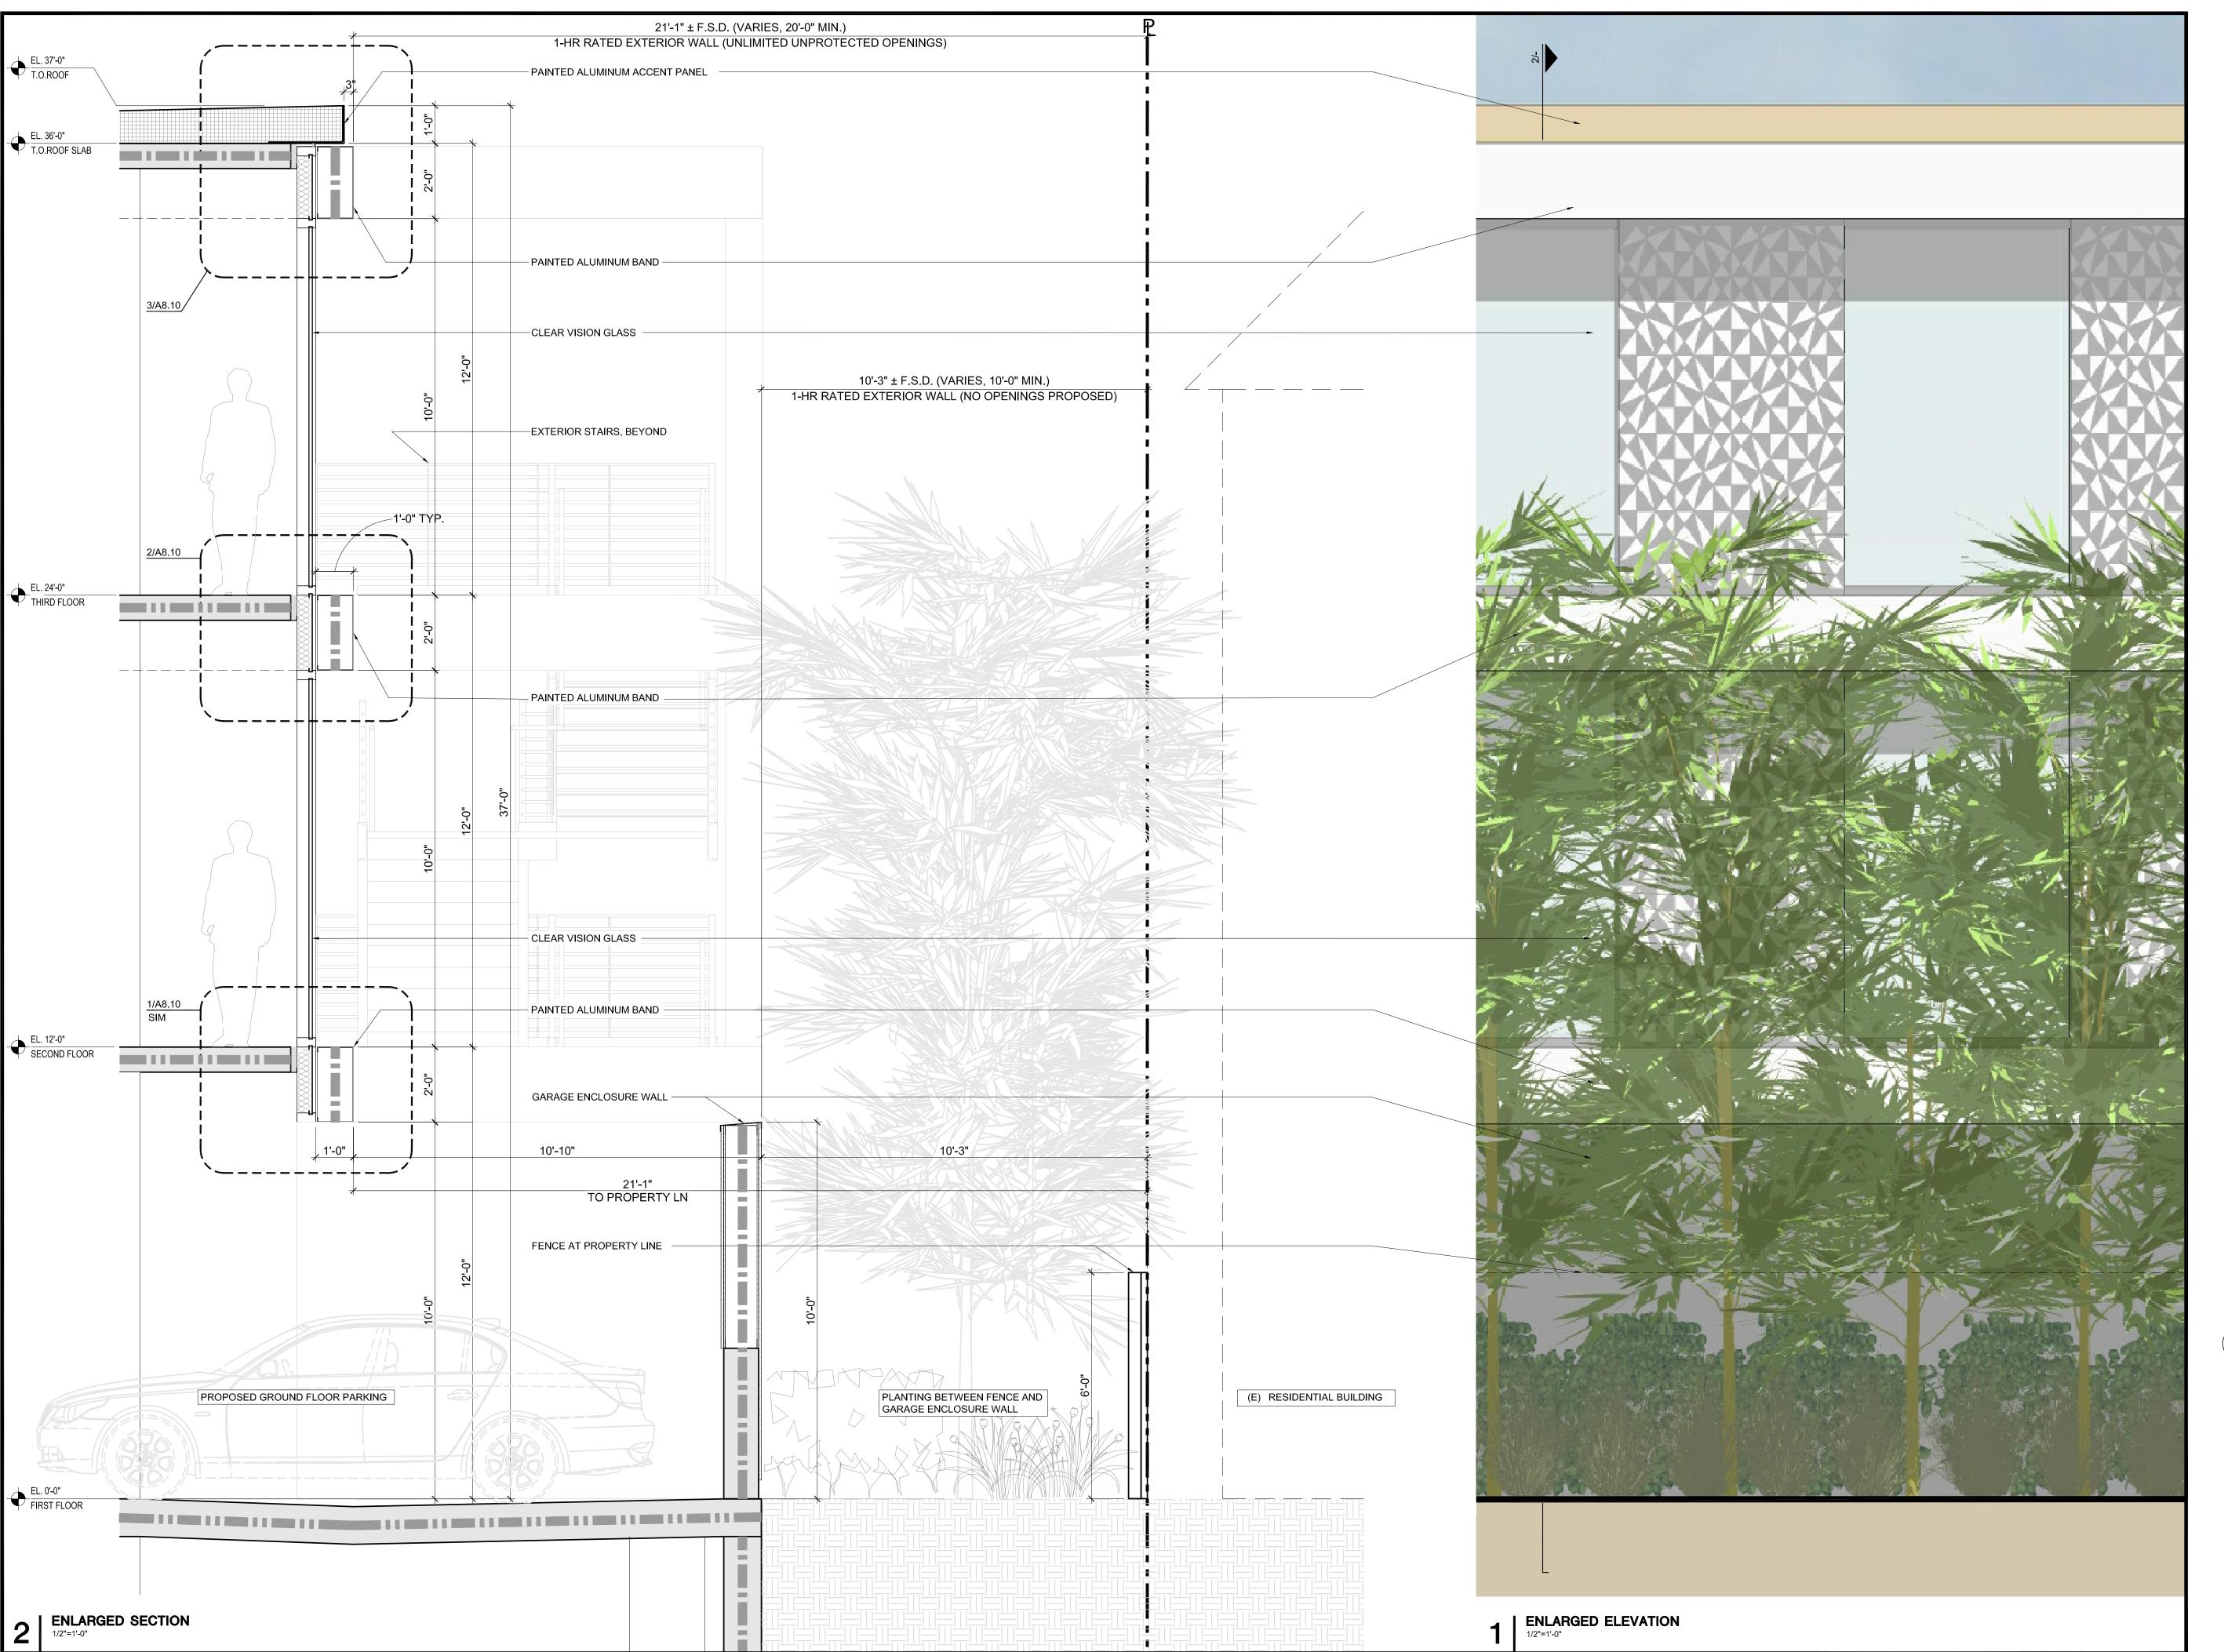

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ISSUES AND REVISIONS

DATE DESCRIPTION

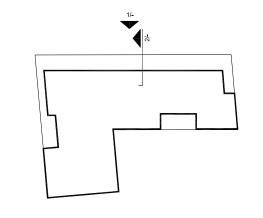08.31.21 PLANNING RESUBMITTAL #1 02.04.22 PLANNING RESUBMITTAL #2

PROJECT NUMI


SHEET TITLE

ENLARGED ELEVATION AND SECTION

1/2" = 1'-0"


SHEET NUMBER

A43

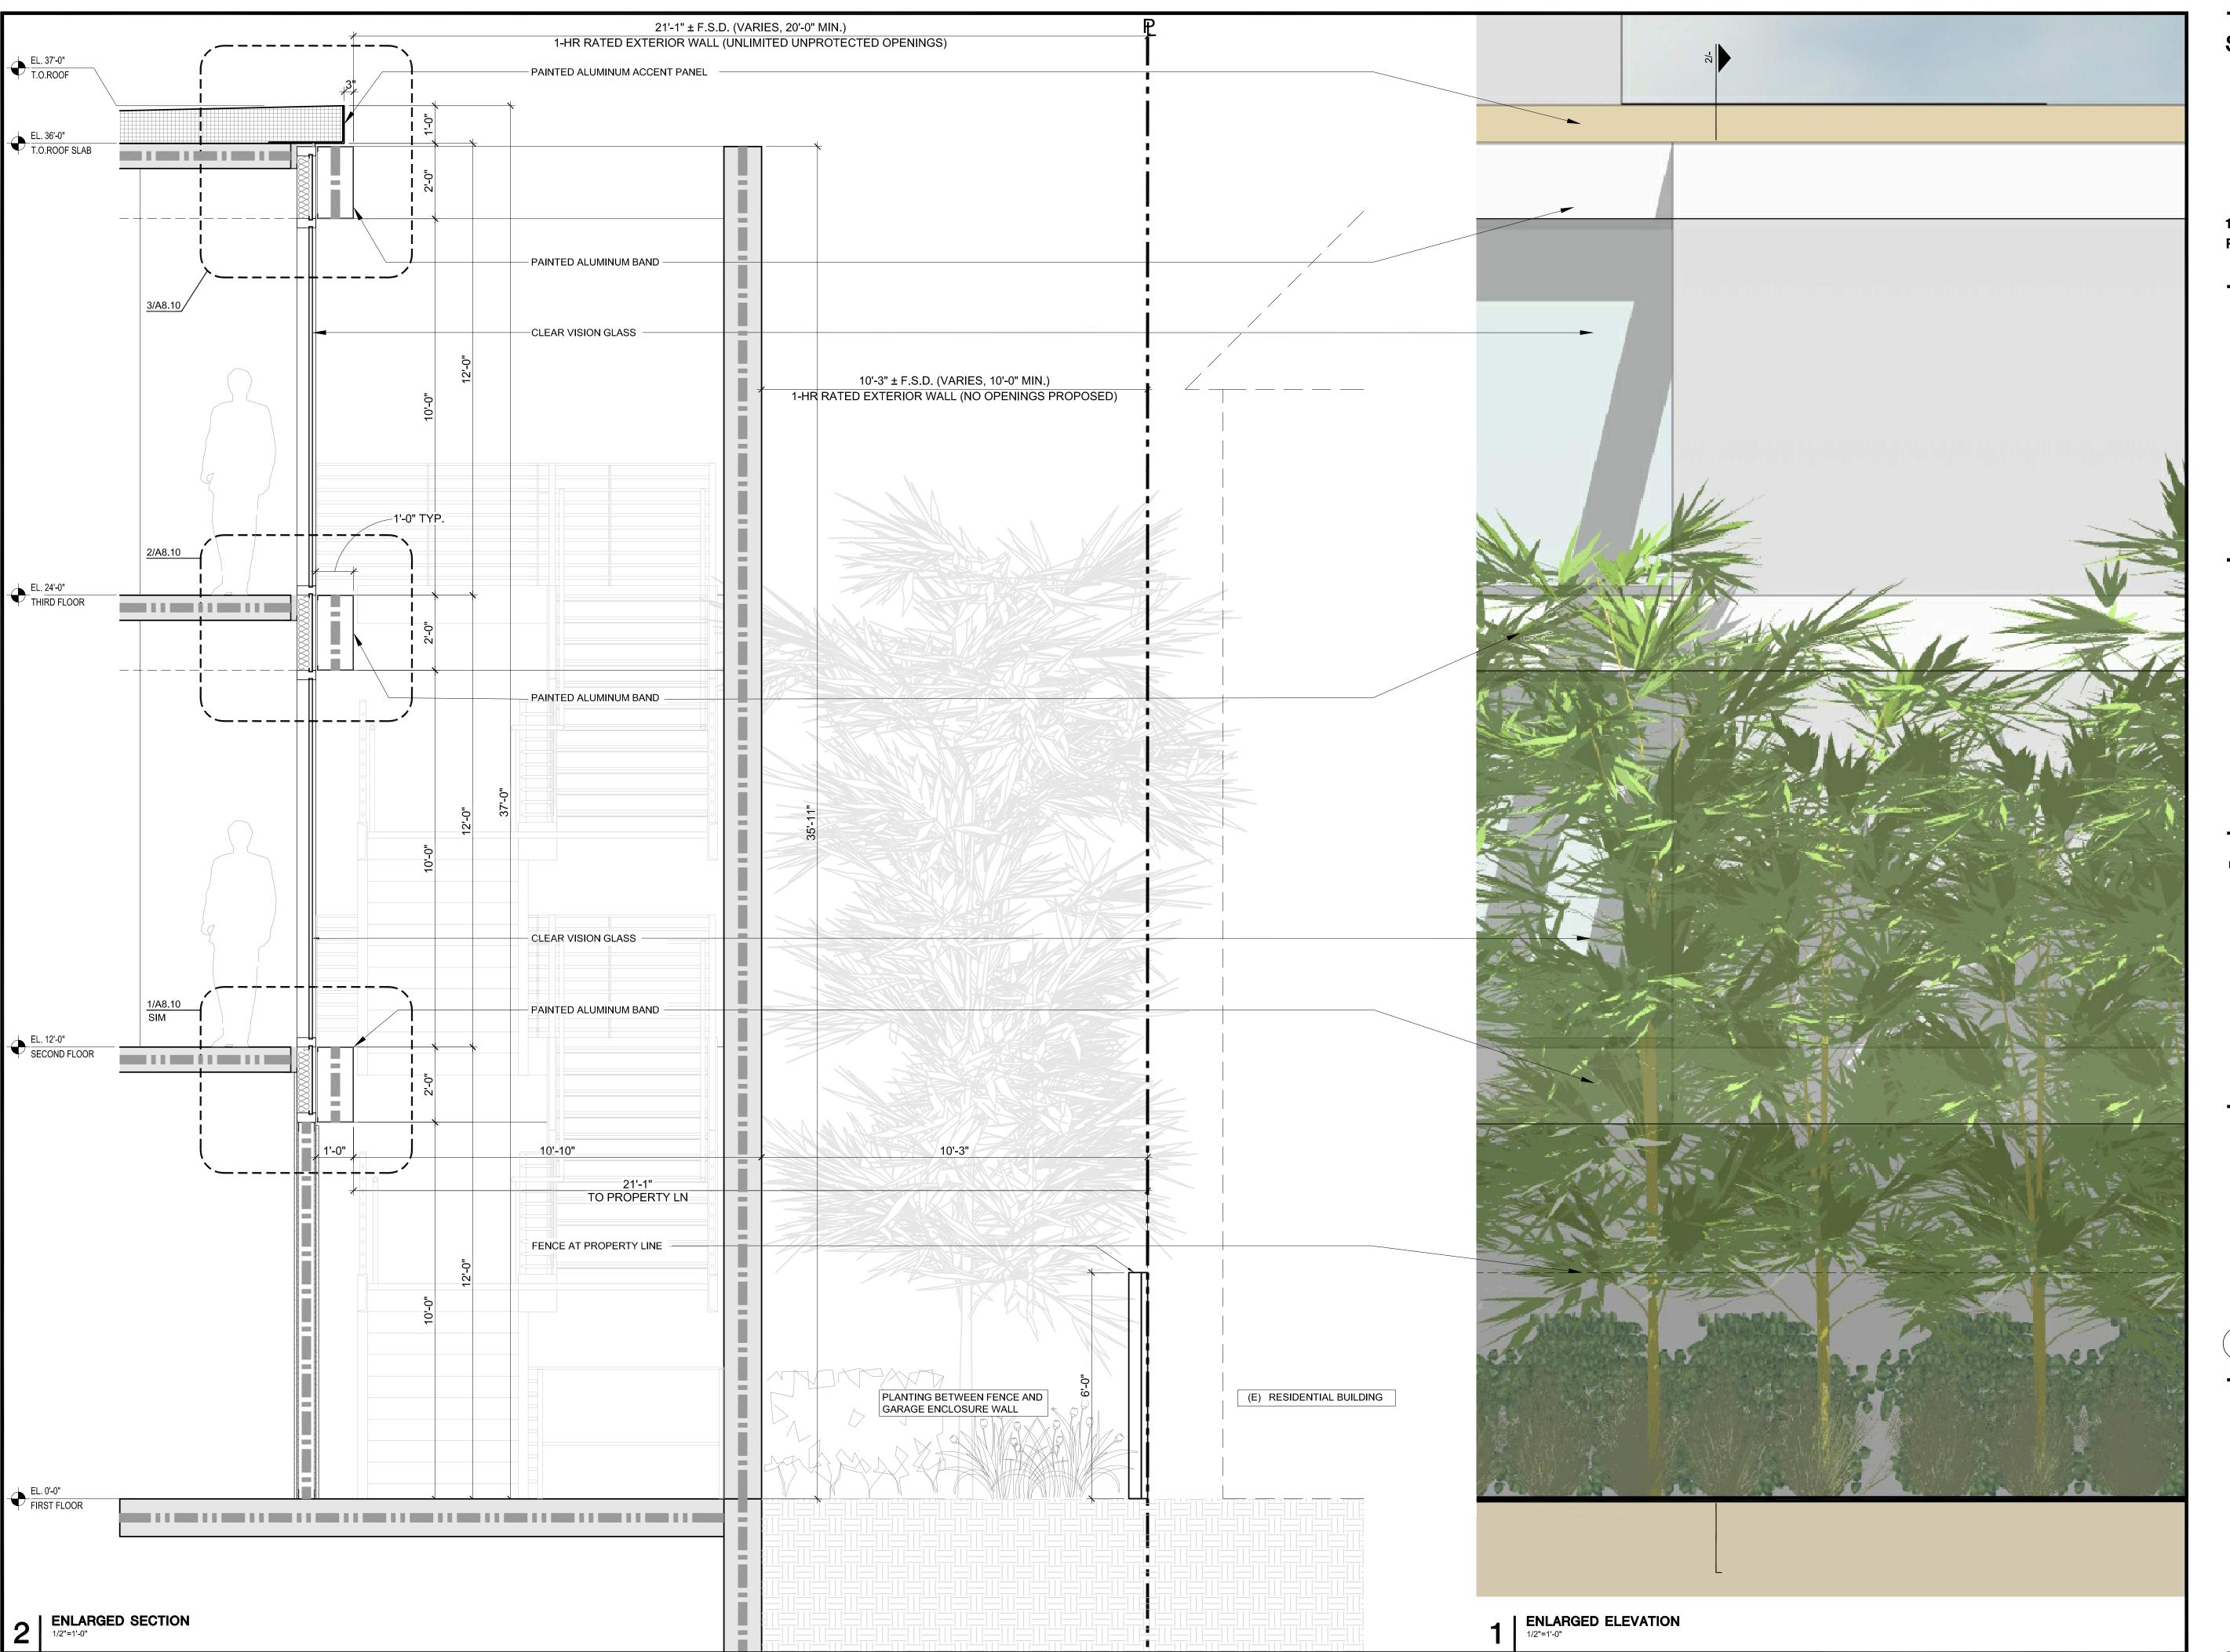

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ISSUES AND REVISIONS

DATE DESCRIPTION

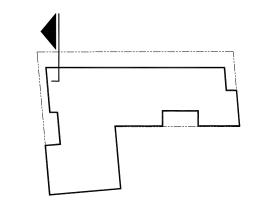02.04.22 PLANNING RESUBMITTAL #2

PROJECT NUMB

ENLARGED ELEVATION AND SECTION


1/2" - 1'-(


1/2" = 1'-0"


2'


SHEET NUME

A44

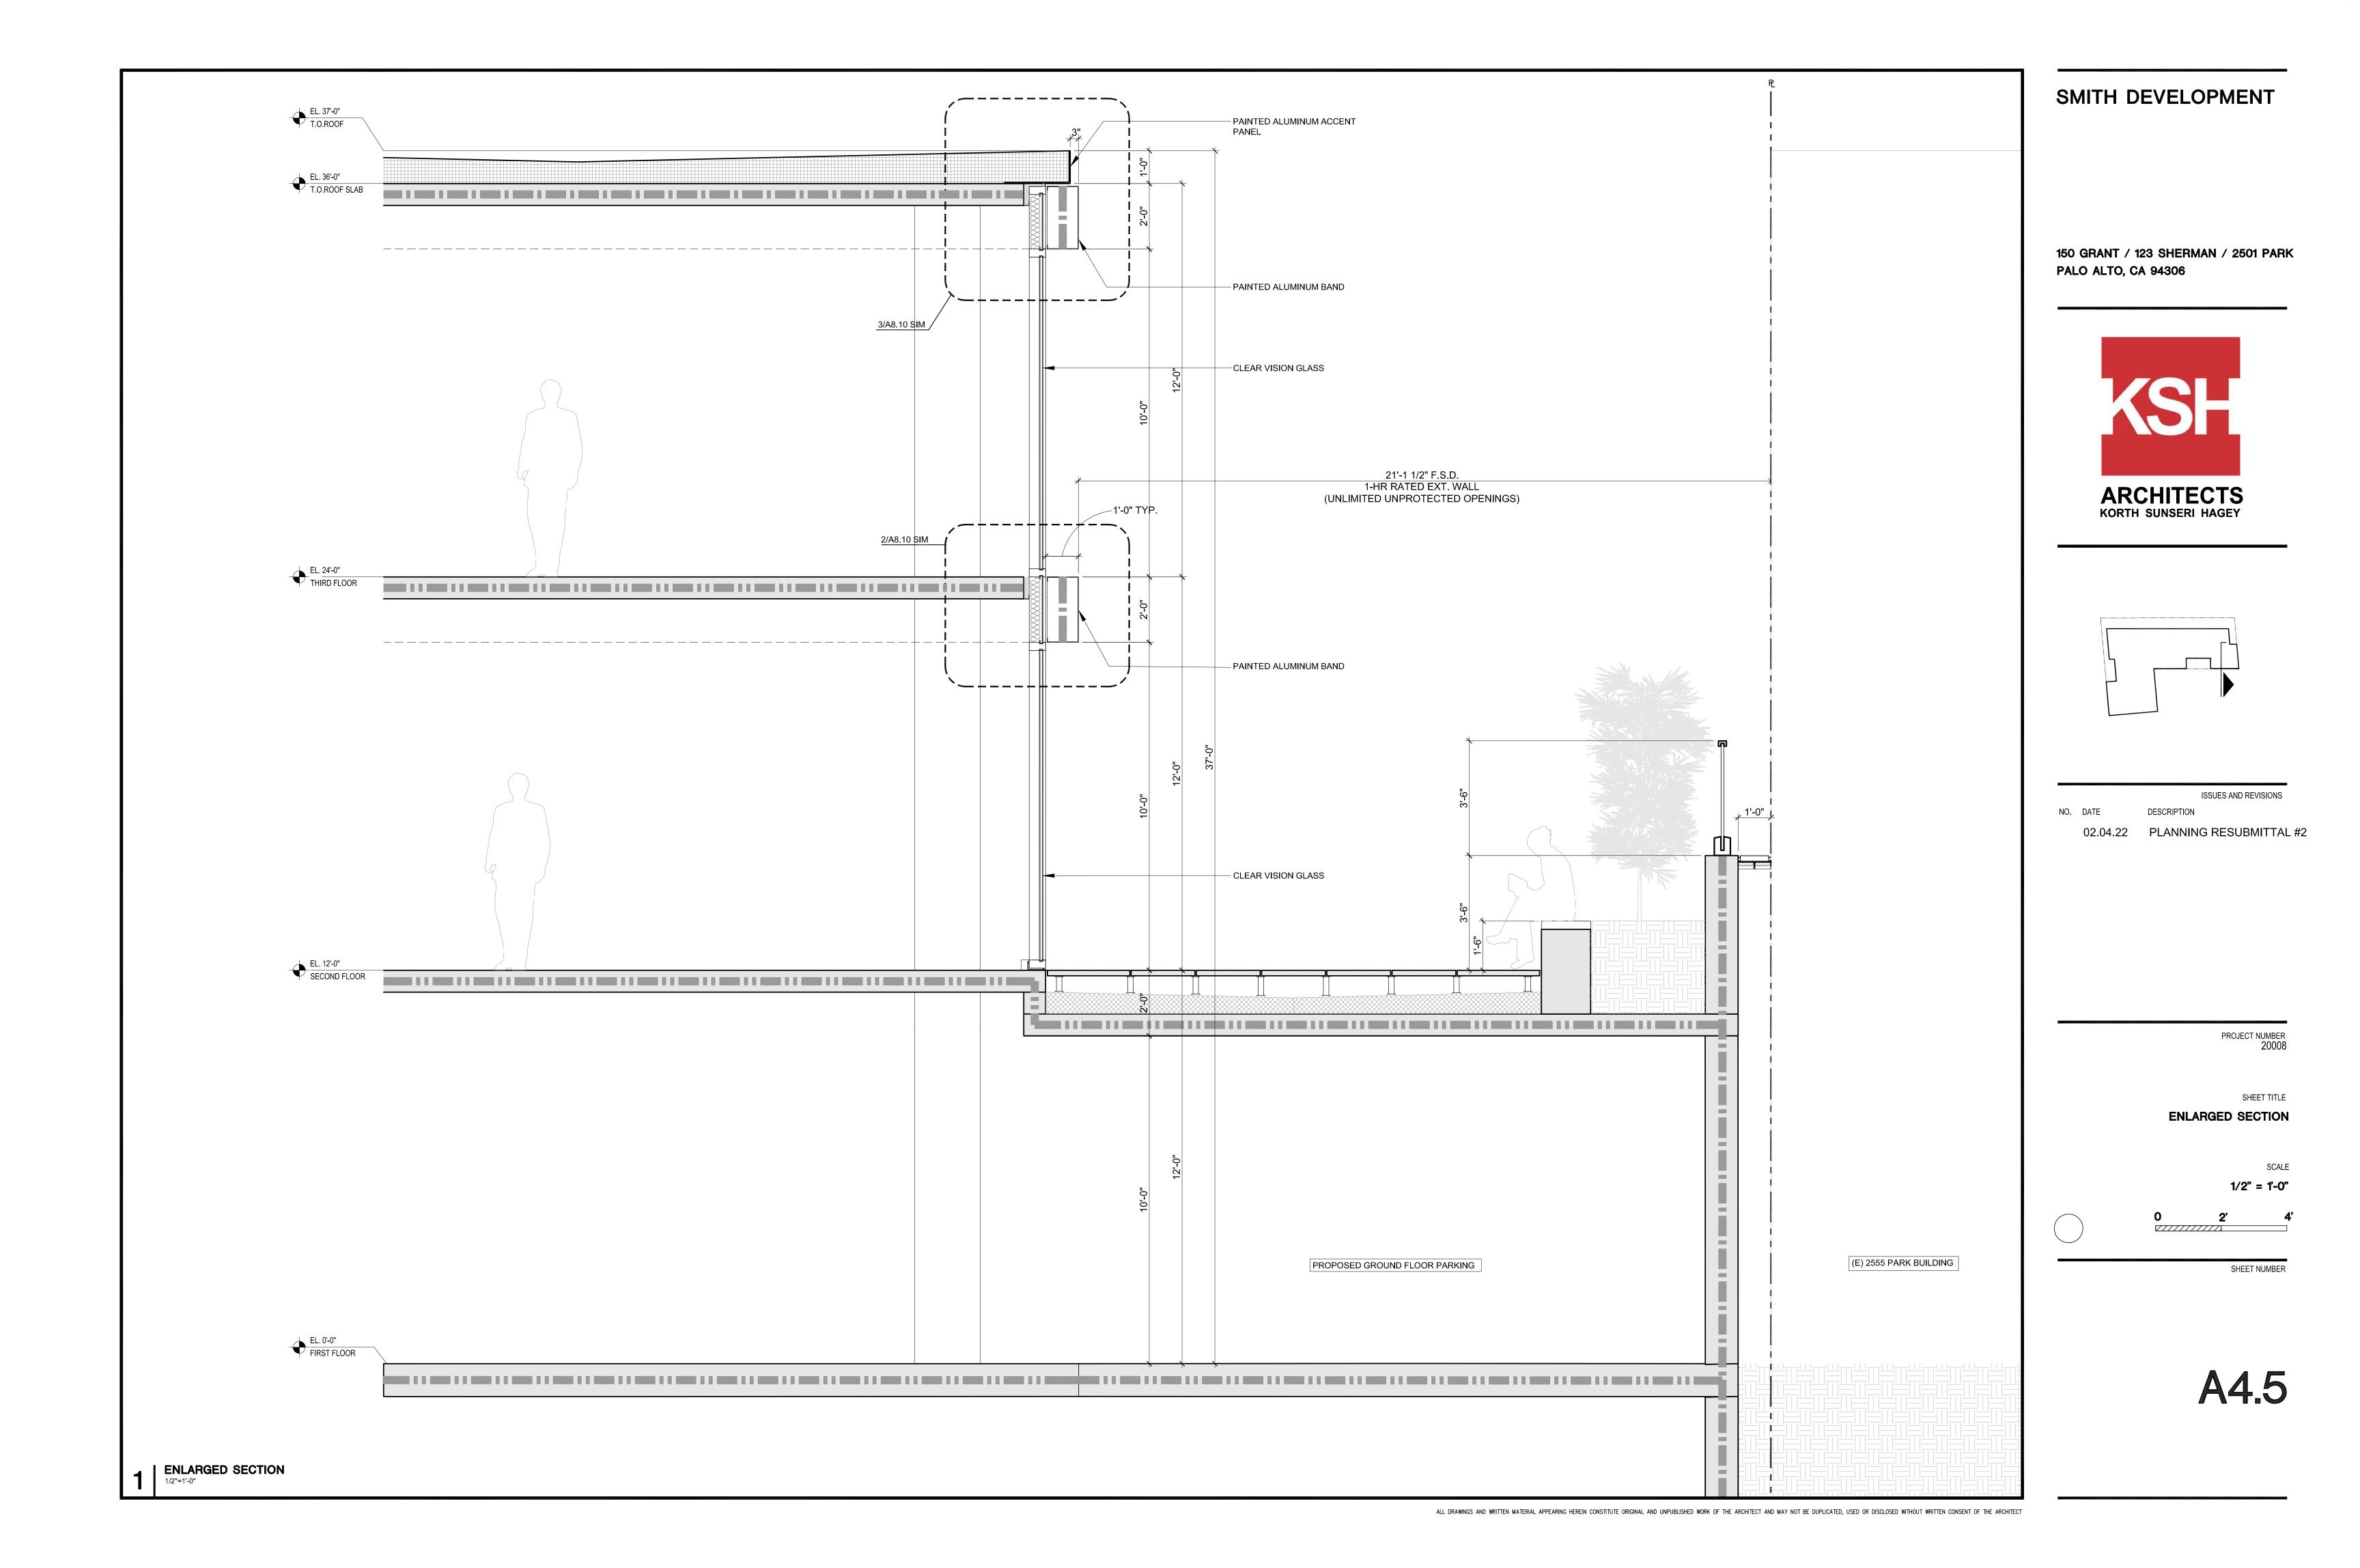

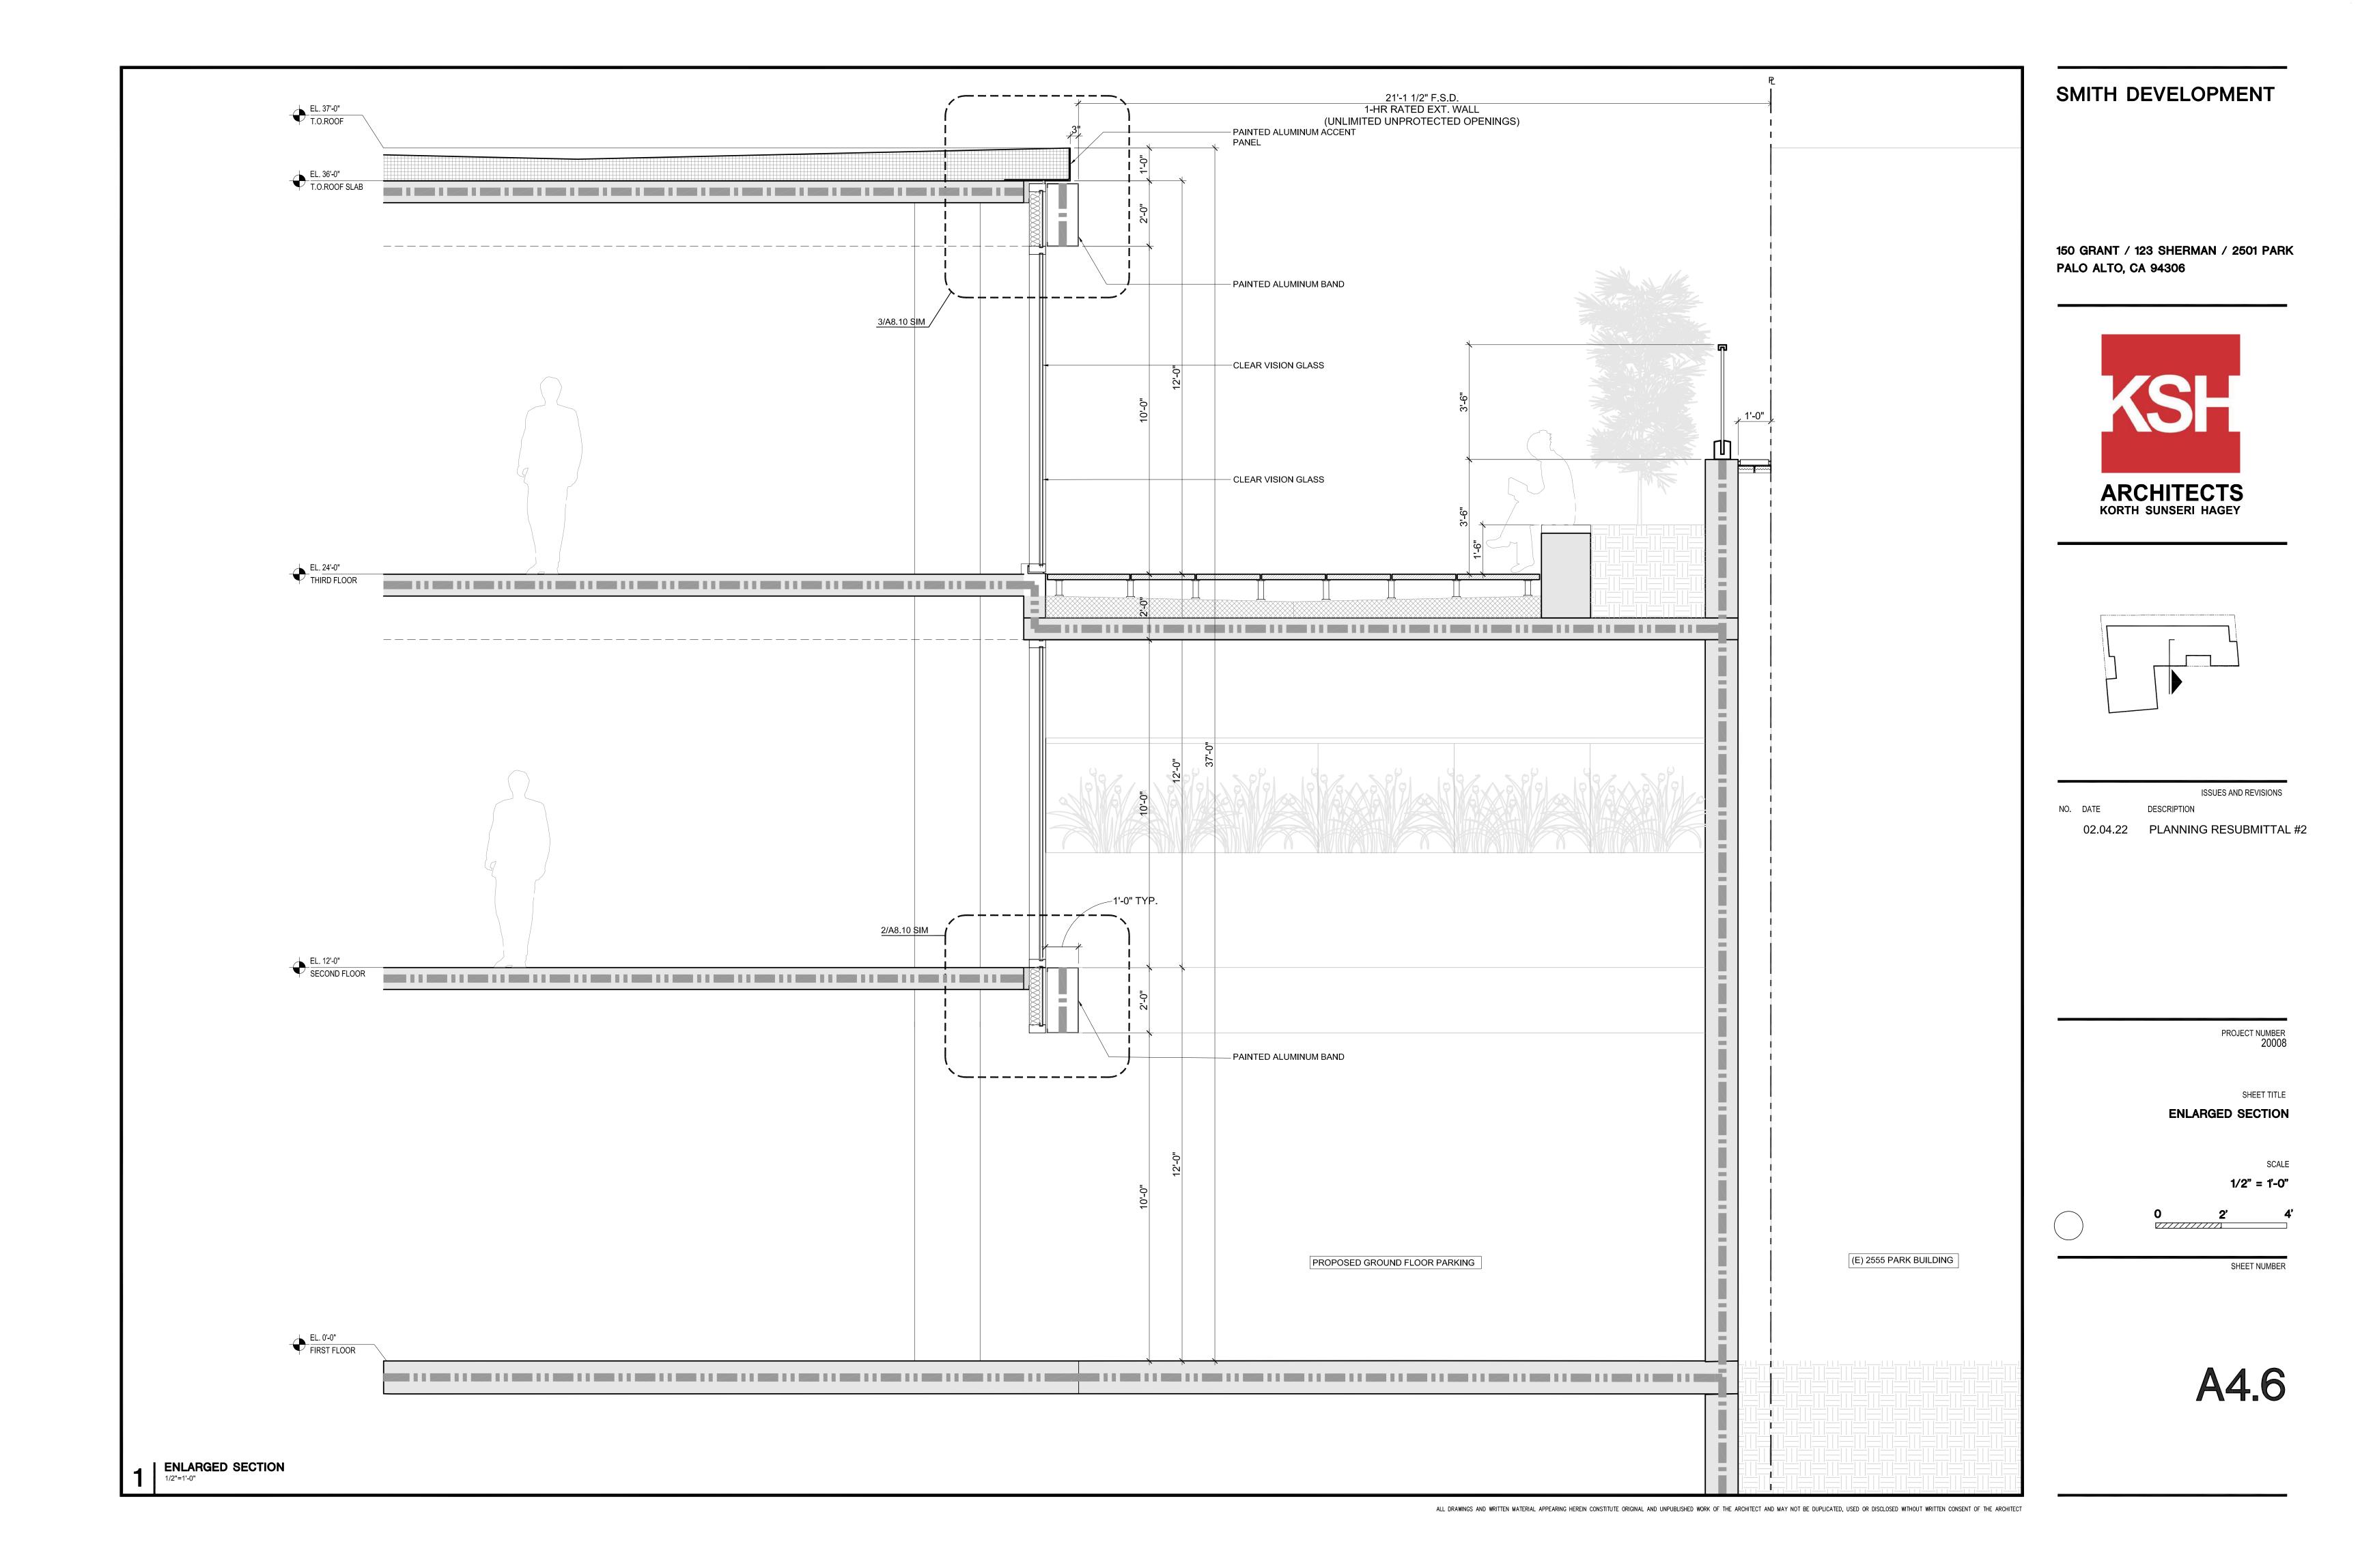

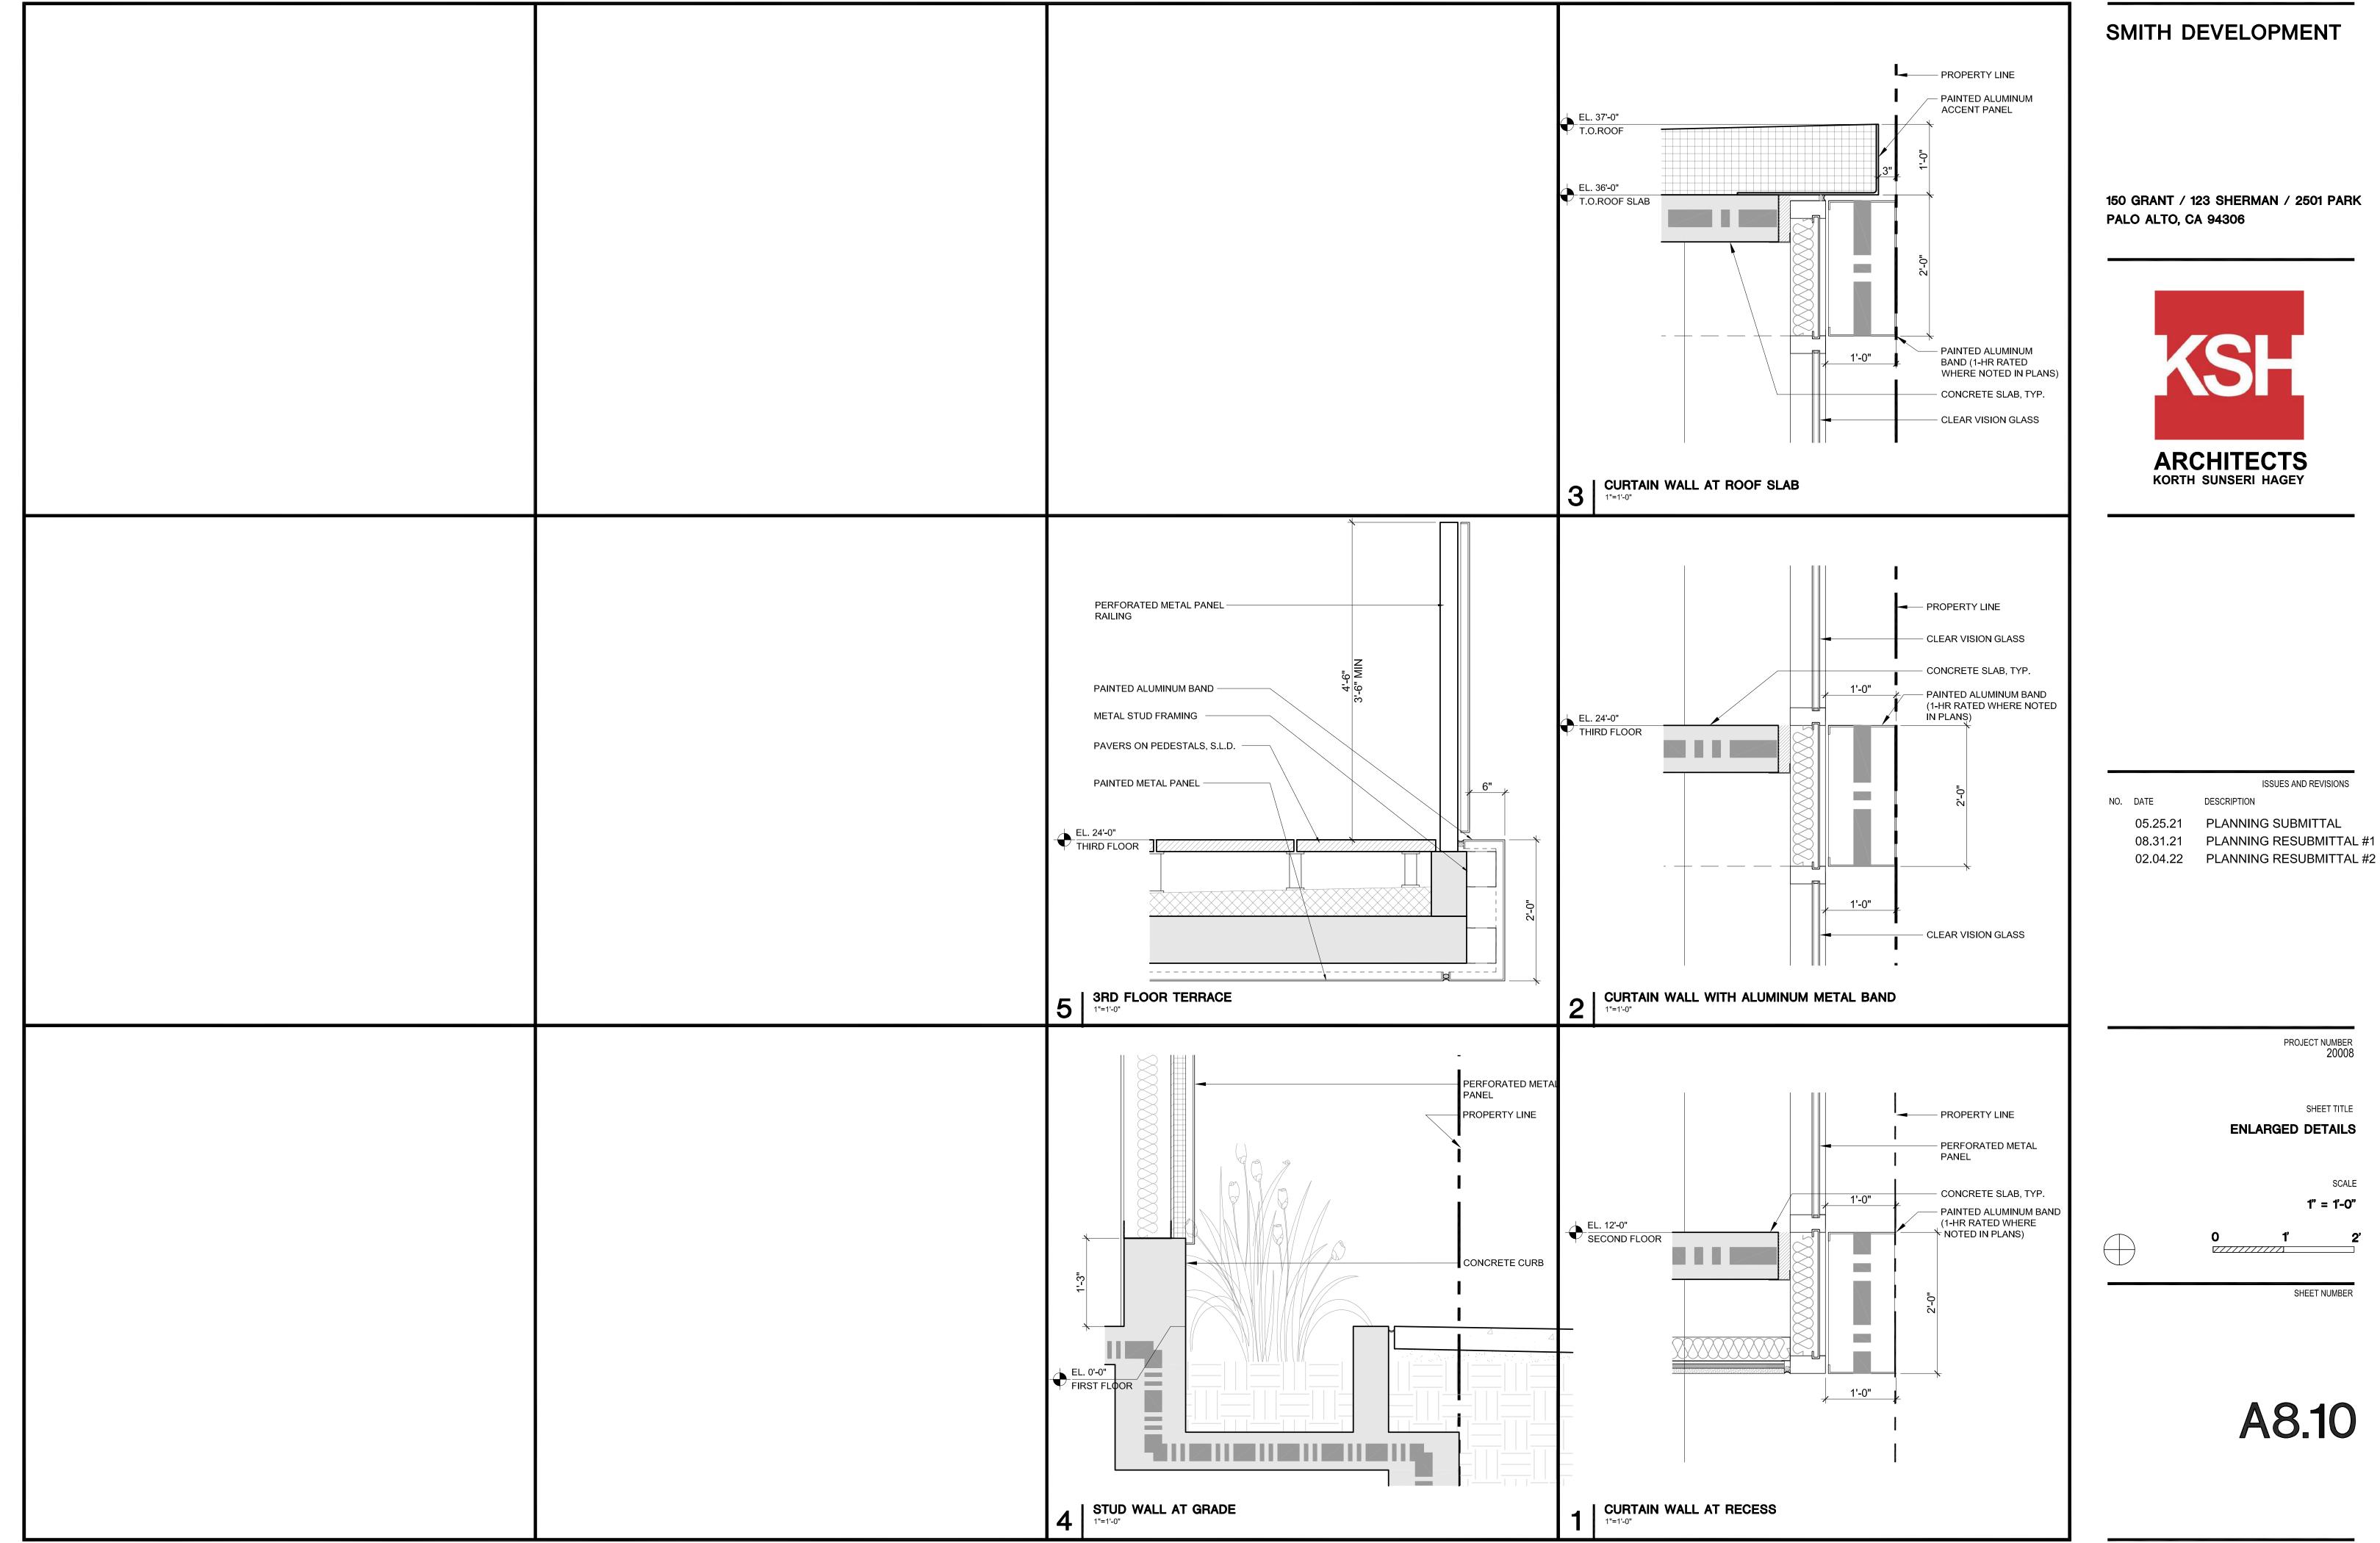


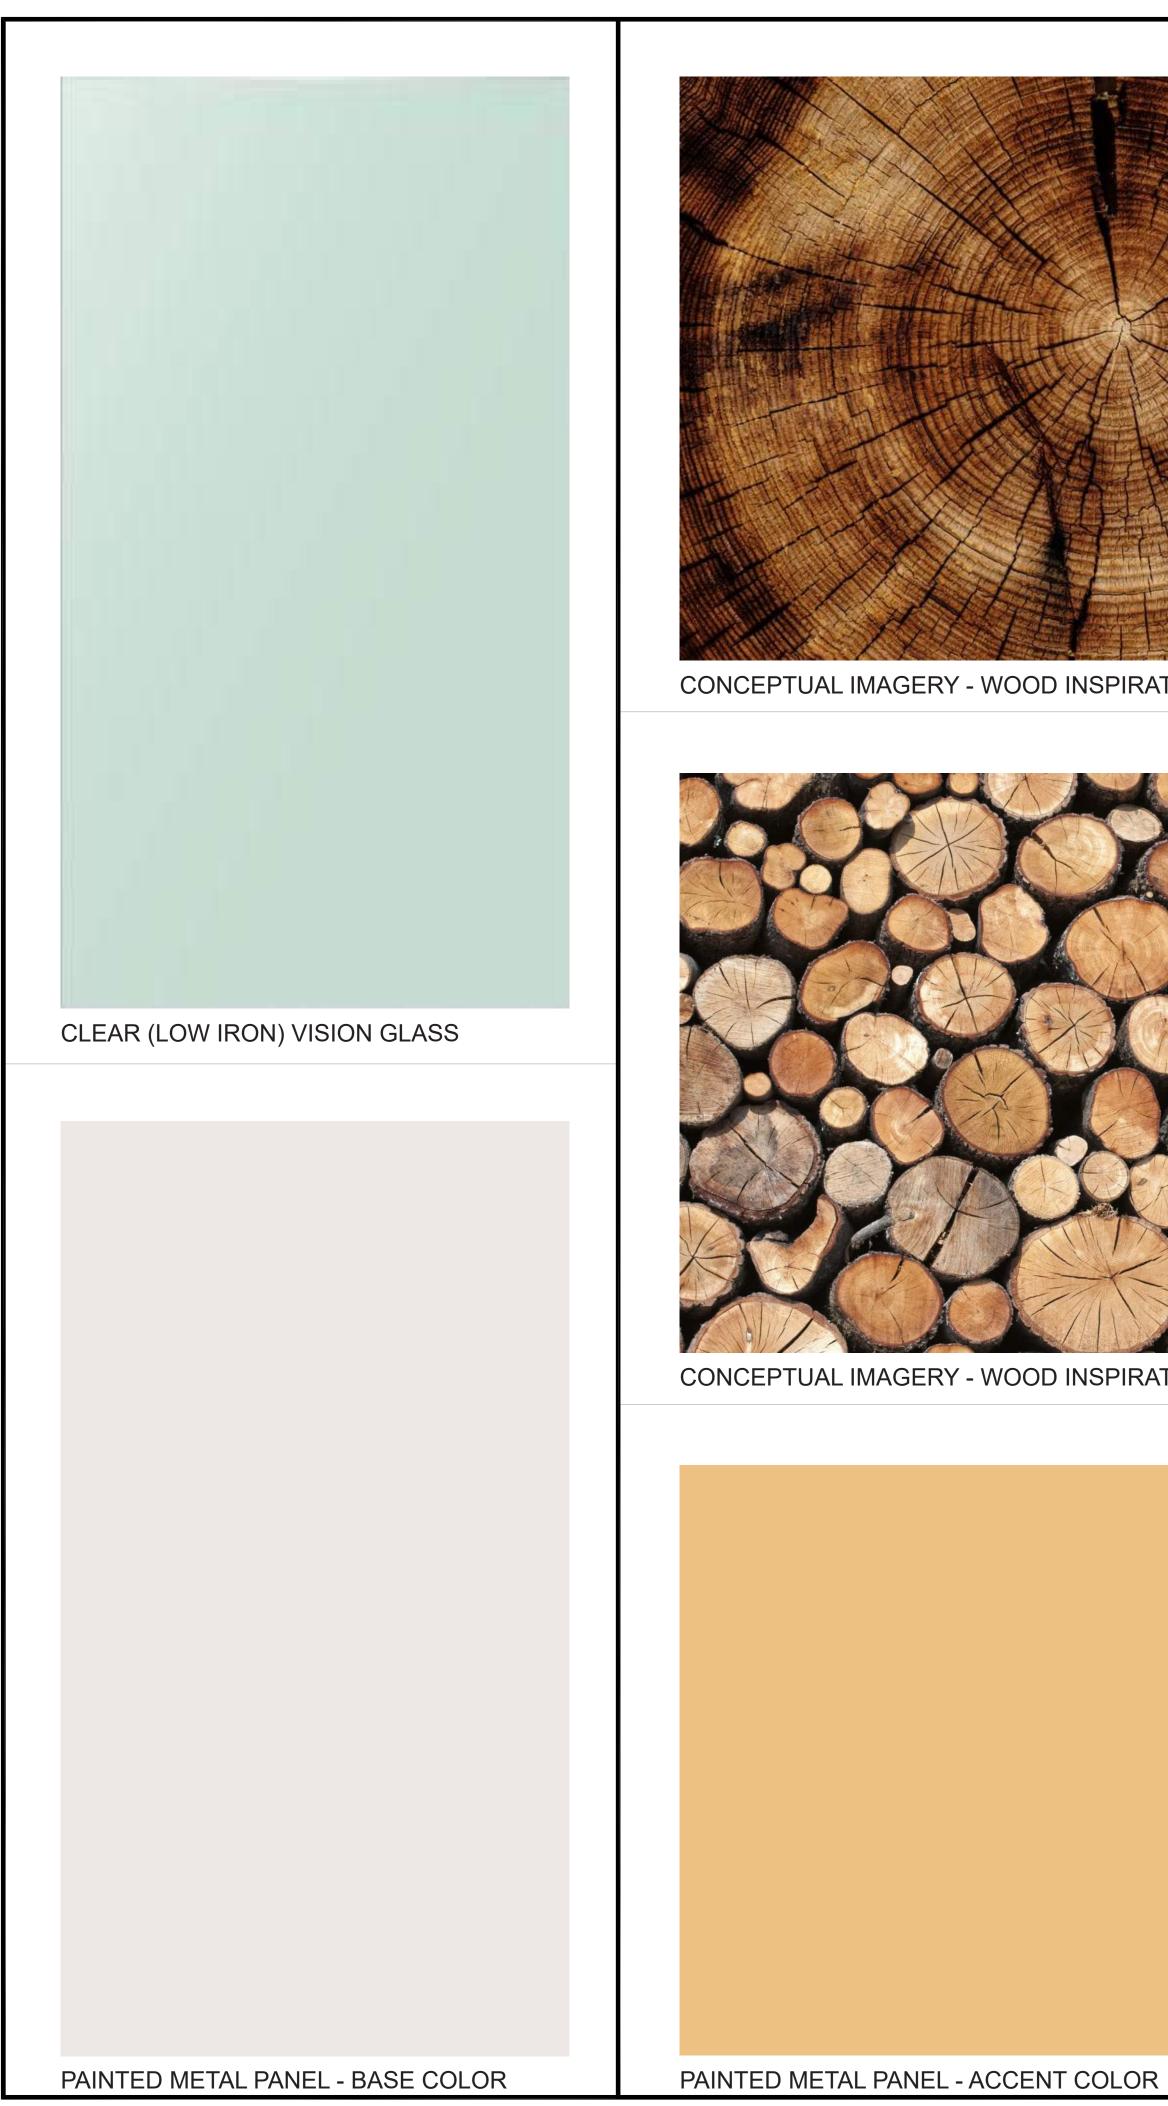






CONCEPTUAL IMAGERY - WOOD INSPIRATION

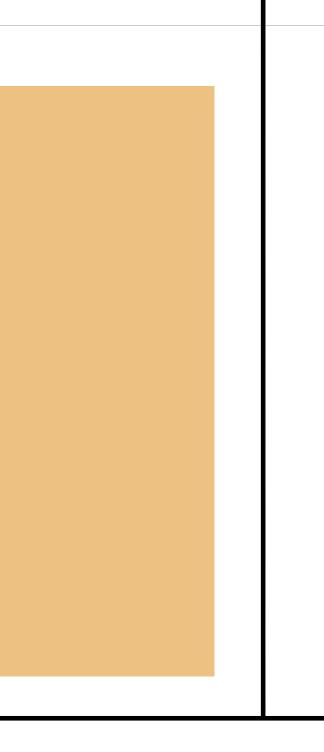



CONCEPTUAL IMAGERY - BOK MODERN STENCILED METAL PANELS

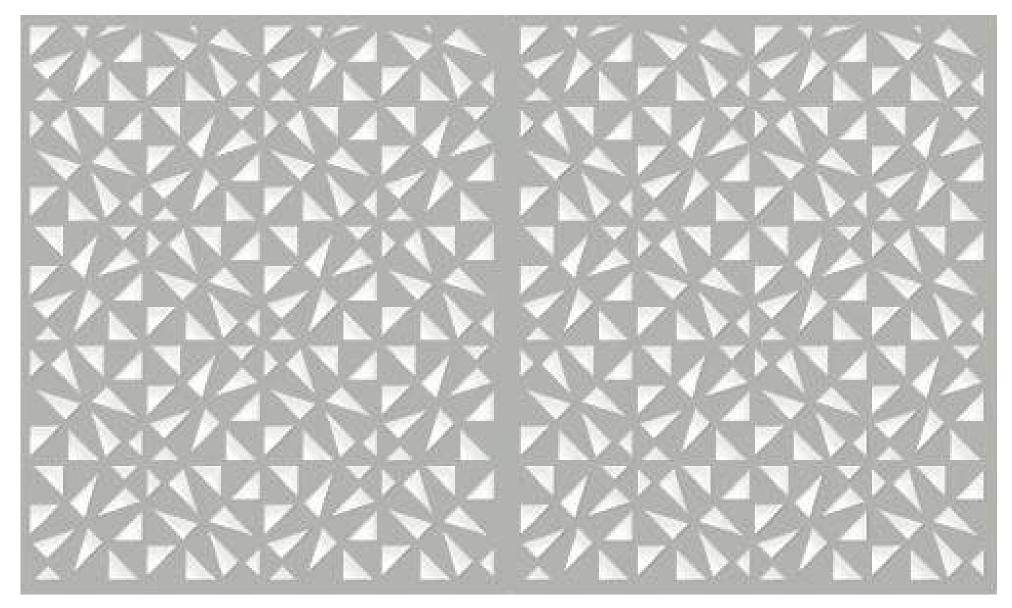

BOK MODERN STENCILED METAL PANEL - B10



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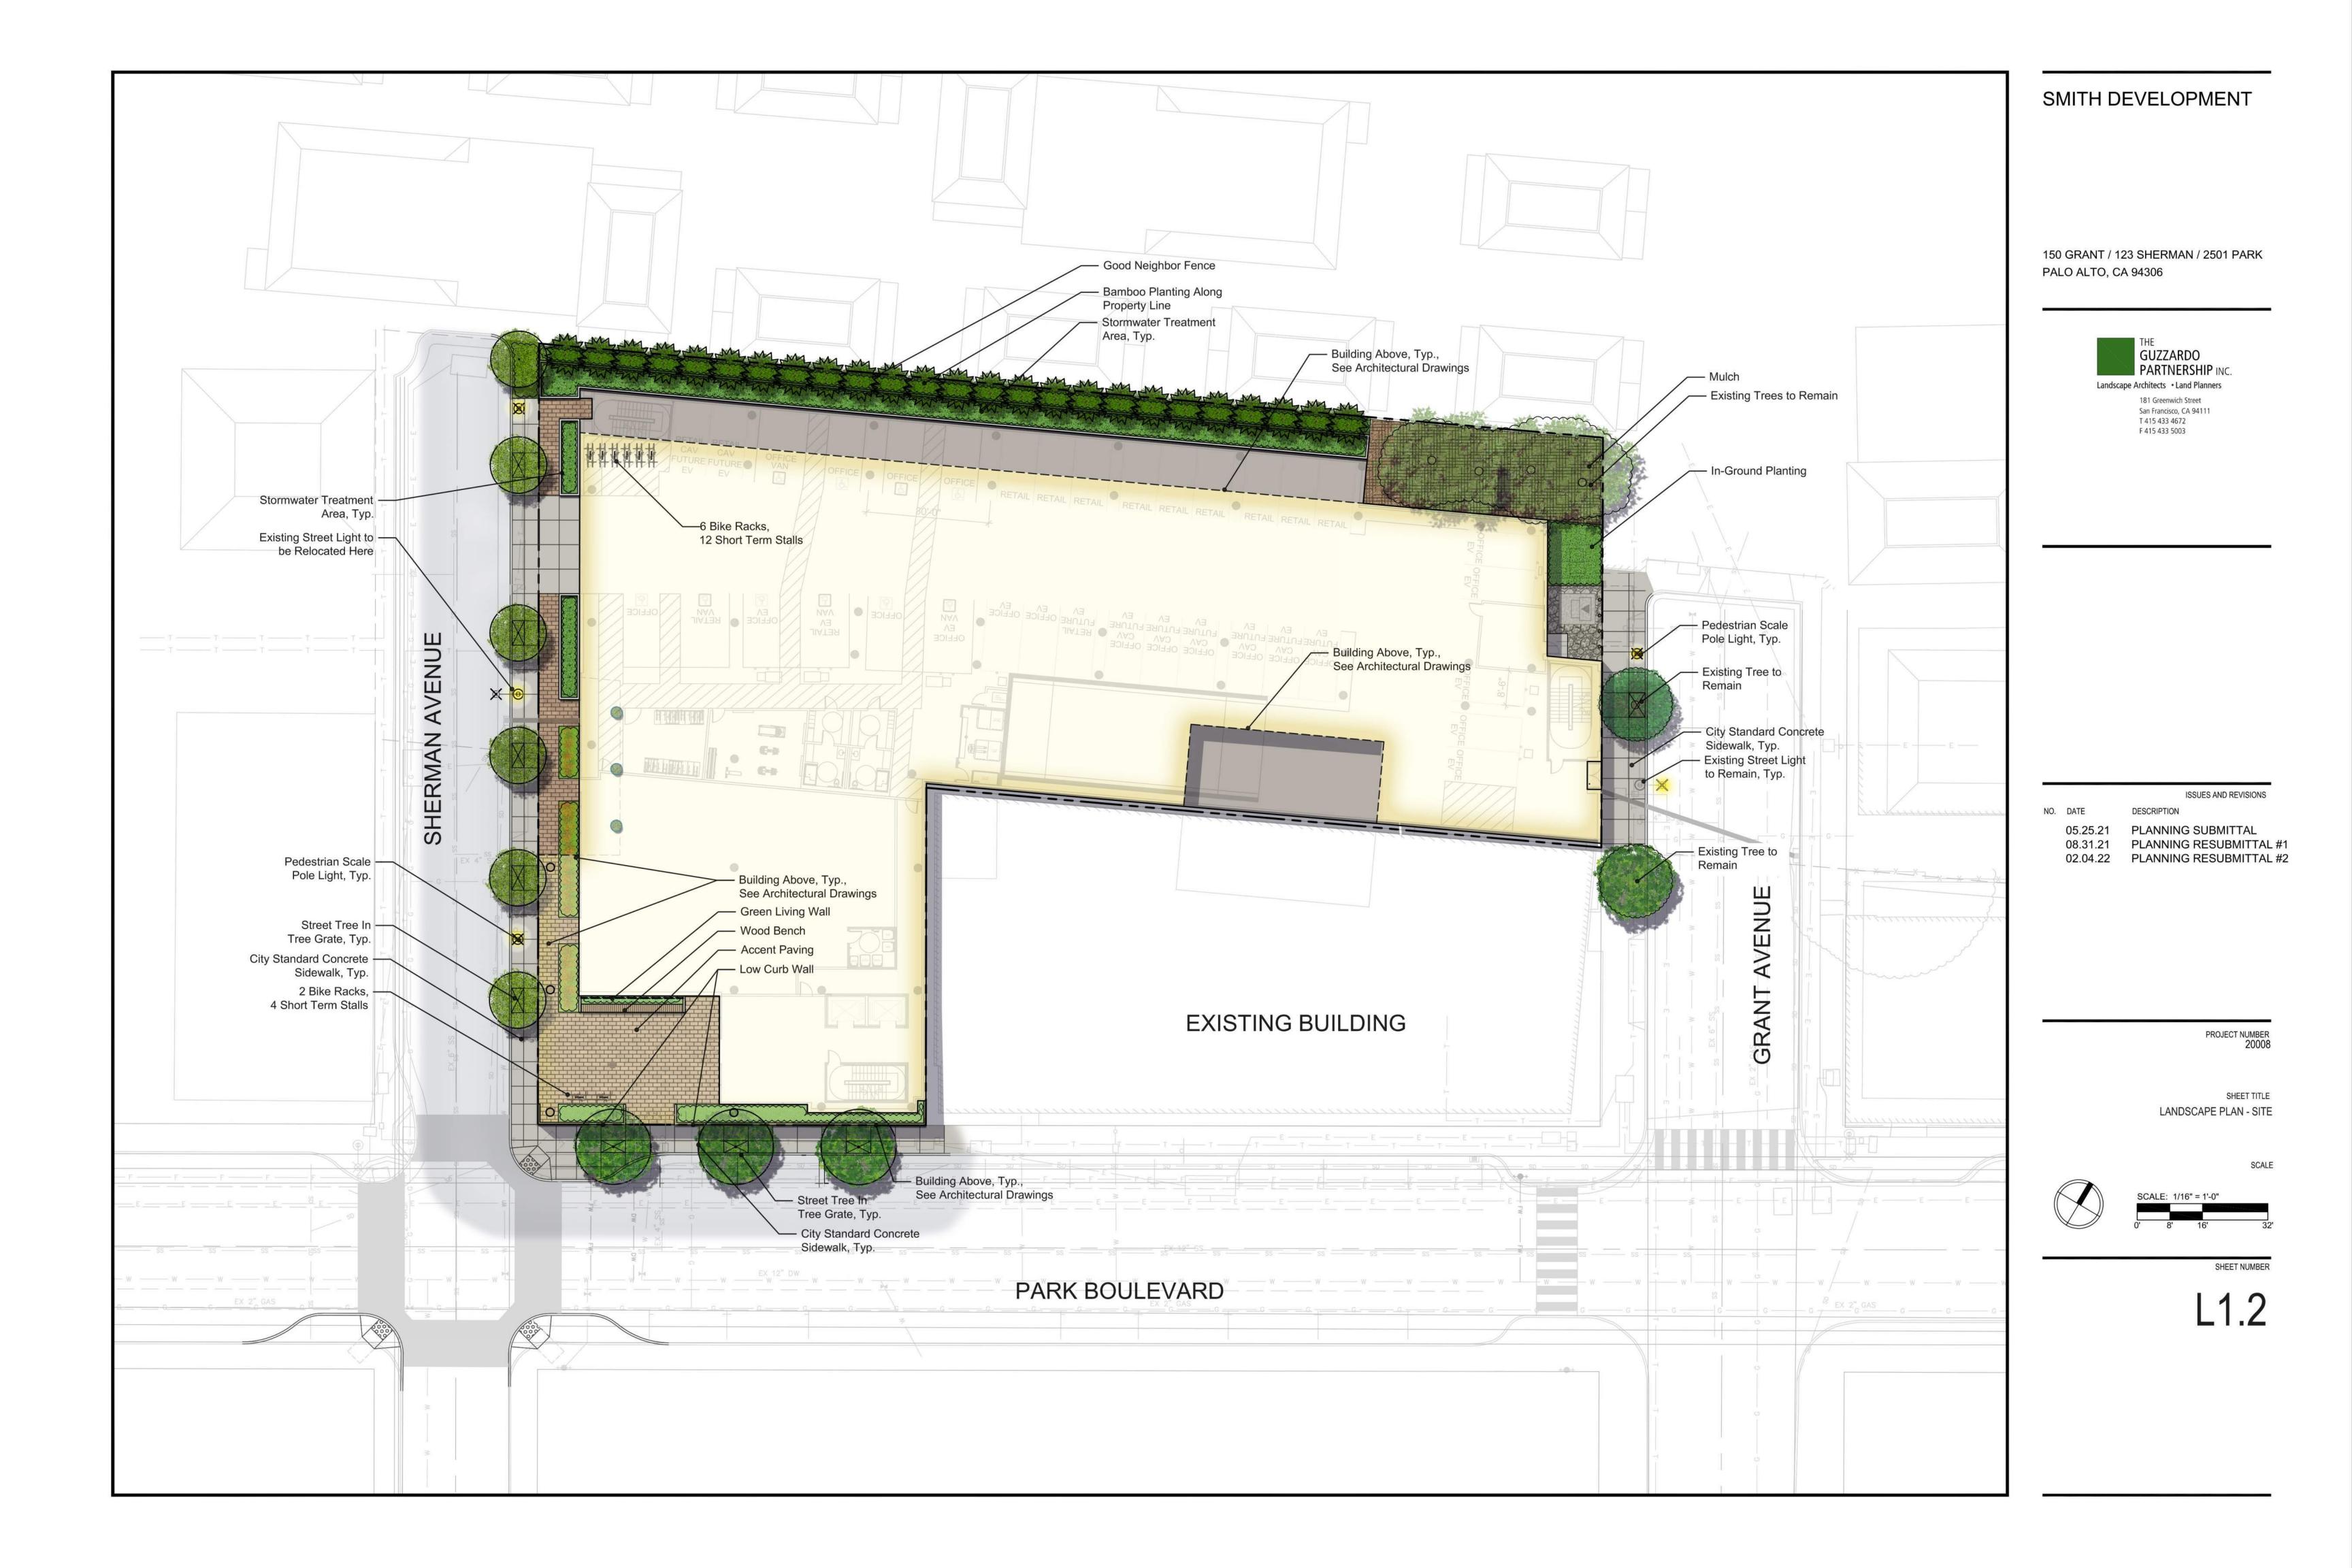
ISSUES AND REVISIONS


08.31.21 PLANNING RESUBMITTAL #1 02.04.22 PLANNING RESUBMITTAL #2

CONCEPTUAL MATERIALS

A10.1





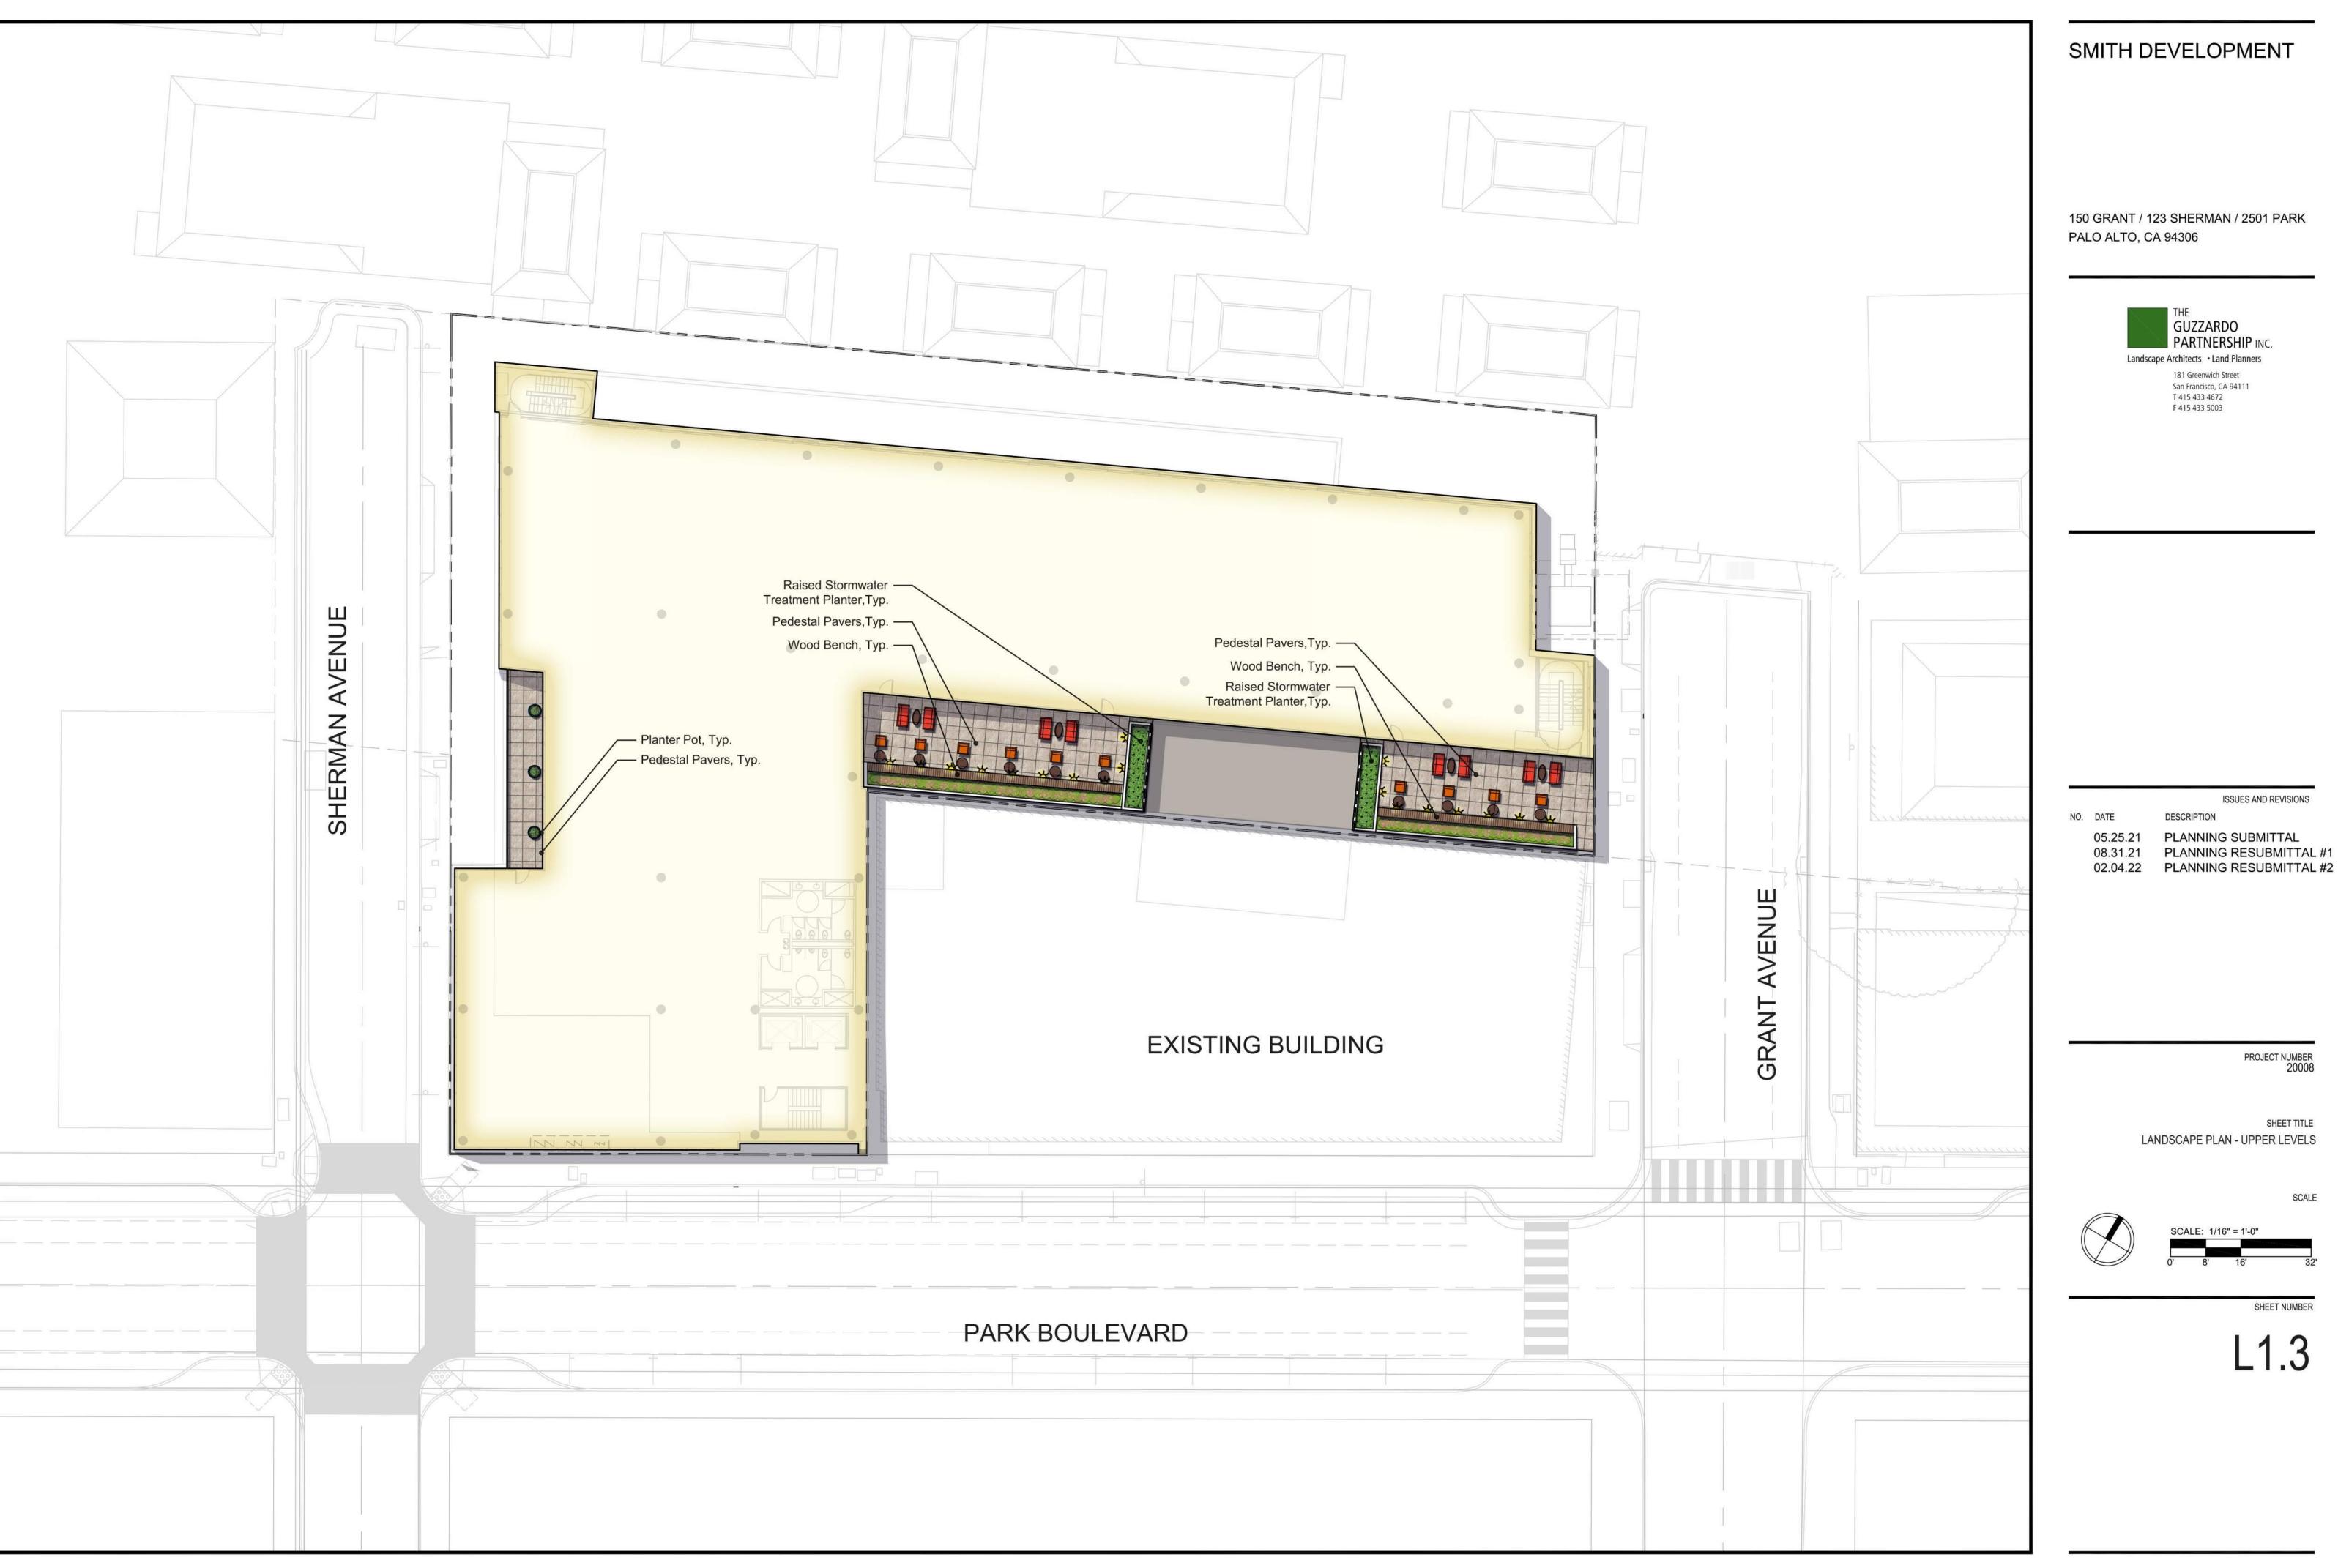


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ISSUES AND REVISIONS

PLANNING SUBMITTAL

LANDSCAPE PLAN - UPPER LEVELS



COLOR AND FINISH SCHEDULE

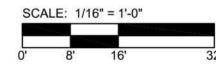PAVING PEDESTRIAN / VEHICULAR CONCRETE PAVING *All colors by Davis Colors, 800.356.4848, www.daviscolors.com Type 1 (Sidewalks, Pedestrian) Natural Grey concrete with light broom finish. Sweep perpendicular to path of travel. PEDESTRIAN ACCENT PAVING By: Acker-Stone, www.ackerstone.com; (T) 800.253.2353. Type 1: California Paver Size: 6cm thick, 6"x12", Color: Granada White w/ Large Slag FM, Pattern: Running Bond PEDESTRIAN ACCENT PAVING - ON STRUCTURE By: Acker-Stone, www.ackerstone.com; (T) 800.253.2353. Type 1: California Paver, Size: 6cm thick, 24"x24", Color: Israel Pewter FM, Pattern: Stacked Bond DECORATIVE GRAVEL Rounded 'Lin Creek' cobbles, 2"-3" diam. By Lyngso Garden Materials; www.lyngsogarden.com, (T) 650.364.1730. **FURNISHINGS** TREE GRATE Type 1 - STA Style Tree Grate, 36"x72", 1-1/2" Thick, 24" Tree Opening, by South Bay Foundry (www.southbayfoundry.com). Type 2 - STA Style Tree Grate, 48"x72", 1-1/2" Thick, 24" Tree Opening, by South Bay Foundry (www.southbayfoundry.com). **BIKE RACKS** Ride Bike Rack by Landscape Forms, Powdercoat, Surface Mount (www.landscapeforms.com) PLANTER POT By: Green-Form, www.green-form.com; (T) 310.331.1665. Model: Kyoto Low, Size: 28" dia., 18" height, Color: Gray WOOD BENCH LIGHTING FIXTURES



Pedestrian-scale Pole Light: BEGA 99878, 12' tall. See Electrical Drawings for locations and mounting requirements.



Wall Light: BEGA 33055, 12-1/2"x2-3/4". See Electrical Drawings.



Natural Gray Concrete




Pedestrian Accent Paving - Granada White



Pedestrian Accent Paving - Israel Pewter



Lin Creek Decorative Gravel

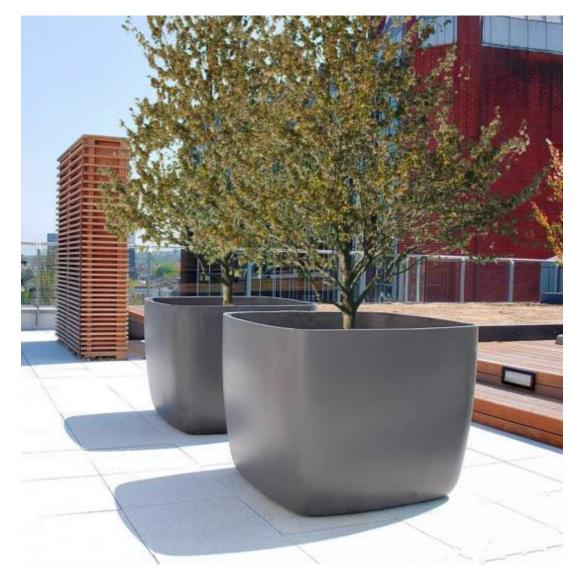


Planter Pots



Wood Top Seat Wall




Bike Rack

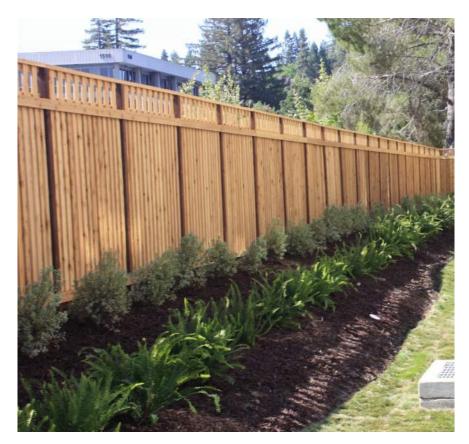

Good Neighbor Fence



Pedestrian Scale Pole Light

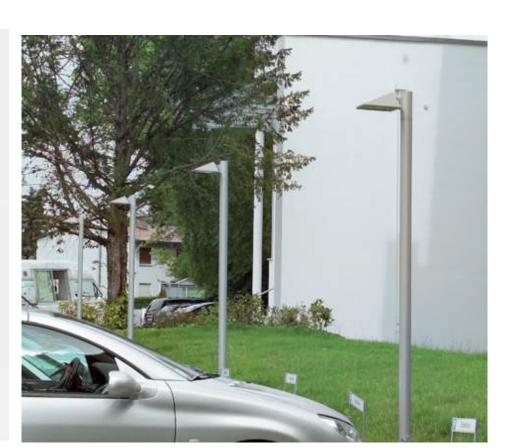

Wall Light

SMITH DEVELOPMENT

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F 415 433 5003


ISSUES AND REVISIONS

PLANNING SUBMITTAL PLANNING RESUBMITTAL #1 02.04.22 PLANNING RESUBMITTAL #2

DESCRIPTION


PROJECT NUMBER 20008

SHEET TITLE SITE AMENITIES, COLOR AND FINISH SCHEDULE

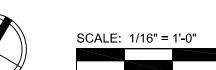



SHEET NUMBER

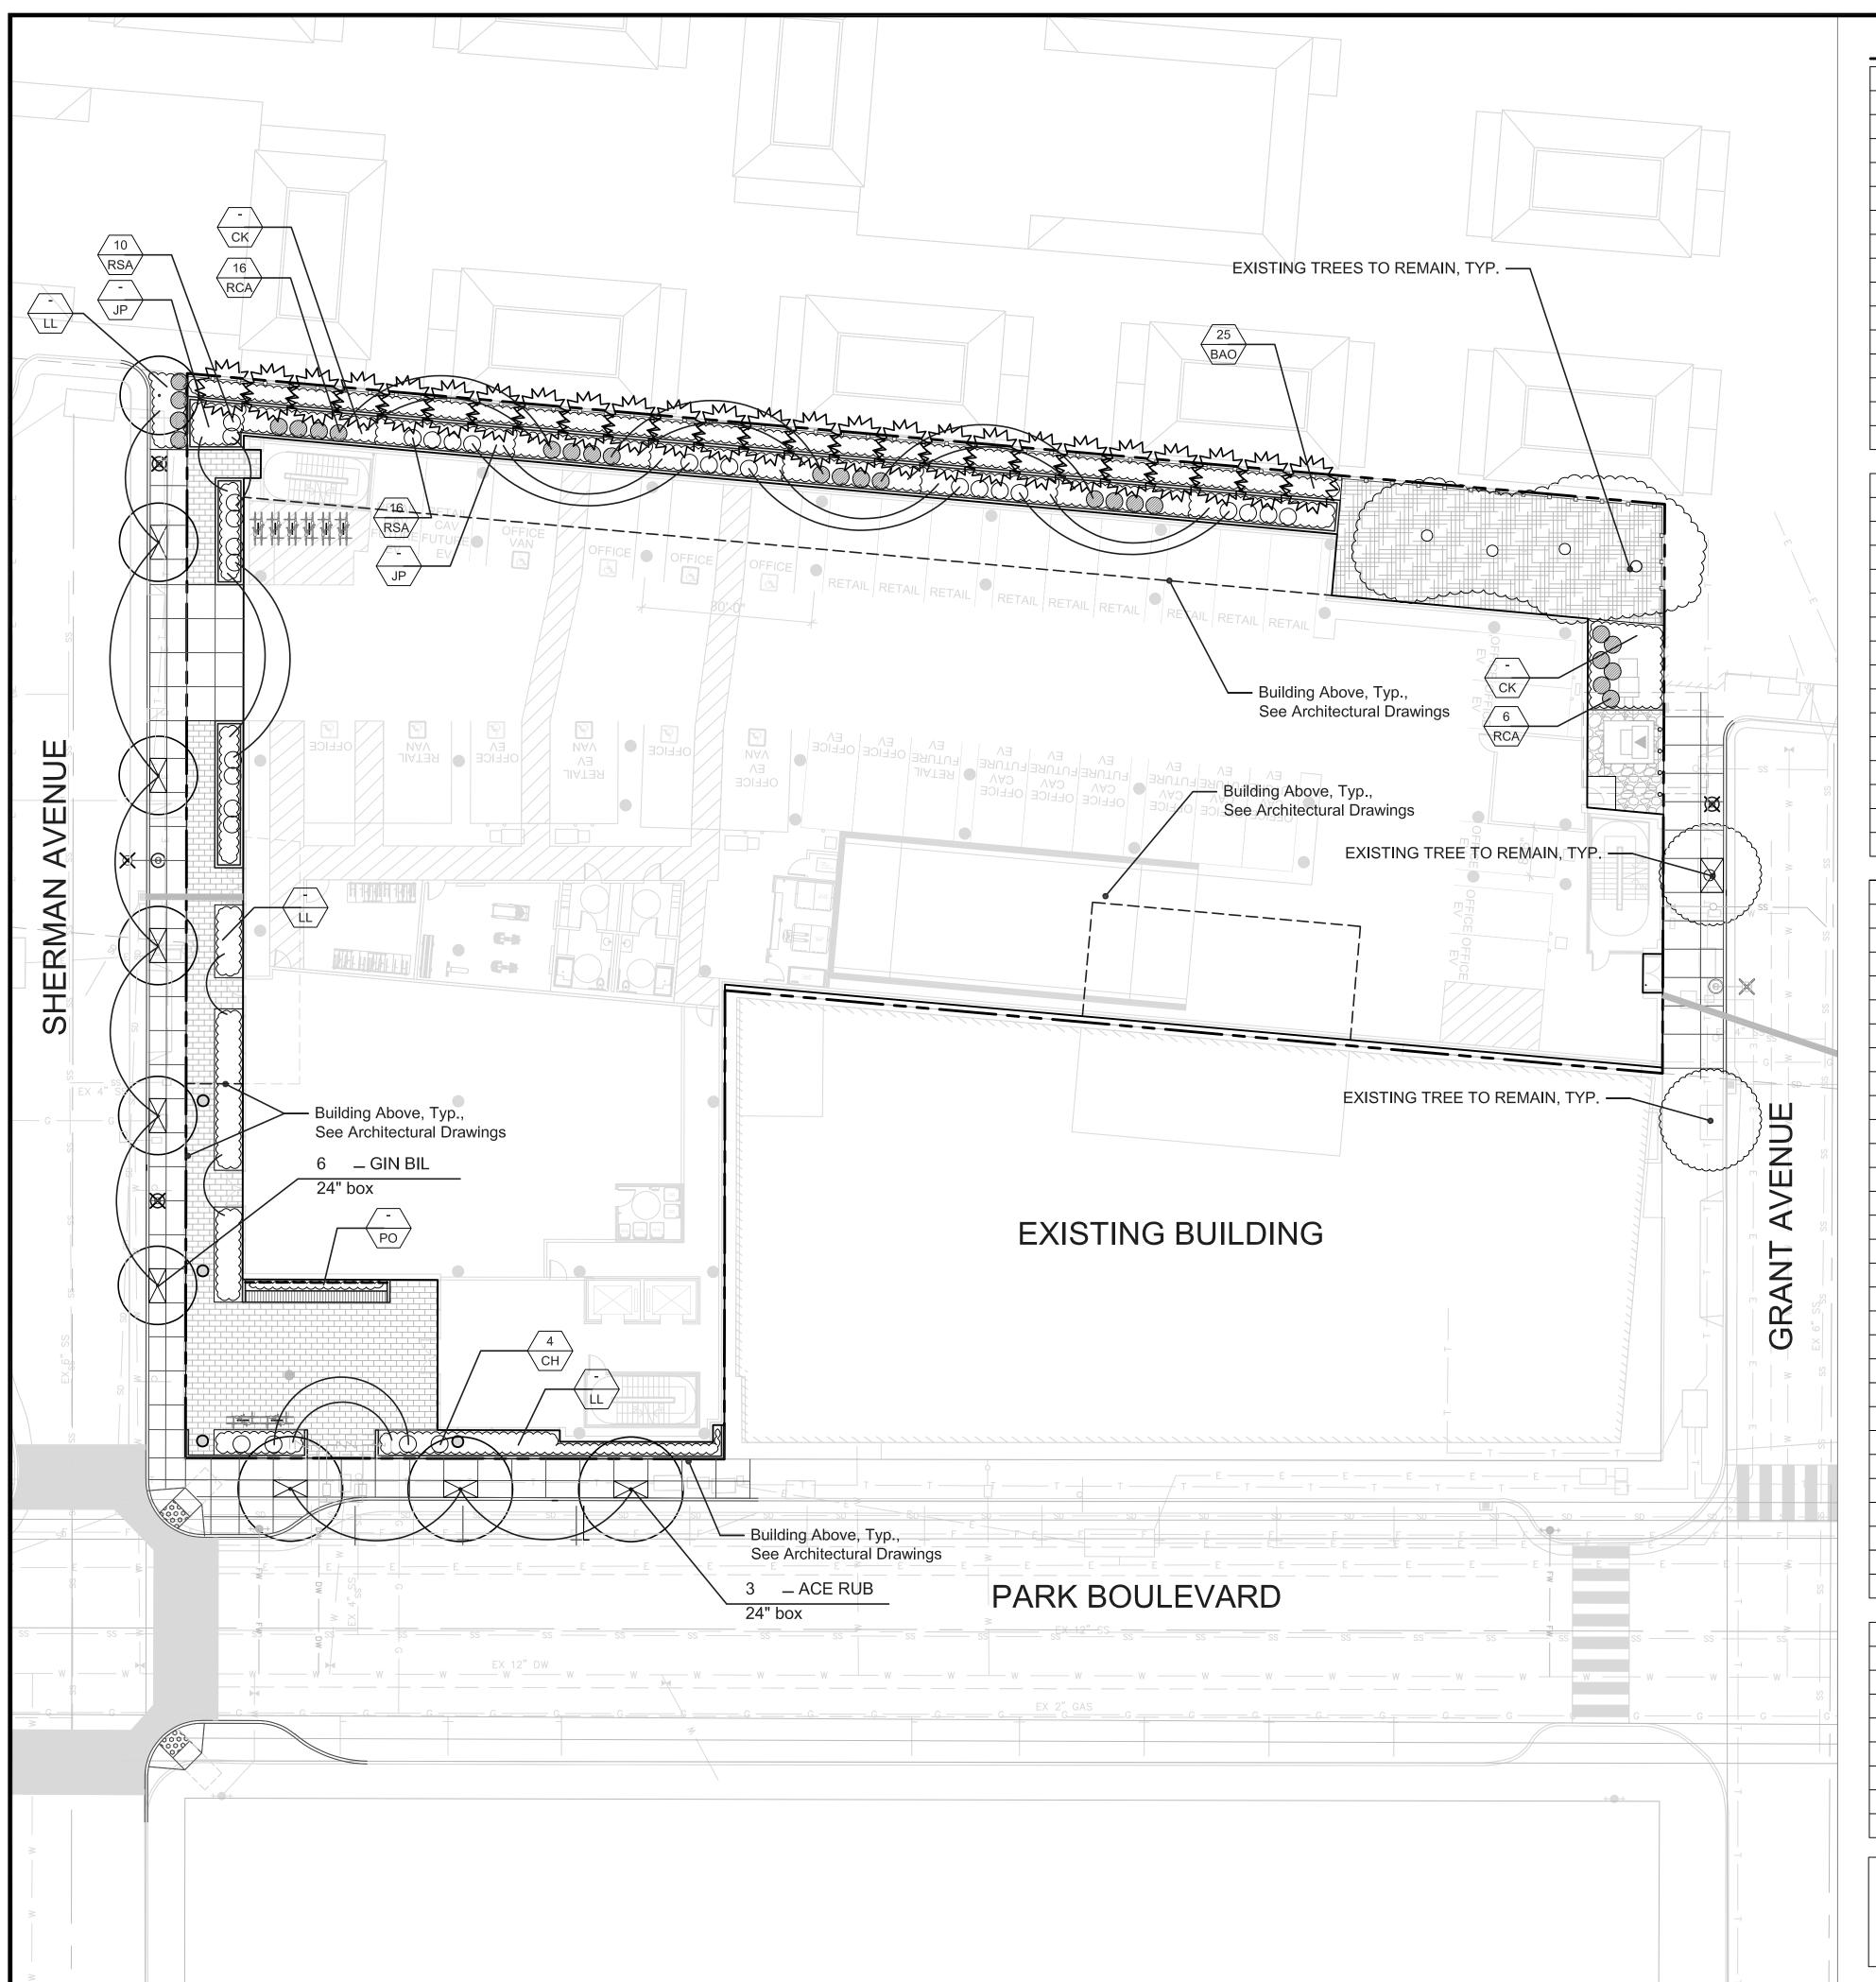

PLANT PALETTE

KEY	SIZE	BOTANICAL NAME	COMMON NAME	COMMENT	WUCOL	CA NATIVE
ACE RUB		Acer rubrum	Red Maple		M	
AES CAL^		Aesculus californica	California Buckeye		L	Υ
ARB MAR^		Arbutus 'Marina'	Marina Strawberry Tree		L	
CER OCC^		Cercis occidentalis	Western Redbud		L	Υ
CIT MEY		Citrus 'Improved Meyer'	Meyer Lemon		М	
GIN BIL		Ginkgo biloba 'Autumn Gold'	Autumn Gold Maidenhair Tree		M	
JAC MIM		Jacaranda mimosifolia	Jacaranda		М	
LAG MUS		Lagerstroemia 'Muskogee'	Crape Myrtle		L	
MAG GRA		Magnolia grandiflora 'Little Gem'	Little Gem Magnolia		M	
OLE EUR		Olea europea 'Swan Hill'	Swan Hill Olive		L	
PIS CHI		Pistachia chinensis	Chinese Pistachio		L	
QUE AGR^		Quercus agrifolia	Coast Live Oak		VL	Υ
QUE LOB^		Quercus lobata	Valley Oak		VL	Υ
TRI CON		Tristania conferta	Brisbane Box		L	

SHRUBS						
KEY	SIZE	BOTANICAL NAME	COMMON NAME	SPACING	WUCOL	CA NATIVE
BAM	5 gal	Bambusa multiplex 'Alphonse Karr'	Alphonse Karr Bamboo	36" o.c.	L	
BAO	25 gal	Bambusa oldhamii	Giant Timber Bamboo	See Plan	L	
CCO	5 gal	Ceanothus concha	California Mountain Lillac	48" o.c.	L	Υ
HXH	5 gal	Hypericum x 'Hidcote"	Gold Flower	36" o.c.	М	Υ
LAS	15 gal	Lavatera assurgentiflora	Tree Mallow	60" o.c.	L	Υ
LCH	5 gal	Loropetalum chinense	Chinese fringe flower	36" o.c.	L	
LEB	5 gal	Leucadendron 'Ebony'	Ebony Conebush	48" o.c.	L	
LJE	5 gal	Leucadendron 'Jester'	Jester Conebush	48" o.c.	L	
MRE	5 gal	Mahonia repens	Oregon Grape	48" o.c.	L	Υ
MCA	15 gal	Myrica californica	California Coffeeberry	60" o.c.	М	Υ
PRC	15 gal	Prunus caroliniana 'Bright & Tight'	Carolina Laurel Cherry	60" o.c.	L	
RSA	5 gal	Ribes sanguineum	Red Flowering Currant	30" o.c.	L	Υ
RCA	15 gal	Rhamunus californiaca 'Little Sur'	Little Sur Coffeeberry	48" o.c.	L	Υ
RIC	5 gal	Rhaphiolepis indica 'Clara'	Indian Hawthorn	24" o.c.	L	

KEY	SIZE	BOTANICAL NAME	COMMON NAME	SPACING	WUCOL	CA NATIVE
AG	1 gal	Achillea millefolium spp.	Yarrow spp	24" o.c.	L	Y
AD	5 gal	Agave 'desertii'	Desert Agave	30" o.c.	VL	Υ
AL	5 gal	Aloe plicata	Aloe plicata	24" o.c.	L	
AN	5 gal	Anigozanthos spp.	Kangaroo Paws	24" o.c.	L	
CG	1 gal	Calandrinia grandiflora 'Jazz Time'	Rock Purslane	24" o.c.	L	
CA	5 gal	Calamagrostis foliosa	Mendocino Reed Grass	36" o.c.	М	Υ
CK	5 gal	Calamagrostis x a. 'Karl Foerster'	Feather Reed Grass	36" o.c.	М	Υ
СН	5 gal	Chondropetalum tectorum	Cape Reed	36" o.c.	L	
DI	5 gal	Dietes vegeta / hybrids	Fortnight Lily / Lemon Drops	30" o.c.	L	
EC	1 gal	Elymus condensatus 'Canyon Prince'	Lyme Grass	30" o.c.	VL	Υ
HU	2 gal	Heuchera spp.	Coral Bells	24" o.c.	М	Υ
HP	5 gal	Hesperaloe parviflora	Red Yucca	36" o.c.	VL	
JP	5 gal	Juncus patens	California Gray Rush	24" o.c.	L	Υ
LD	5 gal	Lavandula dentata	French Lavander	24" o.c.	L	
LP	1 gal	Libertia p. 'Bronze Sword"	Libertia	24" o.c.	L	
LL	5 gal	Lomandra longifolia 'Platinum Beauty'	Variegated Dwarf Mat Rush	24" o.c.	L	
MA	5 gal	Mahonia 'soft caress'	Soft Caress Holly	30" o.c.	М	
MU	5 gal	Muhlenbergia c. 'Regal Mist'	R. Mist Pink Muhlenbergia	42" o.c.	L	
MR	5 gal	Muhlenbergia rigens	Deer Grass	42" o.c.	L	Υ
MS	5 gal	Mimulus 'Sam'	Yellow Monkeyflower	24" o.c.	L	
NE	1 gal	Nephrolepis cordifolia	Southern Sword Fern	24" o.c.	М	Υ
OE	15 gal	Olea europaea 'Montra'	Little Ollie Dwarf Olive	30 o.c.	L	Υ
PE	5 gal	Pennisetum s. 'Rubrum'	Purple Fountain Grass	36" o.c.	L	
РО	5 gal	Polystichum munitum	Western Sword Fern	24" o.c.	L	Υ
SI	1 gal	Sisyrinchium bellum	Blue-eyed Grass	18" o.c.	L	Υ
SG	5 gal	Salvia greggii	Autumn Sage	30" o.c.	L	Υ
ST	5 gal	Stipa arundinacea	New Zealand Wind Grass	18" o.c.	L	
ZC	5 gal	Zauscheneria California 'Ghostly Red'	California Fuschia 'Ghostly Red'	18" o.c.	L	Υ

GROUND	COVERS					
	· ·	- 	CONTRACNINIANT	CDACING	MILICOL	CA
KEY	SIZE	BOTANICAL NAME	COMMON NAME	SPACING	WUCOL	NATIVE
AE	5 gal	Arctostaphyllos 'Emerald Carpet'	Manzanita	36" o.c.	L	Y
AC	5 gal	Acacia cognata 'Cousin Itt'	Little River Wattle	30" o.c.	L	
FE	1 gal	Festuca Rubra	Red Fescue	18" o.c.	L	Υ
МН	5 gal	Mahonia repens	Creeping Oregon Grape	24" o.c.	L	Υ
RP	5 gal	Rosmarinus o. 'Prostratus'	Prostrate Rosemary	24" o.c.	L	
RI	1 gal	Ribes viburnifolium	Catalina Currant	48" o.c.	L	Υ
SM	1 gal	Senecio mandraliscae	Blue Chalk Sticks	12" o.c.	L	

Note: Tree Planting. Prior to in-ground installation, Urban Forestry inspection / approval required for tree stock, planting conditions and irrigation adequacy. Contact (650-496-5953).

Irrigation and tree planting in the right-of-way requires a street work permit per CPA Public Works standards.

Note: Native plant species are used for 52% of the total planting area. (1,722 SF of 3,299 SF total).

SMITH DEVELOPMENT

150 GRANT / 123 SHERMAN / 2501 PARK PALO ALTO, CA 94306



ISSUES AND REVISIONS

DATE DESCRIPTION


05.25.21 PLANNING SUBMITTAL 08.31.21 PLANNING RESUBMITTAL #1 02.04.22 PLANNING RESUBMITTAL #2

PROJECT NUMBER 20008

SHEET TITLE
PLANTING PLAN - SITE


SCA



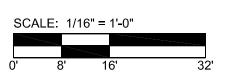

SHEET NUMBE

L3.1

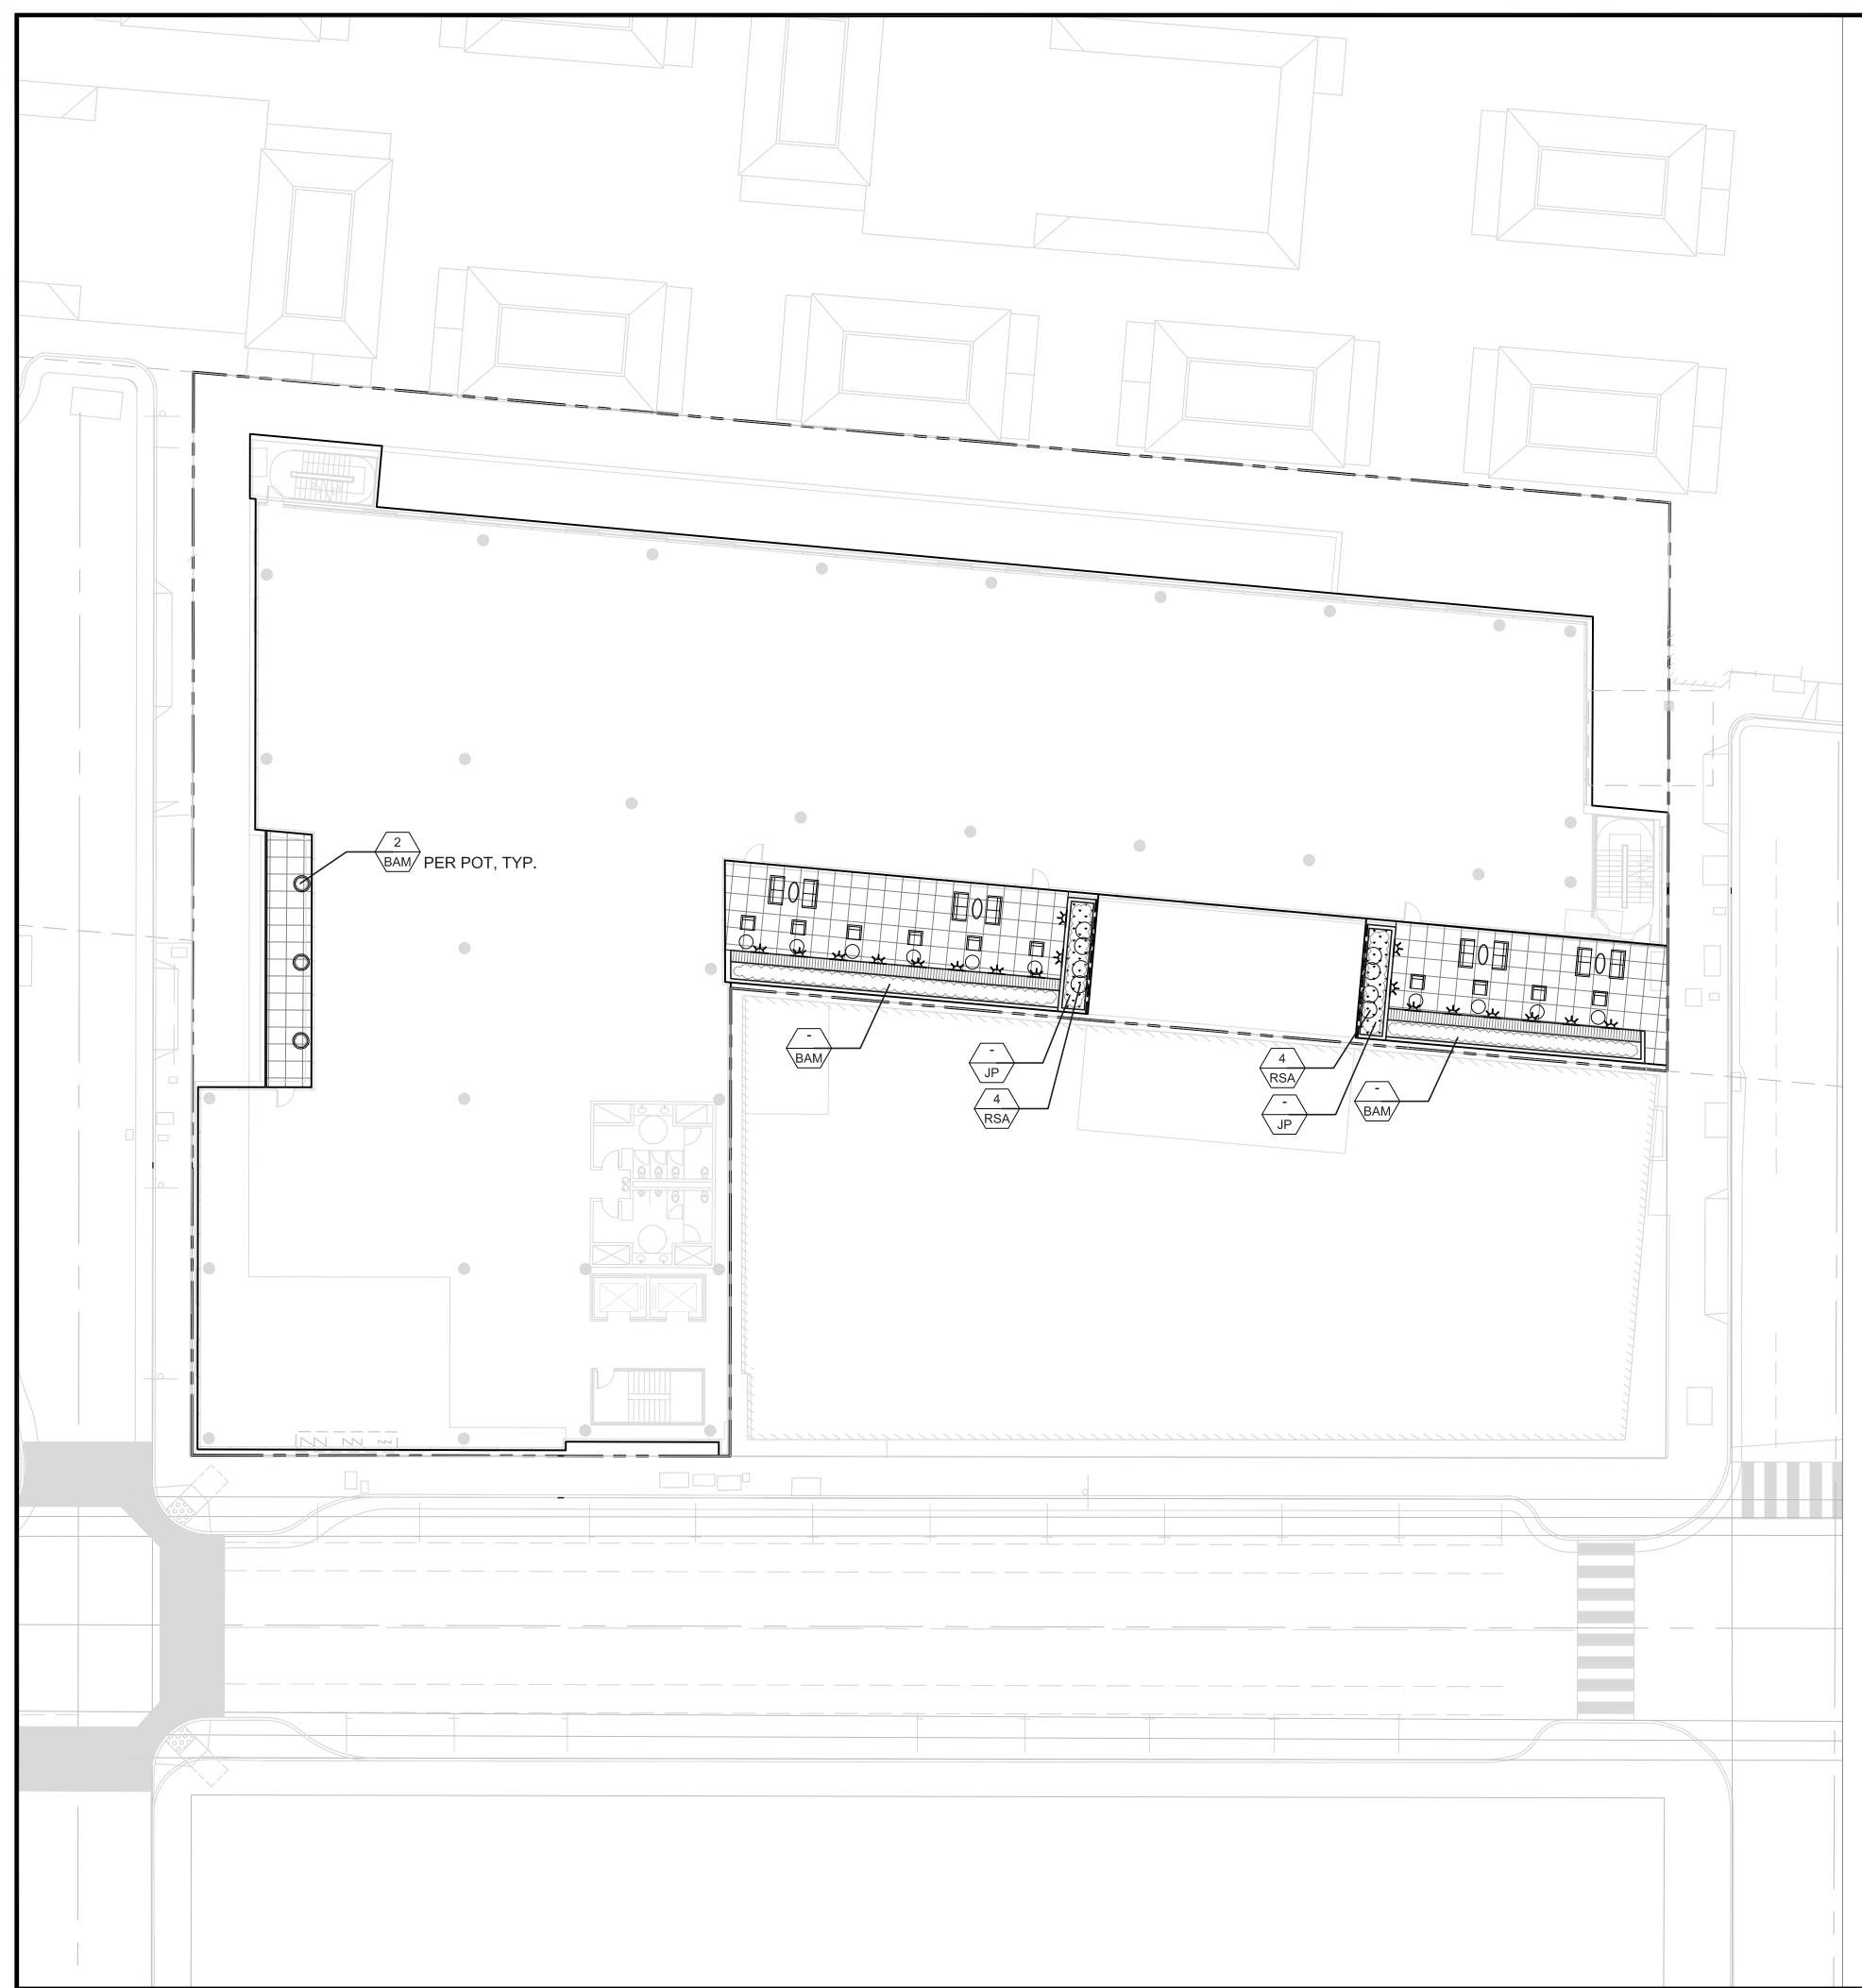

PLANT PALETTE

TREES	^ 36"	Box Standards Unless Noted Otherv	vise on Plans	_		
KEY	SIZE	BOTANICAL NAME	COMMON NAME	COMMENT	WUCOL	CA NATIVE
ACE RUB		Acer rubrum	Red Maple		М	
AES CAL [^]		Aesculus californica	California Buckeye		L	Υ
ARB MAR^		Arbutus 'Marina'	Marina Strawberry Tree		L	
CER OCC^		Cercis occidentalis	Western Redbud		L	Υ
CIT MEY		Citrus 'Improved Meyer'	Meyer Lemon		М	
GIN BIL		Ginkgo biloba 'Autumn Gold'	Autumn Gold Maidenhair Tree		М	
JAC MIM		Jacaranda mimosifolia	Jacaranda		М	
LAG MUS		Lagerstroemia 'Muskogee'	Crape Myrtle		L	
MAG GRA		Magnolia grandiflora 'Little Gem'	Little Gem Magnolia		М	
OLE EUR		Olea europea 'Swan Hill'	Swan Hill Olive		L	
PIS CHI		Pistachia chinensis	Chinese Pistachio		L	
QUE AGR^		Quercus agrifolia	Coast Live Oak		VL	Υ
QUE LOB^		Quercus Iobata	Valley Oak		VL	Υ
TRI CON		Tristania conferta	Brisbane Box		L	

KEY	SIZE	BOTANICAL NAME	COMMON NAME	SPACING	WUCOL	CA NATIVE
					1	NATIVE
BAM	5 gal	Bambusa multiplex 'Alphonse Karr'	Alphonse Karr Bamboo	36" o.c.	L	
BAO	25 gal	Bambusa oldhamii	Giant Timber Bamboo	See Plan	L	
CCO	5 gal	Ceanothus concha	California Mountain Lillac	48" o.c.	L	Υ
HXH	5 gal	Hypericum x 'Hidcote"	Gold Flower	36" o.c.	М	Υ
LAS	15 gal	Lavatera assurgentiflora	Tree Mallow	60" o.c.	L	Υ
LCH	5 gal	Loropetalum chinense	Chinese fringe flower	36" o.c.	L	
LEB	5 gal	Leucadendron 'Ebony'	Ebony Conebush	48" o.c.	L	
LJE	5 gal	Leucadendron 'Jester'	Jester Conebush	48" o.c.	L	
MRE	5 gal	Mahonia repens	Oregon Grape	48" o.c.	L	Υ
MCA	15 gal	Myrica californica	California Coffeeberry	60" o.c.	М	Υ
PRC	15 gal	Prunus caroliniana 'Bright & Tight'	Carolina Laurel Cherry	60" o.c.	L	
RSA	5 gal	Ribes sanguineum	Red Flowering Currant	30" o.c.	L	Υ
RCA	15 gal	Rhamunus californiaca 'Little Sur'	Little Sur Coffeeberry	48" o.c.	L	Υ
RIC	5 gal	Rhaphiolepis indica 'Clara'	Indian Hawthorn	24" o.c.	L	

KEY	SIZE	BOTANICAL NAME	COMMON NAME	SPACING	WUCOL	CA NATIVE
AG	1 gal	Achillea millefolium spp.	Yarrow spp	24" o.c.	L	Υ
AD	5 gal	Agave 'desertii'	Desert Agave	30" o.c.	VL	Υ
AL	5 gal	Aloe plicata	Aloe plicata	24" o.c.	L	
AN	5 gal	Anigozanthos spp.	Kangaroo Paws	24" o.c.	L	
CG	1 gal	Calandrinia grandiflora 'Jazz Time'	Rock Purslane	24" o.c.	L	
CA	5 gal	Calamagrostis foliosa	Mendocino Reed Grass	36" o.c.	М	Υ
CK	5 gal	Calamagrostis x a. 'Karl Foerster'	Feather Reed Grass	36" o.c.	М	Υ
СН	5 gal	Chondropetalum tectorum	Cape Reed	36" o.c.	L	
DI	5 gal	Dietes vegeta / hybrids	Fortnight Lily / Lemon Drops	30" o.c.	L	
EC	1 gal	Elymus condensatus 'Canyon Prince'	Lyme Grass	30" o.c.	VL	Υ
HU	2 gal	Heuchera spp.	Coral Bells	24" o.c.	М	Υ
HP	5 gal	Hesperaloe parviflora	Red Yucca	36" o.c.	VL	
JP	5 gal	Juncus patens	California Gray Rush	24" o.c.	L	Υ
LD	5 gal	Lavandula dentata	French Lavander	24" o.c.	L	
LP	1 gal	Libertia p. 'Bronze Sword"	Libertia	24" o.c.	L	
LL	5 gal	Lomandra longifolia 'Platinum Beauty'	Variegated Dwarf Mat Rush	24" o.c.	L	
MA	5 gal	Mahonia 'soft caress'	Soft Caress Holly	30" o.c.	М	
MU	5 gal	Muhlenbergia c. 'Regal Mist'	R. Mist Pink Muhlenbergia	42" o.c.	L	
MR	5 gal	Muhlenbergia rigens	Deer Grass	42" o.c.	L	Υ
MS	5 gal	Mimulus 'Sam'	Yellow Monkeyflower	24" o.c.	L	
NE	1 gal	Nephrolepis cordifolia	Southern Sword Fern	24" o.c.	М	Υ
OE	15 gal	Olea europaea 'Montra'	Little Ollie Dwarf Olive	30 o.c.	L	Υ
PE	5 gal	Pennisetum s. 'Rubrum'	Purple Fountain Grass	36" o.c.	L	
РО	5 gal	Polystichum munitum	Western Sword Fern	24" o.c.	L	Υ
SI	1 gal	Sisyrinchium bellum	Blue-eyed Grass	18" o.c.	L	Υ
SG	5 gal	Salvia greggii	Autumn Sage	30" o.c.	L	Υ
ST	5 gal	Stipa arundinacea	New Zealand Wind Grass	18" o.c.	L	
ZC	5 gal	Zauscheneria California 'Ghostly Red'	California Fuschia 'Ghostly Red'	18" o.c.	L	Υ

GROUND	GROUNDCOVERS								
KEY	SIZE	BOTANICAL NAME	COMMON NAME	SPACING	WUCOL	CA NATIVE			
4 Ε	5 gal	Arctostaphyllos 'Emerald Carpet'	Manzanita	36" o.c.	L	Υ			
4C	5 gal	Acacia cognata 'Cousin Itt'	Little River Wattle	30" o.c.	L				
Ē	1 gal	Festuca Rubra	Red Fescue	18" o.c.	L	Υ			
ΜΗ	5 gal	Mahonia repens	Creeping Oregon Grape	24" o.c.	L	Υ			
RP	5 gal	Rosmarinus o. 'Prostratus'	Prostrate Rosemary	24" o.c.	L				
રા	1 gal	Ribes viburnifolium	Catalina Currant	48" o.c.	L	Υ			
SM	1 gal	Senecio mandraliscae	Blue Chalk Sticks	12" o.c.	L				

Note: Native plant species are used for 52% of the total planting area. (1,722 SF of 3,299 SF total).

SMITH DEVELOPMENT

150 GRANT / 123 SHERMAN / 2501 PARK PALO ALTO, CA 94306



ISSUES AND REVISIONS


D. DATE DESCRIPTION

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PROJECT NUMBE 2000


SHEET TITLE
PLANTING PLAN - UPPER LEVELS

SCALE

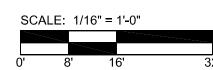

SHEET NUMBE

L3.2

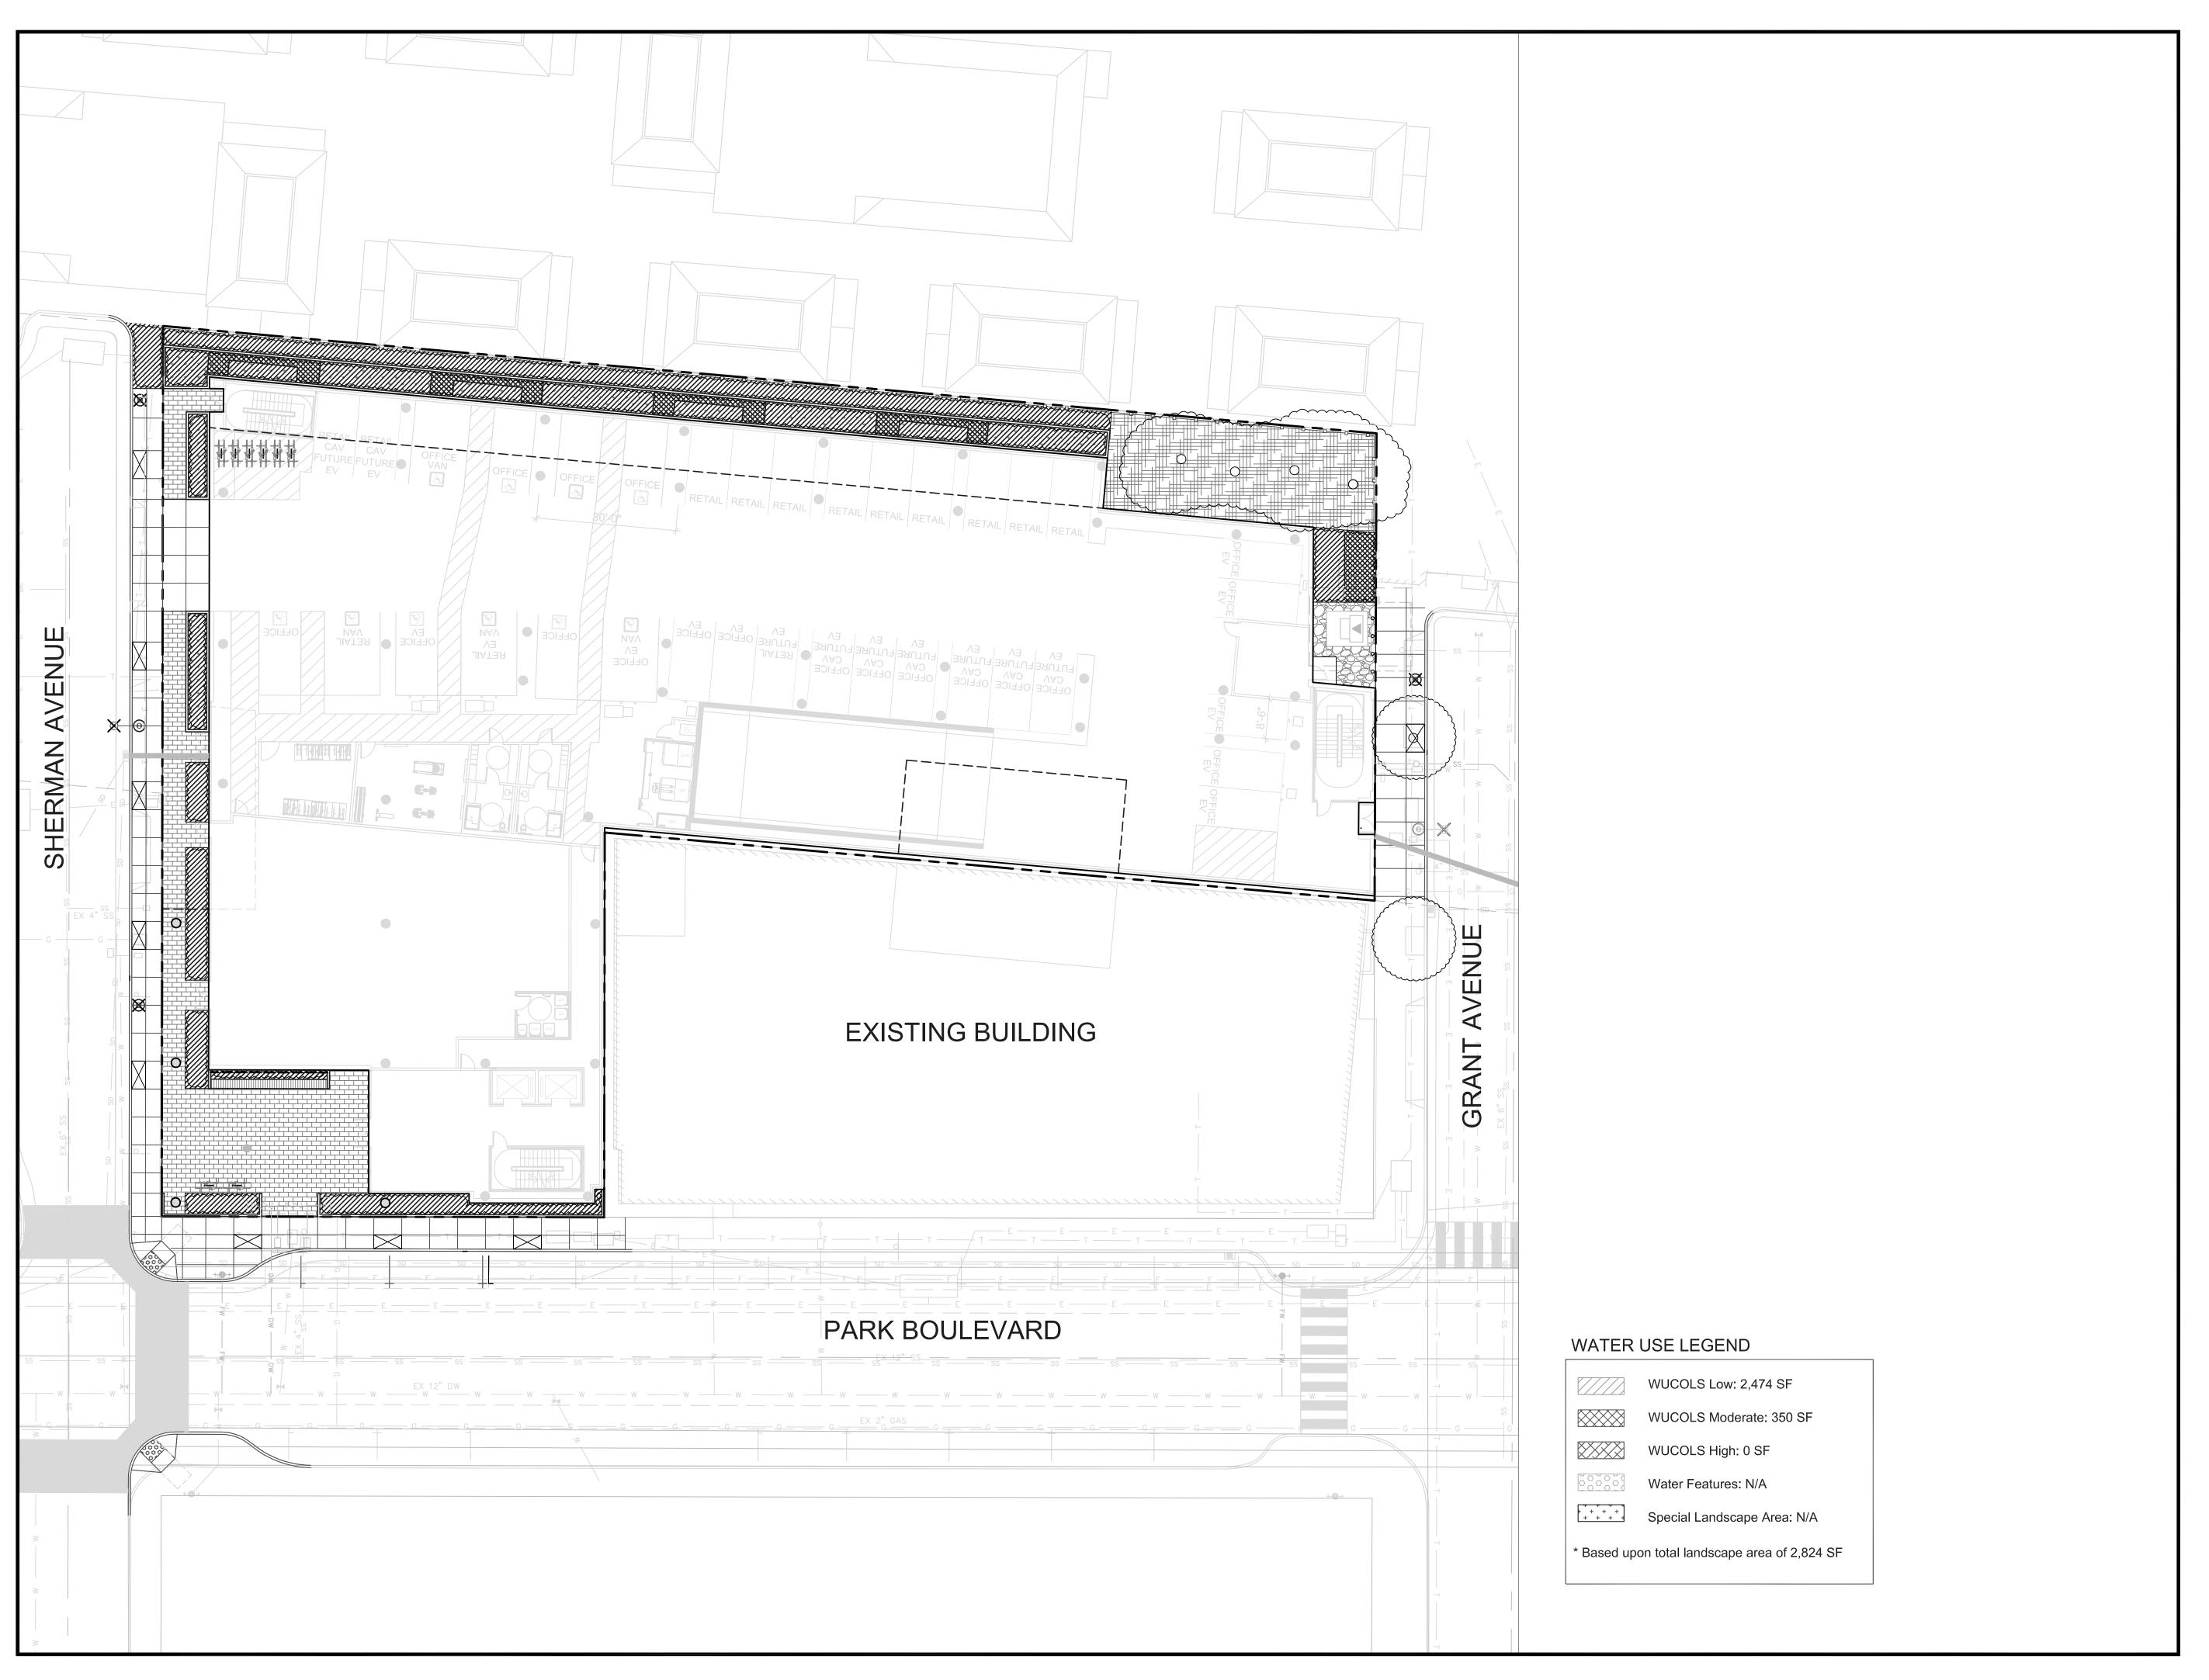

150 GRANT / 123 SHERMAN / 2501 PARK PALO ALTO, CA 94306



ISSUES AND REVISIONS

DATE DESCRIPTION

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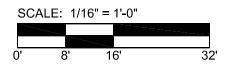
1 PLANNING RESUBMITTAL #1 2 PLANNING RESUBMITTAL #2

> PROJECT NUMI 20

SHEET TITLE
HYDROZONE PLAN - SITE


SCALE





SHEET NUMBE

L4.1

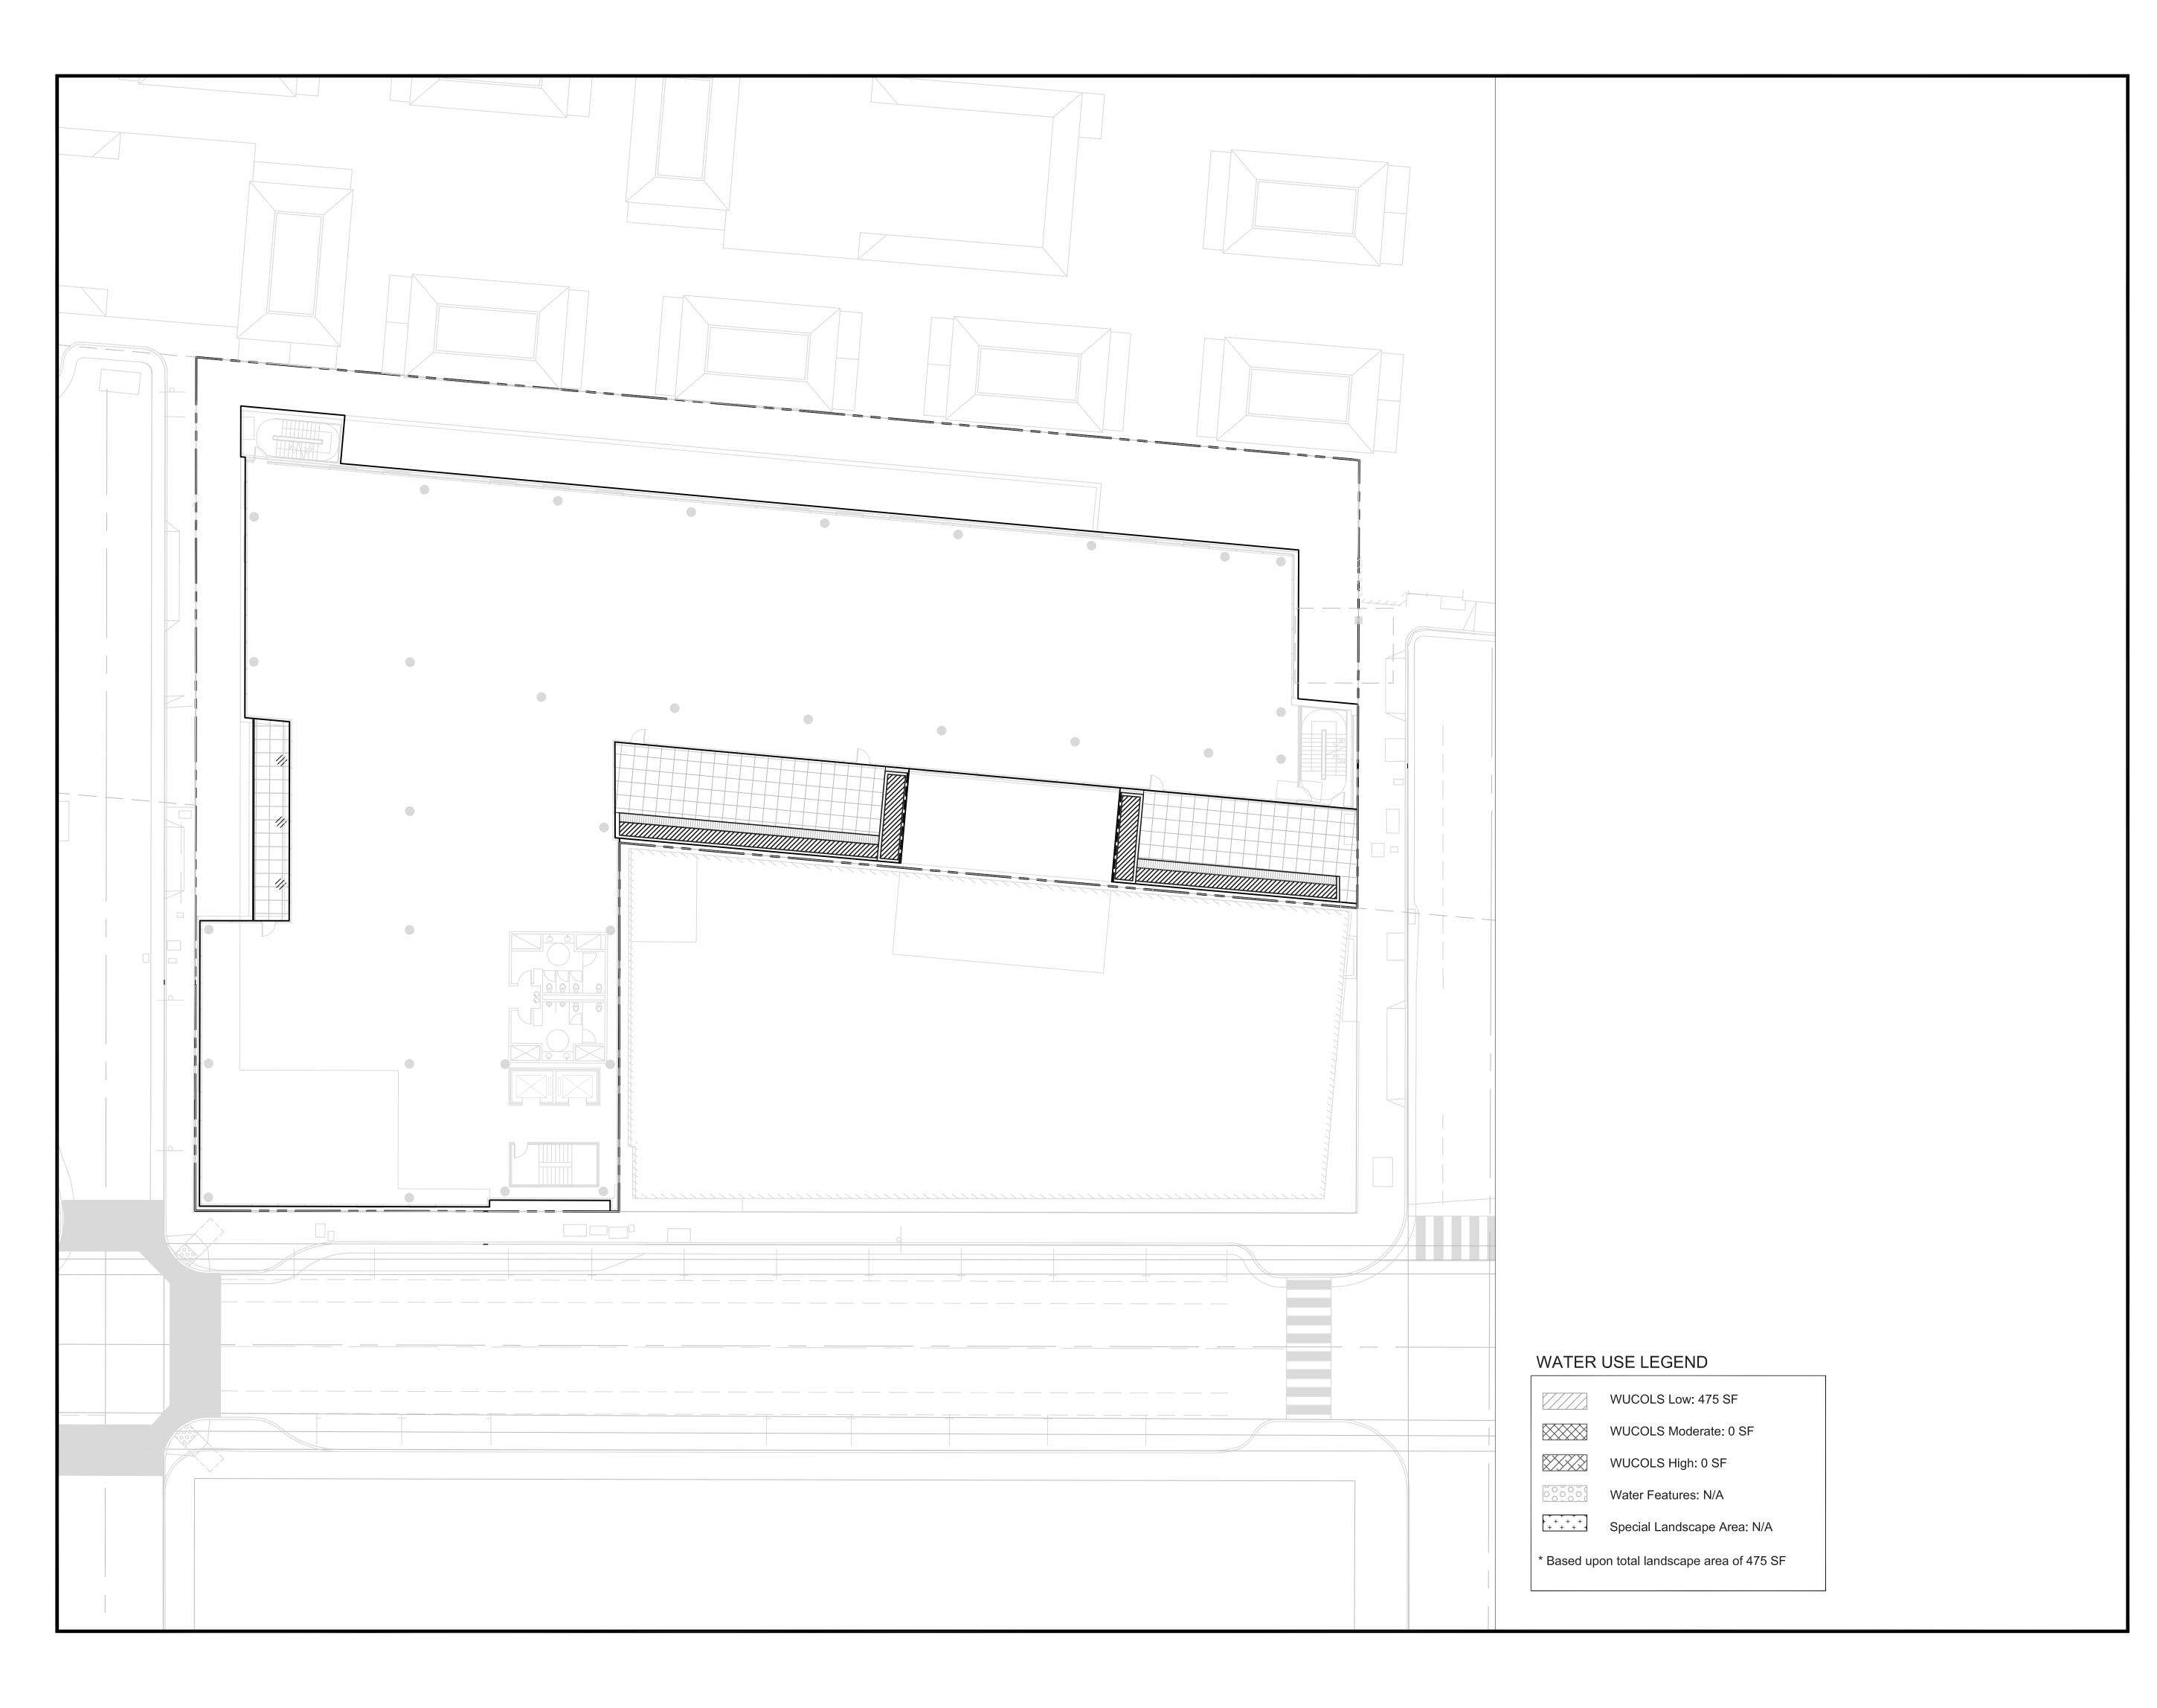

150 GRANT / 123 SHERMAN / 2501 PARK PALO ALTO, CA 94306



ISSUES AND REVISIONS

NO. DATE DESCRIPTION


05.25.21 PLANNING SUBMITTAL 08.31.21 PLANNING RESUBMITTAL #1 02.04.22 PLANNING RESUBMITTAL #2

PROJECT NUM

SHEET TITLE
HYDROZONE PLAN - UPPER LEVELS

SCA



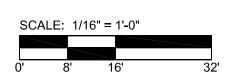

SHEET NUMBE


L4.2


City of Palo Alto


Tree Protection - It's Part of the Plan!

Make sure your crews and subs do the job right!

Fenced enclosures around trees are essential to protect them by keeping the foliage canopy and branching structure clear from contact by equipment, materials and activities, preserving roots and soil conditions in an intact and non-compacted state, and identifying the Tree Protection Zone (TPZ) in which no soil disturbance is permitted and activities are restricted, unless otherwise approved. An approved tree protection report must be added to this sheet when project activity occurs within the TPZ of a regulated tree. For detailed information on Palo Alto's regulated trees and protection during development, review the City Tree Technical Manual (TTM) found at www.cityofpaloalto.org/trees/.

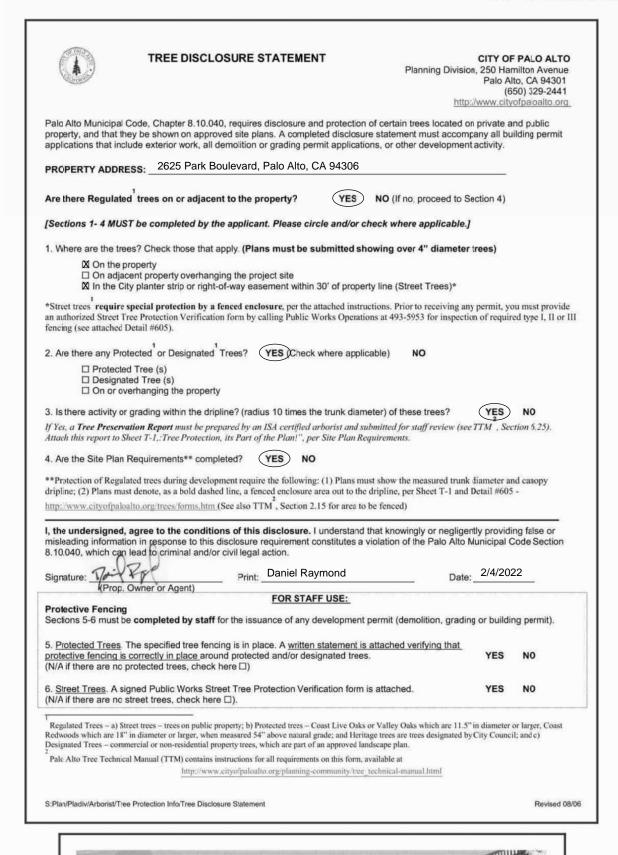

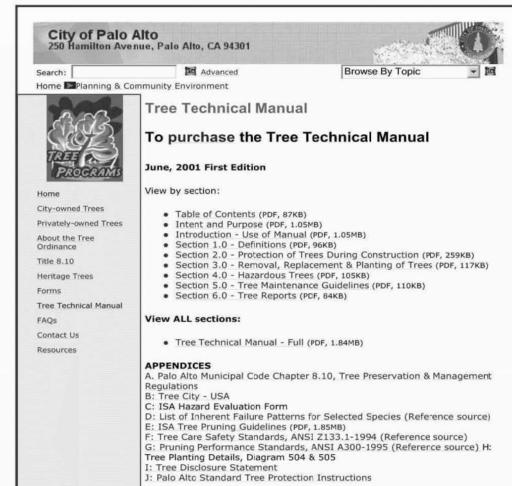

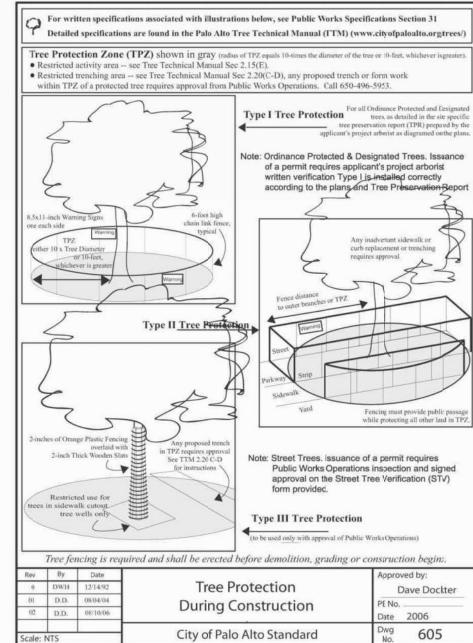

10.	*	PALO ALTO STREET TREE PROTECTION INSTRUCTIONSSECTION 31
31-1	Gene	
	a. b.	Tree protection has three primary functions, 1) to keep the foliage canopy and branching structure clei from contact by equipment, materials and activities; 2) to preserve roots and soil conditions in an intact an non-compacted state and 3) to ideatify the Tree Protection Zone (TPZ) in which no soil disturbance is permitted and activities are restricted, unless otherwise approved. The Tree Protection Zone (TPZ) is a restricted area around the base of the tree with a radius of ten-time the diameter of the tree's trunk or ten feet; whichever is greater, enclosed by fencing.
		ACCUPATION OF CONTROL
31-2	0.0000000000000000000000000000000000000	Detail 605 – Illustration of situations described below.
	a. b.	Tree Technical Manual (TTM) Forms (http://www.cityofpaloalto.org/trees/) 1. Trenching Restriction Zones (TTM, Section 2.20(C)) 2. Arborist Reporting Protocol (TTM, Section 6.30) 3. Site Plan Requirements (TTM, Section 6.35)
		Tree Disclosure Statement (TTM, Appendix J)
	c.	Street Tree Verification (STV) Form (http://www.cityofpaloalto.org/trees/forms)
31-3	Execu	tion
51-5	a.	Type I Tree Protection: The fence shall enclose the entire TPZ of the tree(s) to be protected throughout the life of the construction project. In some parking areas, if fencing is located on paving or concrete that will not be demolished, then the posts may be supported by an appropriate grade level concrete base, if approved by Public Works Operations.
	b.	Type II Tree Protection: For trees situated within a planting strip, only the planting strip and yard side of the TPZ shall be enclosed with the required chain link protective fencing in order to keep the sidewalk and street open for public use.
	c.	Type III Tree Protection: To be used <u>only</u> with approval of Public Works Operations. Trees situated in a tree well or sidewalk planter pit, shall be wrapped with 2-inches of orange plastic fencing from the ground to the first branch and overlaid with 2-inch thick wooden slats bound securely (slats shall not be allowed to dig into the bark). During installation of the plastic fencing, caution shall be used to avoid damaging any branches. Major limbs may also require plastic fencing as directed by the City Arborist.
	d.	Size, type and area to be fenced. All trees to be preserved shall be protected with six (6') foot high chain link fences. Fences are to be mounted on two-inch diameter galvanized iron posts, driven into the ground to a depth of at least 2-feet at no more than 10-foot spacing. Fencing shall extend to the outer branching, unless specifically approved on the STV Form.
	e.	'Warning' signs. A warning sign shall be weather proof and prominently displayed on each fence at 20-fost intervals. The sign shall be minimum 8.5-inches x 11-inches and clearly state in half inch tall letters: "WARNING - Tree Protection Zone - This fence shall not be removed and is subject to a fine according to PAMC Section 8.10.110."
	r.	Duration . Tree fencing shall be erected before demolition; grading or construction begins and remain in place until final inspection of the project, except for work specifically allowed in the TPZ. Work or soil disturbance in the TPZ requires approval by the project arborist or City Arborist (in the case of work around Street Trees). Excavations within the public right of way require a Street Work Permit from Public Works.
	g.	During construction
		All neighbors' trees that overhang the project site shall be protected from impact of any kind. The applicant shall be responsible for the repair or replacement plus penalty of any publicly owned trees that are damaged during the course of construction, pursuant to Section 8.04.070 of the Palo Alto Municipal Code. The following tree preservation measures apply to all trees to be retained: a. No storage of material, topsoil, vehicles or equipment shall be permitted within the TPZ.
		 The ground under and around the tree canopy area shall not be altered. Trees to be retained shall be irrigated, aerated and maintained as necessary to ensure survival.
		END OF SECTION
		to 2004 Standard Drawings and Specifications
Street	Tree Ve	rification of Protection, PWE, Section 31 Revised 08/06

Table 2-2 Palo Alto Tree Technical Manual ARBORIST INSPECTION SCHEDULE All Checked Items Apply to this project: ✓ Inspection of Protective Tree Fencing. The Street Tree Verification Form shall be signed by the City Arborist. For other Protected Trees, the project arborist shall provide a written statement with a photograph verifying that he has conducted a field inspection of the trees and that the protective tree fencing is in place prior to issuance of a demolition, grading, or building permit. (see Verification of Tree Protection, Section 1.39). . Pre-Construction Meeting. Prior to commencement of construction, the applicant or contractor shall conduct a pre-construction meeting to discuss tree protection with the job site superintendent, grading equipment operators, project arborist, City Arborist, and, if a city maintained irrigation system exists, the Parks Manager (Contact 650-496-6962). ☐ Inspection of Rough Grading. The project arborist shall perform an inspection during the course of rough grading adjacent to the TPZ to ensure trees will not be injured by compaction, cut or fill, drainage and trenching, and if required, inspect aeration systems, tree wells, drains and special paving. The contractor shall provide the project arborist at least 48 hours advance notice of such activity. ☐ Monthly Inspections. The project arborist shall perform a monthly activity inspection to monitor and advise for conditions and tree health. The City Arborist shall be in receipt of the activity report during the first week of each calendar month or, immediately if there are any revisions to the approved plans or protection measures. Fax to (650) 329-2154. (see Monthly Inspection Report, Section 1.17). 5. Special activity within the Tree Protection Zone. Work in this area (TPZ described in #7 below) requires the direct onsite supervision of the project arborist (see Trenching, Excavation and Equipment, TTM Section 2.20 C). 6. Landscape Architect Inspection. For discretionary development projects,

prior to temporary or final occupancy the applicant or contractor shall arrange for the

Landscape Architect to perform an on site inspection of all plant stock, quality of

the materials and planting (see Quality, Section 5.20.1 A) and that the irrigation is

functioning consistent with the approved construction plans. The City shall be in

receipt of written verification of Landscape Architect approval prior to scheduling

the final inspection, unless otherwise approved.

7.

Other (please describe)

	City of Palo Alto Tree Department Public Works Operations PO Box 10250 Palo Alto, CA 943 550/495-5953 FAX: 650/852-928 treeprotection@CityofPaloAlto.org	Street	rification of Tree Protection
	ons: Complete upper portion of ent to Public Works Dept. Pul		
APPLICATION D	ATE:		
ADDRESS/LOCA	ATION OF STREET ROTECTED:		
APPLICANT'S N	AME:		
APPLICANT'S A	DDRESS:		
APPLICANT'S T & FAX NUMBER			
This section to be	illed out by City Tree Staff		
address(es) a	rees at the above are adequately e type of protection	YES □ * If NO,	NO* ☐ go to #2 below
Inspected by:			
Date of Inspec	tion:		
address are to protected. The modifications indicate how	are required: the required were communicated		
Subsequent Insp	ection		
Street trees at ab o be adequately	ove address were found protected:	YES ☐ * If NO, indicate in "Notes	NO* ☐ s" below the disposition of case.
npsected by:			***
Date of Inspection	on:		
site, condition and nstalled. Also no	street trees by species, d type of tree protection te if pictures were of sheet if necessary.		

---WARNING---**Tree Protection Zone**

This fencing shall not be removed without City Arborist approval (650-496-5953)

Removal without permission is subject to a \$500 fine per day*

*Palo Alto Municipal Code Section 8.10.110 City of Palo Alto Tree Protection Instructions are located at http://www.city.palo-alto.ca.us/trees/technical-manual.html

ISSUES AND REVISIONS

PLANNING RESUBMITTAL #2

DESCRIPTION

02.04.22

PLANNING SUBMITTAL PLANNING RESUBMITTAL #1

SMITH DEVELOPMENT

150 GRANT / 123 SHERMAN / 2501 PARK

GUZZARDO

San Francisco, CA 94111


Landscape Architects • Land Planners

T 415 433 4672 F 415 433 5003

PALO ALTO, CA 94306

PROJECT NUMBER

SHEET TITLE TREE PROTECTION PLAN

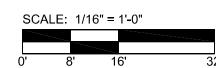

All other tree-related reports shall be added to the space provided on this sheet (adding as needed) Include this sheet(s) on Project Sheet Index or Legend Page.

A copy of T-1 can be downloaded at www.cityofpaloalto.org/arb/forms

Special Tree Protection Instruction Sheet City of Palo Alto



1-

City of Palo Alto

Tree Protection - It's Part of the Plan!

Make sure your crews and subs do the job right!

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Kielty Arborist Services LLC ertified Arborist WE#0476A P.O. Box 6187 San Mateo, CA 94403

Revised February 4th, 2022

Smith Development

Site: 150 Grant Avenue, 123 Sherman Avenue, & 2501 Park Boulevard, Palo Alto Dear Smith Development,

As requested on March 23rd, 2021, I visited the above site for the purpose of inspecting and commenting on the trees. A mixed-use project is proposed for this site, and your concern as to the future health and safety of the trees has prompted this visit. Planning submittal package by KSH Architects was reviewed for writing this report. This report will go over the general health of the trees on site and will give recommendations for the proposed construction. A tree protection plan to follow throughout the entire length of the proposed construction will also be found within this report.


All inspections were made from the ground; the trees were not climbed for this inspection. The trees in question were located on a map provided by you. The trees were then measured for diameter at 54 inches above ground level (DBH). The trees were given a condition rating for form and vitality. The trees' condition rating is based on 50 percent vitality and 50 percent form,


> 1 - 29 Very Poor 30 - 49 Poor 50 - 69 Fair 70 - 89 Good


The height of the trees was measured using a Nikon Forestry 550 Hypsometer. The spread was paced off. Comments and recommendations for future maintenance are provided.

DBH-Diameter at breast height (54 inches above grade) **CON-**Condition rating HT/SP-Tree height and canopy spread P- Indicates protected tree by city ordinance

Grant, Sherman & Park DBH CON HT/SP 8.8 60 15/15 Fair vigor, fair form, minor deadwood. 2R Japanese maple 3.8-5.5 0 12/6 (Acer palmatum) 3R Raywood ash 7.8 55 25/15 Fair vigor, fair form. (Fraxinus angustifolia 'Raywood') 4R Raywood ash 8.7 55 25/15 Fair vigor, fair form. (Fraxinus angustifolia 'Raywood') 4.8 30 15/12 Fair vigor, poor form, heartwood rot, (Magnolia grandiflora) (Photinia x fraseri) 36.8 70 65/25 Good vigor, good form. 7P Redwood (Sequoia sempervirens) 13.5 70 45/15 Good vigor, good form, suppressed. (Sequoia sempervirens) Redwood 8.8 70 35/12 Good vigor, good form, suppressed. (Seauoia sempervirens) 19.8 70 50/15 Good vigor, good form. 10P Redwood (Sequoia sempervirens) (Magnolia grandiflora) Fair to poor vigor, fair form, street 12*P Magnolia 5.8 45 15/12 (Magnolia grandiflora) 13R Tree of heaven 11.5 45 40/25 Fair vigor, fair form, poor location, NO TREES FOUND ON THE 2501 PARK BOULEVARD **SIDE OF PROJECT**

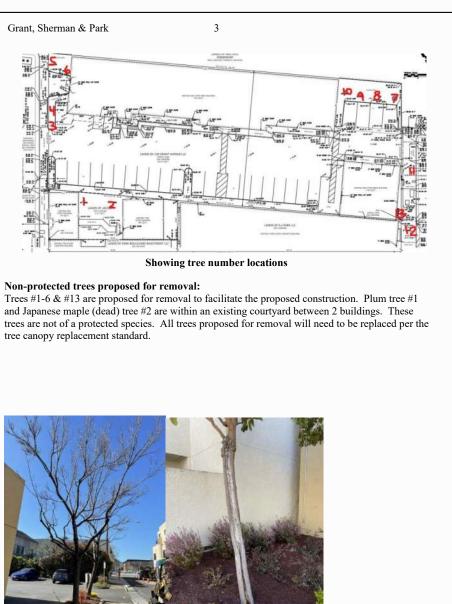

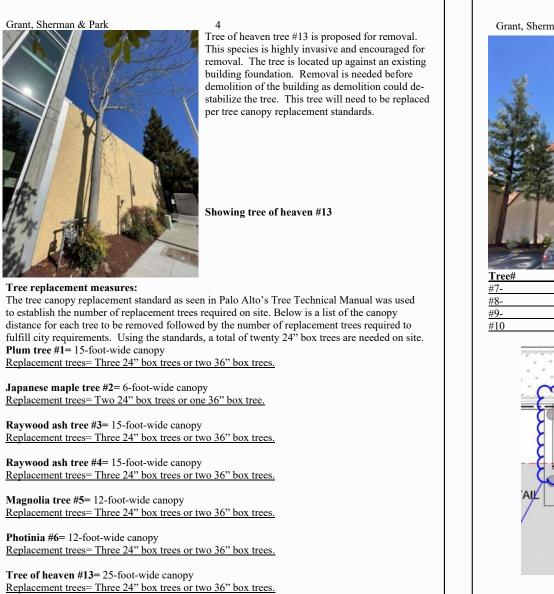

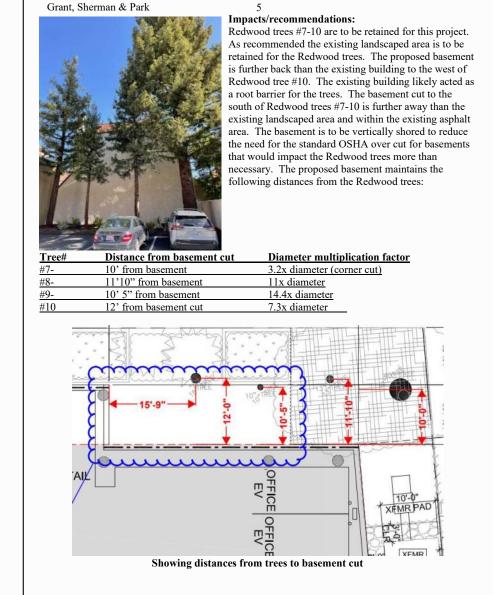

Grant, Sherman & Park

R- Indicates proposed tree removal

using the following scale.

Redwood tree #7 is the closest to the proposed basement cut. The basement cut will be a corner cut from this tree. The area immediately to the south of the tree is to become a landscaped area. Any existing roots within the landscaped area will be retained and will help to reduce impacts. The existing asphalt to be demolished when within the proposed landscape area near tree #7 is recommended to be done by hand under the Project Arborist supervision. Any exposed roots during the demolition of the asphalt within the proposed landscaped area are recommended to be covered by soil and wetted down as soon as possible after being exposed. If to be left exposed for longer than half a day, the exposed roots will need to be covered by 3 layers of wetted down burlap to help avoid root desiccation. Before the construction of the basement is to start, it is recommended to perform a hand excavation trench at the edge of the proposed basement cut when within 30 feet from the Redwood trees while under the Project Arborist supervision. The depth of the trench is recommended to be 3' deep (depth of majority of root zone). All encountered roots are to be recorded and documented. Encountered roots are to be cleanly cut using a hand saw or loppers. The wall of the trench on the tree side where roots have been cut is recommended to be covered by 3 layers or wetted down burlap. Burlap moisture must be maintained by the contractor by wetting down the burlap multiple times a day. At this time an irrigation system is recommended to be installed within the landscaped area. The irrigation system is recommended to consist of a series of soaker hoses within the existing landscaped area. Once a week the soaker hoses shall be turned on until the top foot of soil is saturated. The Redwood trees are recommended to be deep water fertilized using 500 gallons of water mixed with a well-balanced fertilizer in early May of 2022. Every May for the next 3 years the Redwood trees are recommended to be deep water fertilized. The Redwood trees will need to be inspected monthly during the required monthly inspections. Impacts to the Redwood trees are expected to be minor with impacts to Redwood tree #7 to be moderate. The above recommendations consisting of irrigation, deep water fertilized, and hand excavation will act as mitigations for the expected impacts.

A new transformer on a pad with meters is to be constructed above grade at 20' from Redwood tree #7. This work is recommended/required to be supervised by the Project Arborist. Any excavation needed for utilities when within 30' from this tree (10x diameter) will need to be done by hand. Any encountered roots are recommended to be retained by tunneling utility lines below or besides roots where possible. Impacts are expected to be minor.



Grant, Sherman & Park Γhe sidewalk is to be replaced around Magnolia tree #11. The tree is a young street tree with a diameter of only 6". The sidewalk is recommended to be demolished by hand while under the Project Arborist supervision when within 6' from this tree. Existing base rock will also need to be removed by hand. All encountered roots within 6' from the tree will need to be retained where ssible. The use of an air spade is recommended to help remove the existing soil and base roc from the tree's roots. The exposed roots are recommended to be kept moist by covering exposed roots in layers of wetted down burlap. New base rock when within 6' from the tree is recommended to consist of Structural Soil (CU Mix). Structural soil shall be packed around the existing roots with the new sidewalk being built up on top of the existing tree roots. Structural Soil looks like average base rock but larger pieces mixed with a hydro gel. Roots will be able to continue to grow in this medium. The Magnolia tree will need to be irrigated frequently during this proposed work. While roots are exposed and the work is taking place irrigation is recommended to take place every 3 hours. Once the work is completed the tree is recommended to be irrigated with 0 gallons of clean water. Impacts are expected to be minor.

P-Indicates a protected tree by city ordinance

Tree Protection Plan:


Neighboring magnolia tree #12 is not expected to be impacted. This tree will need to be protected by type 3 tree protection fencing. The following tree protection plan will help to insure the future health of the retained trees on site. No impacts to the protected trees on site are expected.

Tree protection zones should be established and maintained throughout the entire length of the project. All tree protection measures, recommended inspections, irrigation, and construction scheduling shall be implemented in full by the owner and contractor. Fencing for the protection zones should be 6-foot-tall metal chain link type supported by 2-inch diameter metal poles pounded into the ground to a depth of no less than 2 feet. The support poles should be spaced no more than 10 feet apart on center. The location for the protection fencing should be placed at a ninimum distance equal to the tree driplines, and at a maximum distance of 10 times the trees liameters where possible. Where tree protection fencing cannot be placed at the dripline because of the approved proposed work, tree protection should be placed as close as possible to the proposed work while still allowing room for construction to safely continue. Signs should be placed on fencing signifying "Tree Protection Zone - Keep Out". No materials or equipment should be stored or cleaned inside the tree protection zones. If tree protection zones need to be reduced for access or any other reason, than a landscape barrier shall be installed where tree protection does not extend out to the tree driplines. The following tree protection distances should

• Magnolia street trees #11 and #12 will need to be protected by type 3 tree protection. Fencing shall consist of orange plastic fencing wrapped around the tree trunk from the ground to a height equal to the first lateral branch, to form a 2-inch thick layer of orange plastic fencing. On the outside of the orange plastic fencing, 2-inch thick wooden slats are recommended to be bound securely to the fencing. During installation of the wood slats, caution shall be used to avoid damaging any bark or branches.

be followed throughout the entire length of the project:

• Redwood trees #7-10 will need to be protected by type 1 tree protection fencing. Fencing will need to be installed at the edge of the proposed basement cut and out to 30 feet from

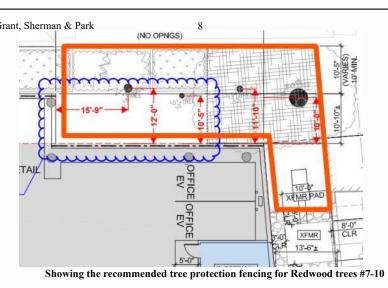


Where tree protection does not cover the entire root zone of the trees (at canopy spread), or when a smaller tree protection zone is needed for access, a landscape buffer consisting of wood chips spread to a depth of six inches with plywood or steel plates placed on top will be placed where foot traffic is expected to be heavy. The landscape buffer will help to reduce compaction to the

During construction any trimming will be supervised by the site arborist and must stay underneath 25% of the tree's total foliage. At this time no pruning is proposed. All pruning shall be done by a

Any roots to be cut should be monitored and documented. Large roots or large masses of roots to be cut should be inspected by the site arborist. The site arborist may recommend irrigation and a tree monitoring program at that time. Cut all roots clean with a saw or loppers. Roots to be left exposed for a period of time should be covered with layers of burlap and kept moist. All roots measuring 1.5 inches in diameter or larger to be cut, must first be shown to the Project Arborist.

Trenching and Excavation Trenching and excavation shall strive to stay outside of the tree protection zones. If not possible trenching for any reason, should be hand dug when beneath the dripline of desired trees. Hand digging and careful placement of pipes below or beside protected roots will dramatically reduce root loss, thus reducing trauma to desired trees. Trenches should be back filled as soon as possible using native materials and compacted to near original levels. Trenches to be left open with exposed roots shall be covered with burlap and kept moist. Plywood laid over the trench will help to protect roots below.

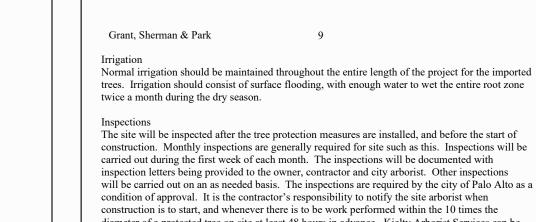

diameter of a protected tree on site at least 48 hours in advance. Kielty Arborist Services can be reached at 650-515-9783(Kevin), or by email at kkarbor0476@yahoo.com. Further information about tree protection can be found in the Tree Technical Manual provided by the city of Palo Alto. This information should be kept on site at all times. The information included in this report is believed to be true and based on sound arboricultural principles and

Sincerely, Kevin R. Kielty Certified Arborist WE#0476A Kevin Kielty David Beckham Certified Arborist WE#10724A TRAQ Qualified David Beckham SMITH DEVELOPMENT

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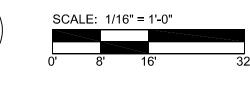
ISSUES AND REVISIONS

DESCRIPTION PLANNING SUBMITTAL PLANNING RESUBMITTAL #1

PROJECT NUMBER

PLANNING RESUBMITTAL #2

ARBORIST REPORT



All other tree-related reports shall be added to the space provided on this sheet (adding as needed) Include this sheet(s) on Project Sheet Index or Legend Page.

A copy of T-1 can be downloaded at www.cityofpaloalto.org/arb/forms

Special Tree Protection Instruction Sheet City of Palo Alto



City of Palo Alto Tree Protection - It's Part of the Plan!

Make sure your crews and subs do the job right!

Fenced enclosures around trees are essential to protect them by keeping the foliage canopy and branching structure clear from contact by equipment, materials and activities, preserving roots and soil conditions in an intact and non-compacted state, and identifying the Tree Protection Zone (TPZ) in which no soil disturbance is permitted and activities are restricted, unless otherwise approved. An appoved tree protection report must be added to this sheet when project activity occurs within the TPZ of a regulated tree. For detailed information on Palo Alto's regulated trees and protection during development, review the City Tree Technical Manual (TTM) found at www.cityofpaloalto.org/trees/.

Tree Protection Fence -Tree Protection Fence — SHERMAN AVENUE GRANTGAMENUE **EXISTING BUILDING** Tree Protection Fence NE' ?) PARK BOULEVARD

TREE DISPOSITION LEGEND

SYMBOL	# OF TREES	DESCRIPTION				
\otimes	7->-	OMIT EXISTING TREE TO BE REMOVED (#1, 2, 3, 4, 5, 6, 73)				
TREE PROTECTION ZONE	4->_	PROTECTED TREES (HERITAGE & STREET TREES) TO REMAIN (#7, 10, 11, 12)				
TREE PROTECTION ZONE	0->2	EXISTING TREES TO REMAIN (#8, 9)				
	7→7	TOTAL NUMBER OF TREES TO BE REMOVED				
	6->6	EXISTING TREES TO REMAIN				
	9	NEW TREES PLANTED				
	15	TOTAL NUMBER OF TREES TO EXIST ON SITE AT PROJECT COMPLETION				
		REVIEW & CONFIRM				

Special Tree Protection Instruction Sheet City of Palo Alto



SMITH DEVELOPMENT

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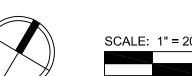



ISSUES AND REVISIONS

PLANNING SUBMITTAL

PLANNING RESUBMITTAL #2

ARBORIST REPORT & TREE DISPOSITION PLAN



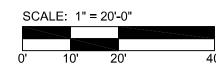

L5.3

Scope of Work

To ensure all of the plants are looking immaculate at all times, Habitat Horticulture is proposing the following weekly maintenance regime. Additionally, we will be available to come on as needed basis to keep the wall looking clean, healthy and vibrant throughout the year. A 100% plant warranty is included in the maintenance cost for **Option A & B**.

Green Element	System	Dimensions	Location
Living Wall	Non-Recirculating		

Maintenance Task List

- Check and Clean Pre and Post Filters
- Manually add nutrients to fertigation system
- Develop an Integrated Pest Management program
- Remove dust from leaves and shine leaves
- System flushes to mitigate salt build up in drip lines and in growing medium
- Clean fallen leaves and debris, deadhead flowers, weeding and aesthetic pruning
- Test each irrigation zone and adjust according to stage of growth and season
- Replace plants as needed throughout the year

Project:

123 Sherman, Typical Non-recirculating Living Wall Shop Drawings

Issue Description:By: Date:Shop DrawingsGC 08/10/21

Drawings:

LW0: Title Sheet

LW1: Living Wall Plan & Elevation

LW2: Living Wall Details

LW3: Irrigation System Details

LW4: Functional Diagram

LW5: Installation Images

LW6: Plant Palette

SMITH DEVELOPMENT

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ISSUES AND REVISIONS

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08.31.21 PLANNING RESUBMITTAL #1 02.04.22 PLANNING RESUBMITTAL #2


PROJECT NUI

SHEET TITLE SHEET

1/16" = 1'-0"



SHEET NUMB

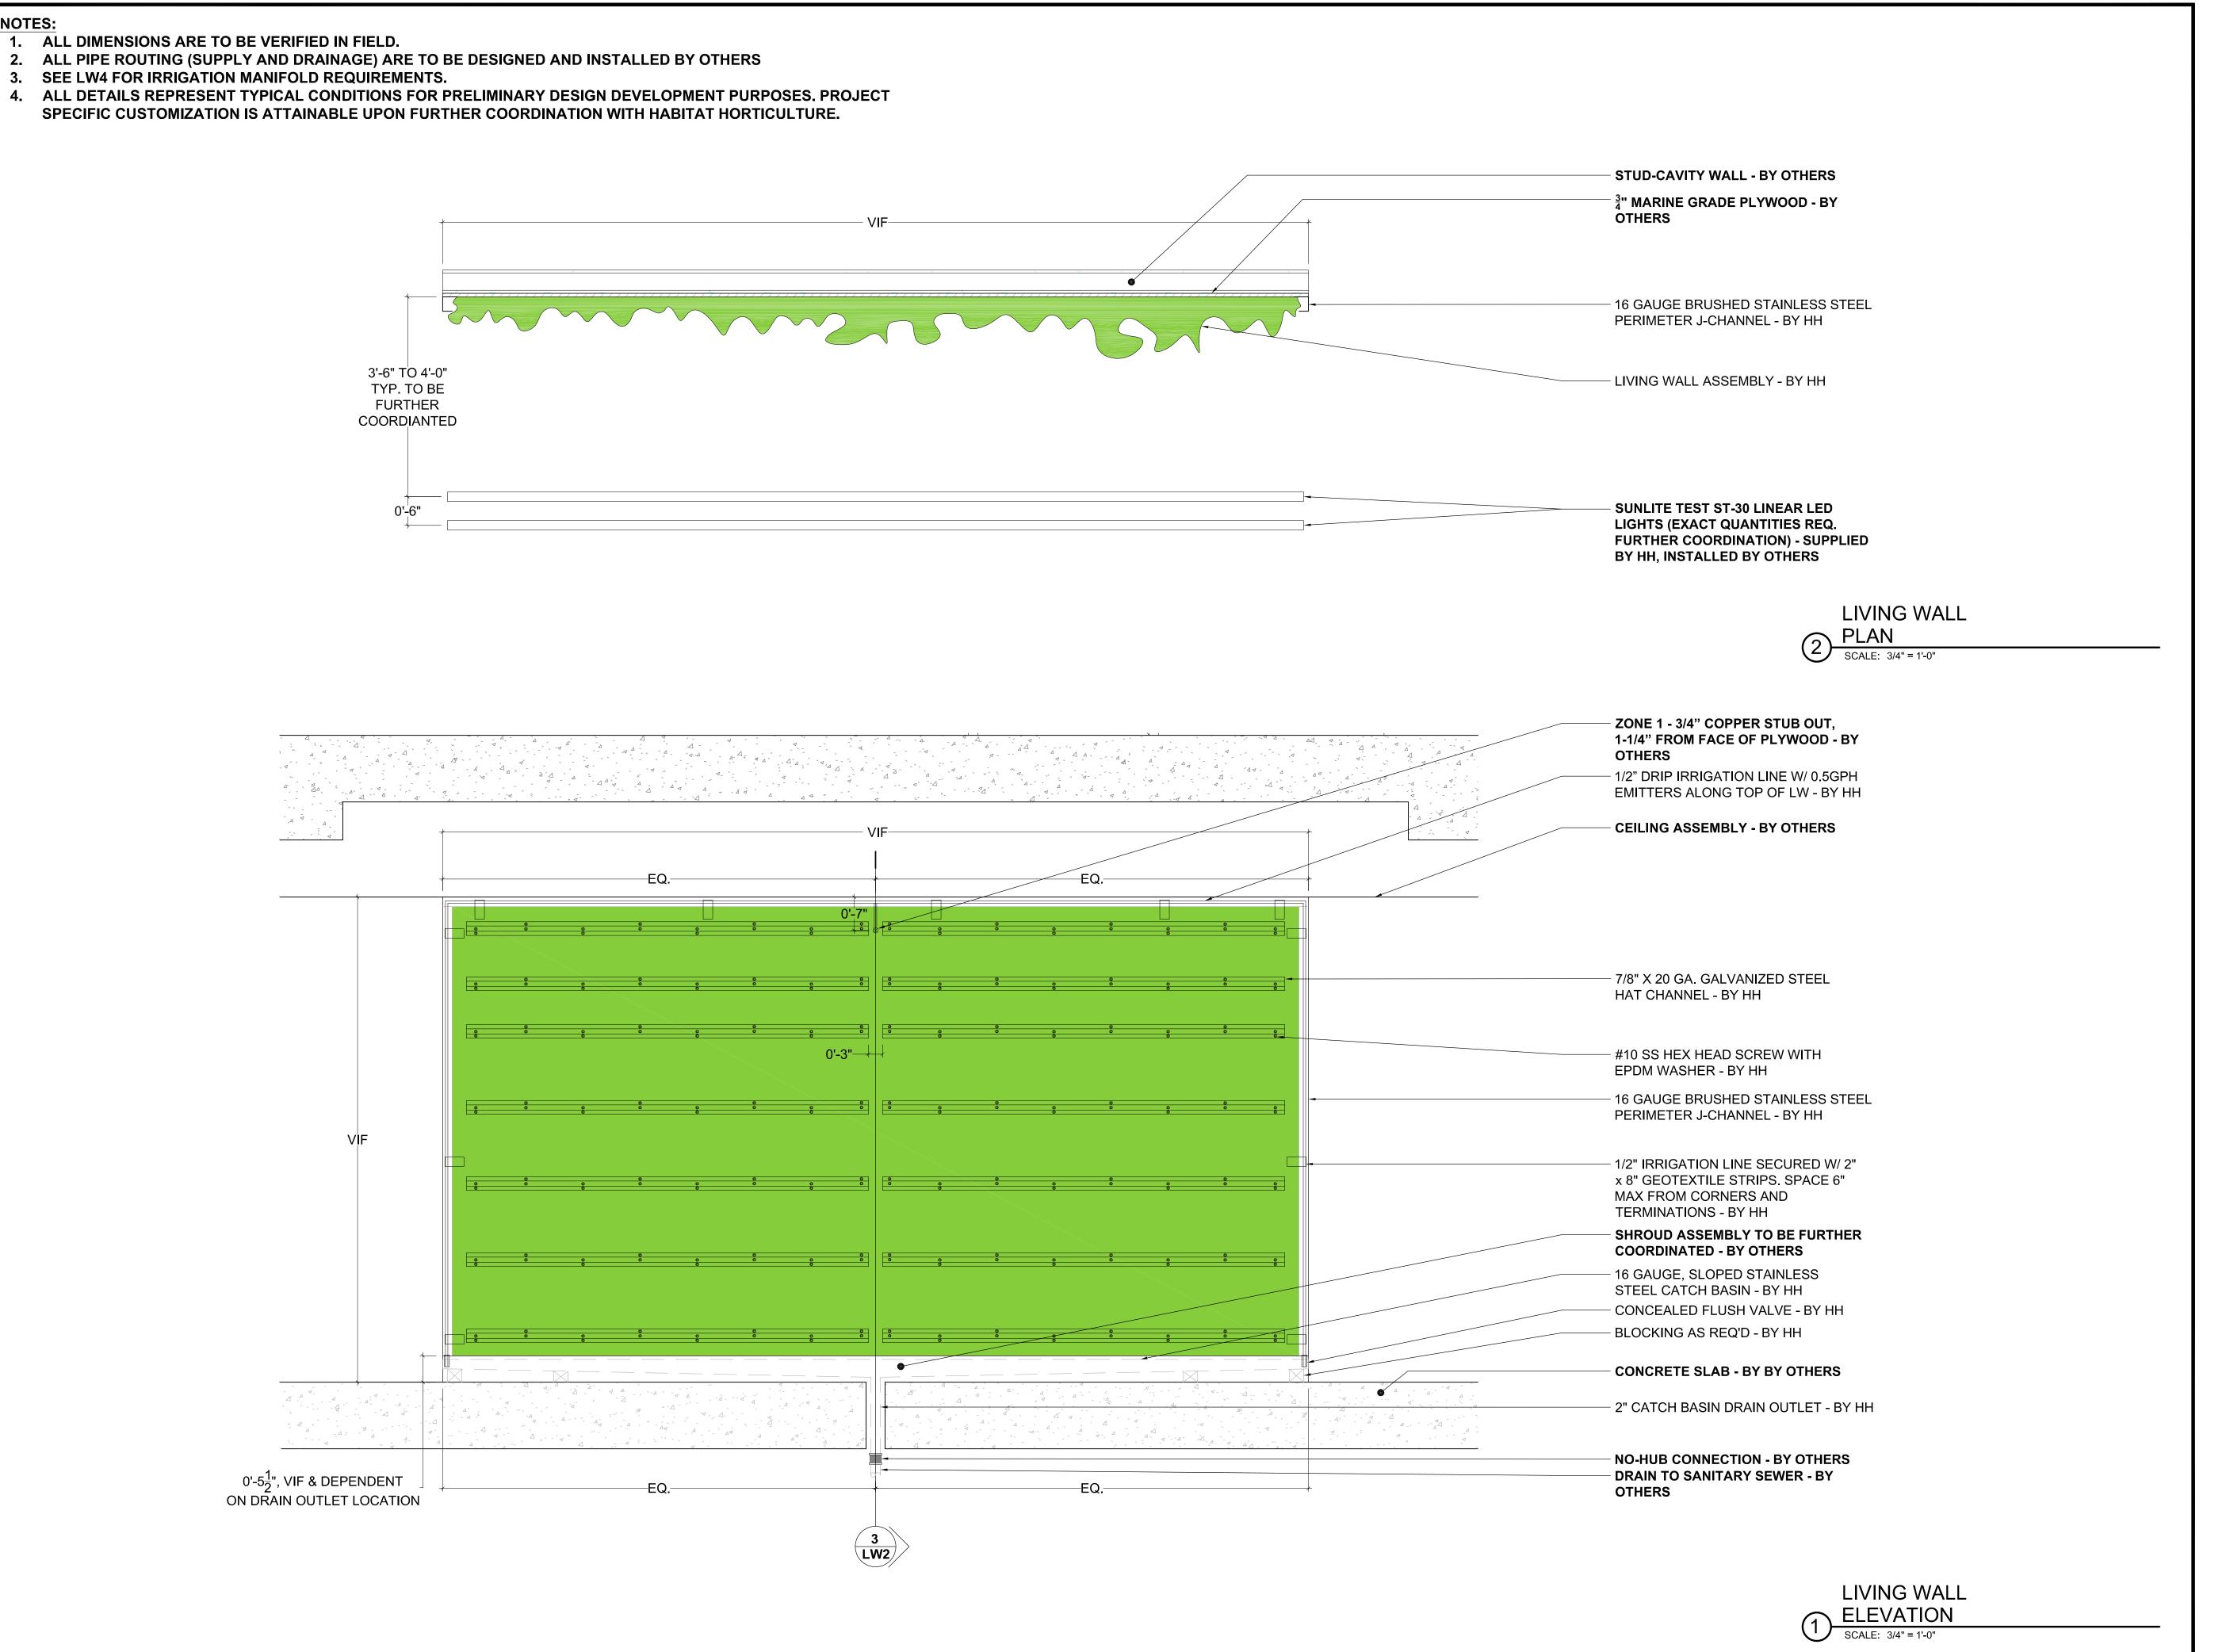

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ISSUES AND REVISIONS

DATE DESCRIPT

08.31.21 PLANNING RESUBMITTAL #1 02.04.22 PLANNING RESUBMITTAL #2

PROJECT NUMBER


SHEET TITLE
LIVING WALL PLAN & ELEVATION

1/16" = 1'-0"

SCALE

SHEET NUMBER



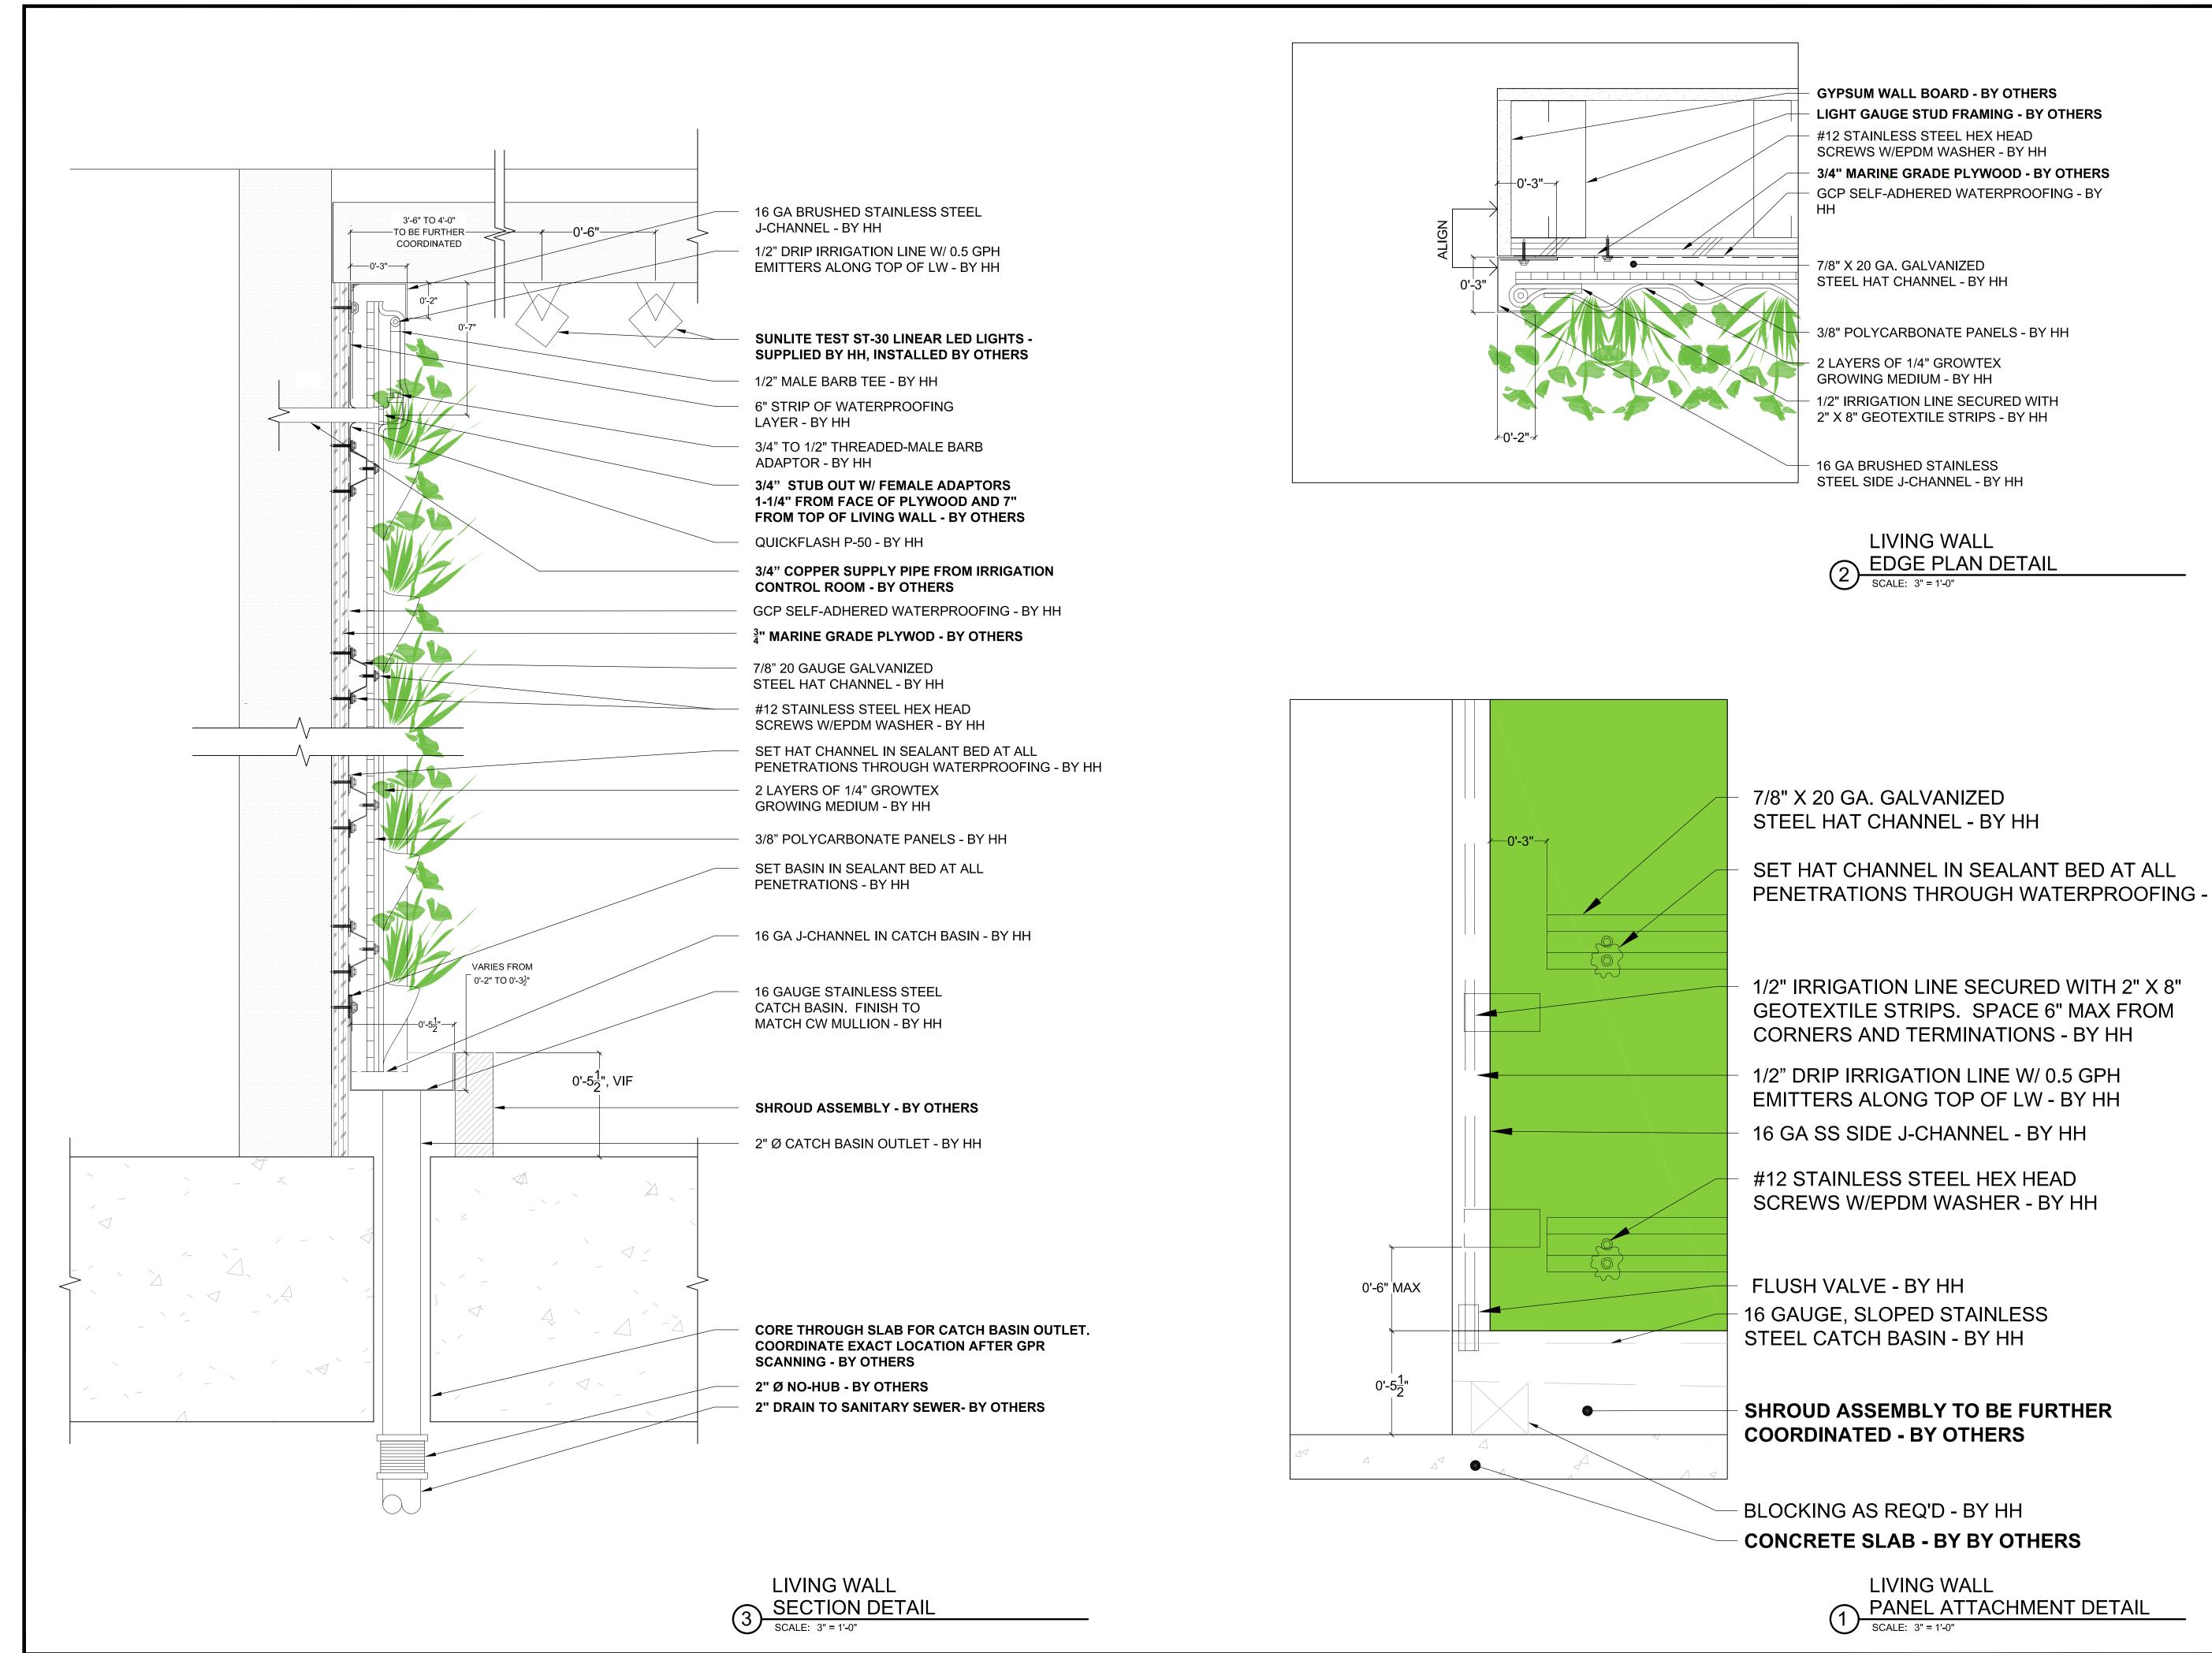

GYPSUM WALL BOARD - BY OTHERS LIGHT GAUGE STUD FRAMING - BY OTHERS #12 STAINLESS STEEL HEX HEAD SCREWS W/EPDM WASHER - BY HH 3/4" MARINE GRADE PLYWOOD - BY OTHERS GCP SELF-ADHERED WATERPROOFING - BY 7/8" X 20 GA. GALVANIZED STEEL HAT CHANNEL - BY HH 3/8" POLYCARBONATE PANELS - BY HH 2 LAYERS OF 1/4" GROWTEX GROWING MEDIUM - BY HH 1/2" IRRIGATION LINE SECURED WITH 2" X 8" GEOTEXTILE STRIPS - BY HH

> LIVING WALL 2 EDGE PLAN DETAIL
>
> SCALE: 3" = 1'-0"

16 GA BRUSHED STAINLESS STEEL SIDE J-CHANNEL - BY HH SMITH DEVELOPMENT

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ISSUES AND REVISIONS

08.31.21 PLANNING RESUBMITTAL #1 02.04.22 PLANNING RESUBMITTAL #2

PROJECT NUMBER 20008

SHEET TITLE LIVING WALL DETAILS

1/16" = 1'-0"

SHEET NUMBER


LIVING WALL PANEL ATTACHMENT DETAIL

SCALE: 3" = 1'-0"

NOTES: 1. ALL FERTIGATION COMPONENTS EXCEPT FOR THE BACKFLOW DEVICE ASSEMBLY, BRASS FITTINGS, AND COPPER PIPE ADAPTERS WILL BE PROCURED BY HH AND INSTALLED BY OTHERS UNLESS OTHERWISE NOTED. 2. A MINIMUM WATER PRESSURE OF 50 PSI IS REQUIRED AT 1" DOMESTIC COLD WATER SUPPLY POC AT IRRIGATION CONTROLS. 3. A MINIMUM WATER PRESSURE OF 25 PSI IS REQUIRED AT EACH TOP OF WALL 3/4" COPPER STUB OUT. 4. ALL PIPE ROUTING (SUPPLY AND DRAINAGE) ARE TO BE DESIGNED AND INSTALLED BY OTHERS. 5. ALL DIMENSIONS ARE TO BE VERIFIED IN FIELD.

1-1/2" 0'-10" MIN

NON-RECIRCULATING IRRIGATION SYSTEM PLAN SCALE: 3/4" = 1'-0"

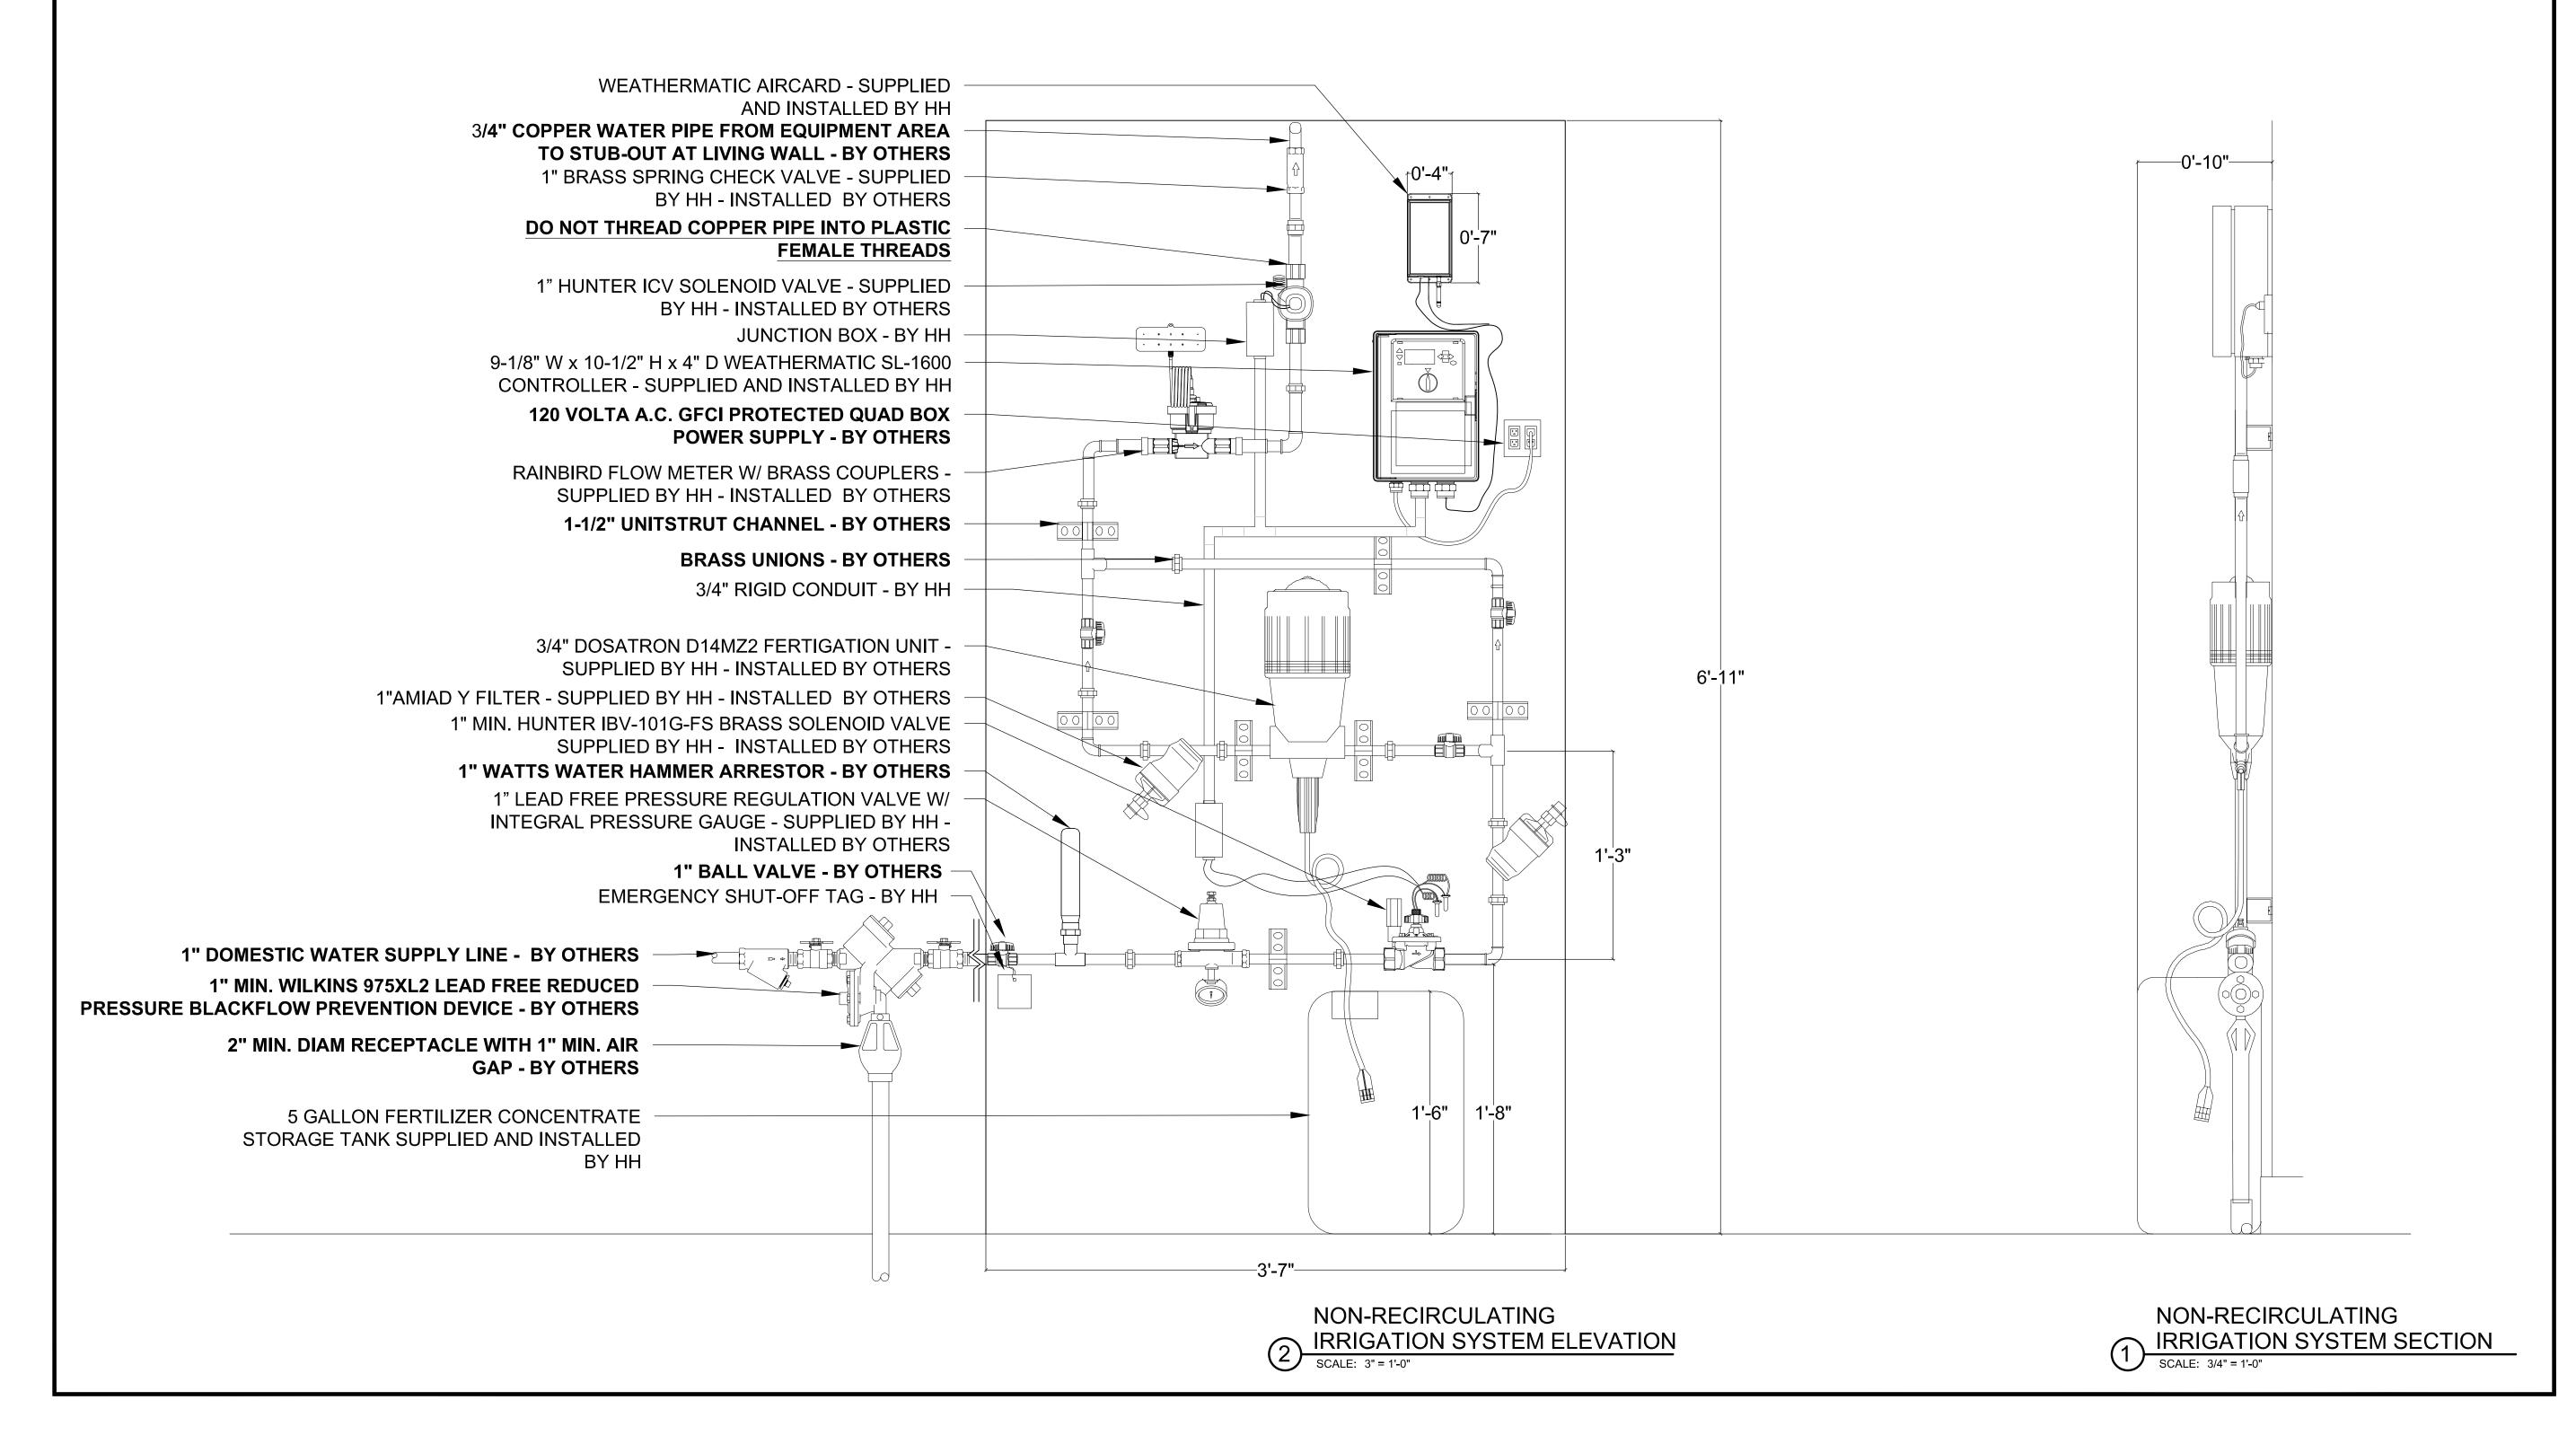

SMITH DEVELOPMENT

SUPPLIED BY HH:

- 2 QTY 1" HUNTER SOLENOID VALVE

- 2 QTY 1" AMIAD Y-FILTER - 1 QTY 3/4" DOSATRON

SUPPLIED BY OTHERS:

- 5 QTY BALL VALVES

- POWER SUPPLY - AIR GAP DRAIN

- 1 QTY 1" BRASS SPRING CHECK

- 1 QTY RAINBIRD FLOW METER

- 1 QTY WEATHERMATIC SL-1600

- 1 QTY WEATHERMATIC AIRCARD

- 1 QTY FERTILIZER STORAGE TANK

- BACKFLOW PREVENTION DEVICE

- WATER HAMMER ARRESTOR

- COPPER PIPE, UNIONS, AND ADAPTERS

- 1 QTY 1" PRV WITH INTEGRAL PSI GAUGE

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ISSUES AND REVISIONS

DATE DESCRIPTION

08.31.21 PLANNING RESUBMITTAL #1 02.04.22 PLANNING RESUBMITTAL #2


PROJECT NUM

SHEET TITLE
IRRIGATION SYSTEM DETAILS

SC

1/16" = 1'-0"

SHEET NUMBER

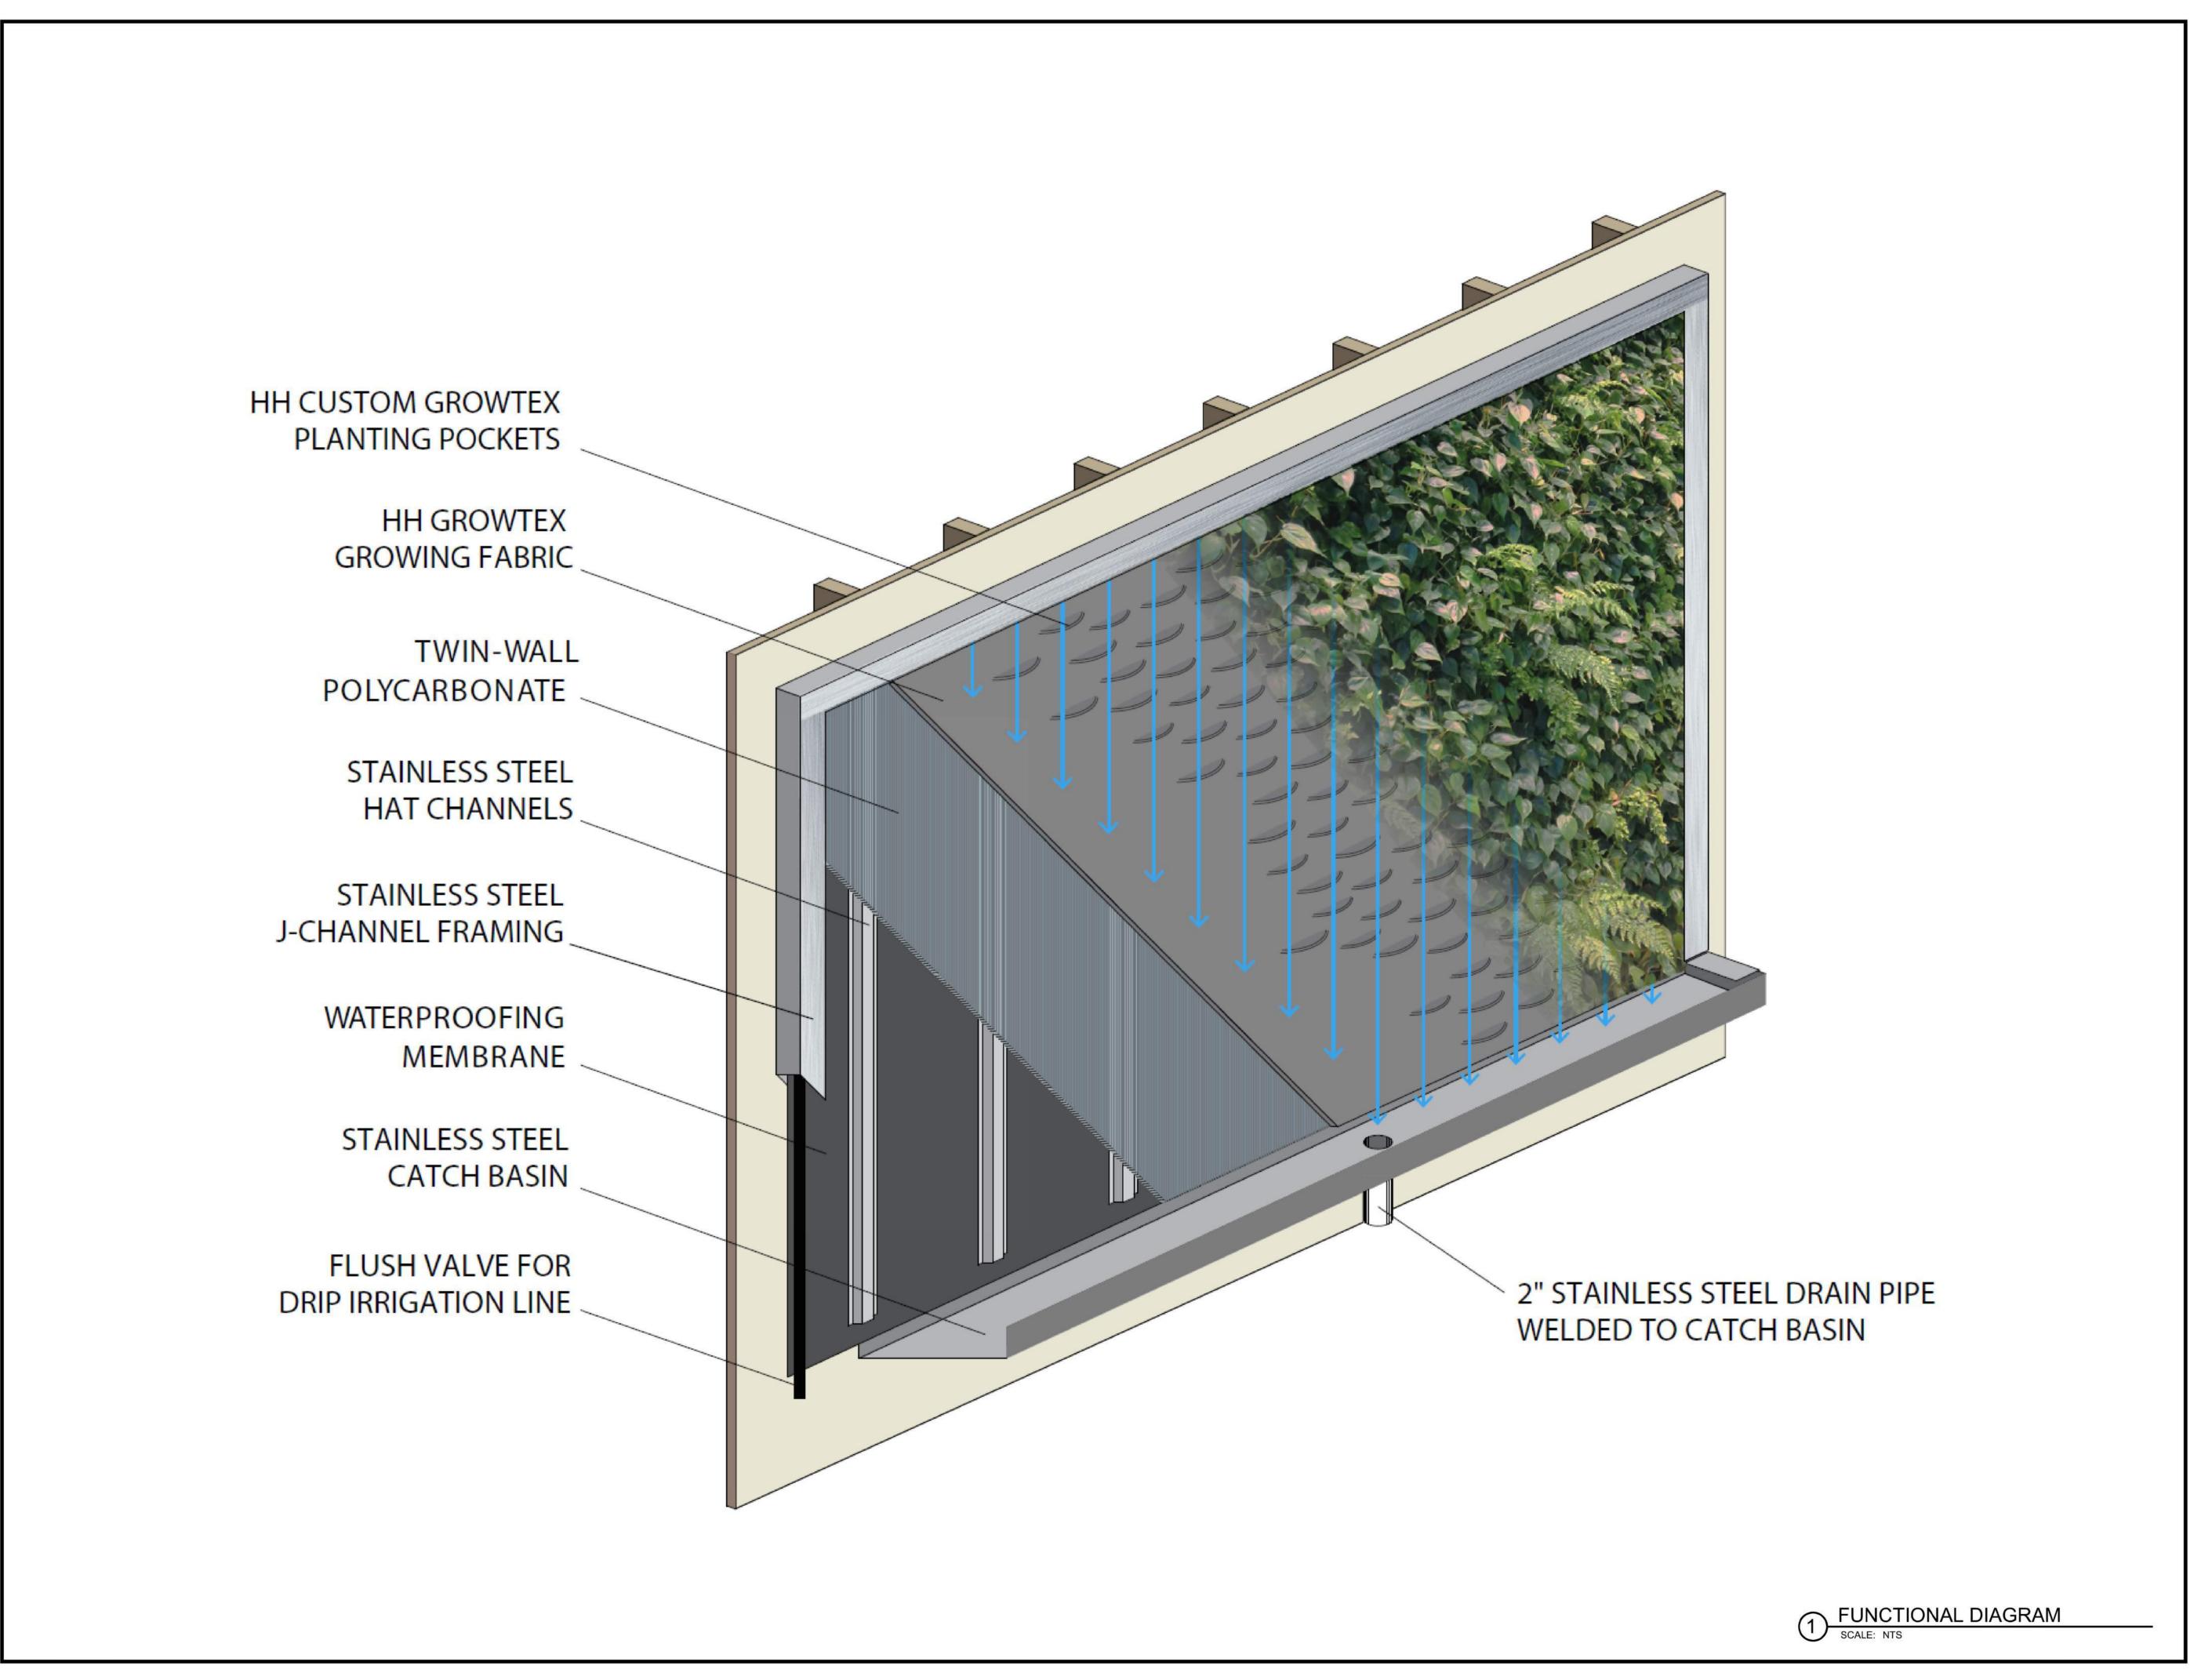

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ISSUES AND REVISIONS

E DESCRIPT

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PROJECT NUMB

SHEET TITLE
FUNCTIONAL DIAGRAM

SCALE 1/16" = 1'-0"

SHEET NUME

PLANTS!

1 INSTALLATION PROCESS
SCALE: NTS

SMITH DEVELOPMENT

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ISSUES AND REVISIONS

DESCRIP

08.31.21 PLANNING RESUBMITTAL #1 02.04.22 PLANNING RESUBMITTAL #2

PROJECT NUMB

SHEET TITLE
INSTALLATION PROCESS

1/16" = 1'-0"

SHEET NUME

LW5

123 Sherman

preliminary plant palette





Asparagus sprengeri

Muehlenbeckia complexa

Microlepia strigosa

Polypodium glycyrrhiza

Nephrolepis 'Jesters Crown Fern'

Asparagus Fern

Maidenhair Vine

Lace Fern

Licorice Fern

Boston Fern



Geranium cantabrigiense 'Karmina'

Cranesbill Karmina

Oxalis vulcanicola 'Plum crazy'

Plum Crazy Volcanic Sorrel Hebe pimeleoides 'Quicksilver'

Quicksilver Hebe

Ceanothus griseus var. horizontalis 'Yankee Point'

Yankee Point Ceanothus

Astelia chathamica 'Silver Spear'

Silver Spear

SMITH DEVELOPMENT

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ISSUES AND REVISIO

DESCRIP

08.31.21 PLANNING RESUBMITTAL #1 02.04.22 PLANNING RESUBMITTAL #2

PROJECT N

SHEET TITLE
PLANT PALETTE


1/16" = 1'-0"



SHEET NUMB





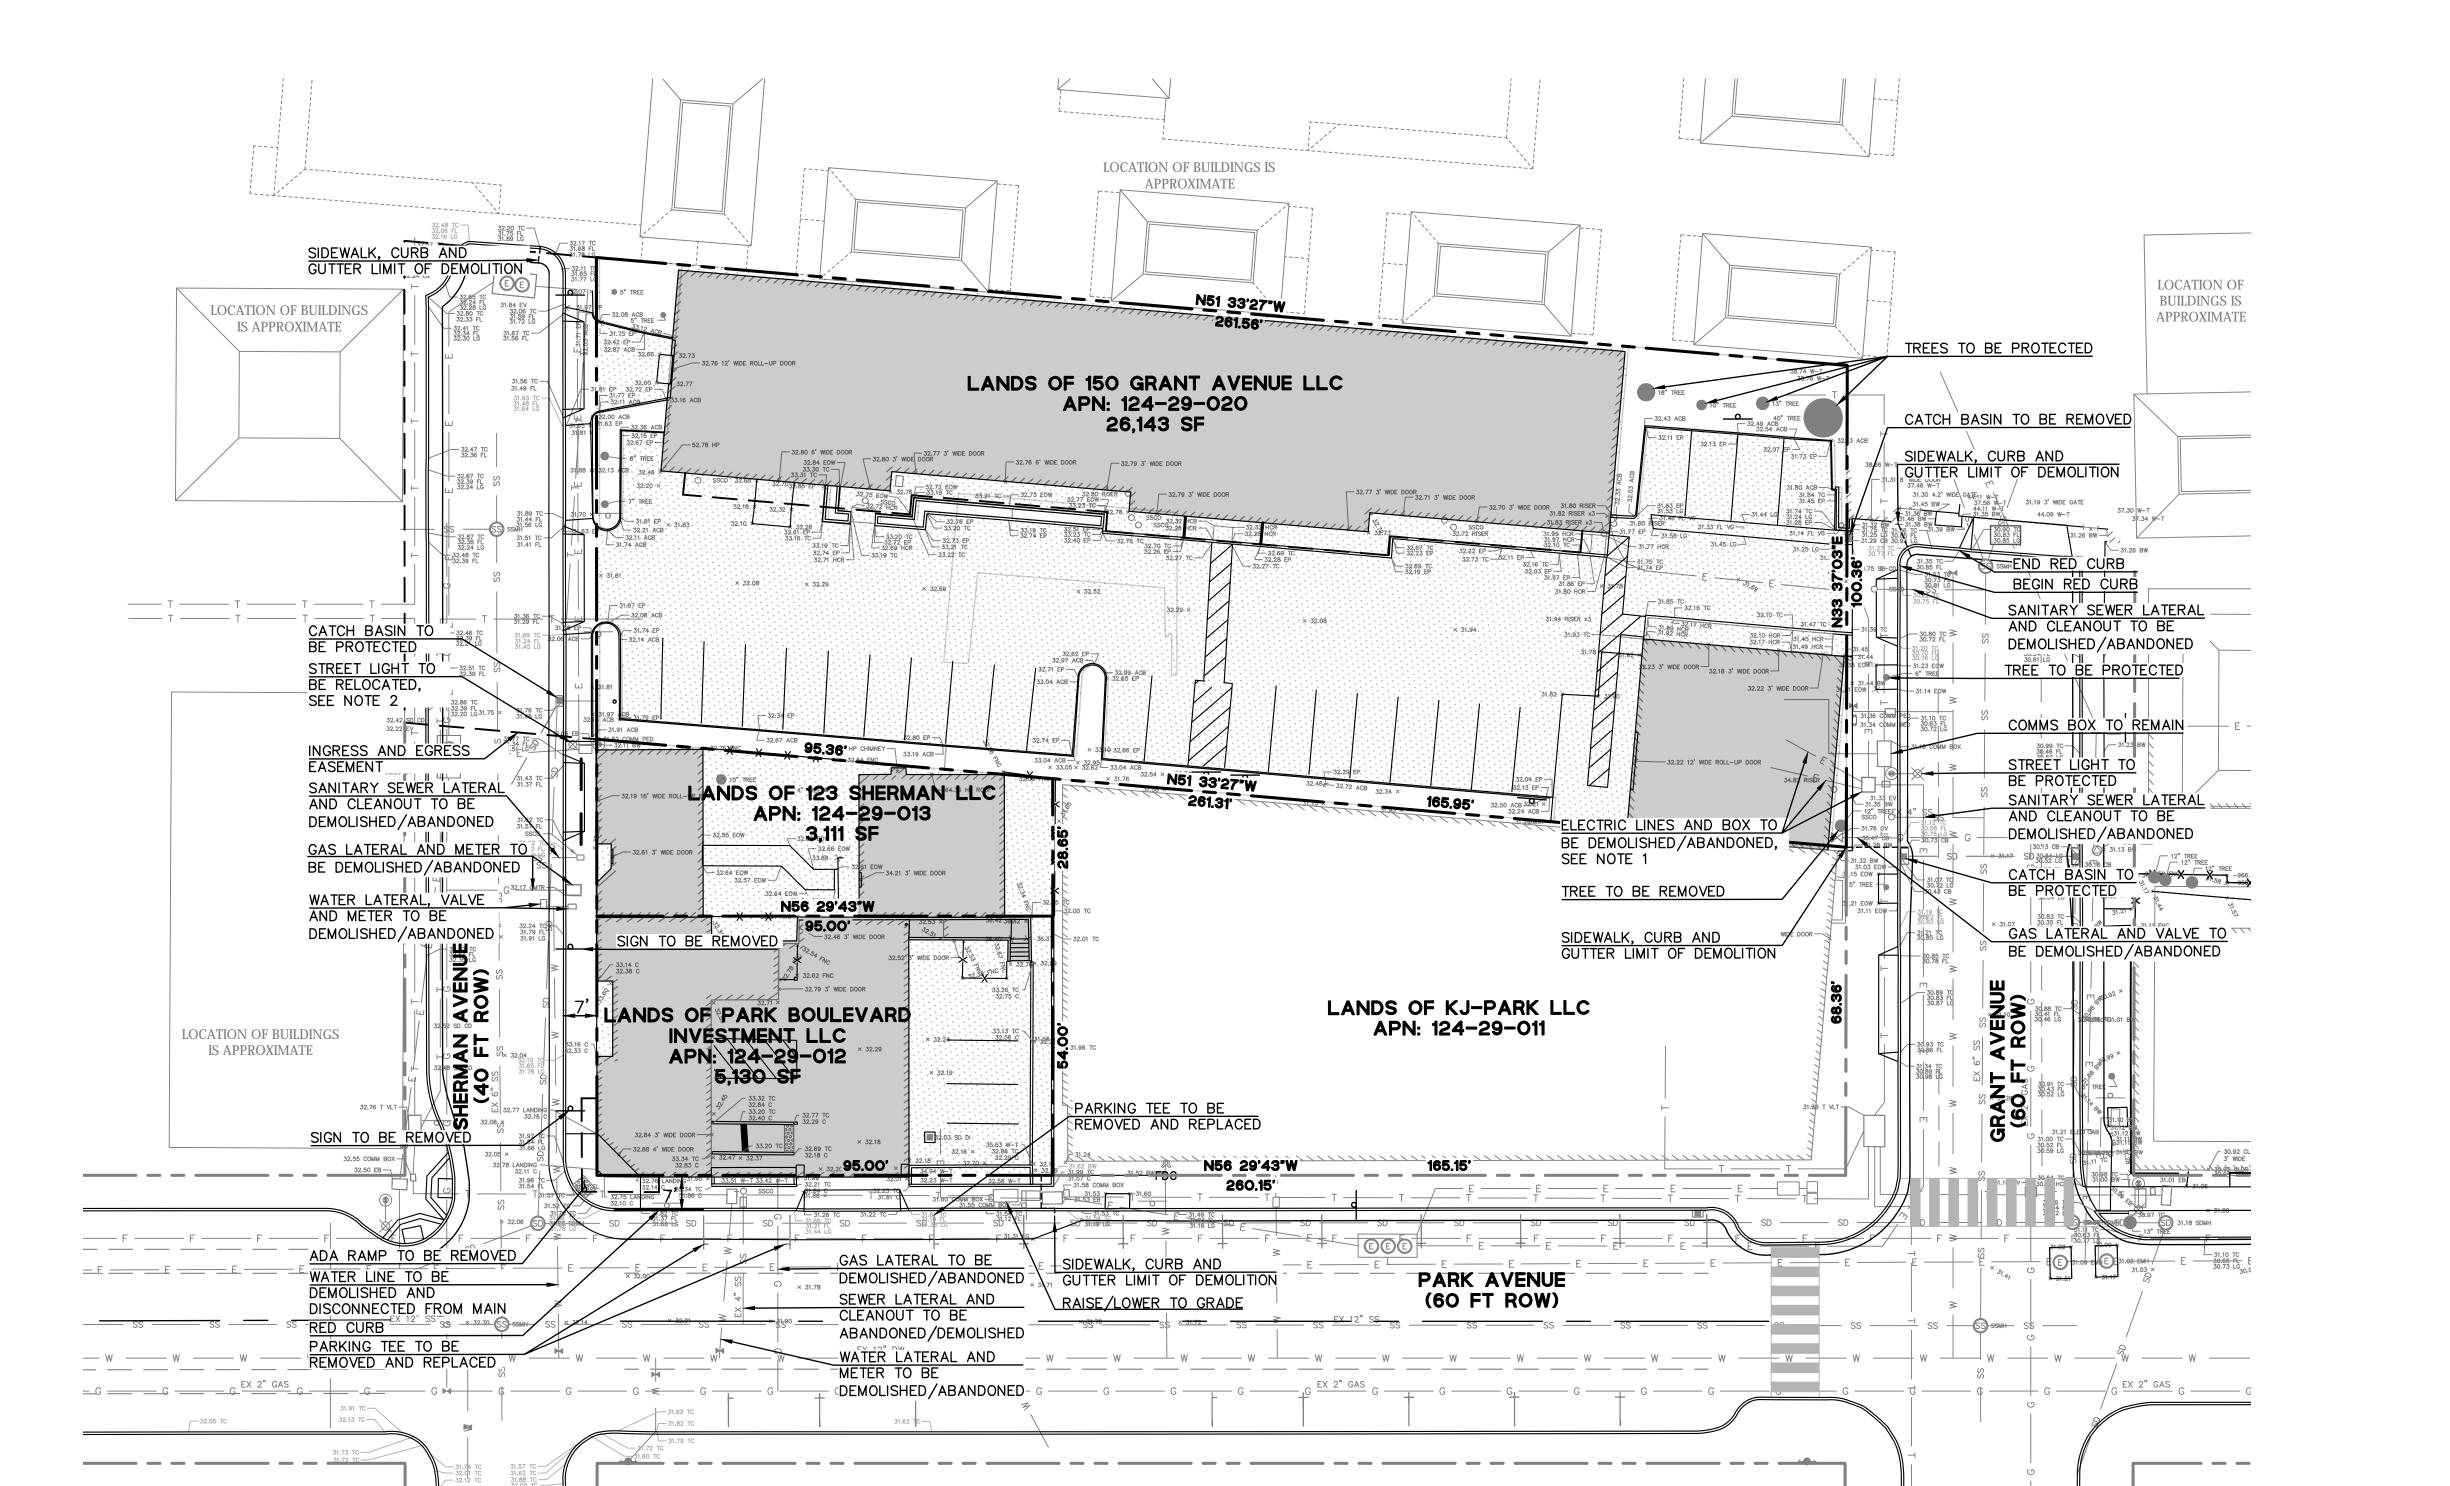

LEGEND:

	- PROPERTY LINE
	— ADJACENT PROPERTY LINE
— —	— EASEMENT
——X—	—X— EX FENCE
— ss —	— SS — EX SANITARY SEWER LINE
	EX STORM DRAIN LINE
W	— w — EX DOMESTIC WATER LINE
— T —	T EX COMMUNICATIONS LINE
— Е —	— E — EX ELECTRIC LINE
— ОН —	OH EX OVERHEAD LINE
—— GAS ——	— GAS — EX GAS LINE
— P —	— P — EX PETROLEUM LINE

BUILDING TO BE DEMOLISHED PAVEMENT TO BE DEMOLISHED

EX TREE EX SANITARY SEWER MANHOLE EX STORM DRAIN MANHOLE


EX ELECTRIC MANHOLE EX WATER VALVE

EX HYDRANT EX STORM DRAIN CATCH BASIN EX GAS METER

EX STREET LIGHT EX SIGN

NOTE:

- 1. DEACTIVAION AND REMOVAL OF ELECTRIC LINE TO BE COORDINATED WITH CPAU PRIOR TO REMOVAL OF VAULT.
- 2. REMOVAL OF STREET LIGHT TO BE COORDINATED WITH CPAU. CPAU TO DEMOLISH THE LIGHT, APPLICANT TO DEMOLISH THE BASE.

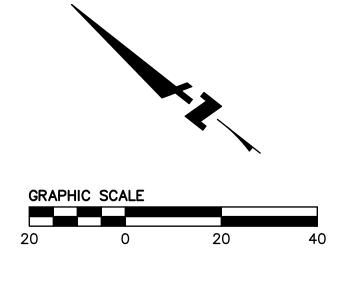


VENUE

SHERM/ TIONS 123 ONDI

Drawing Number:

SD1.0

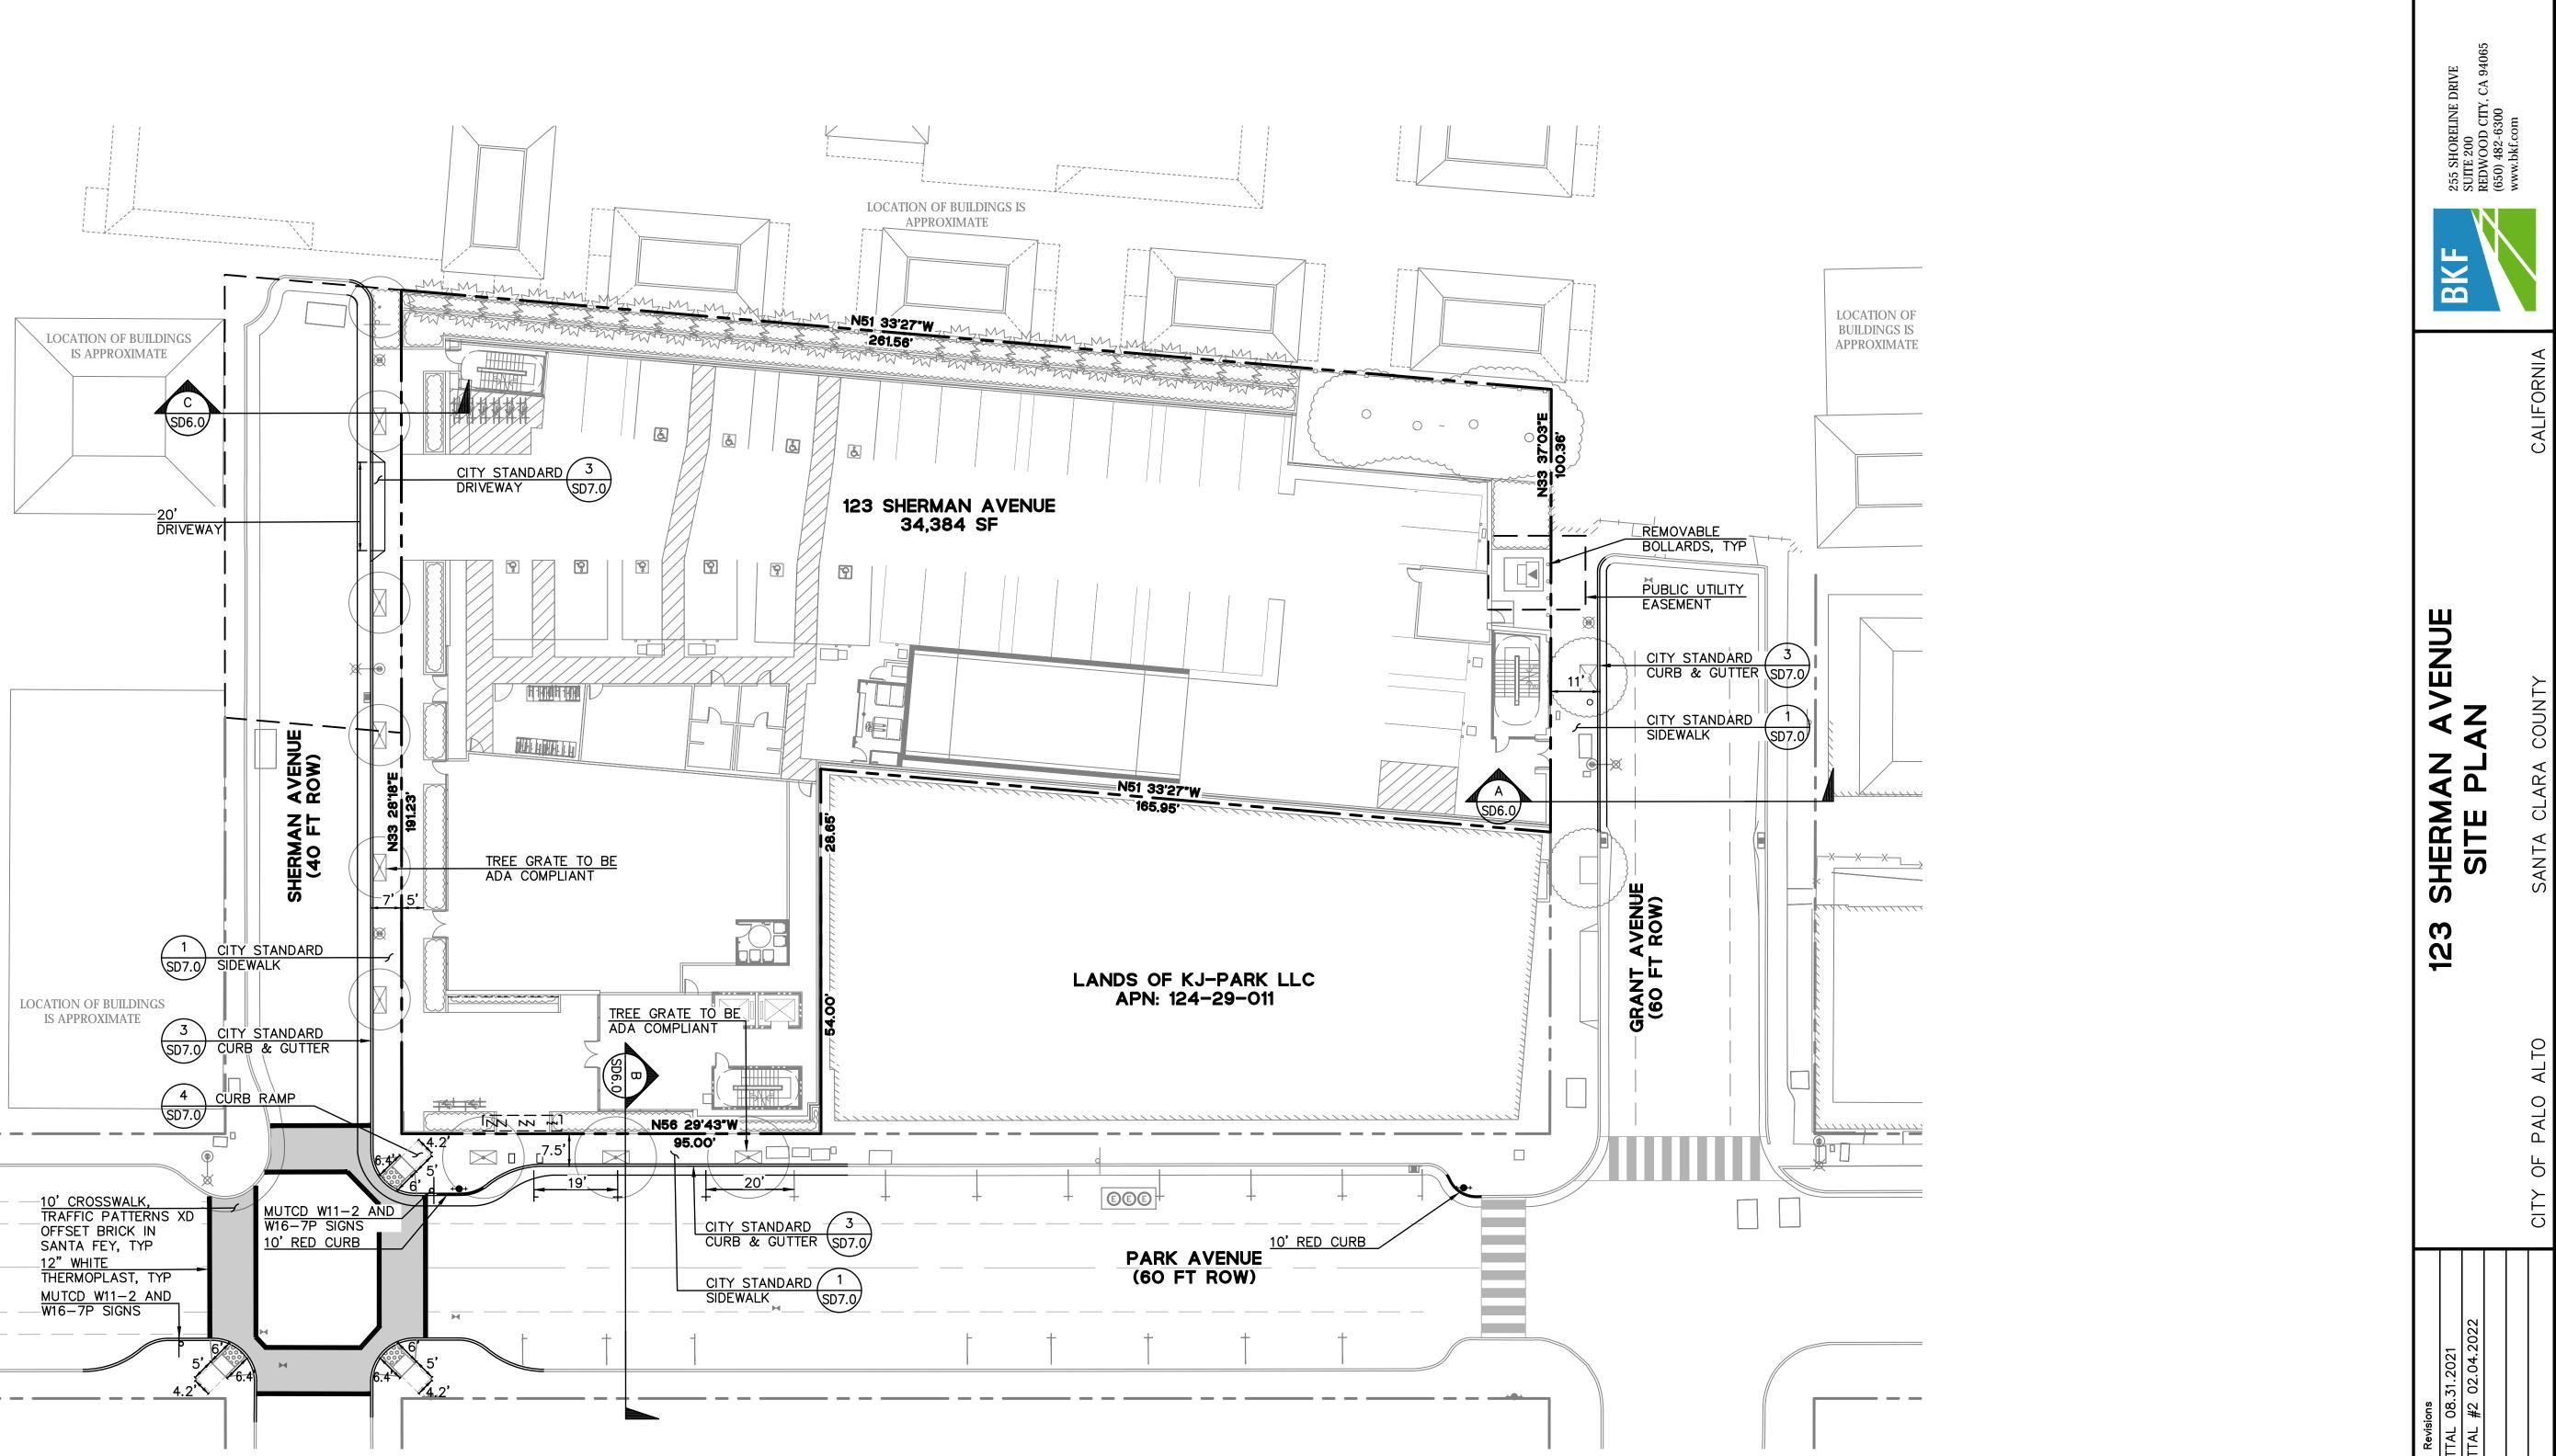

LEGEND:

PROPERTY LINE
ADJACENT PROPERTY LINE
EASEMENT

BUILDING OVERHANG

GROUND LEVEL OPEN TO SKY ABOVE

GRAPHIC SCALE
20 0 20 40


Date 05/27/2021 No. Revis Scale 1" = 20' 1 PLANNING RESUBMITTAL Design MS 2 PLANNING RESUBMITTAL Drawn LER 2 PLANNING RESUBMITTAL Approved RKB 2 PLANNING RESUBMITTAL


SD2 0




SHERMAN A 123 FIRI


LOCATION OF BUILDINGS
IS APPROXIMATE MOTION 1

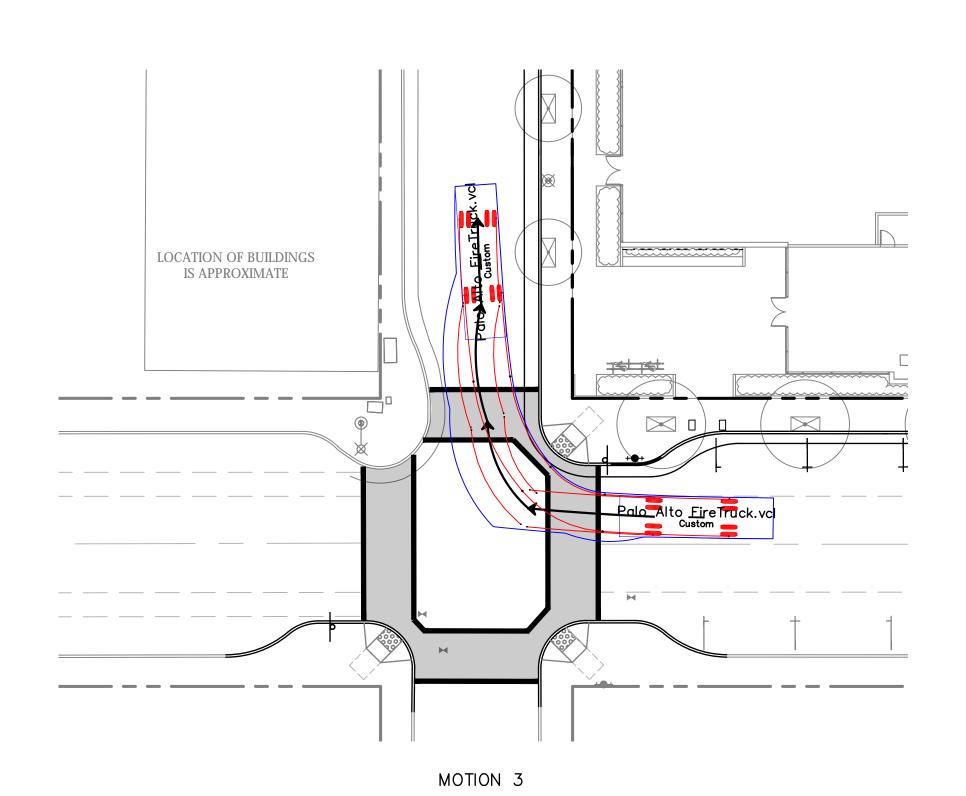

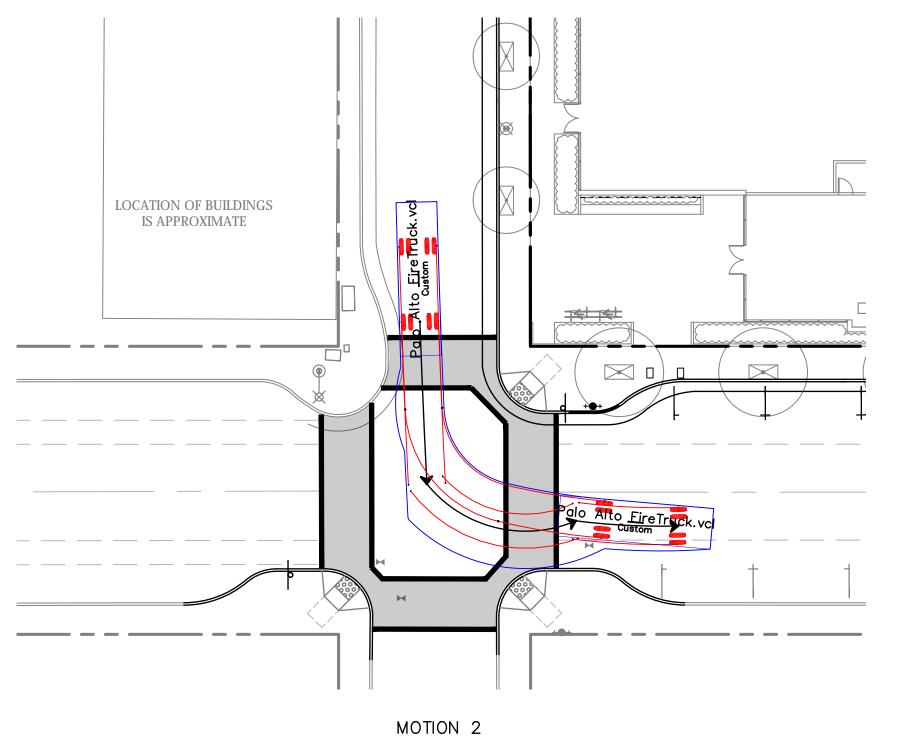

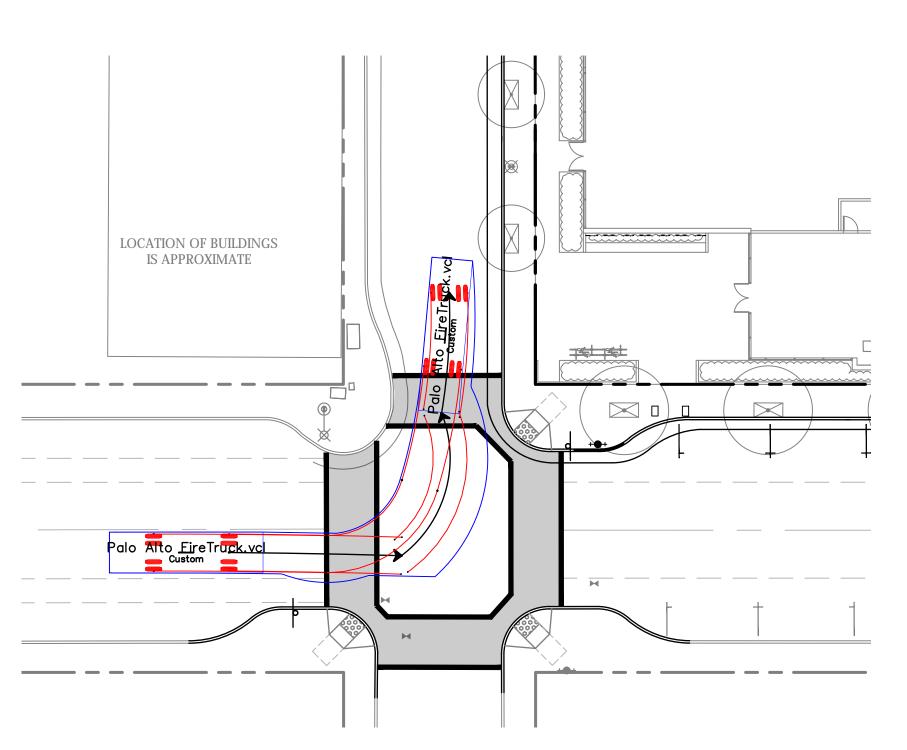

RAPHI									
			40						
	O	20	40						

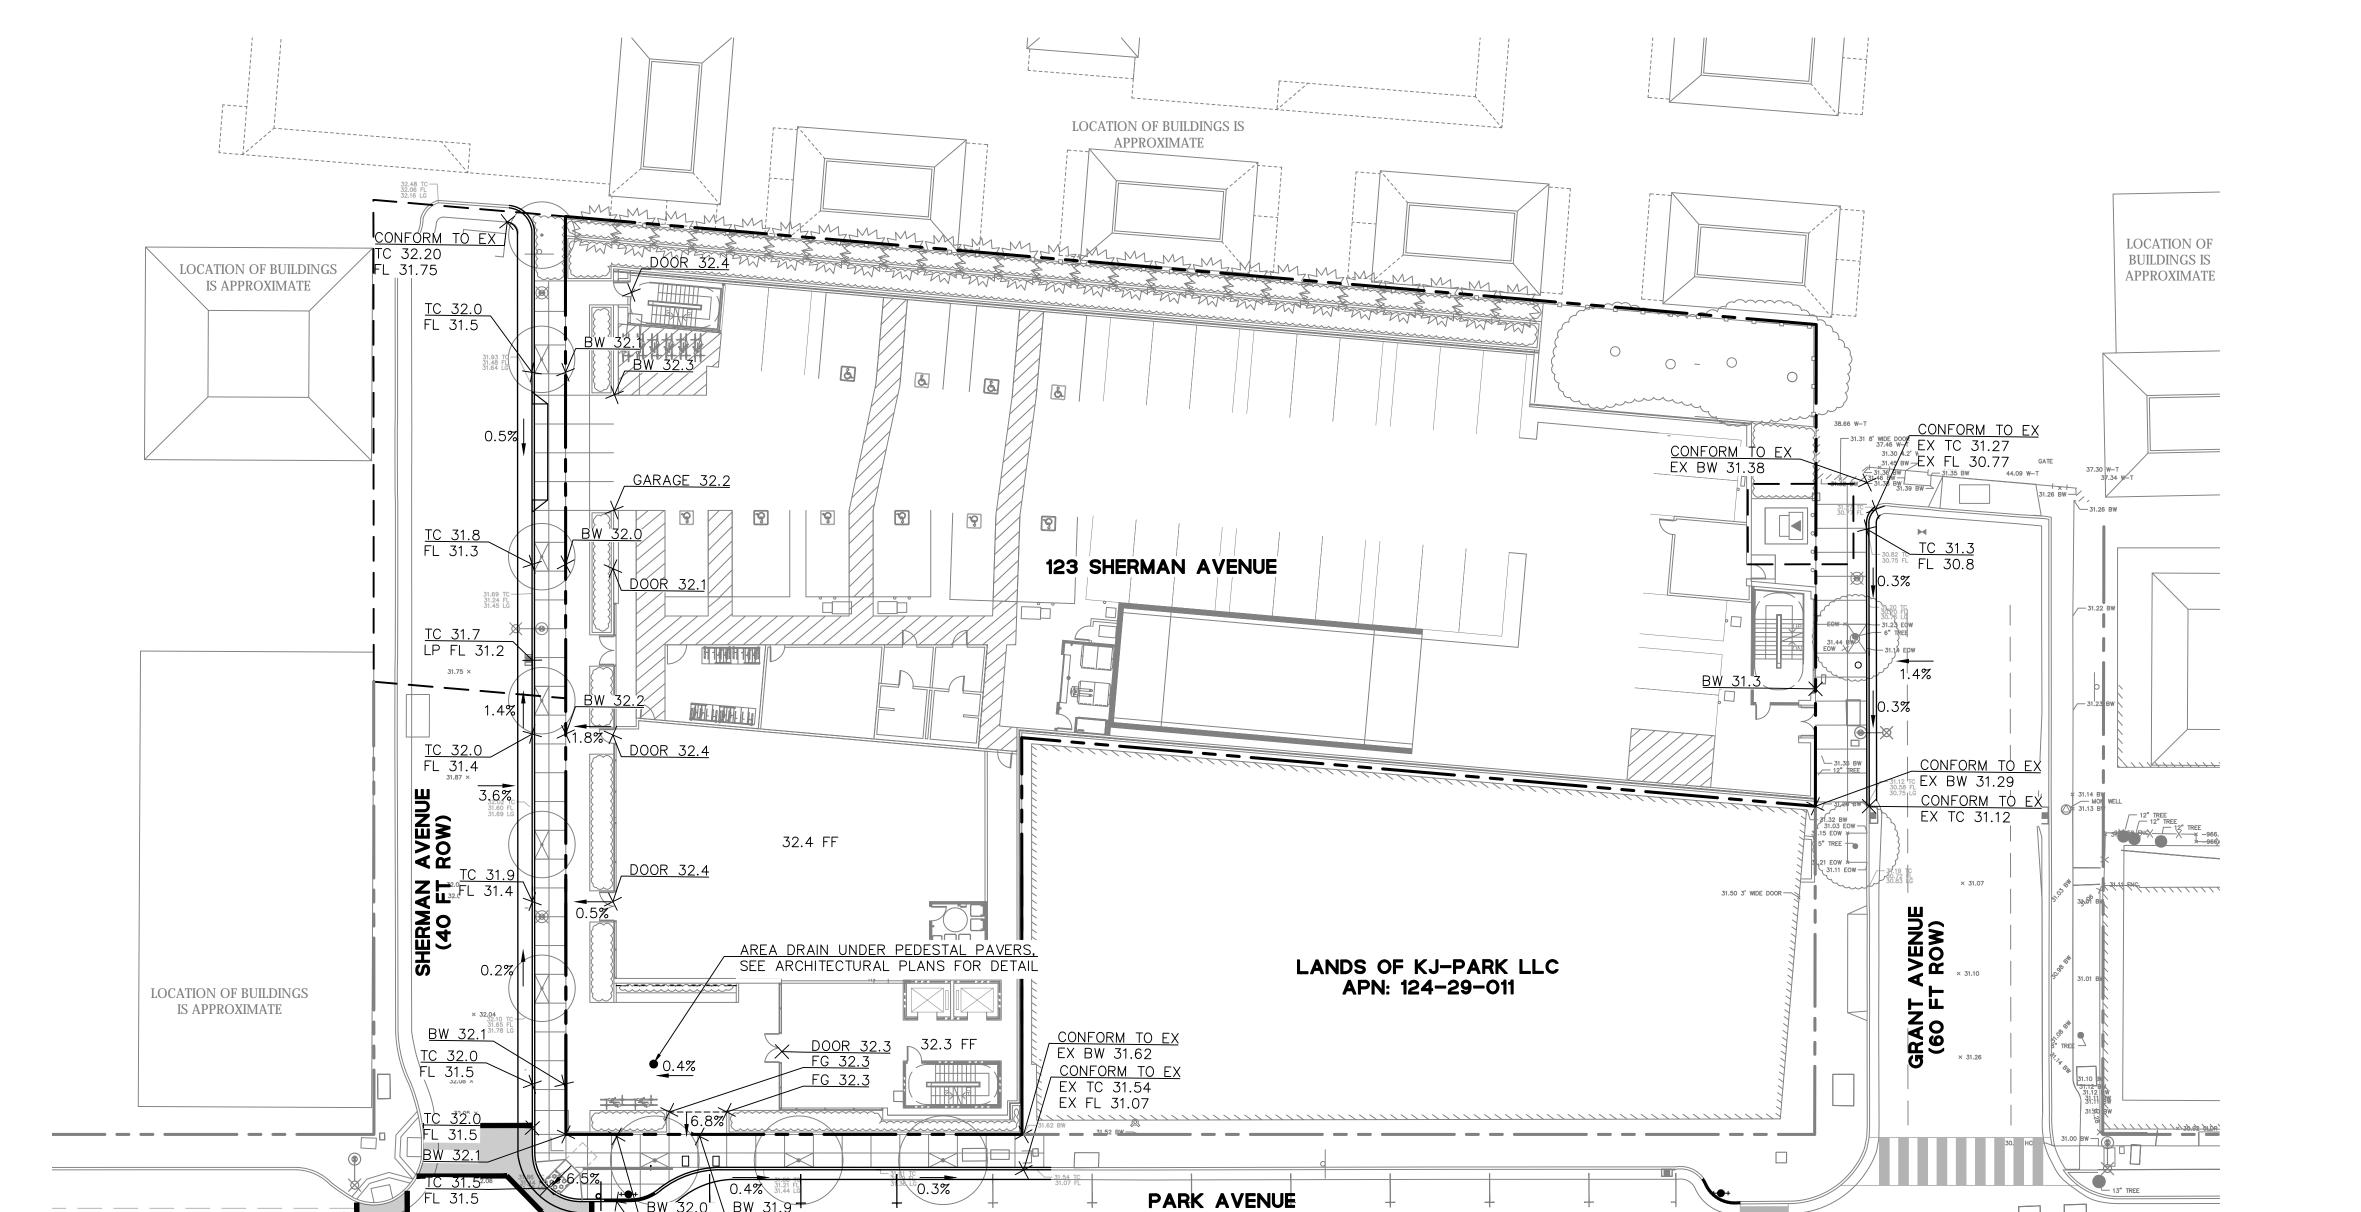

(60 FT ROW)

LEGEND:

PROPERTY LINE
ADJACENT PROPERTY LINE
EASEMENT

---- GRADE BREAK

BUILDING OVERHANG

GROUND LEVEL OPEN TO SKY ABOVE

TC 31.9 FL 31.4

× 31.75

GRAPHIC SCALE
20 0 20

BKF

GRADING PLAN

CITY OF PALO ALTO


Date 05/27/2021 No.

Scale 1" = 20' 1


Design MS 2

Drawn LER
Approved RKB
Job No 20210512

SD3.0

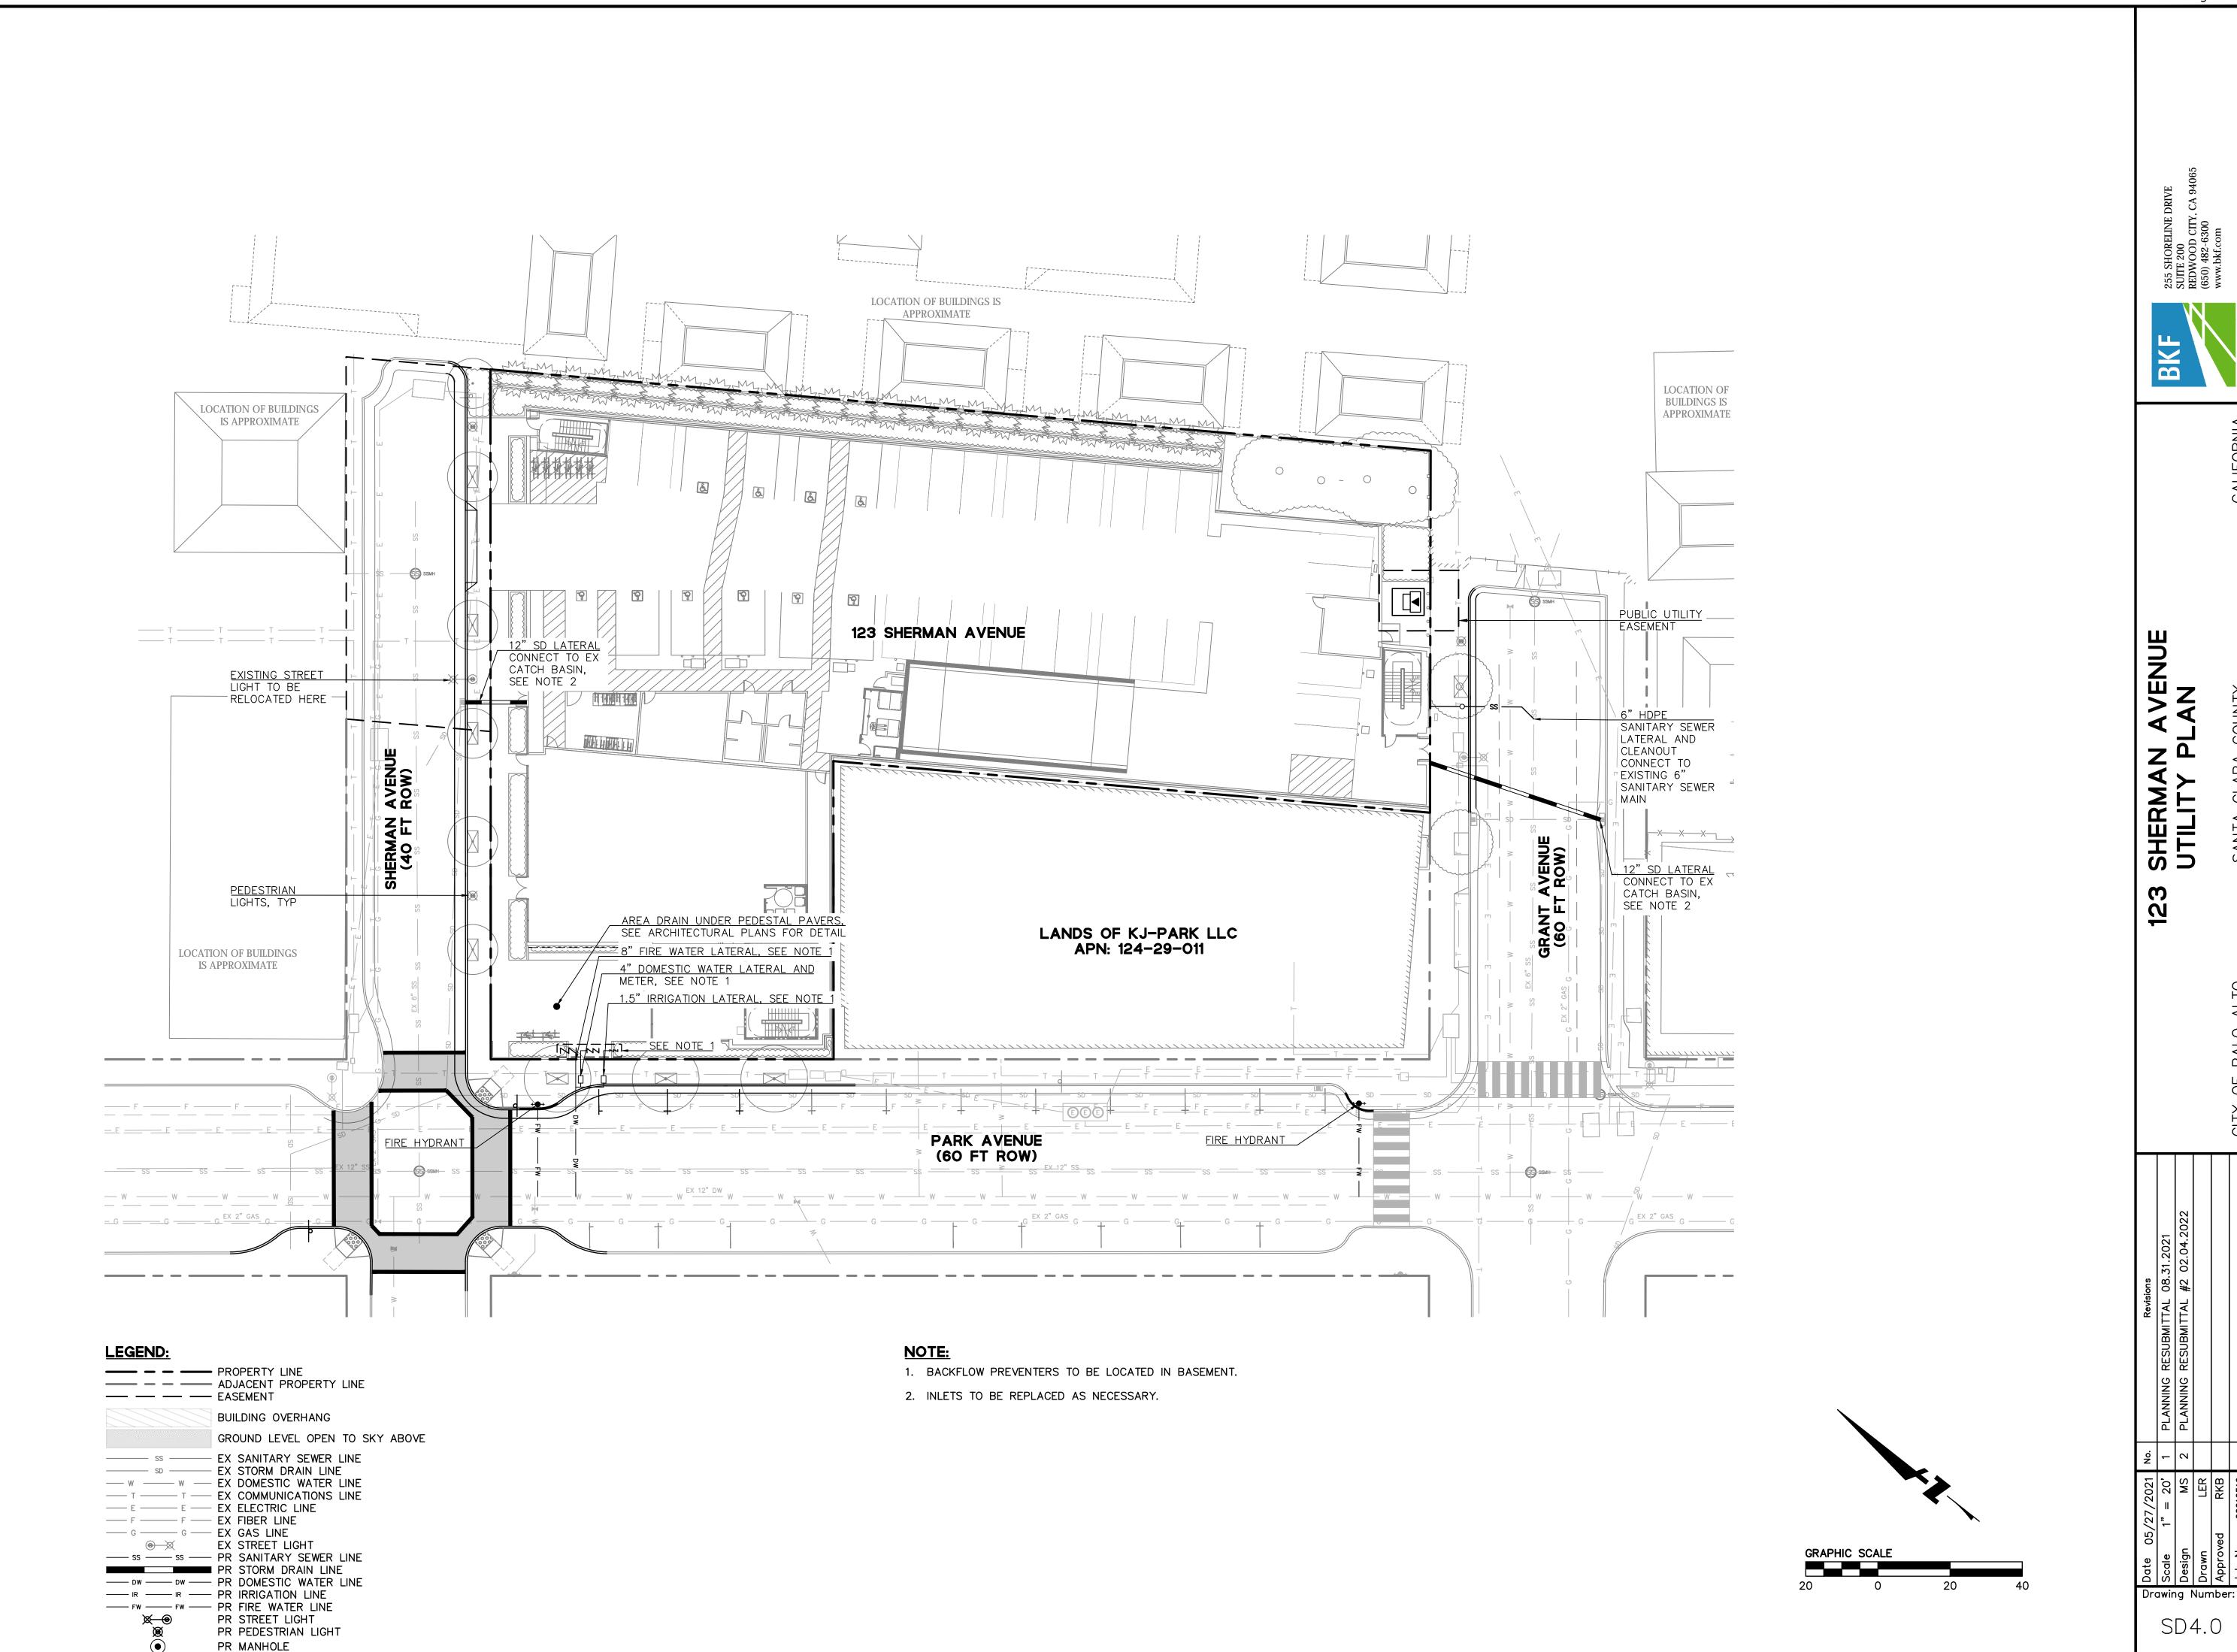


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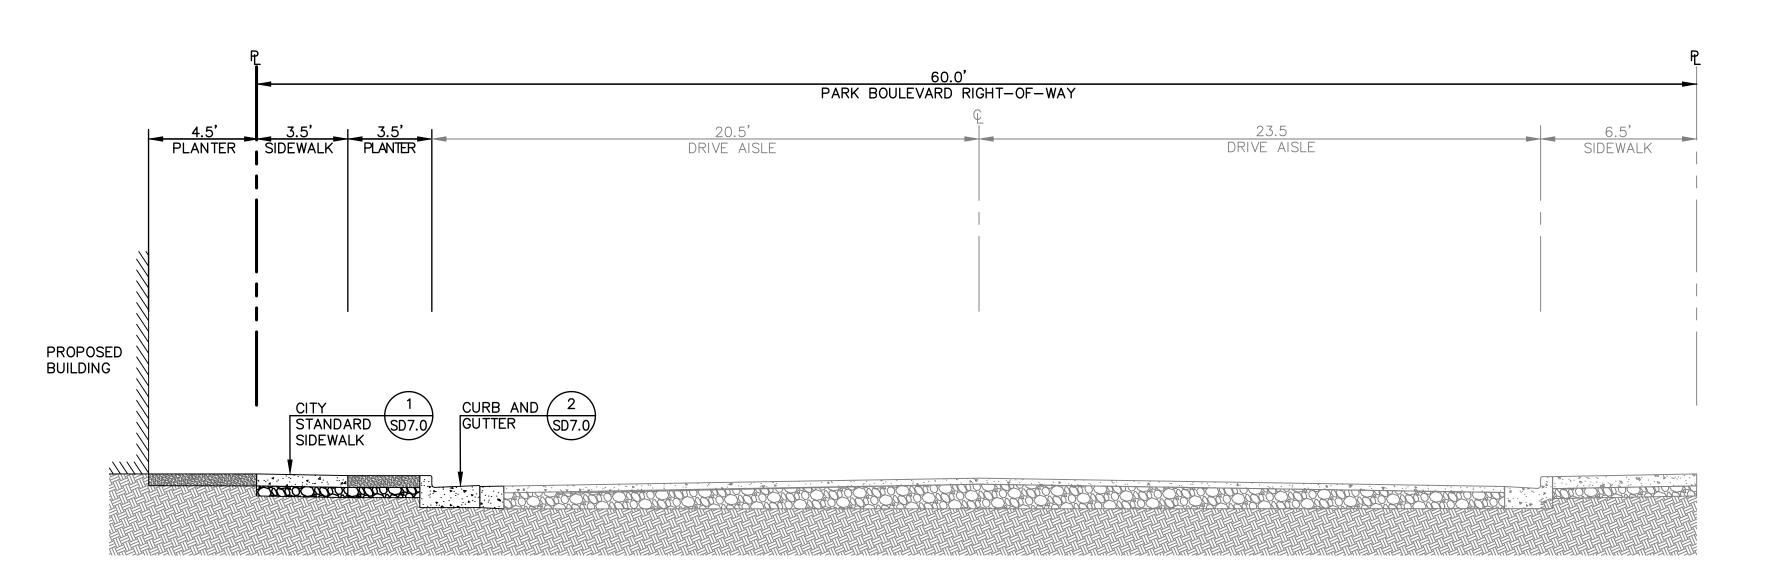

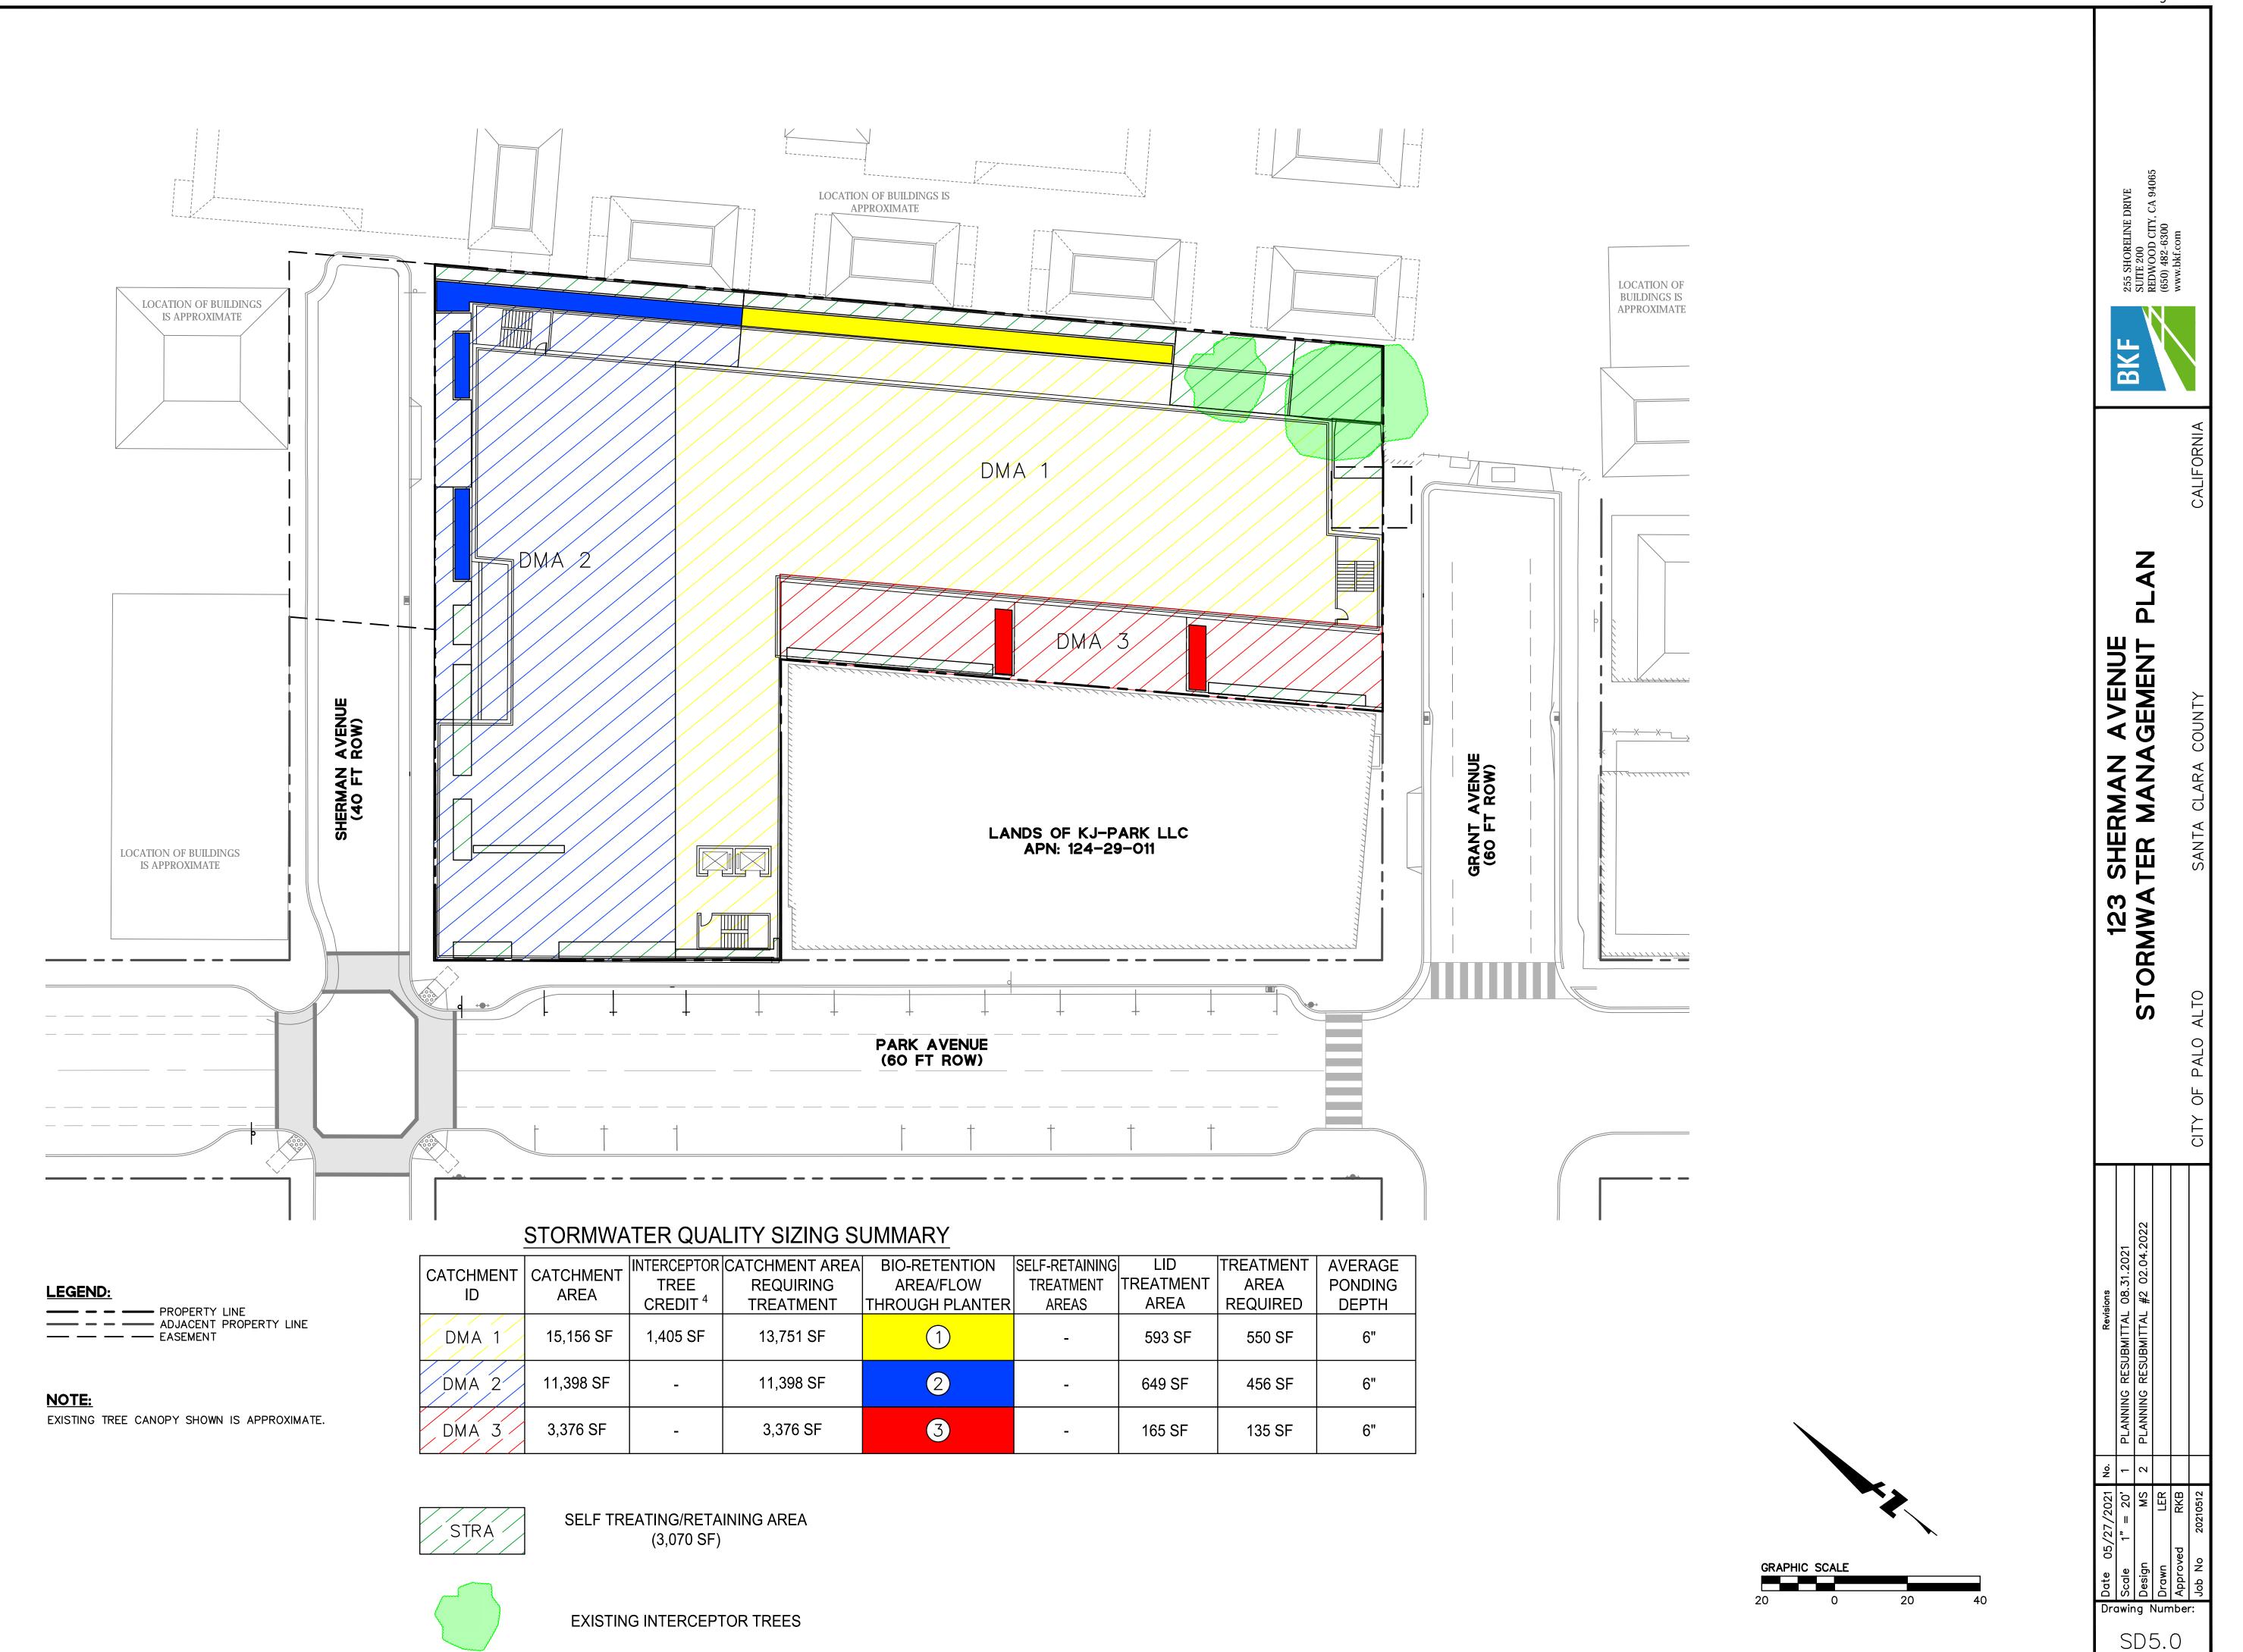
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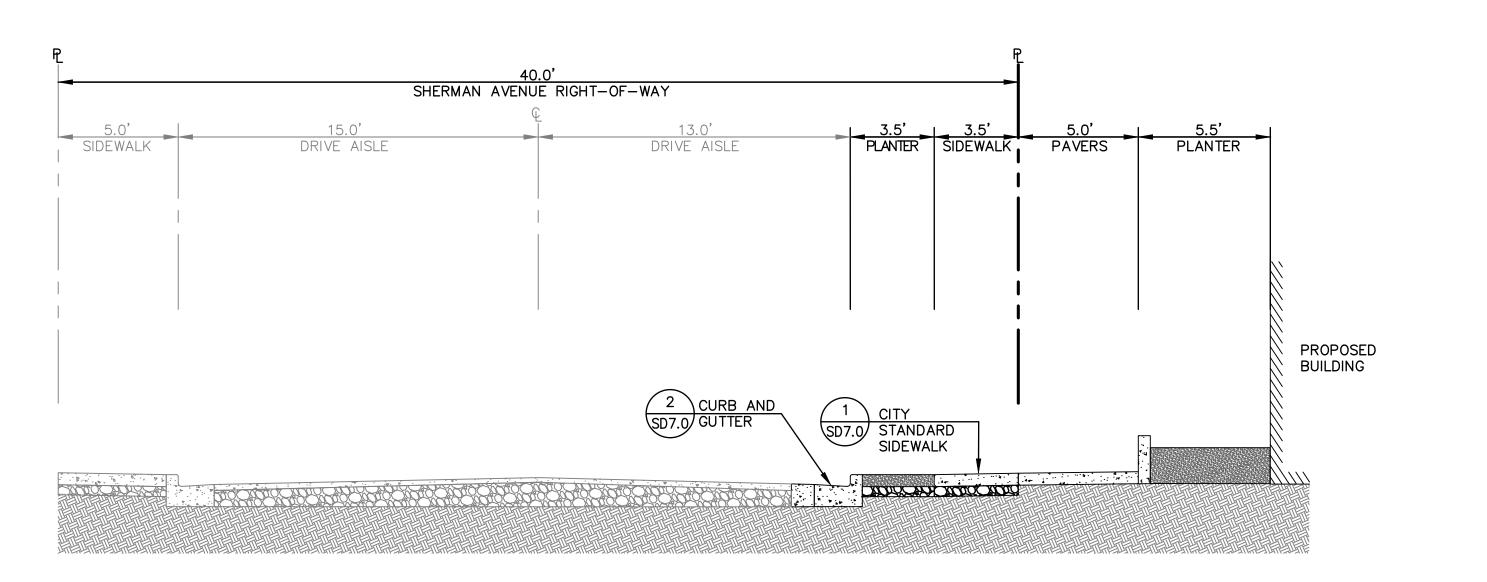
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SECTION A NOT TO SCALE




SECTION B NOT TO SCALE

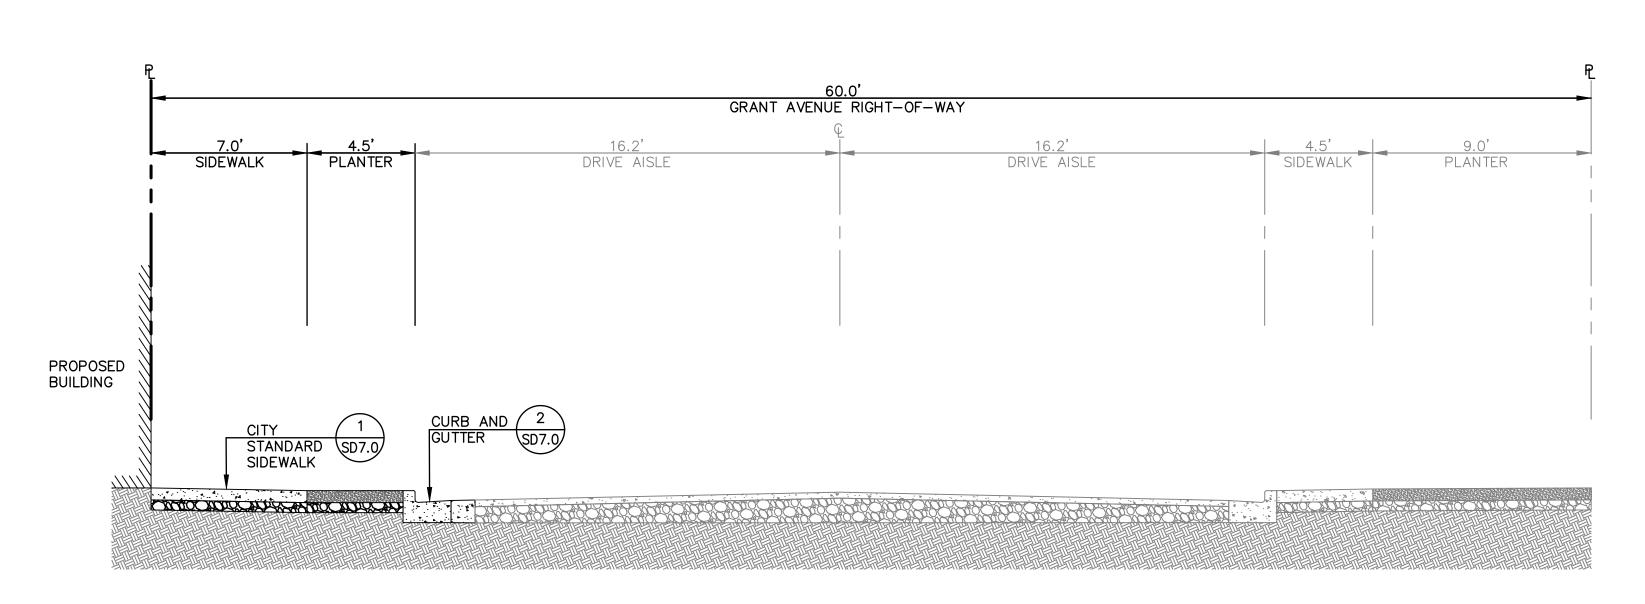


SHERMAN DETAIL


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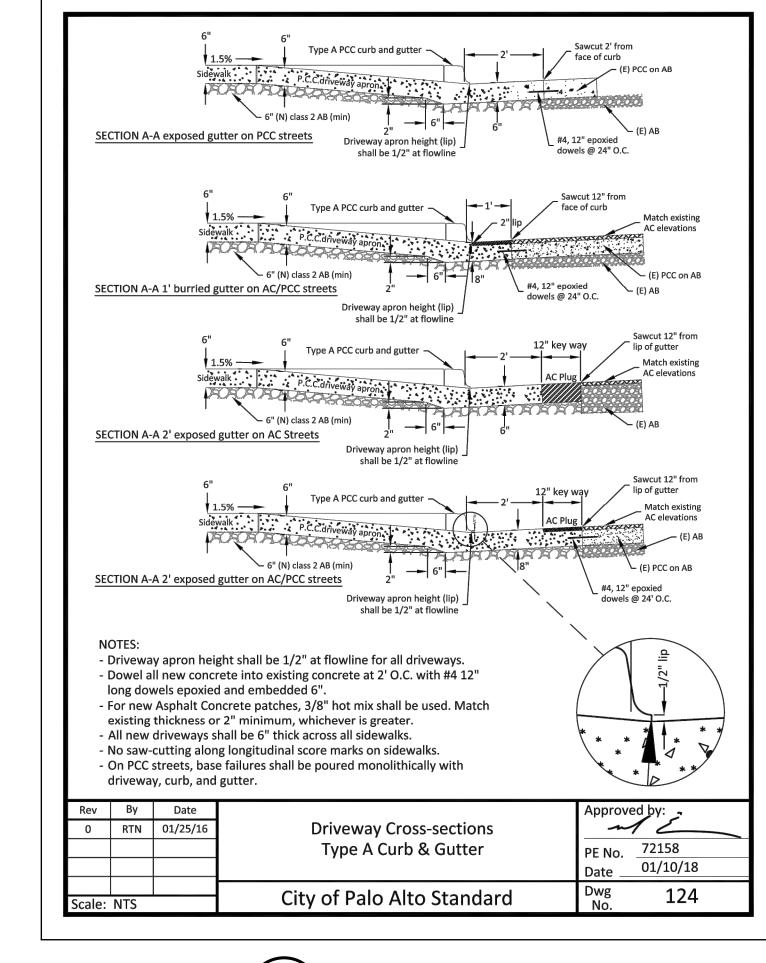
SD7.0



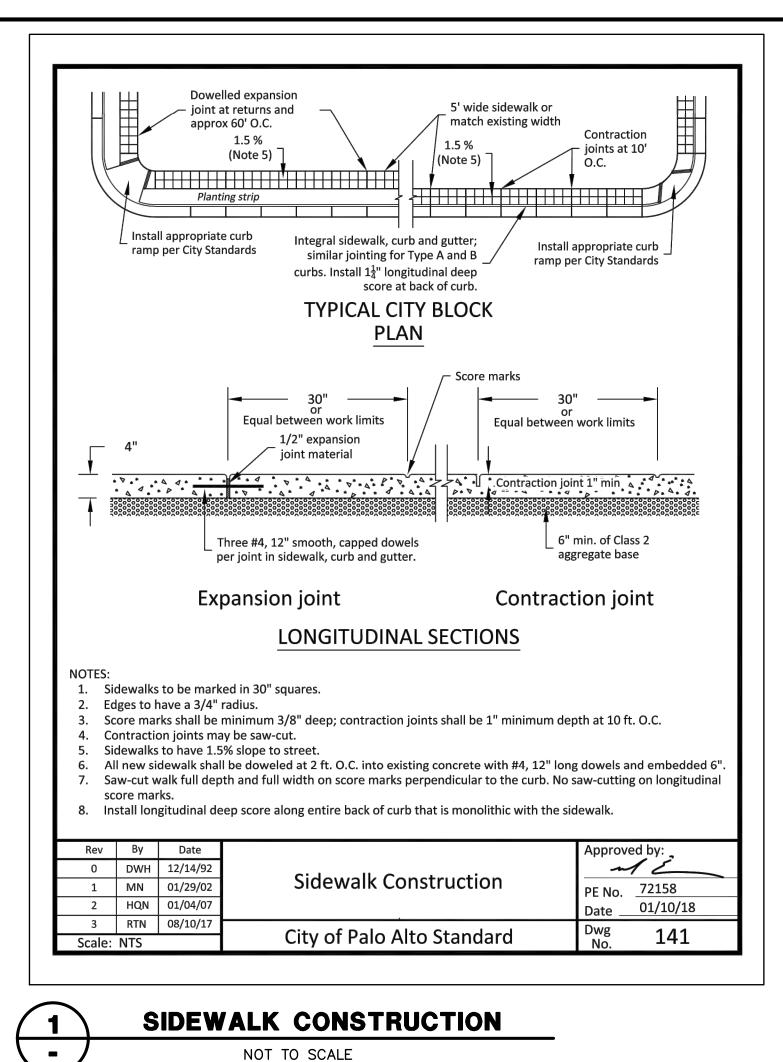


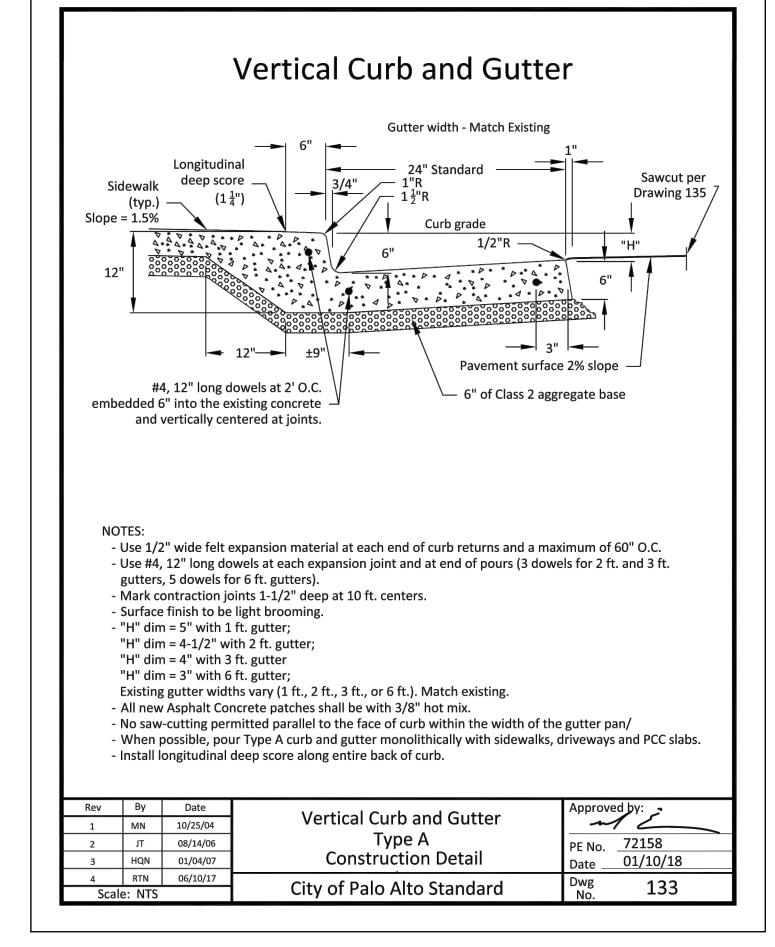



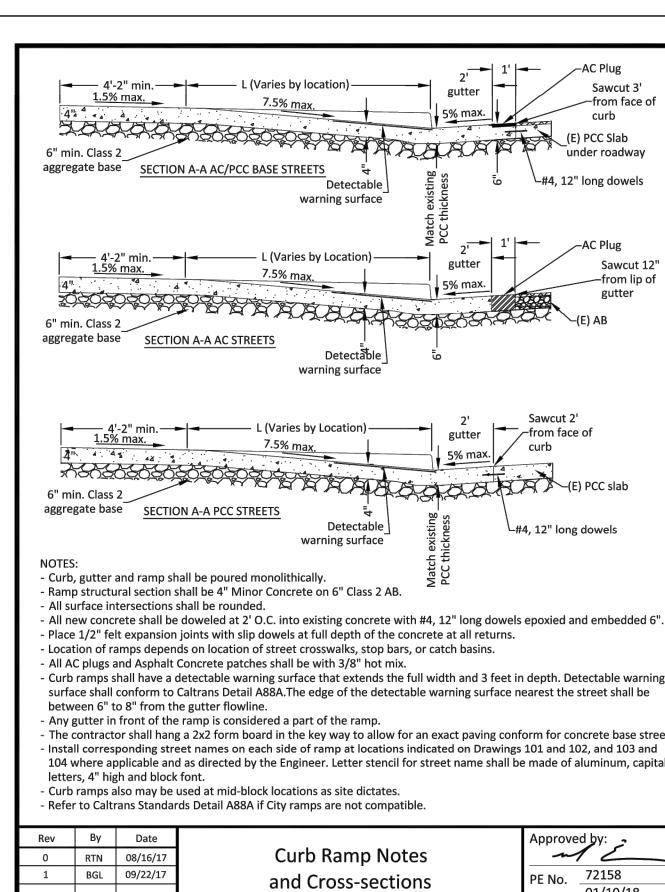

3	DRIVEWAY	
<u>-</u>	NOT TO SCALE	

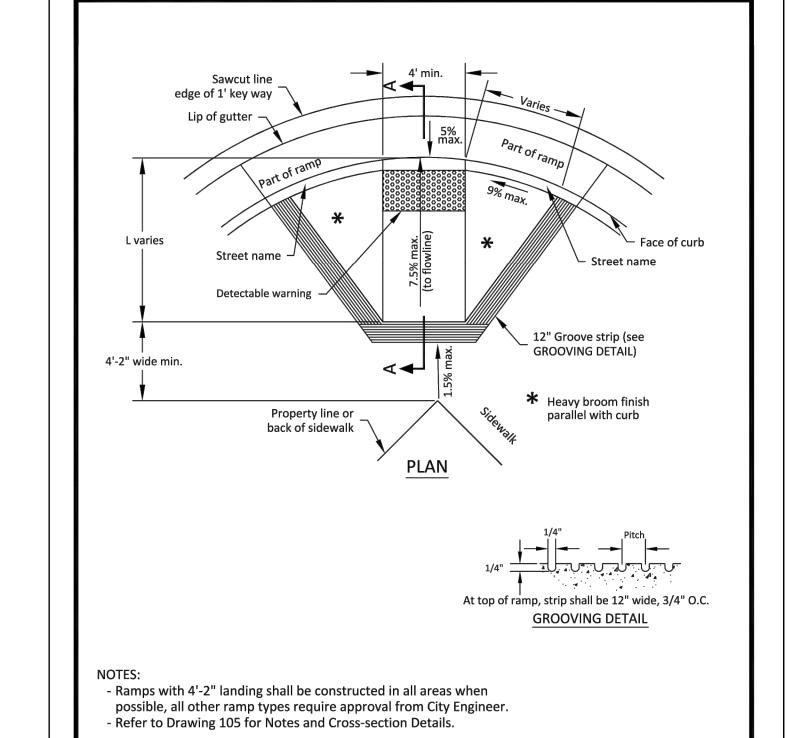

Curb Ramp With 4'-2" Landing

City of Palo Alto Standard

Rev By Date 1 MMN 02/21/14

2 RTN 06/10/17


Scale: NTS

		max.	7.5% max.	gutter	from face of
4"2	4 4 4	4 S S		5% max.	curb
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6" mi	n. Class	2		SURUA F	under roadway
aggreg	gate bas	e SECTIO	N A-A AC/PCC BASE STREETS 🛂 🛴]	\
			Detectable	PCC thickness	∕-#4, 12" long dowels
			warning surface أَ	S	
			<u>-</u>	-	
			,	2 0	
				≥	AC Plug
-	—— 4'-; 1 5%	2" min. —— 6 max.	L (Varies by Location)	gutter	Sawcut 12"
·411	1	Tillax,	7.5% max.	lı - I	from lip of
4"	1000			5% max.	gutter
THE STATE OF THE S	A COM	\$ \$ \$ \$ \$ \$ \$ \$ \$ \$ \$ \$ \$ \$ \$ \$ \$ \$ \$	HADADAAA		
6" mir	n. Class	2		00000000000000000000000000000000000000	(E) AB
aggreg	gate base	e SECTIO	ON A-A AC STREETS		
			Detectable	-9	
			warning surface		
1			I (Varias bullacation)	. 2'	Sawcut 2'
	4' 1.5%	'-2" min. —• 6 max.	L (Varies by Location)	gutter	from face of
21"			7.5% max.	5% max.	/ curb
\supset	ZZ	ACARA		11	
Ж	سر برير				(E) PCC slab
	in. Class		THE PARTY OF THE P	ALALA .	27 47 (2) (2)
aggre	gate bas	e <u>SECTIO</u>	ON A-A PCC STREETS 4	[∞] ~ /	1
			Detectable_	stin	└#4, 12" long dowels
			warning surface	ž ž	
NOTES	i :			Match existing PCC thickness	
			all be poured monolithically.	P dai	
			shall be 4" Minor Concrete on 6" Class 2 AB.	_	
			shall be rounded.		
			doweled at 2' O.C. into existing concrete with #4		
			joints with slip dowels at full depth of the concre		S.
			ds on location of street crosswalks, stop bars, or of Concrete patches shall be with 3/8" hot mix.	cattii bdSiiiS.	
			detectable warning surface that extends the full v	width and 3 fee	et in depth. Detectable warning
surfa	ce shall	conform to	Caltrans Detail A88A.The edge of the detectable	warning surfac	e nearest the street shall be
			e gutter flowline.		
- Any g	gutter in	front of the	ramp is considered a part of the ramp.		
			g a 2x2 form board in the key way to allow for an		
			eet names on each side of ramp at locations indic		
			d as directed by the Engineer. Letter stencil for st	reet name shal	i be made of aluminum, capital
		gh and block	tont. used at mid-block locations as site dictates.		
			ds Detail A88A if City ramps are not compatible.		
	Ву	Date			Approved by:
Rev			Curb Ramp Notes		m//_
		08/16/17			
0	RTN	08/16/17	·		72150
		08/16/17 09/22/17	and Cross-sections		PE No. 72158
0	RTN		·		PE No. 72158 Date 01/10/18
0	RTN BGL		·	S	01/10/19

CURB RAMP NOT TO SCALE

72158

01/10/18

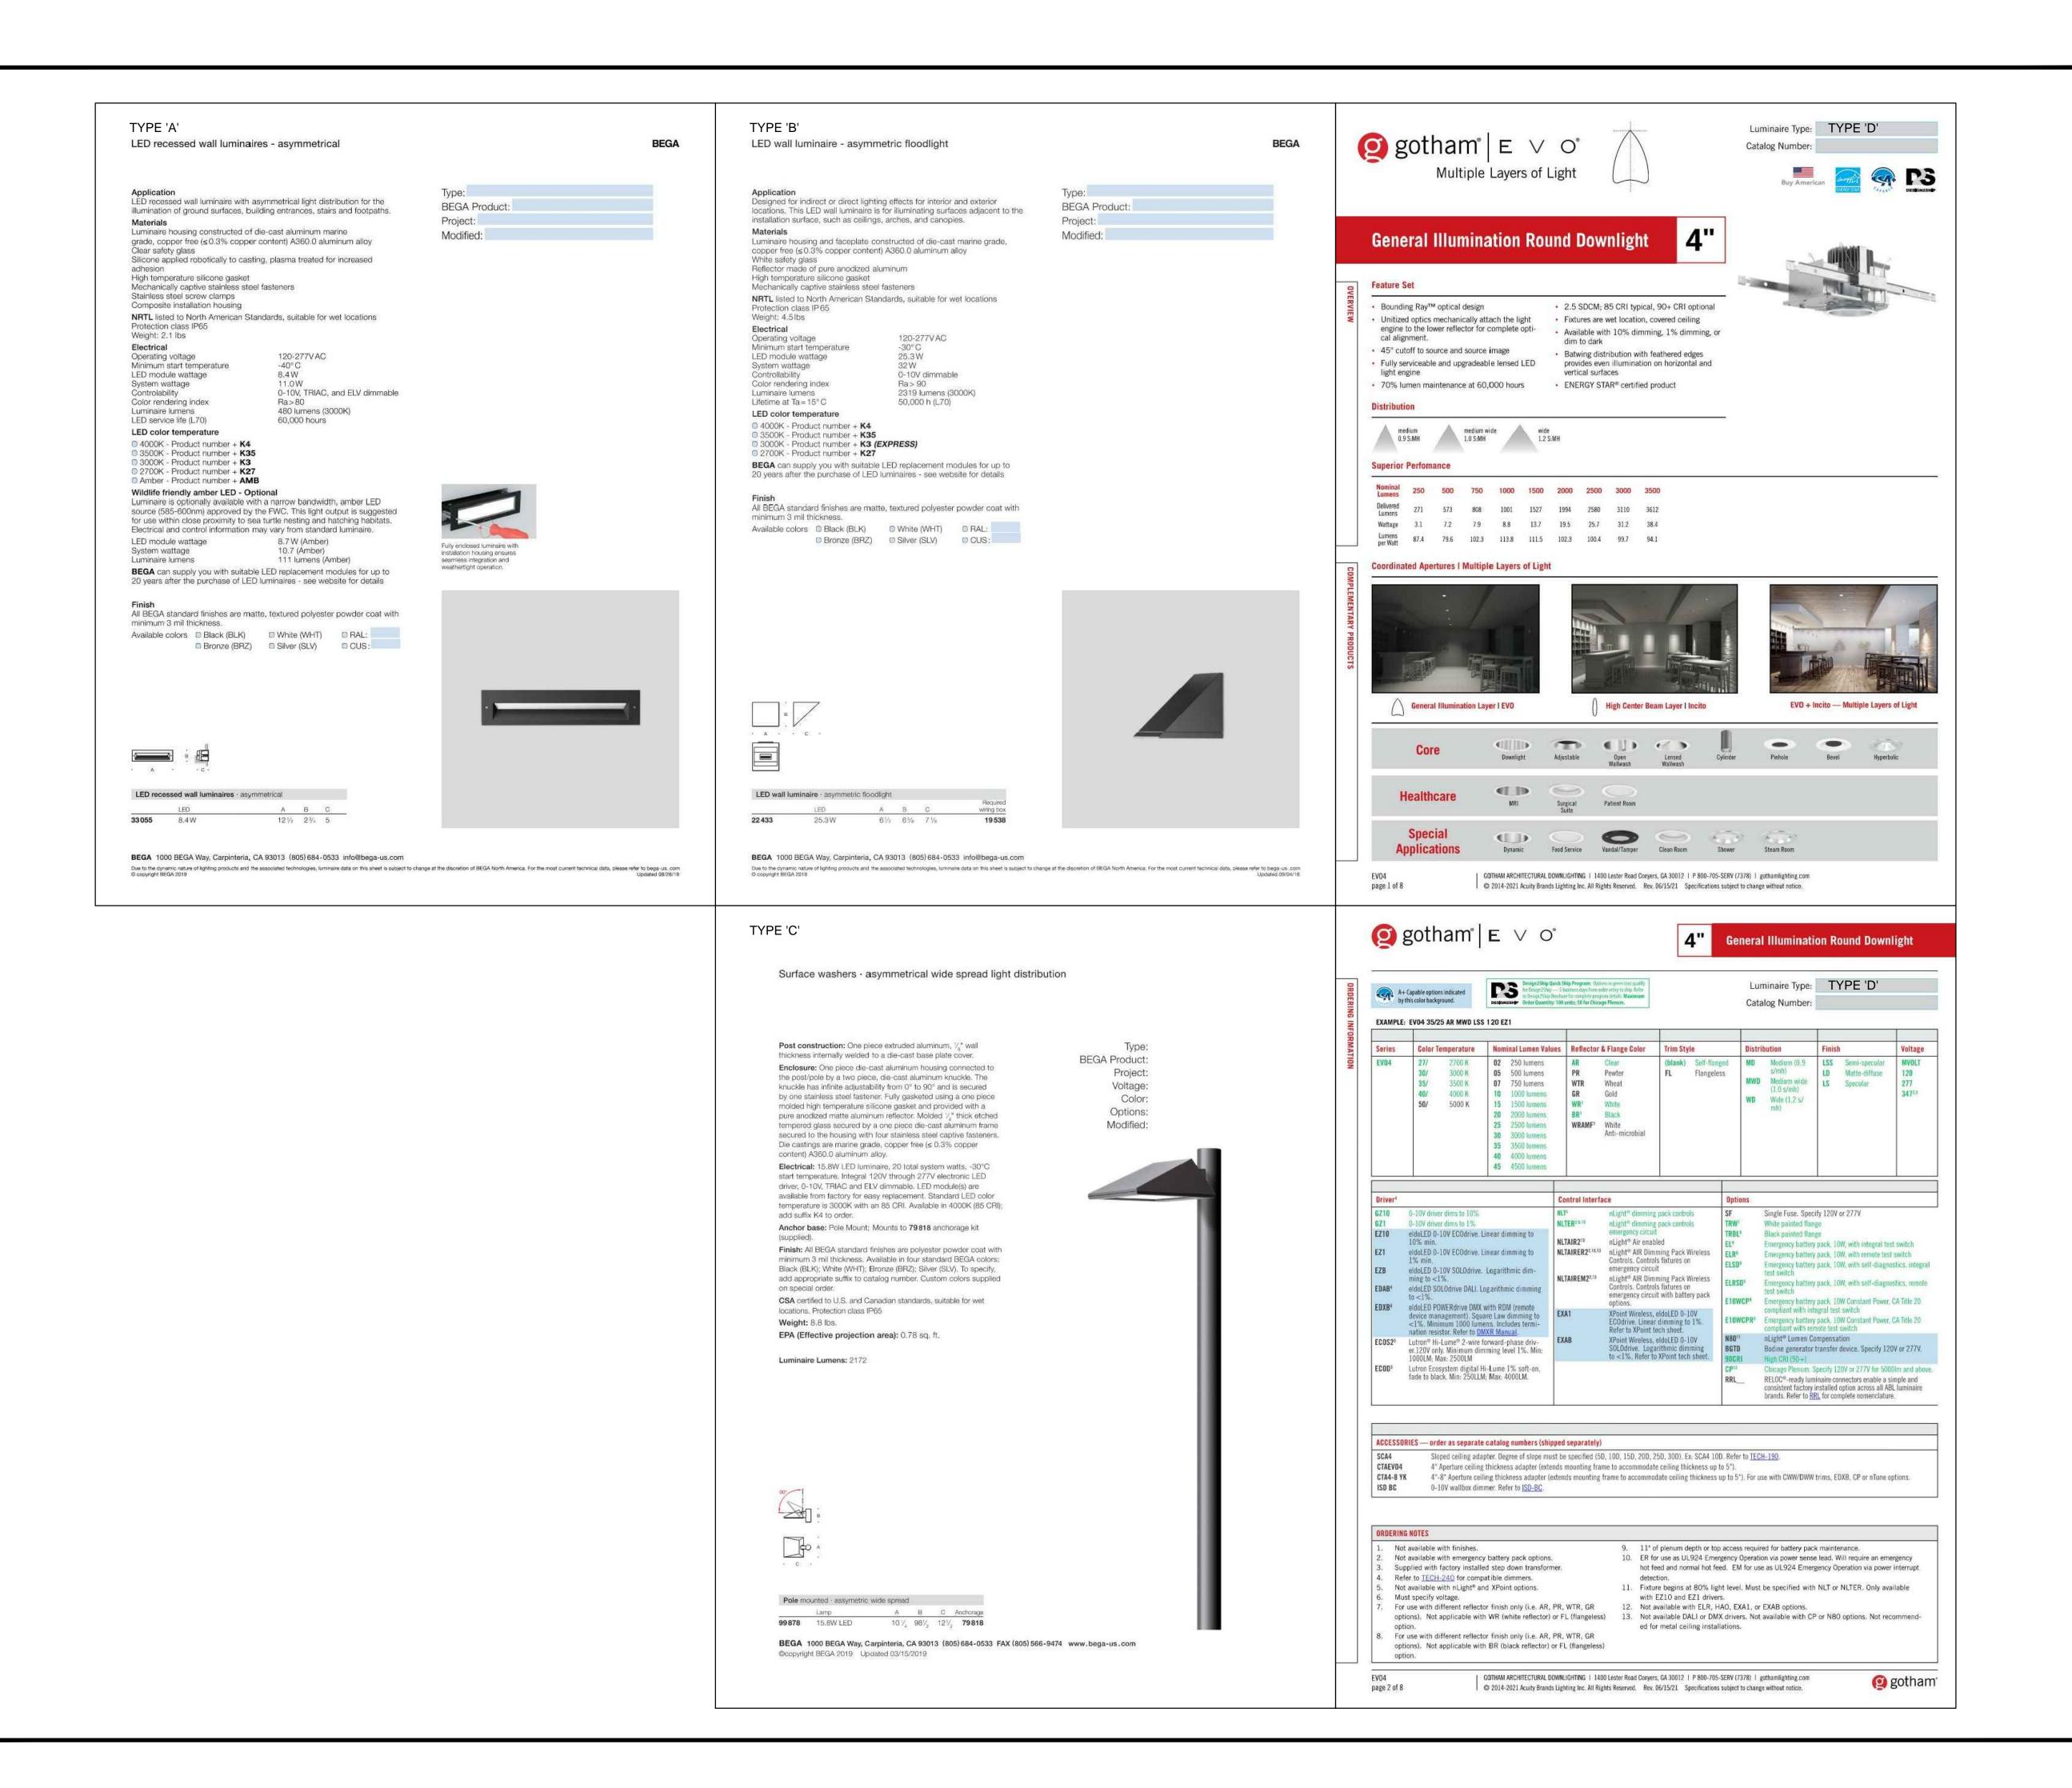

2625 PARK BLVD PALO ALTO, CA 94306



ISSUES AND REVISIONS

NO. DATE DESCRIPTION

08.31.21 PLANNING RESUBMITTAL #1 02.03.22 PLANNING RESUBMITTAL #2

PROJECT NUMBER


LIGHTING CUTSHEETS

NO SCALE

SHEET TITLE

SHEET NUMBER

=1 (

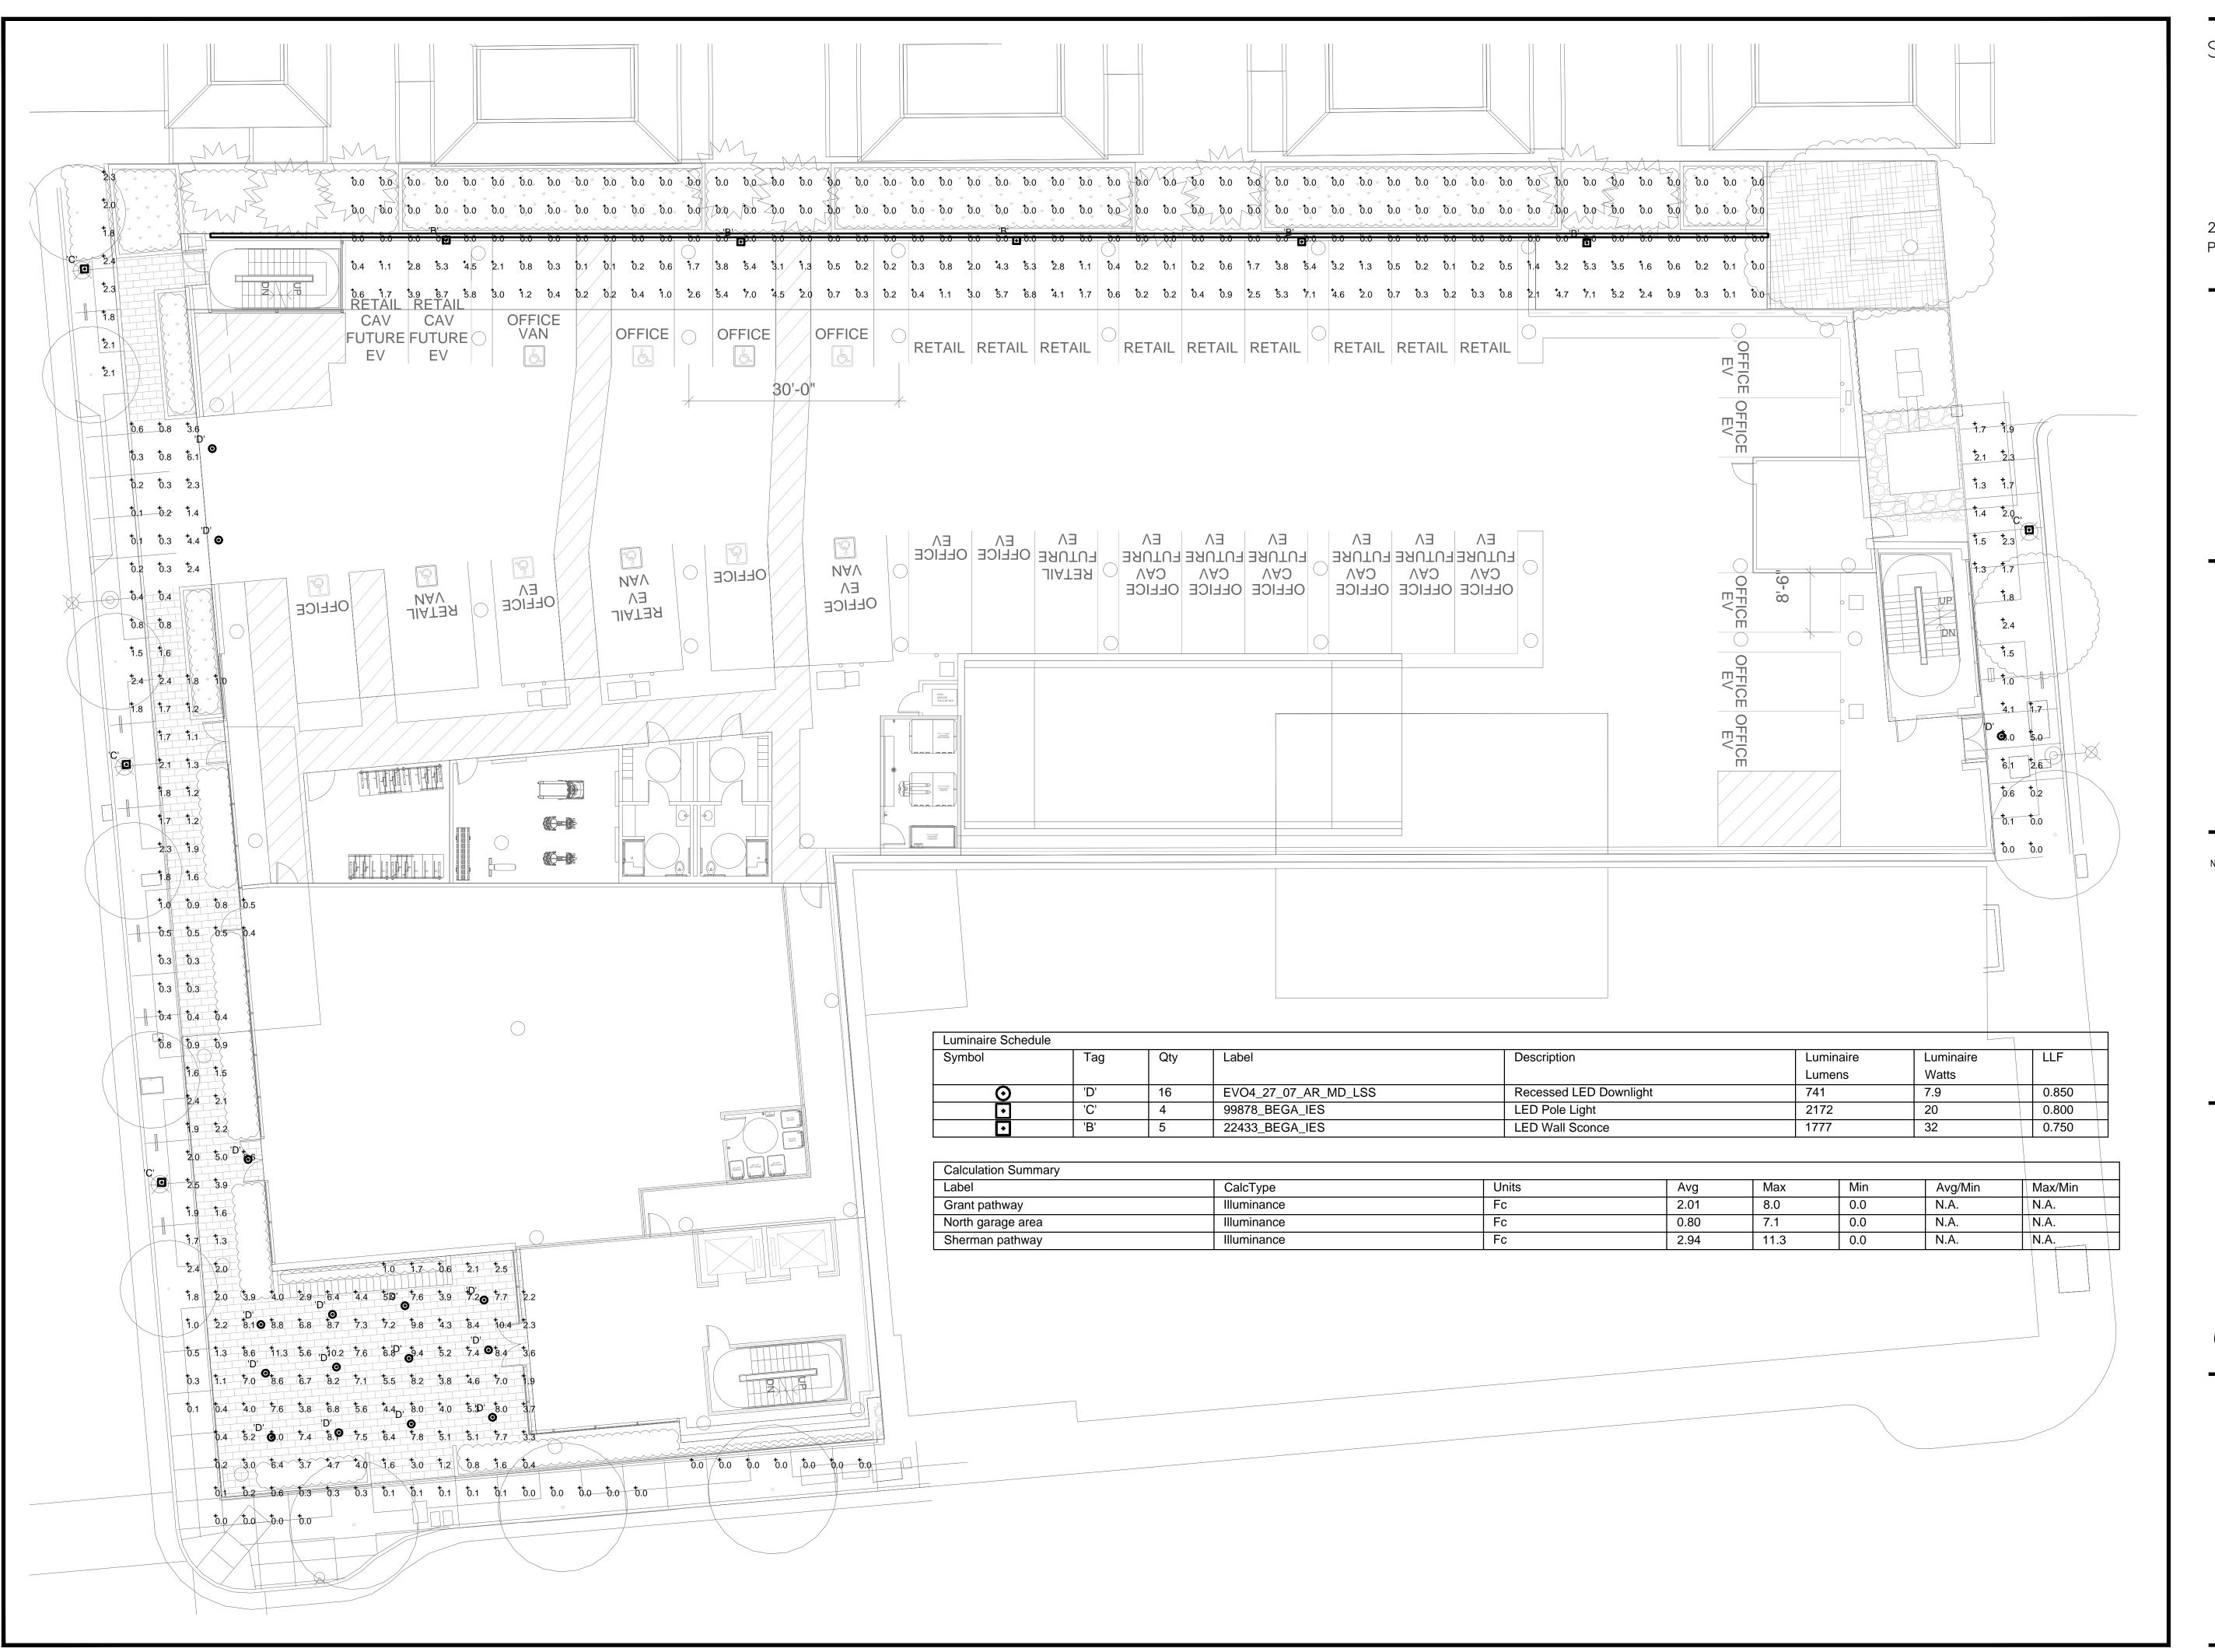

2625 PARK BLVD PALO ALTO, CA 94306

> INTERFACE ENGINEERING
>
> PROJECT 2021-0196
> CONTACT Kristina Santi

135 Main Street, Suite 400 San Francisco, CA 94105

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ISSUES AND REVISIONS

O. DATE DESCRIPTION

05.25.21 PLANNING SUBMITTAL
08.31.21 PLANNING RESUBMITTAL #1
02.03.22 PLANNING RESUBMITTAL #2

PROJECT NUMBER

SHEET TITLE


SITE LIGHTING PHOTOMETRIC PLAN

SCALE NO SCALE

SHEET NUMBER

SHEET NO

E1.1

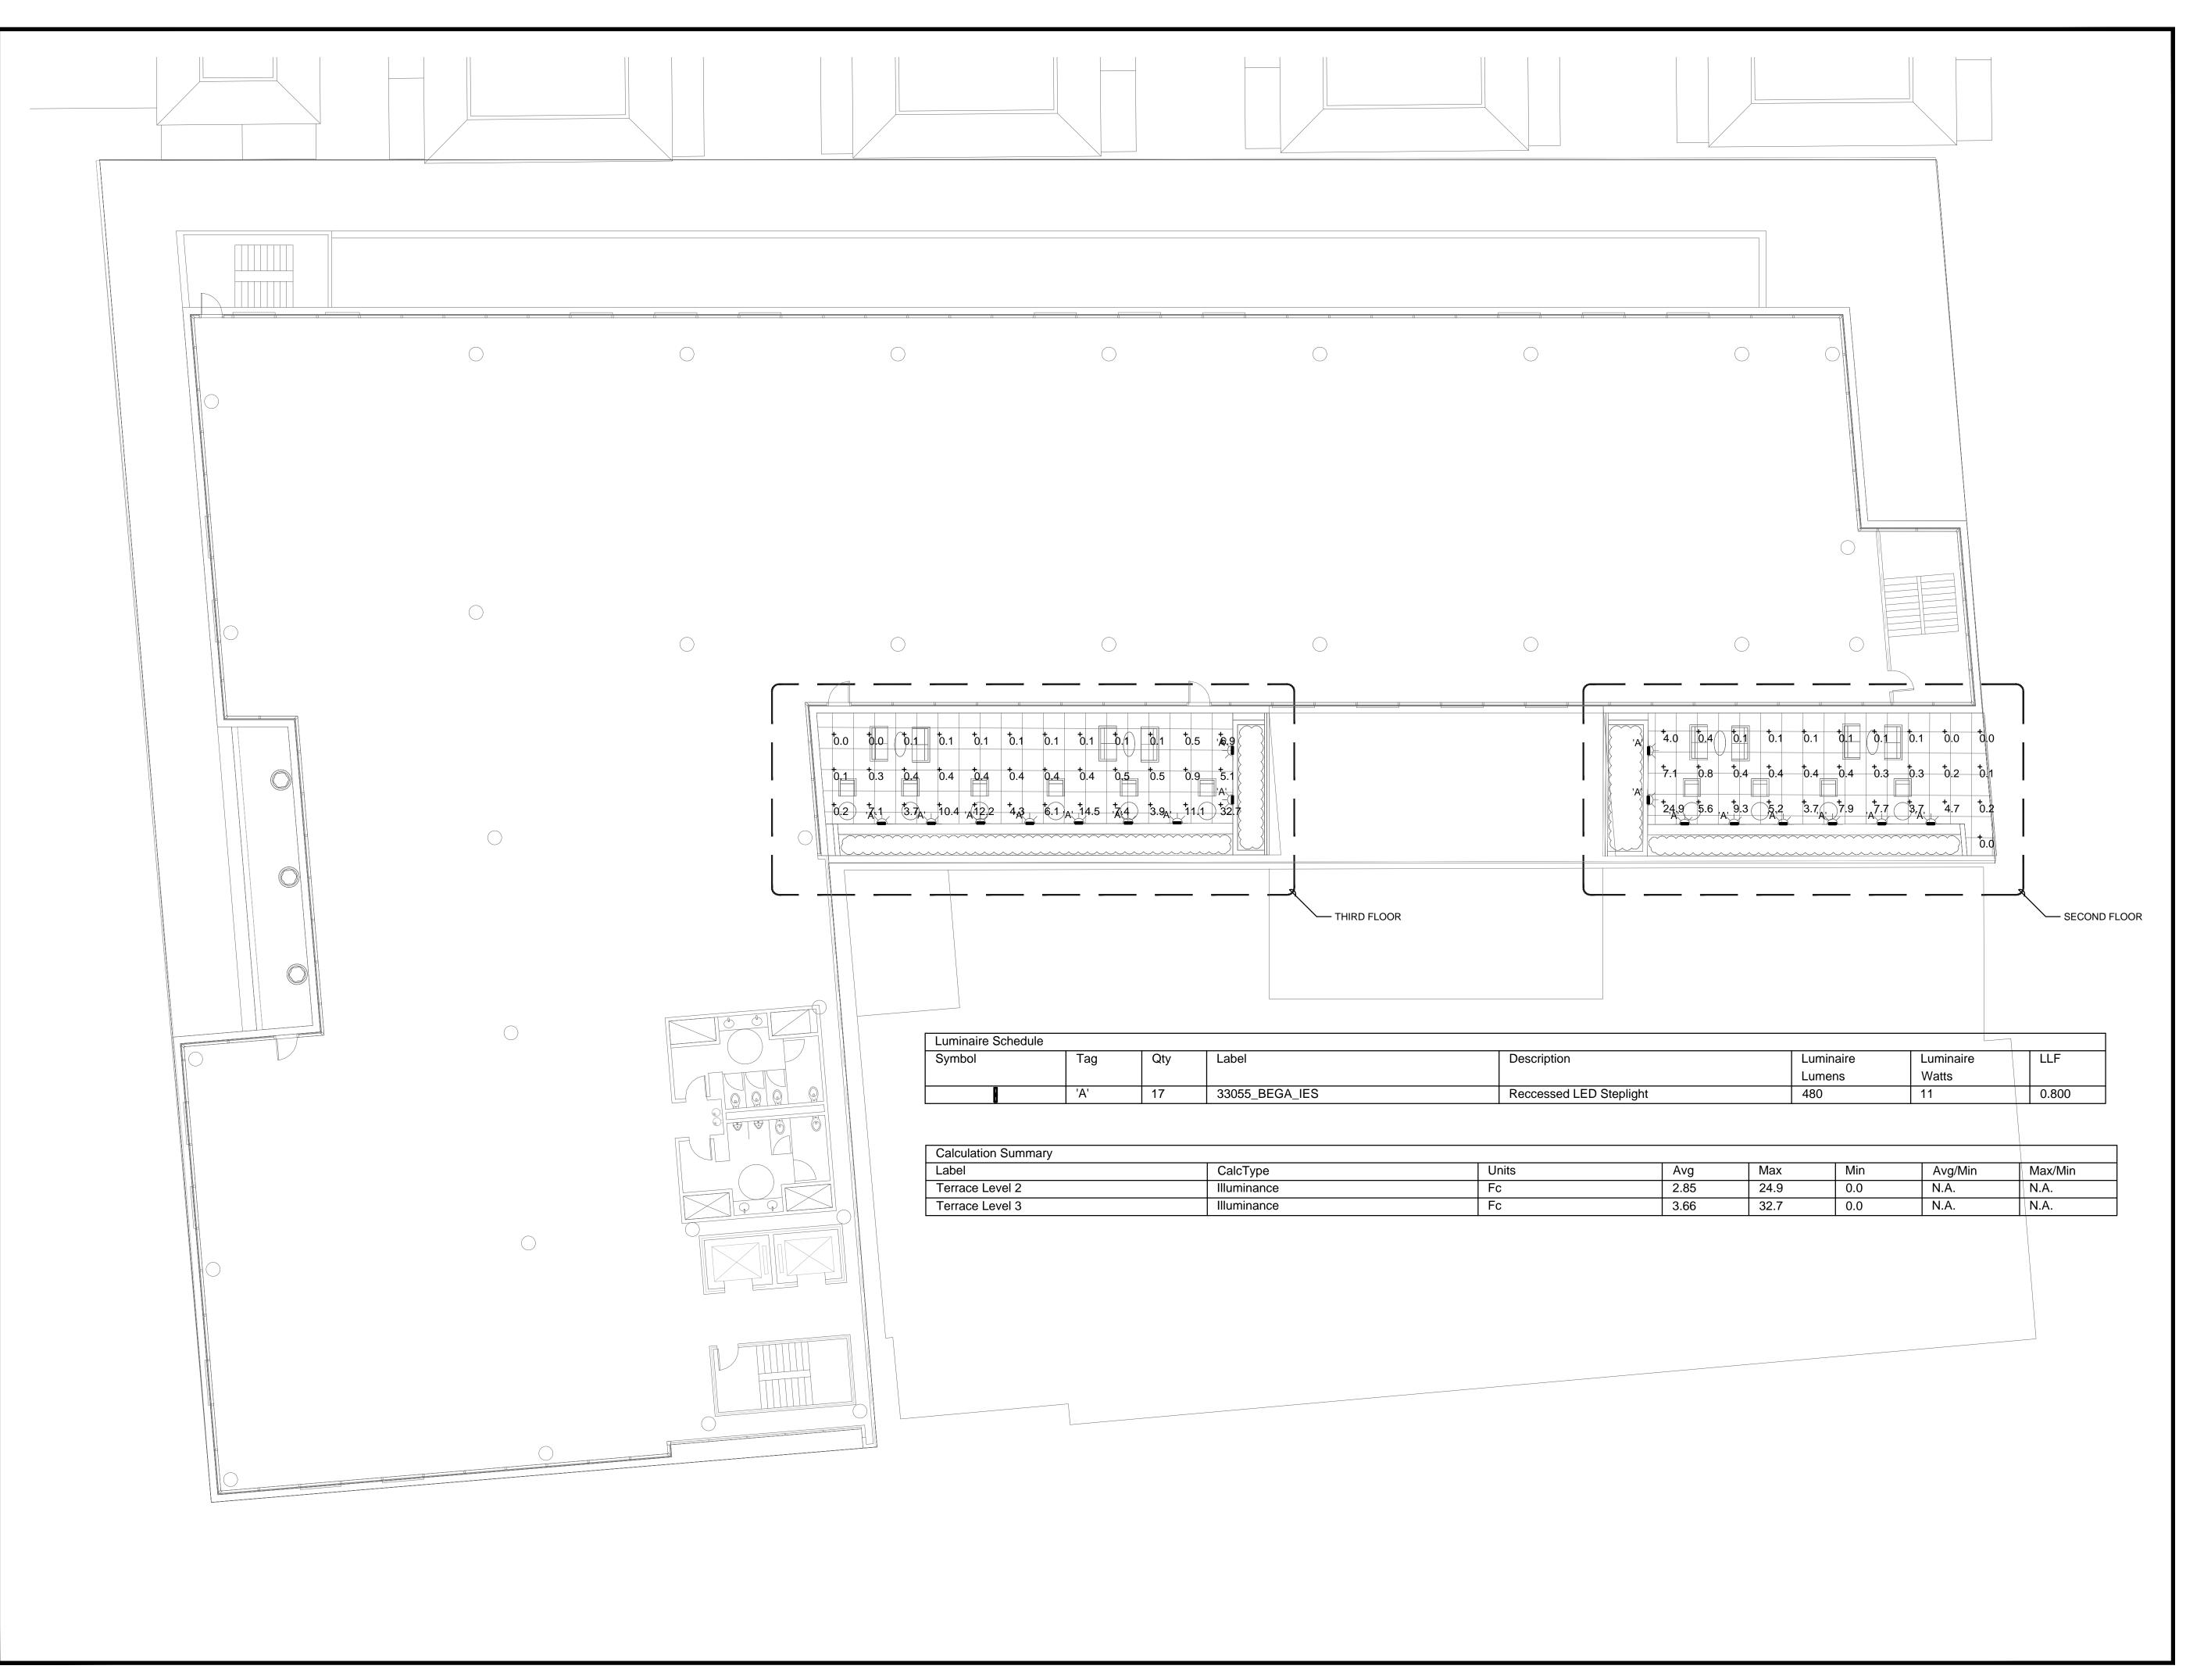

2625 PARK BLVD PALO ALTO, CA 94306

> INTERFACE ENGINEERING
>
> PROJECT 2021-0196
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ISSUES AND REVISIONS

NO. DATE DESCRIPTION

05.25.21 PLANNING SUBMITTAL
08.31.21 PLANNING RESUBMITTAL #1
02.03.22 PLANNING RESUBMITTAL #2

PROJECT NUMBER 19030

SHEET TITLE

LEVEL 2 AND LEVEL 3 TERRACE LIGHTING PHOTOMETRIC PLAN

NO SCALE

SHEET NU

F12