PLANNING REVIEW


COVER SHEET

SHEET NUMBER



PLANNING REVIEW

180 EL CAMINO REAL, BLDG D, SUITE #136B STORE NO. TBD, LEVEL: GROUND LEVEL PALO ALTO, CA 94304

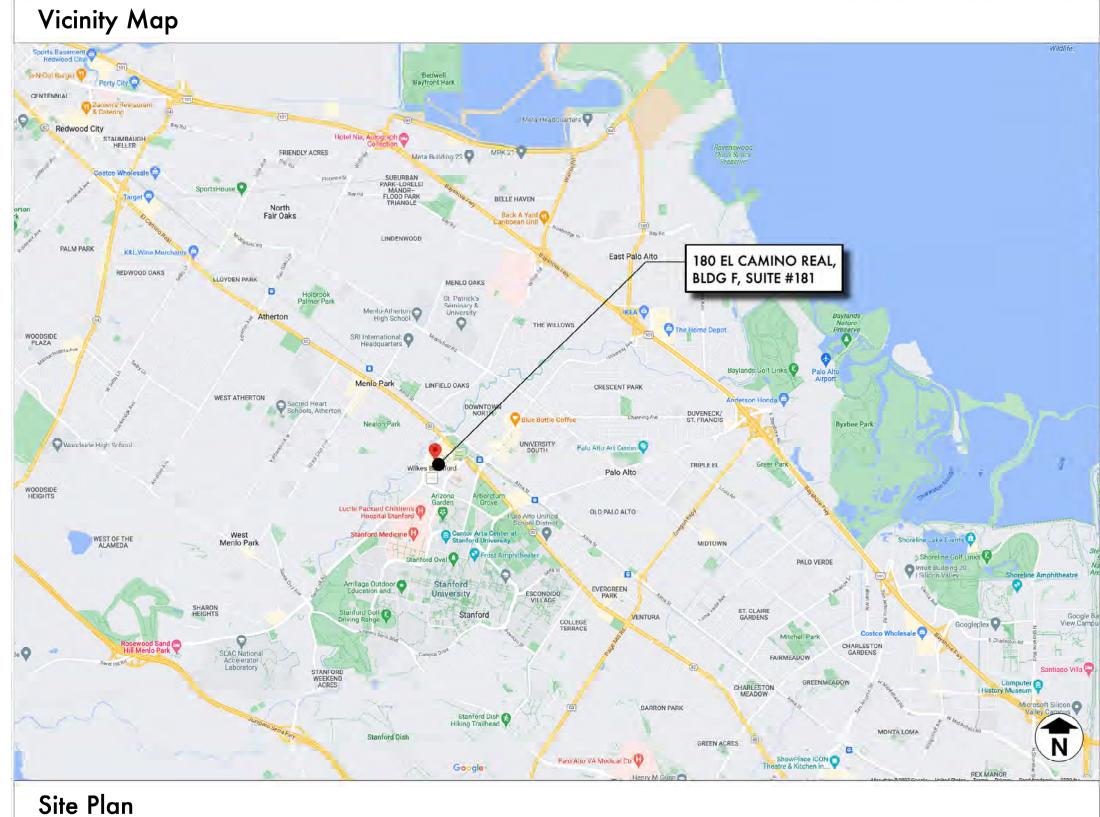

Project Data/	Codes	
APPLICABLE CODES (INCLUDING CITY OF SAN MATEO CODE AMENDMENTS): 2022 CALIFORNIA BUILDING CODE (CBC) 2022 CALIFORNIA ELECTRICAL CODE (CEC) 2022 CALIFORNIA MECHANICAL CODE (CMC) 2022 CALIFORNIA PLUMBING CODE (CPC) 2022 CALIFORNIA ENERGY CODE 2022 CALIFORNIA FIRE CODE (CFC) NFPA 13 "STANDARD FOR THE INSTALLATION OF SPRINKLER SYSTEMS" (2022) 2010 ADA STANDARDS FOR ACCESSIBLE DESIGN PALO ALTO MANICIPLE CODE		
CONSTRUCTION TYPE: OCCUPANCY GROUP: FIRE SPRINKLERS: ALLOWABLE HEIGHT: ACTUAL HEIGHT: ALLOWABLE AREA: ACTUAL AREA:	YES, FULLY SPRINKLERED	

Project Directory BACK OF OF THE HOUSE INC. SAN FRANCISCO, CA TEL: 415.652.4012 CONTACT: HANNAH WALBRIDGE HANNAH@BACKOFTHEHOUSEINC.COM

ARCHITECT: **CROME ARCHITECTURE** 905 FOURTH STREET SAN RAFAEL, CA 94901 TEL: 415.453.0700 FAX: 415.453.0785 CONTACT: MAX CROME EMAIL: MAX@CROMEARCHITECTURE.COM

THE FOLLOWING ITEMS ARE SHOWN IN SCHEMATIC FORM IN THESE DOCUMENTS.

COMPLETE WORKING DRAWINGS, SPECIFICATIONS AND CALCULATIONS ARE TO BE

EXISTING/DEMOLITION FLOOR PLAN PROPOSED PLAN

ARCHITECTURAL

A0.0 COVER SHEET

Drawing Index

EXTERIOR ELEVATIONS EXTERIOR ELEVATIONS & DETAILS INTERIOR DIGITAL MATERIAL BOARD EXTERIOR DIGITAL MATERIAL BOARD

Scope of Work **Deferred Submittals**

INTERIOR REMODEL OF EXISTING RESTAURANT. SELECTED NEW SEATING, EQUIPMENT AND MILLWORK. DEMO OF SELECTED NON LOAD BEARING PARTITIONS. NEW NON RATED INTERIOR PARTITION. NEW FINISHES. MINIMAL NEW LIGHTING. NEW ADDED BAR. PLUMBING & MECHANICAL SCOPE IN THE KITCHEN

EXTERIOR UPGRADE, INCLUDES: NEW FINISHES, NEW AWNING, NEW SIGNAGE, NEW EXTERIOR ENCLOSURE FOR THE SEATING AREA WITH PLANTERS, NEW LIGHTING &F URNITURE. REPLACEMENT OF THE EXISTING EXTERIOR LIGHT FIXTURES WITH NEW.

EXCLUSIONS: NO CHANGE TO OCCUPANT LOAD. NO CHANGE TO BUILDING ENVELOPE. NO CHANGES TO THE PARKING. NO CHANGES TO THE BUILDING HEIGHT. NO NEW PLANTING

> GENERAL CONTRACTOR SHALL PROVIDE ACCESS PANELS FOR ALL TRADES AS REQUIRED BY CODE. LOCATIONS TO BE APPROVED BY ARCHITECT AND/OR OWNERS REPRESENTATIVE PRIOR

FIRE ALARM FIRE SPRINKLER

-SINAGE -BARRICADE

SUBMITTED FOR CITY APPROVAL.

- HOOD FIRE SUPPRESSION SYSTEM

CONTRACTOR IS TO VERIFY ALL DIMENSIONS AND EXISTING CONDITIONS ON THE SITE AND BE RESPONSIBLE FOR CONFIRMING AND CORRELATING ALL QUANTITIES AND DIMENSIONS. SELECTING FABRICATION PROCESSES AND TECHNIQUES OF CONSTRUCTION, COORDINATING HIS/HER WORK WITH ALL OTHER TRADES AND PERFORMING HIS/HER WORK IN A SAFE, COMPLETE, AND SATISFACTORY MANNER.

10. ALL WALL DIMENSIONS ARE F.O.F. TO F.O.F., U.O.N.

TO EXECUTION OF WORK.

11. PROVIDE BLOCKING AT WALLS WHERE REQUIRED FOR SUPPORT OF SHELVING.


12. ALL EXITS TO BE OPENABLE FROM INSIDE WITHOUT USE OF A KEY.


13. FIRE SPRINKLERDESIGN SHALL BE SUBMITTED UNDER SEPARATE PERMIT DIRECTLY TO THE CITY OF PALO ALTO FIRE DEPARTMENT.

14. SPECIFY ON THE PLANS THAT STORAGE IN STOCK/STORAGE ROOMS SHALL BE MAINTAINED 18 INCHES OR MORE BELOW SPRINKLER HEAD DEFLECTORS, A 3-INCH RED STRIPE SHALL BE MARKED ALONG ALL WALLS WITHIN STOCK/STORAGE ROOMS AT THE MAXIMUM STORAGE HEIGHT, AND THE STRIPE SHALL BE LABELED, "NO STORAGE ABOVE THIS LINE" IN WHITE LETTERS A MINIMUM OF ONCE ON EACH WALL.

15. LANDLORD STRONGLY RECOMMENDS THAT THE TENANT CONTRACTS WITH THE MALL'S BARRICADE VENDOR TO SUPPLY AND INSTALL. THE BARRICADE SYSTEM. BARRICADE SHOULD BE 12' HIGH WITH TELESCOPING RODS AND SCRIM SHEETS FROM 12' HEIGHT TO TOP OF STOREFRONT. BARRICADE WILL REQUIRE A DEFERRED PERMIT SUBMITTAL/APPROVAL BY THE CITY OF PALO ALTO

Symbols Legend

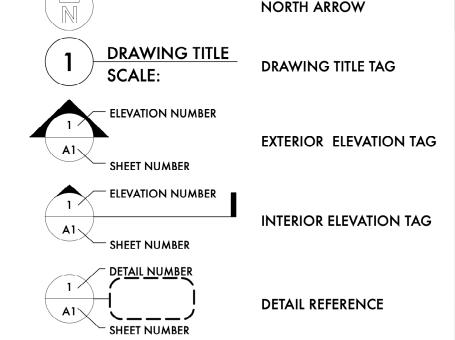

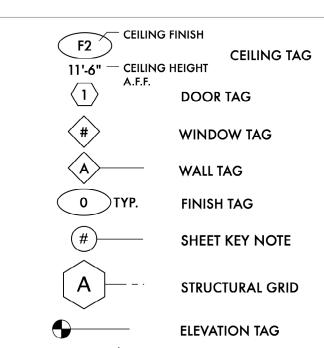

FIRE EXTINGUISHER, 2A10BC MINIMUM FLOOR DRAIN J BOX WALL RECEPTACLE

SIMON GENERAL COMMENTS:

• PLANS REVIEWED AND APPROVED BY LANDLORD'S TENANT COORDINATOR MUST BE PRESENT ON THE JOB SITE AND BE ACCOMPANIED BY PLANS APPROVED FOR BUILDING PERMIT. ANY PROPOSED DEVIATION FROM THE LANDLORD APPROVED PLANS MUST BE NUMBERED AND CLOUDED ON THE PLANS, AND THEN RESUBMITTED BY THE TENANT TO THE LANDLORD FOR RE-APPROVAL PRIOR TO ANY CONSTRUCTION CHANGES TAKING PLACE IN THE FIELD. • TENANT'S GC IS REQUIRED TO CHECK IN WITH LANDLORD'S ON SITE PROPERTY MANAGER PRIOR TO THE START OF TENANT CONSTRUCTION. CONTACT MALL MANAGEMENT OFFICE. CONTACT PROPERTY MANAGEMENT FOR CONSTRUCTION BARRICADE REQUIREMENTS, INCLUDING BARRICADE GRAPHICS.

• TENANT'S GC IS RESPONSIBLE TO COMPLY WITH ALL MALL RULES AND REGULATIONS AND AS INSTRUCTED ON SITE BY MALL MANAGEMENT. • ANY DAMAGE TO LANDLORD'S PROPERTY DURING TENANT DEMOLITION OR CONSTRUCTION (MALL FLOORING, BULKHEAD, NEUTRAL PIERS, ETC.) WILL BE REPAIRED PER MALL SPECIFICATIONS, AT TENANT'S EXPENSE. • ANY LANDLORD EQUIPMENT, COMPONENT, AND / OR SERVICE FEEDING OTHER TENANT(S) THAT IS EXISTING IN THE SPACE MUST REMAIN VISIBLE AND ACCESSIBLE TO THE LANDLORD. TENANT SHALL INSTALL ACCESS PANELS AS REQUIRED TO MAINTAIN ACCESS. ACCESS PANELS SHALL BE LABELED TO PROPERLY IDENTIFY SYSTEM, COORDINATE WITH MALL OPERATIONS. • ALL LANDLORD COMMENTS FROM PREVIOUS REVIEW(S) ARE TO BE INCORPORATED INTO THE FINAL SET OF APPROVED DRAWINGS AND ARE TO BE

ADHERED TO IN THE FIELD. •ALL LANDLORD COMMENTS ON THIS SET OF DRAWINGS SHALL APPLY TO THE ENTIRE DOCUMENT SET, EVEN IF NOT REPEATED ON EVERY SHEET IN DRAWING

•THE RE-USE OF ANY EXISTING CONSTRUCTION, FINISHES, EQUIPMENT, OR ELECTRICAL, PLUMBING OR HVAC SYSTEMS CURRENTLY IN THE SPACE IS CONDITIONAL UPON IT BEING APPROPRIATE FOR RE-USE. ANY EXISTING CONDITION OR EQUIPMENT TO BE RE-USED MUST BE RESTORED TO LIKE NEW CONDITIONS. THE LANDLORD MAKES NO WARRANTY ON THE RE-USE OF ANY

EXISTING CONDITION IN THE SPACE. • IF AT ANY POINT A FAILURE, UPGRADES, AND / OR IMPROVEMENTS TO EXISTING SYSTEMS OCCUR, IT IS THE SOLE RESPONSIBILITY OF THE TENANT TO REPAIR OR REPLACE, AT TENANT EXPENSE.

AGREEMENT.

macy^{*}s bloomingdales

Under Redevelopmen

AGENCY SHALL BE PROVIDED BY GENERAL CONTRACTOR AND INCLUDED IN 5. GENERAL CONTRACTOR SHALL MAKE NO REVISIONS, ALTERATIONS OR

LOCAL GOVERNMENT AGENCIES.

General Notes

APPLICABLE CODES.

CHANGES TO THE WORK AS SHOWN IN THE CONTRACT DOCUMENTS WITHOUT THE PRIOR WRITTEN APPROVAL OF THE ARCHITECT AND/OR OWNERS REPRESENTATIVE. NO ADDITIONAL COSTS FROM THE GENERAL CONTRACTOR SHALL BE CONSIDERED AND THE WORK MAY BE REQUIRED TO BE REMOVED WITHOUT SUCH APPROVAL BY ARCHITECT.

. ALL WORK AND MATERIAL SHALL BE EXECUTED IN FULL ACCORDANCE WITH ALL

2. GENERAL CONTRACTOR SHALL PROVIDE AND BE RESPONSIBLE FOR ALL COSTS

4. FIRE EXTINGUISHERS AND CABINETS AS REQUIRED BY LOCAL GOVERNMENT

FOR PUBLIC PROTECTION AS REQUIRED BY THE CONTRACT DOCUMENTS AND

6. GENERAL CONTRACTOR SHALL PROVIDE THE BUILDING OFFICIAL WITH A CERTIFICATE OF CONSTRUCTION COMPLIANCE WITH ENERGY CONSERVATION STANDARDS UPON FINAL BUILDING DEPARTMENT INSPECTIONS (WHERE

7. GENERAL CONTRACTOR SHALL PREPARE THE FLOOR LEVEL AND SMOOTH AND PROVIDE FOR THE FILLING OF ALL FLOOR DRAINS, FLOOR SINKS OR OTHER SUCH DEPRESSIONS, CRACKS OR IRREGULARITIES IN FLOOR SLAB.

• LANDLORD AND TENANT RESPONSIBILITIES ARE AS DEFINED IN LEASE

• LANDLORD STRONGLY PREFERS USE OF ENERGY STAR PRODUCTS AND/OR EQUIPMENT WHENEVER POSSIBLE DURING TENANT BUILD OUT, WHICH CAN

REVISION TAG

REDUCE ENERGY CONSUMPTION.

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Address:

Project

MANDATORY

2/26/24

PLANNING REVIEW

CAL GREEN

STANDARDS GB-1

SHEET NUMBER

Compliance Path Verification The project will be verified by a Rough GB Final Inspection IVR # 153 COMMERCIAL GREEN BUILDING SPECIAL INSPECTOR
 Mandatory
 Fireplaces

 Mandatory
 Temporary ventilation (MERV 8)
 conformance with the CALGreen mandatory and elective measures claimed. I have reviewed and understand the after-construction requirements below. MandatoryCovering of duct openings and protection of mechanical equipment during constructionMandatoryAdhesives, sealants and caulks: Comply with VOC limits (Table 5.504.4.1 and 5.504.4.2 for VOC limits)MandatoryPaints and Coatings: Comply with VOC Limits (Table 5.504.4.3) 5.504.3 5.504.4.1 Signature (Green Building Special Inspector) 5.504.4.3.1 Mandatory Aerosol paints and coatings Mandatory Carpet systems: Carpet adhesive (Table 5.504.4.1 for VOC limits) See Foundation Inspection chaptists Mandatory Composite wood products: Formaldehyde limits (Table 5.504.4.5) 5.504.4.5 5.504.4.5.3 5.504.4.6 Mandatory Resilient flooring systems

Mandatory Resilient flooring verification of compliance 5.504.4.6.1 Mandatory Filters: Labeling (MERV 13, with exceptions) 5.504.5.3 Phone or Email Mandatory Environmental tobacco smoke (ETS) control Mandatory Indoor moisture control

Mandatory Outside air delivery (For Indoor Air Quality)

Mandatory Carbon dioxide (CO2) monitoring (For Indoor Air Quality) 5.506.1 5.506.2 Mandatory Indoor Air Quality Management Plan PAMC 16.14.390 Mandatory Acoustical control (STC Values per ASTM E90 and ASTM E413 5.507.4 Mandatory Exterior noise transmission, prescriptive method (with exceptions) 5.507.4.1 5.507.4.1.1 SECTION TO BE COMPLETED AFTER 5.507.4.2 Mandatory Exterior noise transmission, performance method CONSTRUCTION 5.507.4.2.1 Mandatory Site features

Mandatory Documentation of compliance 5.507.4.2.2 5.507.4.3 Mandatory Interior sound transmission (with note) Mandatory Ozone depletion and greenhouse gas reductions

Mandatory Chlorofluorocarbons (CFC's) Development Center to schedule your final inspection: 5.508.1.1 Construction debris receipts from an approved facility using 5.508.1.2 5.508.2 Mandatory Halons If HERS testing was required per the homes energy report, Mandatory Refrigerant piping 5.508.2.1 Mandatory Refrigerant piping valves Mandatory Refrigerant piping access valves If there were alterations during construction that impacted the Mandatory Refrigerated service case
Mandatory Refrigerant receivers
Mandatory Pressure testing 5.508.2.3 energy report (i.e. R values, Ŭ factors, Equipment Types) rerun 5.508.2.4 5.508.2.5 5.508.2.6 the report and attach it. Mandatory Evacuation (after pressure testing) I certify that: CALGreen inspections were performed throughout construction. The home has met the CALGreen measures as claimed on this sheet. Those required for landscaping may be excluded from Y - Yes; the measure is in the scope of work this confirmation if verified within 6 months of final inspection. N - No; the measure is not in the scope of work Through a combination of onsite inspections and confirmation PAMC - Palo Alto Municipal Code; locally amended from the Contractor there have been no alterations that [N] - New Construction impacted the energy report for the home, unless the new report [MF] - Multi-family dwellings [AA] - Additions and alterations [HR] - High-rise building Signature (Green Building Special Inspector) The Green Building Survey is a required project submittal. The survey can be found at the following link. The online survey shall be completed and a Green Building Survey Report Sign only after project is complete will be sent in an email. Include a copy of the survey report on a separate page in this plan set. Please indicate the reference page here ____ The ENERGY STAR Portfolio Manager profile is a required project submittal and can be created at the following link. The Portfolio Manager profile shall be opened and a screenshot shall be included on a separate page in this plan set. Please indicate the reference page here _____ For more information on energy benchmarking, please visit City of Palo Alto Utilities "Benchmarking Your Building" webpage here

CITY STAMPS ONLY

2022 NONRESIDENTIAL GREEN BUILDING APPLICATION CALGREEN MANDATORY

Version 01/23

Application: This sheet shall be used for nonresidential projects that do not trigger Tier 1 or Tier 2 requirements and include: Tenant improvements, renovations or alterations with a permit value of \$200,000 or more.

5.1 Planning and Design

Mandatory Storm water pollution prevention for projects that disturb < 1 acre of land

Mandatory Local storm water pollution prevention

Mandatory

Mandatory

Bicycle parking for (Additions or alterations which add nine or less visitor vehicular parking spaces exempt

Mandatory

Mandatory

Long term bicycle parking

Long term bicycle parking

Mandatory Grading and paving (exception for additions and alterations not altering the drainage path)

Indoor Water Use: Water closets (shall not exceed 1.28 gallons per flush)

Mandatory Indoor Water Use: Floor-mounted urinals (0.129ph)

Mandatory Indoor Water Use: Floor-mounted urinals (0.5 gpf)

Mandatory Indoor Water Use: Single showerhead (1.8 gpm at 80 psi)

Mandatory Indoor Water Use: Multiple showerheads serving one shower (flow rate of 1.8 gpm at 80 psi)

Mandatory Indoor Water Use: No Indoor Water Use: N

Indoor Water Use: Metering faucets for wash fountains (0.2 gallons/ cycle)

Mandatory Indoor Water Use: Areas of additions or alteration

Mandatory Indoor Water Use: Standards for plumbing fixtures and fittings (2022 California Plumbing Code)

Mandatory Outdoor potable water use in landscape areas (MWELO)

Mandatory Documentation: Construction waste management plan, waste management company, waste stream reduction alternative Universal waste [AA]

Mandatory Enhanced construction waste reduction (80% Diversion w/ job valuation >\$25,000 or meet state standards of 65%)

Mandatory Testing and adjusting for new buildings < 10,000 SF or new systems that serve additions or alterations [N] [AA]

Mandatory Testing and adjusting for systems: Renewable energy, landscape irrigation, and water reuse

Mandatory

Meters, separate submeters or metering devices shall be installed as follows:

Excess consumption (Submeters for additions that consume over 1,000 gal/ day)

Mandatory Indoor Water Use: Wall-mounted urinals (0.125gpf)

Mandatory
Indoor Water Use: Kitchen faucets (1.8 gpm at 60 psi)

Mandatory
Indoor Water Use: Wash fountains (1.8 gpm at 60 psi)

Mandatory
Indoor Water Use: Metering faucets (0.2 gallons/ cycle)

Mandatory Best management practices

5.3 Water Efficiency and Conservation

Mandatory Commercial kitchen equipment

Mandatory Non-residential enhanced water budget

5.4 Material Conservation and Resource Efficiency

Mandatory Weather protection

Mandatory Moisture control: Sprinklers

Mandatory Moisture control: Entries and openings

Mandatory Moisture control: Exterior door protection

Mandatory Moisture control: Fashing

Mandatory Moisture control: Fashing

Mandatory Construction waste management plan
Mandatory Waste management company

Mandatory Recycling by occupants (with exceptions)

Mandatory Performance reviews – Water (sites > 1 acre)

Recycling by occupants: Additions (with excer

Mandatory Excavated soil and land clearing debris (100% reuse or recycle)

 Mandatory
 Testing, adjusting and balancing: Reporting for HVAC balancing

 Mandatory
 Operation and maintenance (O&M) manual

Mandatory Performance reviews – Energy (projects over 10,000 square feet)

Mandatory Waste stream reduction alternative

Mandatory Testing and adjusting: Procedures Mandatory Testing and adjusting: HVAC balancing

Mandatory Inspection and reports

Mandatory Construction waste management

Mandatory Cooling Tower Water Use (locally amended)

Mandatory Food Waste Disposers

Title 24, Part 11, California Green Building Code (CALGreen) City of Palo Alto Green Building Program and Resources

City of Palo Alto Green Building Ordinance 5570 (PAMC 16.14 Amendments) https://codelibrary.amlegal.com/codes/paloalto/latest/paloalto_ca/0-0-0-72369

Rough GB

PAMC 16.14.290/ 5.106.1

5.106.1.2

5.106.4.1.2

5.106.10

5.303.3.1

5.303.3.2.1

5.303.3.3.2 5.303.3.4.1

5.303.3.4.2

5.303.3.4.3

5.303.3.4.4 5.303.3.4.5

5.303.4.1

5.408.1

5.408.1.3

5.408.3

5.410.4.2 5.410.4.2 5.410.4.3

5.410.4.3.1

5.410.4.4 5.410.4.5

5.410.4.5.1

PAMC 16.14.370 Section 5.410.4.7

PAMC 16.14.380 Section 5.410.4.8

Title 23, Chapter 2.7/ 5.304.1

PAMC 16.14.330 Section 5.304.2

PAMC 16.14.340 Section 5.306
PAMC 16.14.350 Section 5.307


5.303.3.2.2

PAMC 16.14.290/ 5.106.1.1

PAMC 18.54.060/ 5.106.4/ 5.106.4.1.3

https://www.dgs.ca.gov/BSC/CALGreen

 $\underline{https://www.cityofpaloalto.org/Departments/Planning-Development-Services/Development-Services/Green-Building/Compliance}$

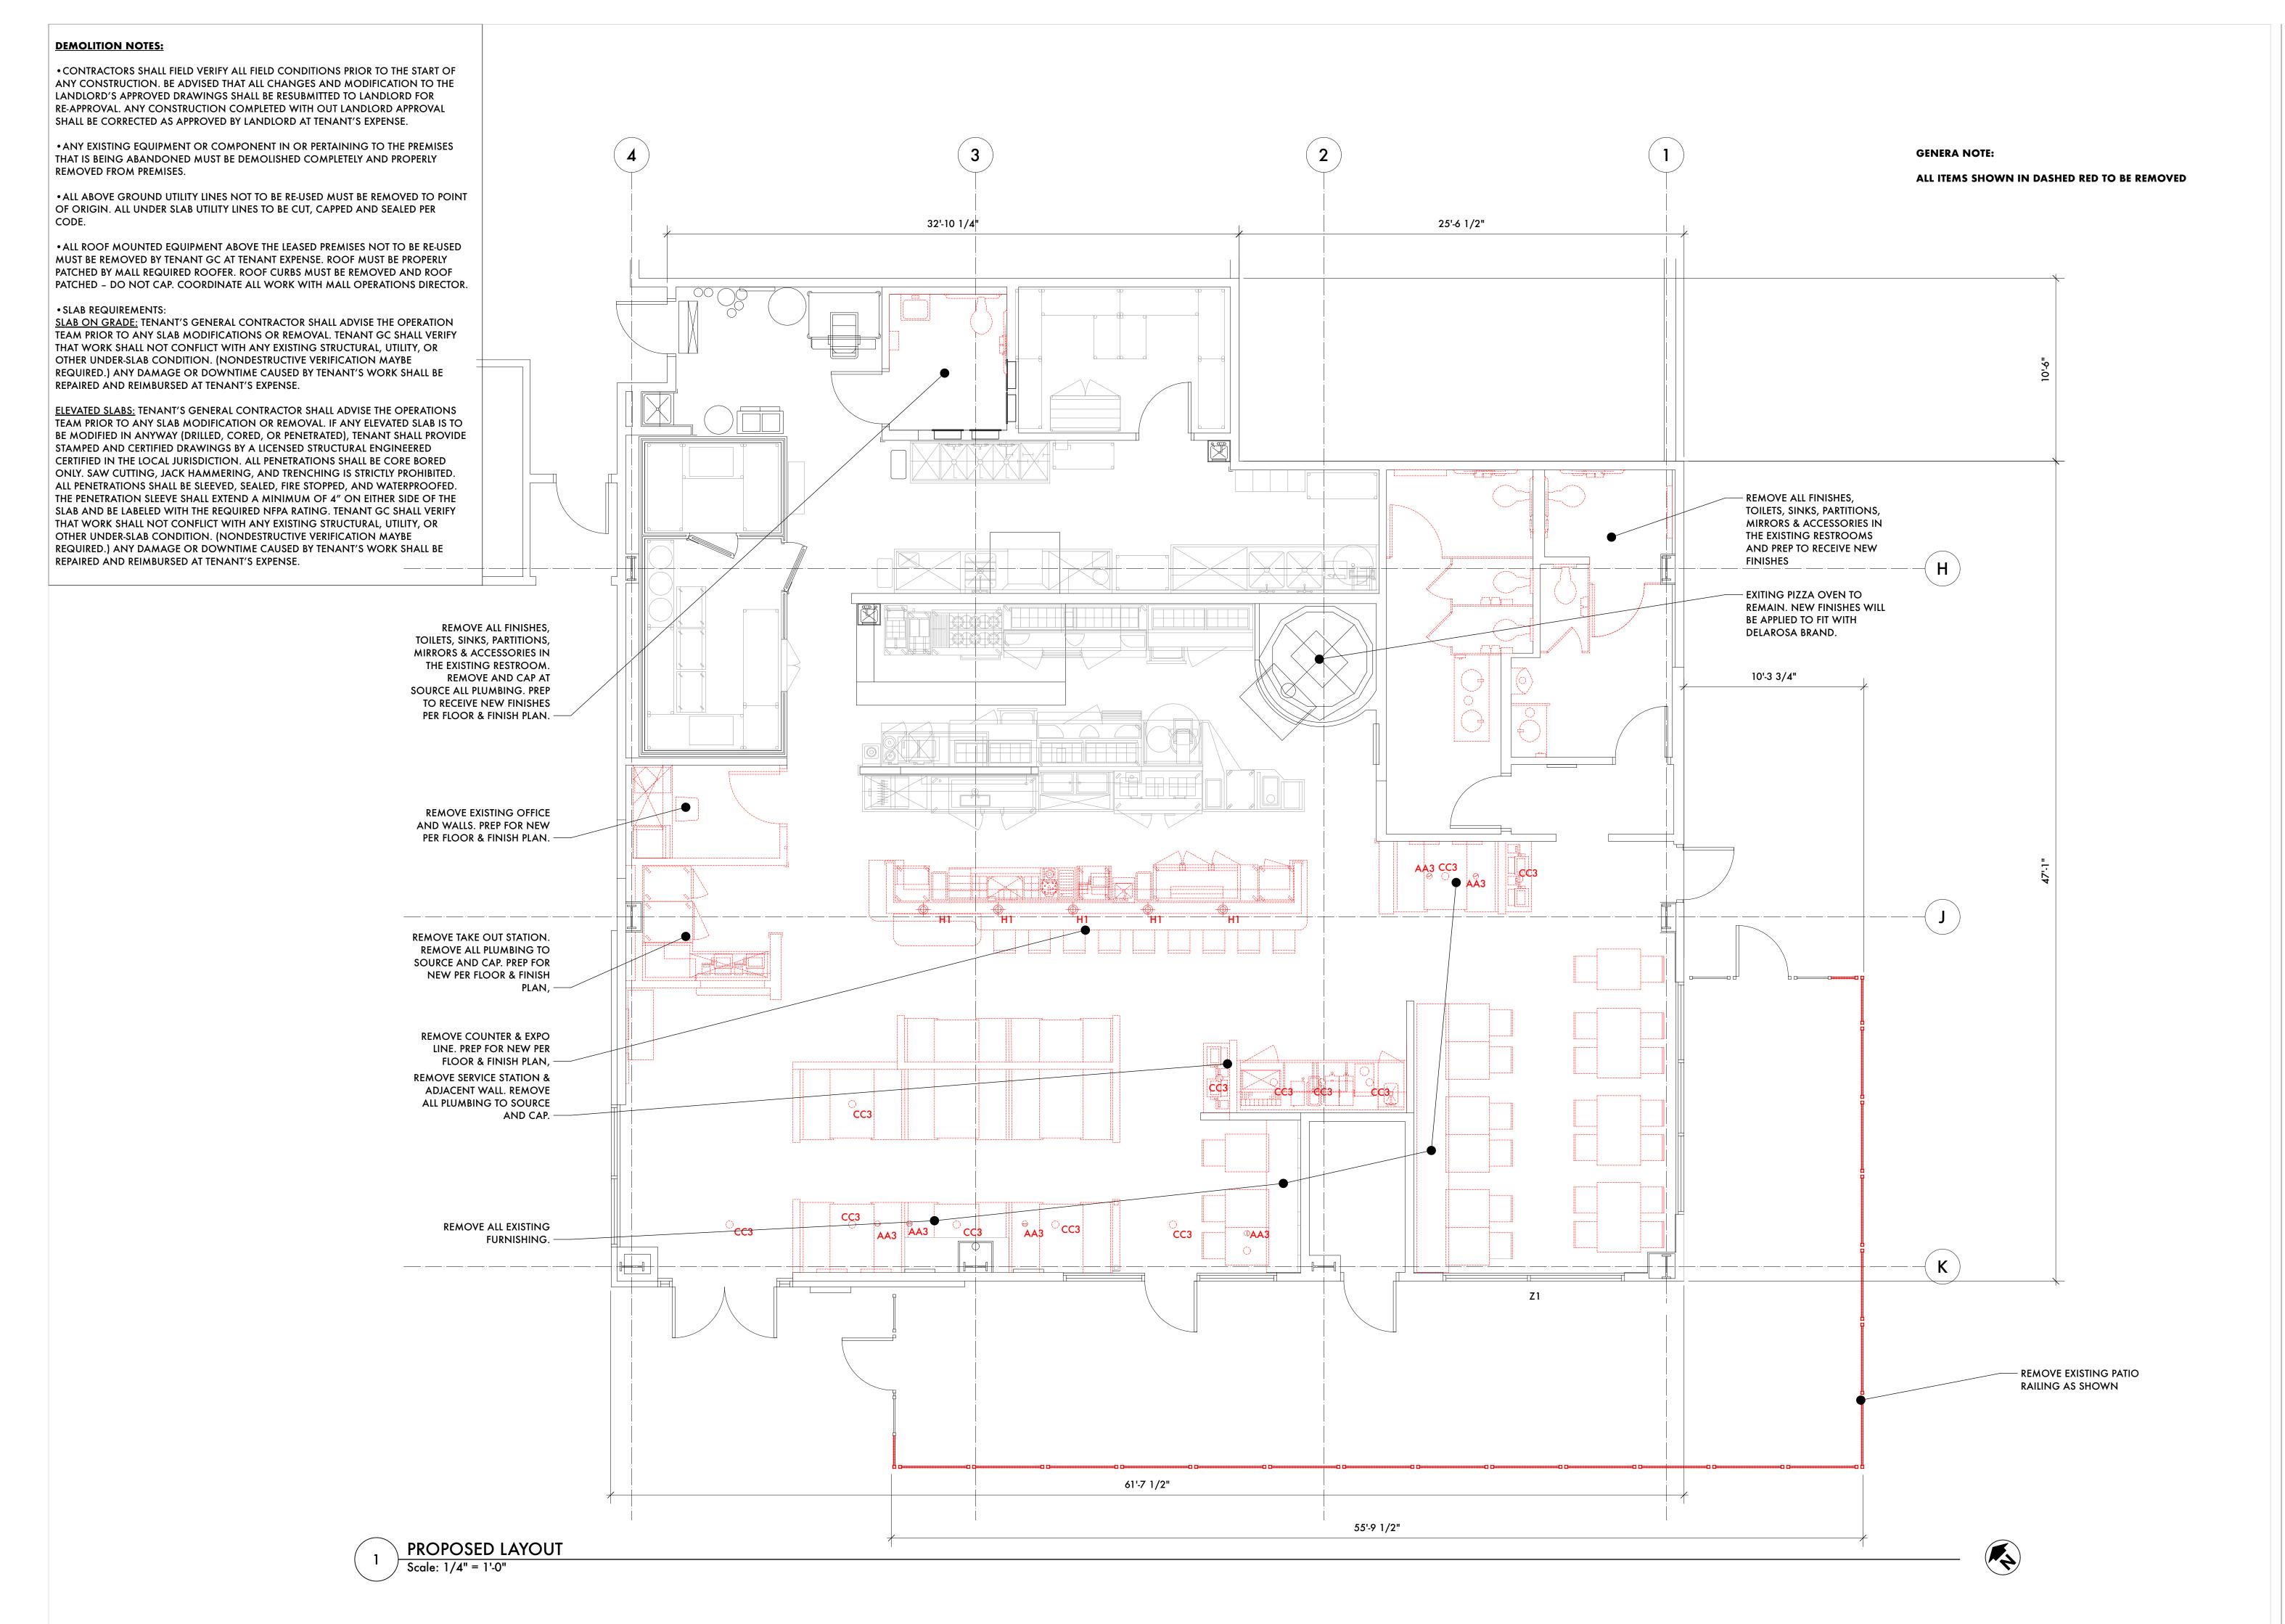



DELAROSA

180 EL CAMINO REAL,
BLDG D,
SUITE #136B
PALO ALTO, CA 94304



:ROME Architecture

SUBMITTAL

PLANNING REVIEW 2/26/24

EXISTING/DEMO FLOOR PLAN

SHEET NUMBER

A1.0

LL PLAN COMMENTS:

• ALL FLOORING TRANSITIONS MUST BE SMOOTH AND FLUSH. THE USE OF PLASTIC, VINYL, OR RUBBER TRANSITIONS STRIPS IS STRICTLY PROHIBITED. TENANTS MUST UTILIZE A HARD SURFACE TRANSITION.

• TENANT IS REQUIRED TO INSTALL A WATERPROOF MEMBRANE IN ALL WET AREAS (RESTROOMS, KITCHENS, FOOD SERVICES, ETC...) OF THE SPACE. TENANT SHALL USE A 30 MIL POLYETHYLENE CLEAVAGE MEMBRANE (EQUAL TO NOBLESEAL TS) INSTALLED PER MANUFACTURERS RECOMMENDATIONS AND ANSI A108. MEMBRANE MUST BE EXTENDED UP THE WALL A MINIMUM OF 6" OR EQUAL TO THE HEIGHT OF THE FLOOR BASE.

•NO RUBBER OR VINYL BASE IS PERMITTED IN THE SALES AREA OF THE PREMISES.

• GC TO FIELD VERIFY ALL EXISTING CONDITIONS AND DIMENSIONS IN THE SPACE. FAILURE TO PROPERLY FIELD VERIFY EXISTING CONDITIONS DOES NOT RELIEVE THE TENANT OF ANY EXPENSES OR RESPONSIBILITIES RESULTING FROM THAT FAILURE.

• NOTHING IS PERMITTED TO BE ATTACHED TO, SUSPENDED FROM, OR PENETRATE LANDLORD'S STRUCTURE, FLOOR DECK, OR ROOF DECK. YOU MAY ATTACH, NON-DESTRUCTIVELY, TO OR SUSPEND FROM THE TOP CHORD OF THE JOIST OR THE STRUCTURAL STEEL WHICH EXISTS ABOVE THE TENANT SPACE. WHEN ATTACHING TO LANDLORD'S STRUCTURE, **DO NOT** DRILL, WELD, SCREW, OR SHOOT INTO STRUCTURE. ALTERNATIVE METHODS OF ATTACHMENT ONLY, NOTHING TO DAMAGE LANDLORD'S BASE BUILDING STRUCTURE. TENANT SHALL PROVIDE SIGNED AND SEALED STRUCTURAL DRAWINGS, BY A STRUCTURAL ENGINEER WITH LEGALLY ACTIVE REGISTRATION AS INDICATED BY ALL JURISDICTIONAL REQUIREMENTS, FOR ALL STRUCTURAL MODIFICATIONS FOR LANDLORD RECORDS.

• ANY LANDLORD EQUIPMENT, COMPONENT, AND / OR SERVICE FEEDING OTHER TENANT(S) THAT IS EXISTING IN THE SPACE MUST REMAIN VISIBLE AND ACCESSIBLE TO THE LANDLORD. TENANT SHALL INSTALL ACCESS PANELS AS REQUIRED TO MAINTAIN ACCESS. ACCESS PANELS SHALL BE LABEL TO PROPERLY IDENTIFY SYSTEM, COORDINATE WITH MALL OPERATIONS.

• ALL REAR ENTRIES MUST HAVE A DOORBELL FOR DELIVERIES.

• ALL CONCRETE PATCHING MUST BE LEVEL WITH THE EXISTING CONCRETE FLOOR.

• TENANT IS REQUIRED TO INSTALL A WATERPROOF MEMBRANE IN ALL WET AREAS (RESTROOMS, KITCHENS, FOOD SERVICES, ETC...) OF THE SPACE. TENANT SHALL USE A 30 MIL POLYETHYLENE CLEAVAGE MEMBRANE (EQUAL TO NOBLESEAL TS) INSTALLED PER MANUFACTURERS RECOMMENDATIONS AND ANSI A 108. MEMBRANE MUST BE EXTENDED UP THE WALL A MINIMUM OF 4" OR EQUAL TO THE HEIGHT OF THE FLOOR BASE.

DISPLAY FIXTURES, RACKS, SHELVING, AND STORAGE UNIT REQUIREMENTS:

• TENANT SHALL BE SOLELY RESPONSIBLE FOR THE DESIGN, INSTALLATION, AND USE OF ANY DISPLAY OR STORAGE SYSTEM(S) WITHIN THE PREMISE INCLUDING ALL COMPLIANCE WITH APPLICABLE BUILDING CODES, FIRE CODES AND THE REQUIREMENTS OF ANY INSURANCE RATING BUREAUS. IF ANYTHING DONE, OMITTED TO BE DONE OR SUFFERED TO BE DONE BY TENANT IN, UPON OR ABOUT THE PREMISES IN REGARD TO SUCH DISPLAY OR STORAGE SYSTEM(S) SHALL RESULT IN A FIRE CODE VIOLATION(S) AND THE TENANT FAILS TO TAKE CORRECTIVE ACTION AND / OR PAY THE ASSOCIATED FINE, REGARDLESS OF WHETHER ASSESSED AGAINST TENANT OR LANDLORD, WITHIN THE PRESCRIBED TIME PERIOD, THEN TENANT SHALL BE LIABLE FOR ALL COSTS AND EXPENSES RESULTING FROM SUCH VIOLATION(S) AND LANDLORD SHALL HAVE THE RIGHT TO CORRECT ANY SUCH

• TENANT DISPLAY FIXTURES IN THE RETAIL SPACE AND RACK / SHELVING / STORAGE UNITS IN THE STOCKROOM SHALL BE DESIGNED TO PROVIDE ADEQUATE CLEARANCE FOR THE AUTOMATIC (FIRE) SPRINKLER SYSTEM. NO DISPLAYS OR STORAGE SHOULD EXCEED 12FT AND CEILINGS MUST BE INSTALLED TO PROVIDE A MINIMUM OF 18" OF CLEARANCE BETWEEN THE TOP OF THE STORAGE SYSTEM AND SPRINKLER DEFLECTORS.

CONDITION(S) AT TENANT'S EXPENSE.

• TENANT DISPLAYS OR STORAGE HIGHER THAN 12'-0"
ARE CLASSIFIED AS "HIGH PILED STORAGE", WHICH
REQUIRES HIGH HAZARDOUS AUTOMATIC (FIRE)
SPRINKLER PROTECTION DESIGNED PER FM GLOBAL
LOSS PREVENTION DATA SHEET AND NFPA
REQUIREMENTS FOR THE STORAGE OF "GROUP A
PLASTIC" COMMODITIES. HIGH PILED STORAGE ALSO
REQUIRES A MINIMUM OF 36" OF CLEARANCE
BETWEEN THE TOP OF STORAGE AND SPRINKLER
DEFLECTORS.

• TENANT MOBILE / COMPACT STORAGE SYSTEMS
SHALL BE CONSTRUCTED OF WIRE MESH SHELVES.
HOWEVER, IF CONSTRUCTED WITH SOLID SHELVES
(WOOD OR STEEL), THE UNITS SHALL BE INSTALLED
WITH A MINIMUM OF A 3" SPACER TO PROVIDE SPACE
BETWEEN UNITS AT MAXIMUM 5'-0" INTERVALS.

• TENANT'S ARCHITECT AND GENERAL CONTRACTOR SHALL PROVIDE THE FOLLOWING INFORMATION TO THE MALL REQUIRED SPRINKLER CONTRACTOR REGARDING STOCK / STORAGE AREA:

* TYPE OF STORAGE SYSTEM(S). (INCLUDING DETAILS


OF THE STORAGE SYSTEM(S).

* TYPE OF SHELVING. (WIRE MESH / SOLID WOOD / SOLID STEEL, ETC.) O TYPE OF COMMODITIES.
(PLASTICS, AEROSOL'S, CLOTHING, ETC)

* ELEVATION OF HIGHEST SHELF / CEILING HEIGHT.

• LANDLORD STRONGLY PREFERS USE OF ENERGY STAR PRODUCTS AND/OR EQUIPMENT WHENEVER POSSIBLE DURING TENANT BUILD OUT, WHICH CAN REDUCE ENERGY CONSUMPTION.

Scale: 1/4" = 1'-0"

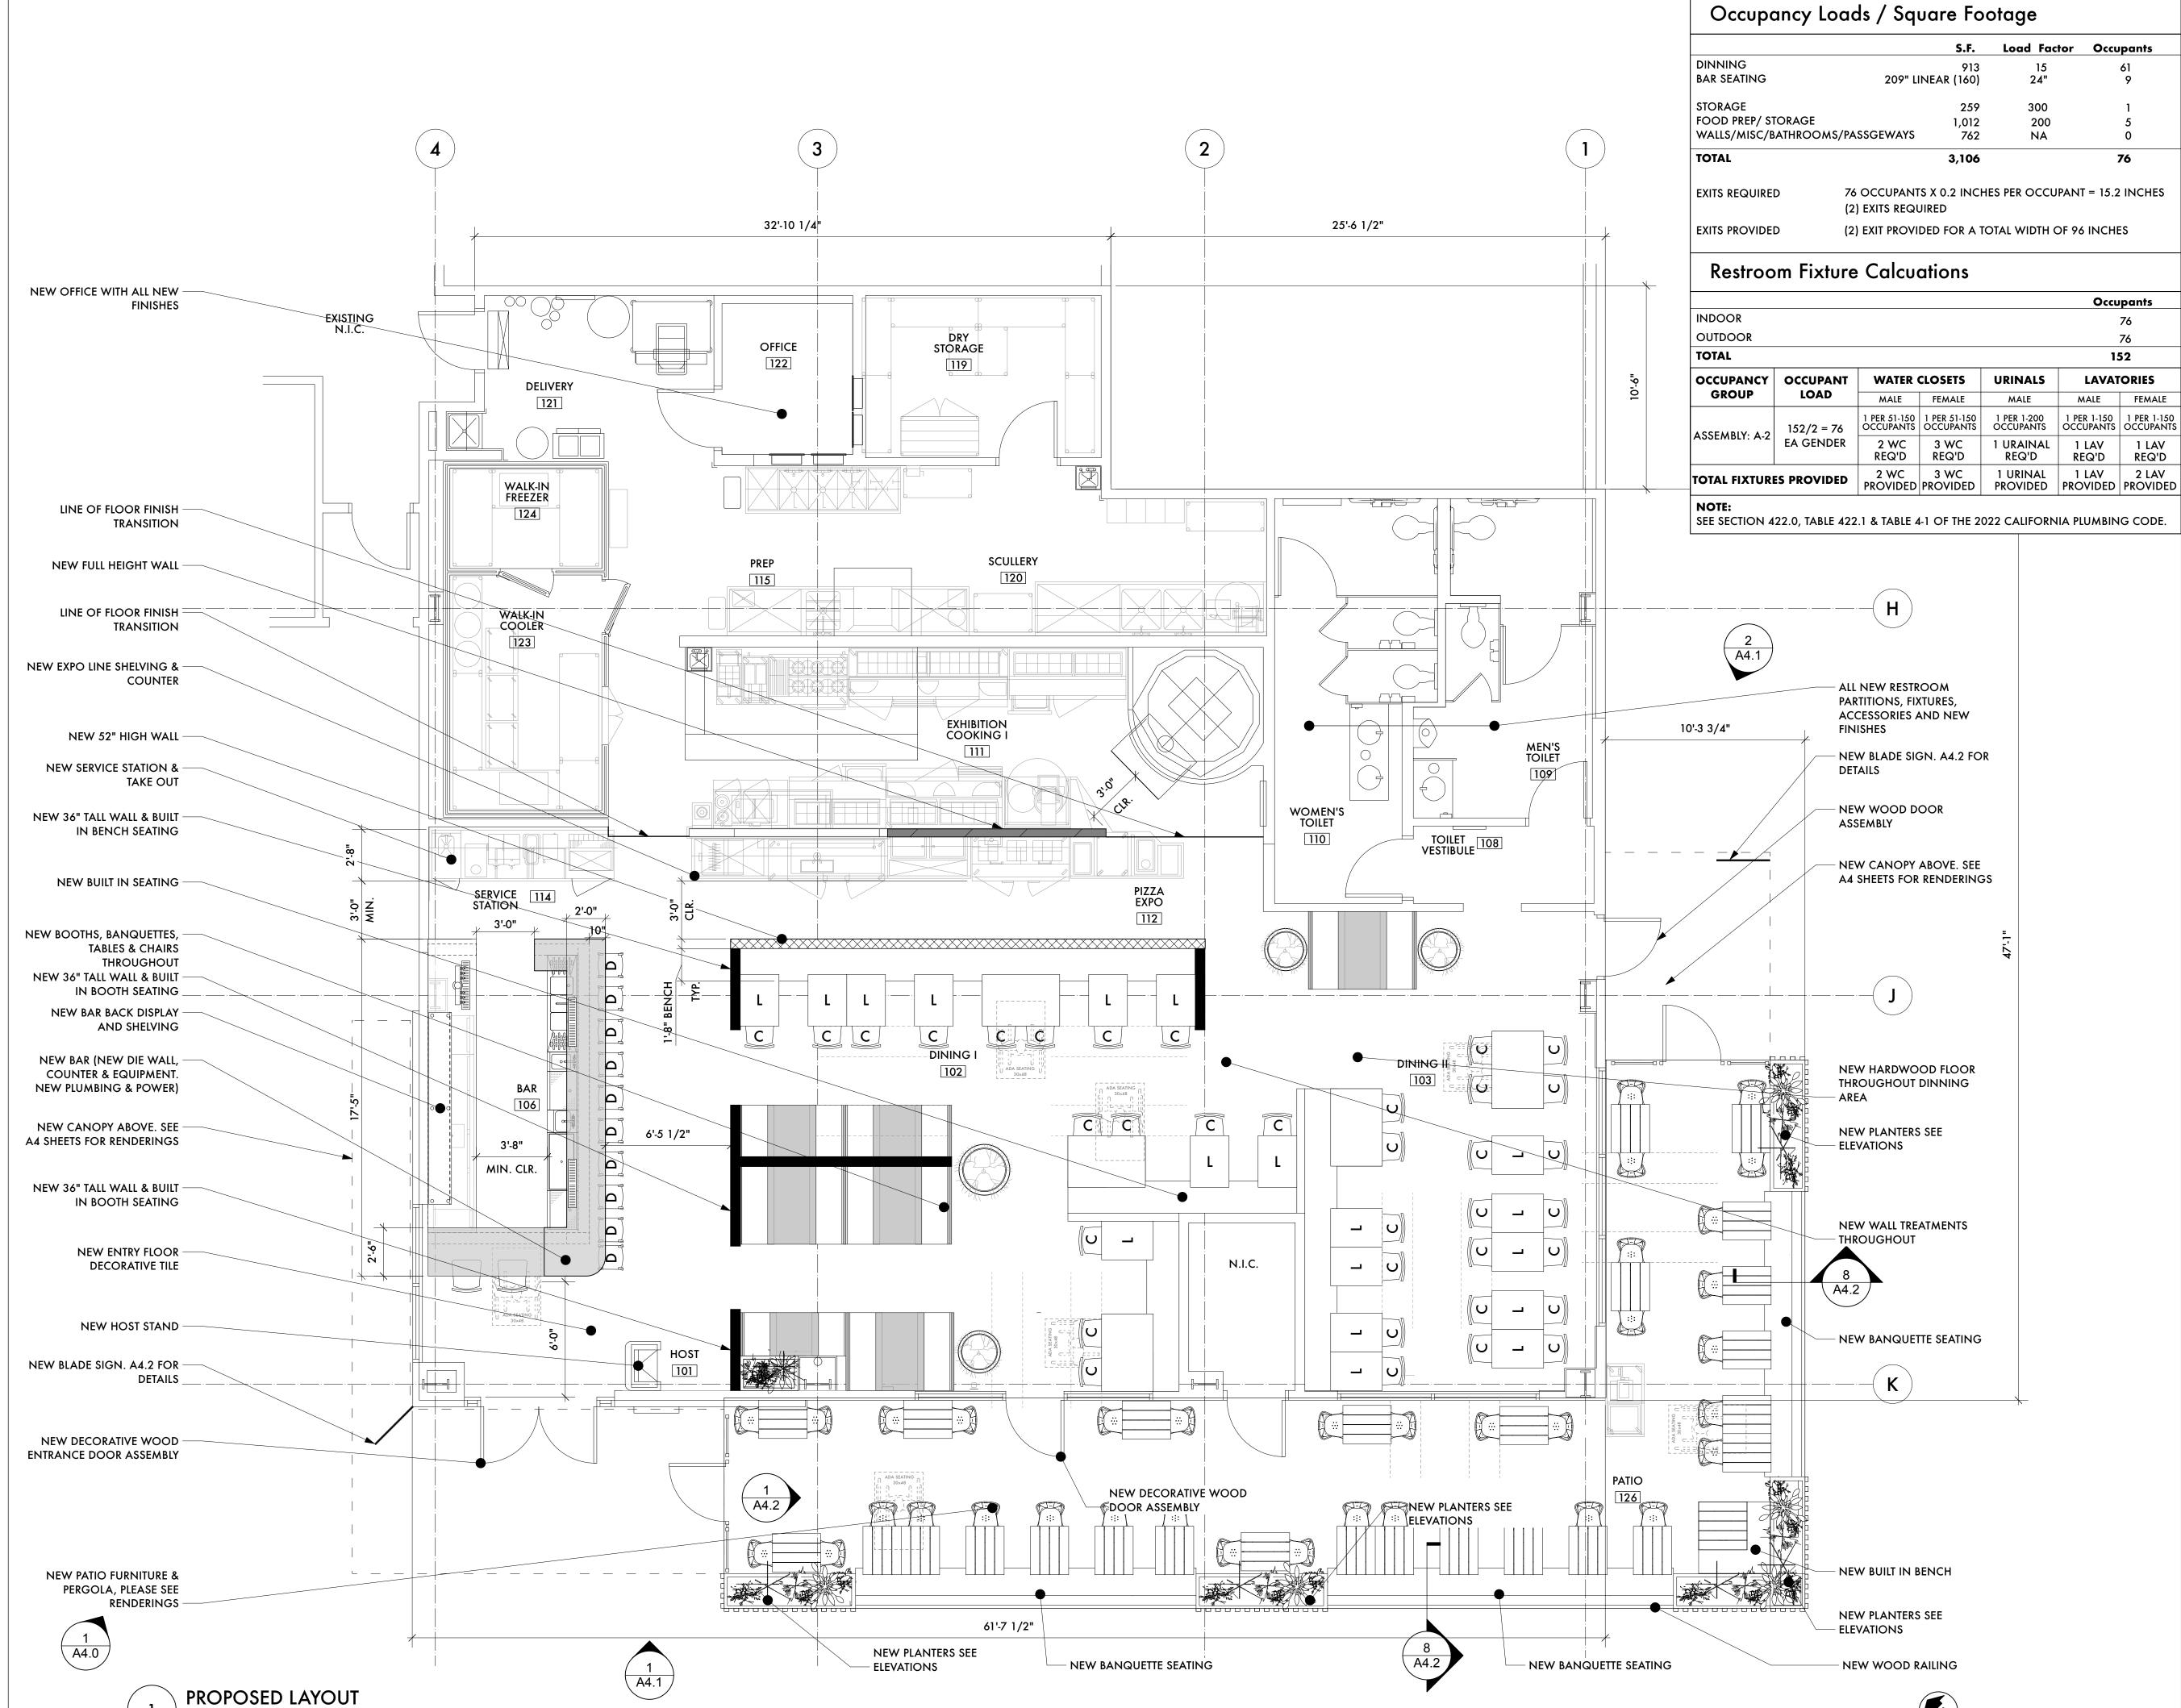

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DELAROSA

180 EL CAMINO REAL,

BLDG D,

SUITE #136B

PALO ALTO, CA 94304

MAX A. CROME

C-25487

February 2025

SUBMITTAL

PROPOSED PLAN

SHEET NUMBER

2/26/24

PLANNING REVIEW



ROMEArchitecture

SUBMITTAL
PLANNING REVIEW

EATHER REVIEW

RCP DEMO

SHEET NUMBER

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REFLECTED CEILING PLAN COMMENTS: • IF NOT ALREADY EXISTING, TENANT MUST PROVIDE

A SEALED PARTITION ABOVE THE STOREFRONT TO SEPARATE THE COMMON AREA CEILING FROM THE TENANT'S SPACE. (SHALL BE RATED IF REQUIRED BY CODE AND ALL PENETRATION SHALL COMPLY AND BE LABELED WITH THE REQUIRED NFPA RATING.)

• NOTHING IS PERMITTED TO BE ATTACHED TO, SUSPENDED FROM, OR PENETRATE LANDLORD'S STRUCTURE, FLOOR DECK, OR ROOF DECK. YOU MAY ATTACH, NON-DESTRUCTIVELY, TO OR SUSPEND FROM THE TOP CHORD OF THE JOIST OR THE STRUCTURAL STEEL WHICH EXISTS ABOVE THE TENANT SPACE. WHEN ATTACHING TO LANDLORD'S STRUCTURE, DO NOT DRILL, WELD, SCREW, OR SHOOT INTO STRUCTURE. ALTERNATIVE METHODS OF ATTACHMENT ONLY, NOTHING TO DAMAGE LANDLORD'S BASE BUILDING STRUCTURE. TENANT SHALL PROVIDE SIGNED AND SEALED STRUCTURAL DRAWINGS, BY A STRUCTURAL ENGINEER WITH LEGALLY ACTIVE REGISTRATION AS INDICATED BY ALL JURISDICTIONAL REQUIREMENTS, FOR ALL STRUCTURAL MODIFICATIONS FOR LANDLORD RECORDS.

 ANY LANDLORD EQUIPMENT, COMPONENT, AND / OR SERVICE FEEDING OTHER TENANT(S) THAT IS EXISTING IN THE SPACE MUST REMAIN VISIBLE AND ACCESSIBLE TO THE LANDLORD. TENANT SHALL INSTALL ACCESS PANELS AS REQUIRED TO MAINTAIN ACCESS. ACCESS PANELS SHALL BE LABEL TO PROPERLY IDENTIFY SYSTEM, COORDINATE WITH MALL OPERATIONS.

• SIMON REQUIRES ALL TENANTS TO USE LANDLORD'S REQUIRED CONTRACTOR FOR ALL SPRINKLER WORK. REFER TO SPRINKLER COMMENTS FOR FURTHER REQUIREMENTS.

SECURITY CAMERA COMMENTS:

 SECURITY EQUIPMENT MUST BE INSTALLED WITHIN THE PREMISES; CAMERAS AND/OR SECURITY EQUIPMENT ARE NOT PERMITTED ON THE EXTERIOR OF THE PREMISES UNLESS APPROVED IN WRITING BY LANDLORD. HOWEVER, IN CASES WHERE LANDLORD APPROVES EXTERIOR CAMERAS OR EQUIPMENT, THE CAMERAS OR EQUIPMENT SHOULD BE POSITIONED AS TO LIMIT VIEWING AREA AND SHALL CAPTURE IMAGES OF THE TENANT'S DOORWAYS ONLY AND SHALL NOT CAPTURE IMAGES OUTSIDE OF THE PREMISES. IN CASES WHERE A TENANT MAY HAVE AN APPROVED PATIO AREA, ALL CAMERAS OR EQUIPMENT SHALL BE INSTALLED AND OPERATED SO AS TO CAPTURE ONLY THE APPROVED PATIO AND NO COMMON AREA.


 ALL EQUIPMENT, INSTALLATION METHODS AND LOCATIONS MUST BE APPROVED BY LANDLORD IN WRITING PRIOR TO INSTALLATION.

• NO SIGNAL SHALL BE EMITTED OUTSIDE THE PREMISES.

 ABSOLUTELY NO DISTRIBUTION, ELECTRONICALLY OR OTHERWISE, OF CAPTURED IMAGE OR VIDEO TO ANY THIRD PARTY OTHER THAN LANDLORD UPON REQUEST.

• SECURITY CAMERAS, VISION PANELS, OR "BUBBLES" SHALL NOT BE VISIBLE TO PUBLIC VIEW IN THE DESIGN CONTROL ZONE OR ON PATIOS FROM THE COMMON AREA.

Scale: 1/4" = 1'-0"

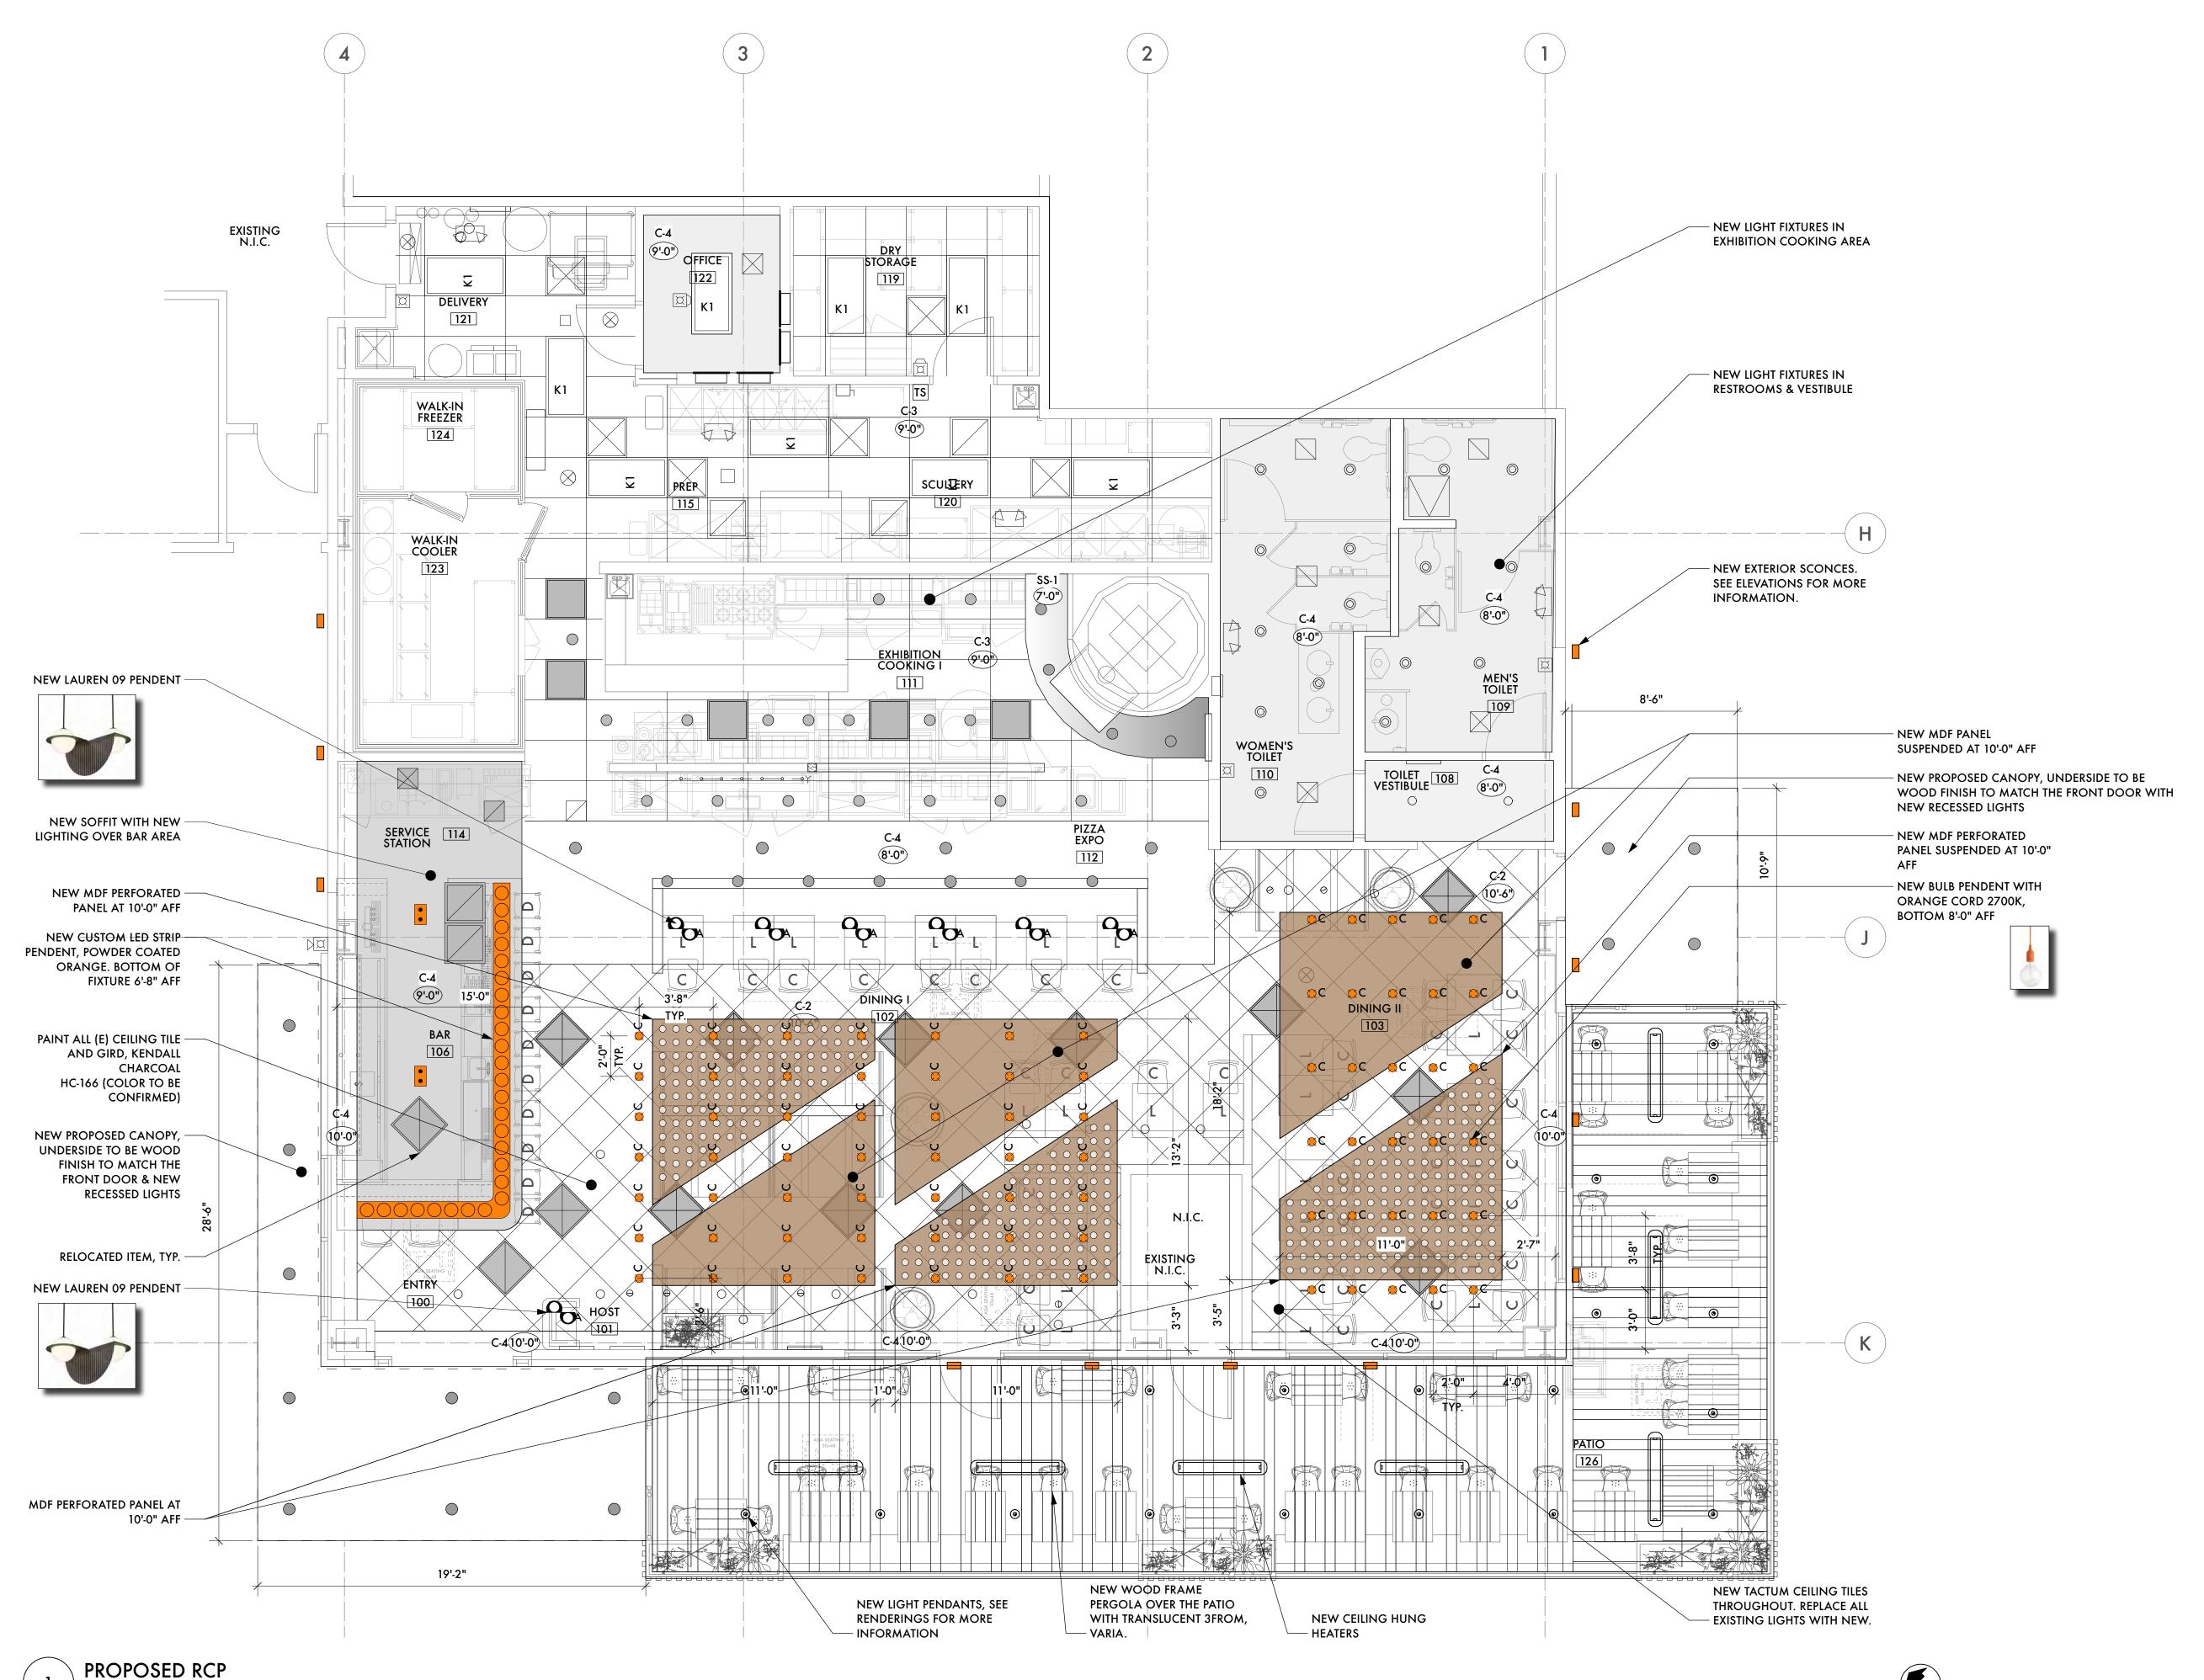

DELAROSA 180 EL CAMINO REAL, BLDG D, SUITE #136B PALO ALTO, CA 94304



SUBMITTAL 2/26/24

PLANNING REVIEW

PROPOSED

SHEET NUMBER

2/26/24

SHEET NUMBER

A4.0




SUBMITTAL

2/26/24

ELEVATIONS

A4.1

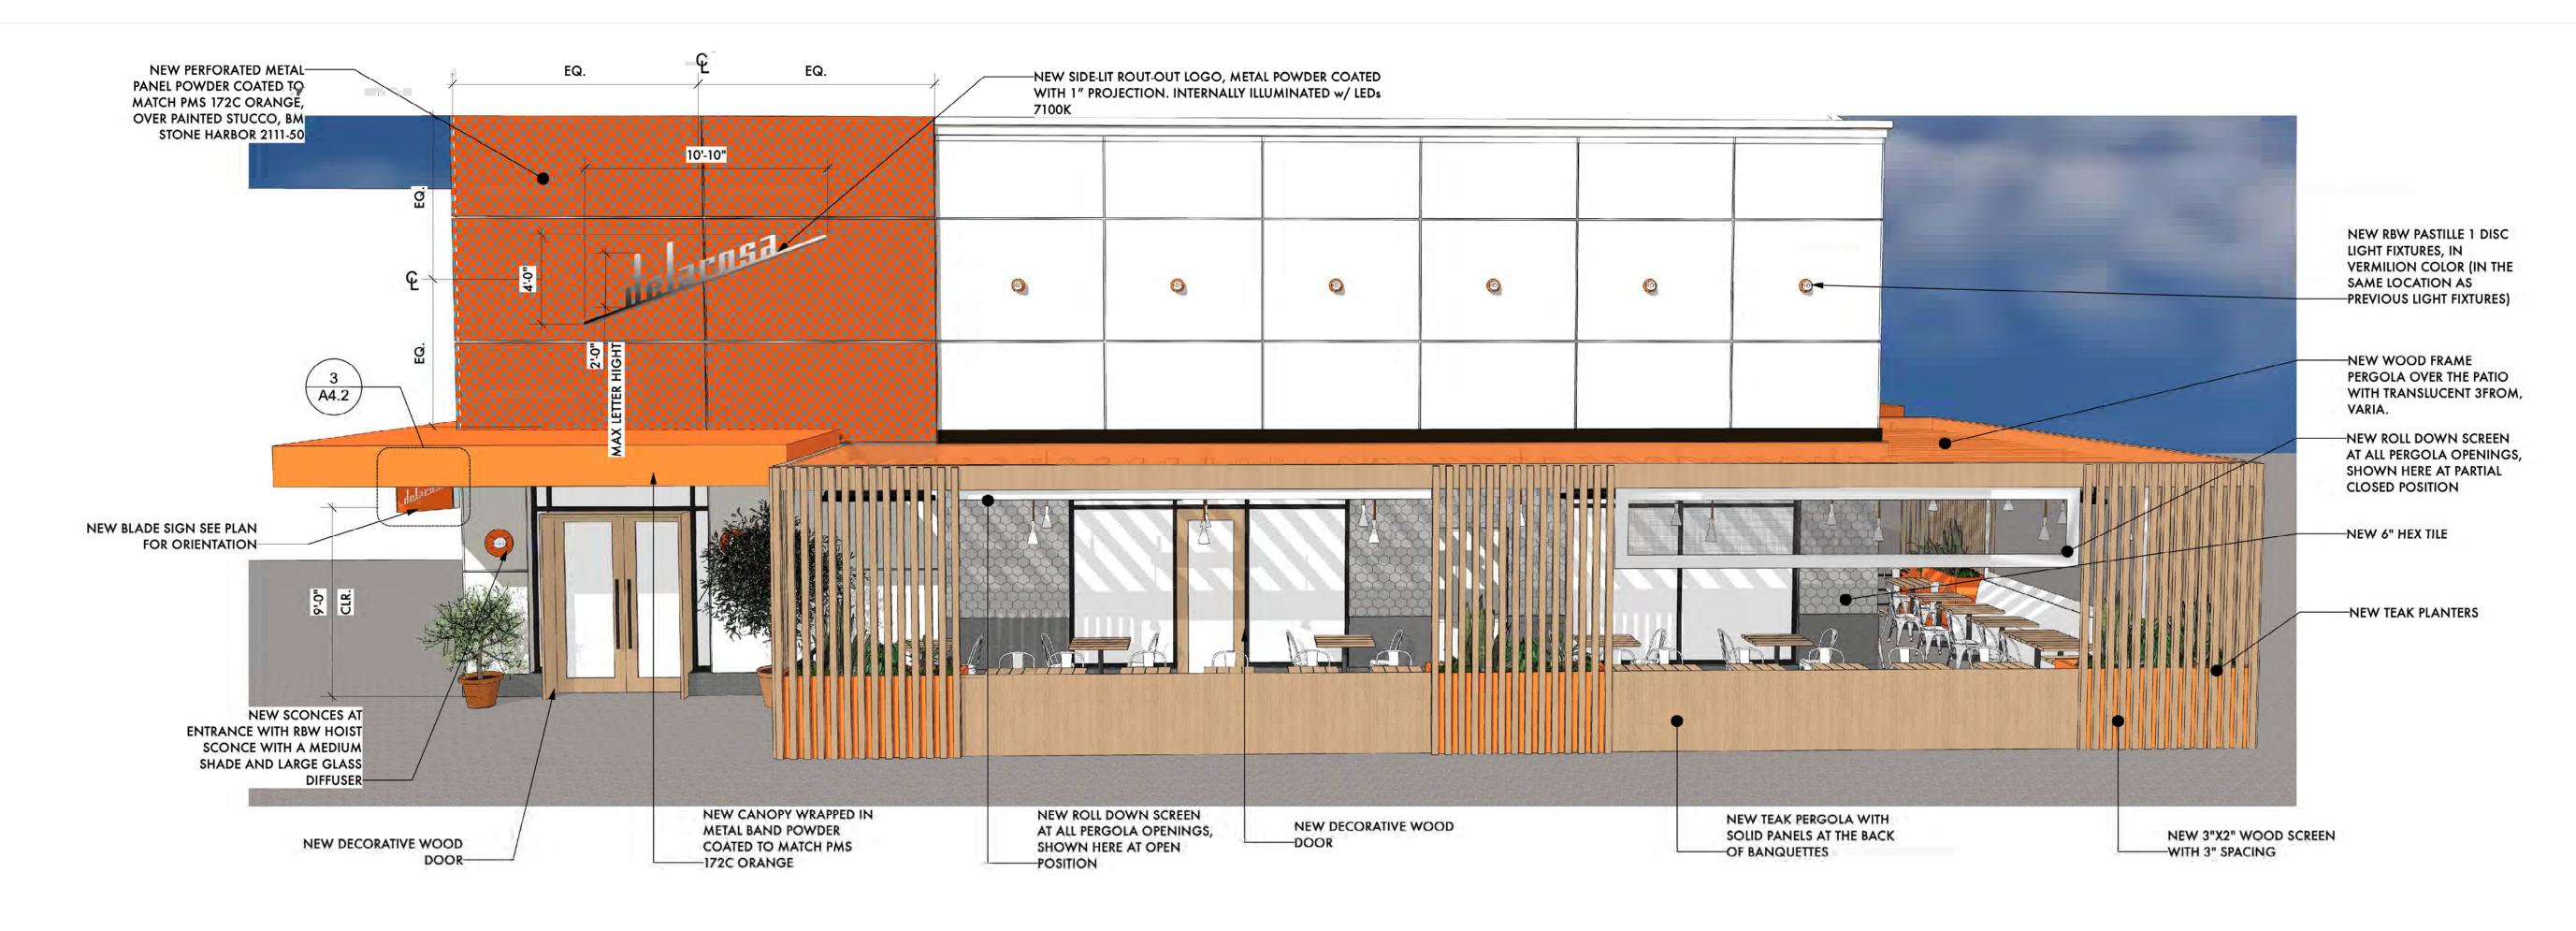

FRONT ELEVATION
Scale: 1/4" = 1'-0"





ROMEArchitecture

SUBMITTAL
PLANNING REVIEW 2/26/24


EXTERIOR ELEVATIONS & DETAILS

SHEET NUMBER

A4.2





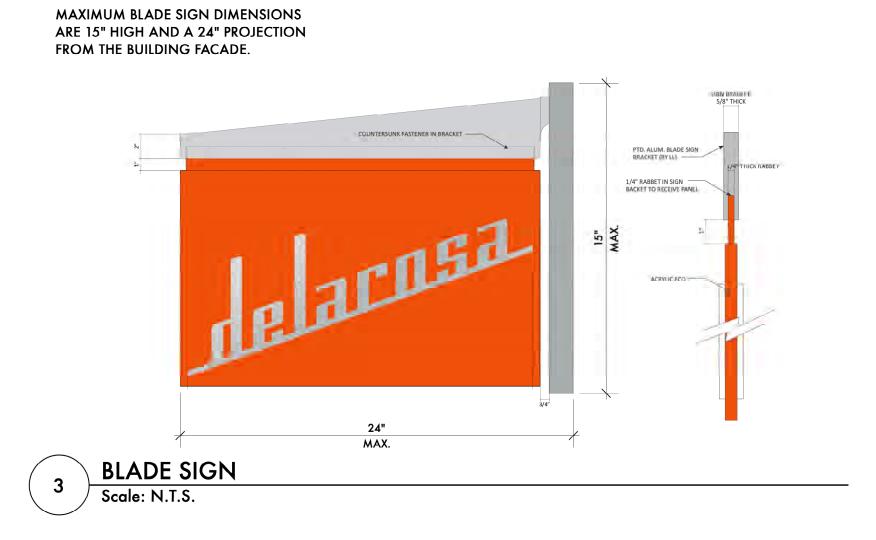

SHEET NUMBER


BOARD



Bar top, tabletops – white oak



Flooring – white oak planks

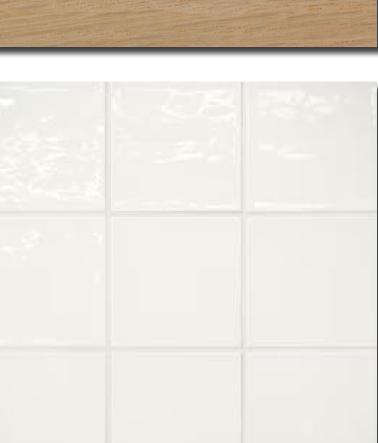

Front bar & Cookline -4x4 white wall tile




Expo counter – Carrera marble



Cabinetry, server station - grey washed stained wood



Bar reference image

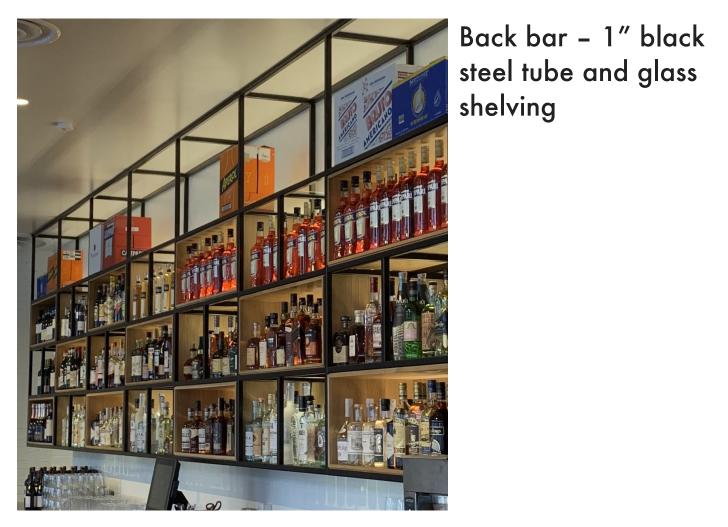



Dinning room image for reference

SHEET NUMBER

A5.1



Chantilly Lace


OC-65



Grey Base/ Wall Tile: Fireclay 2.5"x8" Brick in Rocky Mountains



PERFORATED ALUM. PANELS NON-LIT .080 ALUM. FACE PTD. TO MATCH PMS 172C ORANGE, W/ 2" PERFORATED HOLES

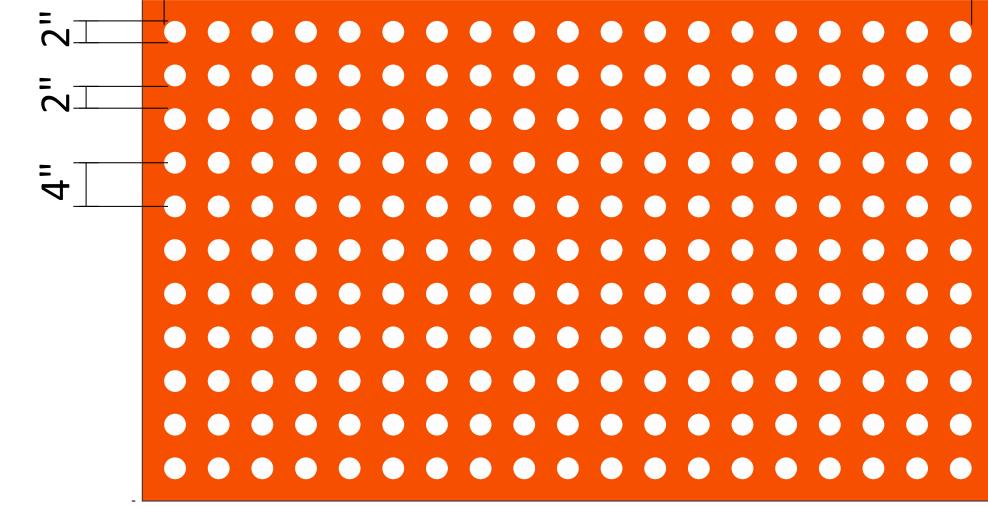



RBW Hoist Sconce with a medium shade and large glass diffuser at the entry doors



RBW Pastille 1 Disc on the wall above



Teak tables



White tolix chairs