616 RAMONA STREET PALO ALTO, CA 94301

PRELIMINARY ARB SUBMISSION 08/16/2023



PROJECT CONSULTANTS	PROJECT INFORMATION	GENERAL ZONING COMPLIANCE ANALYSIS DRAWING INDEX	
CLIENT HAMILTON INVESTORS, LLC. 664 GILMAN STREET PALO ALTO, CA 94301 CONTACT: STEPHEN RELLER sreller@randmproperties.com CONTACT: MARK MORAGNE mmoragne@randmproperties.com ARCHITECT HAYES GROUP ARCHITECTS 2657 SPRING STREET REDWOOD CITY, CA 94063 650.365.0600 PH 650.365.0670 FAX CONTACT: KEN HAYES x:115 khayes@thehayesgroup.com	PROJECT DESCRIPTION: PARTIAL BUILDING DEMOLITION, LESS THAN 50 % OF EXTERIOR WALLS, AND REMODEL OF EXISTING OFFICE BUILDING WITH AN ADDITION USING TDR AND EXEMPT FLOOR AREA EARNED FROM ADA UPGRADES. SEE A0.5 APN: 120-27-012 ZONING: CD-C(P) CONSTRUCTION TYPE: V-B OCCUPANCY: B / M BUILDING CODES: 2022 CBC 2022 CFC 2022 CFC 2022 CFC 2022 CPC 2022 CPC 2022 CPC 2022 CALIFORNIA ENERGY CODE 2022CALIFORNIA GREEN BUILDING CODE ALL APPLICABLE LOCAL, COUNTY, STATE AND	REQUIRED /ALLOWED PROPOSED COMPLIES HISTORIC CATEGORY: NONE FLOOD ZONE: NONE RAMONA ST SETBACK: MIN. 4'SSB 0' YES- (E) NON- COMPLYING INTERIOR SIDE SETBACK: MIN. 0' 0' YES MAXIMUM FIGHT: 50-0' 41'-10" YES MAXIMUM FIGHT: 10:1 (3.0:1 WITH TIDR AND EXEMPT FLOOR AREA) PROPOSED LOT COVERAGE: MAX 5.125 SF (100%) 4,860 SF (95%) YES A 0.1 COVER SHEET; DRAWING INDEX, VICINITY MAP, BUILDING INFO, PROJECT TEAM SU-1 SITE SURVEY A 0.2 STREETSCAPE; EXISTING & PROPOSED A 0.3 EXISTING BUILDING FLOOR PLANS A 0.4 EXISTING BUILDING FLOOR PLANS A 0.5 EXISTING ADA FLOOR AREA SUMMARY CHARTS & DIAGRAM A 0.5 EXISTING ADA FLOOR AREA OPERATIONS SUMMARY CHARTS & DIAGRAMS A 0.6 BUILDING FLOOR AREA OPERATIONS SUMMARY CHARTS & DIAGRAMS A 0.7 PROPOSED FLOOR AREA CHARTS & DIAGRAMS A 0.7 P	DRAWING CONTENT COVER SHEET
SURVEYOR WADE HAMMOND CIVIL ENGINEERING + LAND SURVEYING 36660 NEWARK BLVD SUITE C NEWARK, CA 94560 510.579.6112 PH CONTACT: L. WADE HAMMOND wade@whlandsurveyor.com	GREEN BUILDING: PROJECT TO COMPLY WITH CITY OF PALO ALTO'S GREEN BUILDING ORDINANCE - CAL GREEN TIER 2 FOR NON RESIDENTIAL FIRE SPRINKLERS: (N) SPRINKLERS THROUGHOUT TRASH/RECYCLE: ON-SITE	EXISTING FLOOR AREA: PROPOSED FLOOR AREA: REQUIRED PARKING: SEE A0.7 SEE A	
6 To Kamona_ BIM_ Arch	FIRE DEPARTMENT NOTES 1. FIRE ALARM SYSTEM TO COMPLY WITH CBC'22 907.2.2.	The Miseum of American Fertises Delivery and	JOB NUMBER: 2123.00 SCALE: AS NOTED DRAWN BY: MS All drawings and written materials or herein constitute the original & unput work of the Architect and the same in be duplicated, used or disclosed with written consent of the Architect. © Hayes Group Architects, Inc. DRAWING NUMBER



HAYES GROUP ARCHITECTS, INC. 2657 SPRING STREET REDWOOD CITY, CA 94063 P: 650.365.0600 F: 650.365.0670 www.thehayesgroup.com

PROJECT ADDRESS:


616 RAMONA STREET PALO ALTO, CA 94301

ISSUANCE:

PRELIMINARY **ARB** SUBMISSION 08.16.2023

NO. DESCRIPTION:

All drawings and written materials contained herein constitute the original & unpublished work of the Architect and the same may not be duplicated, used or disclosed without the written consent of the Architect.

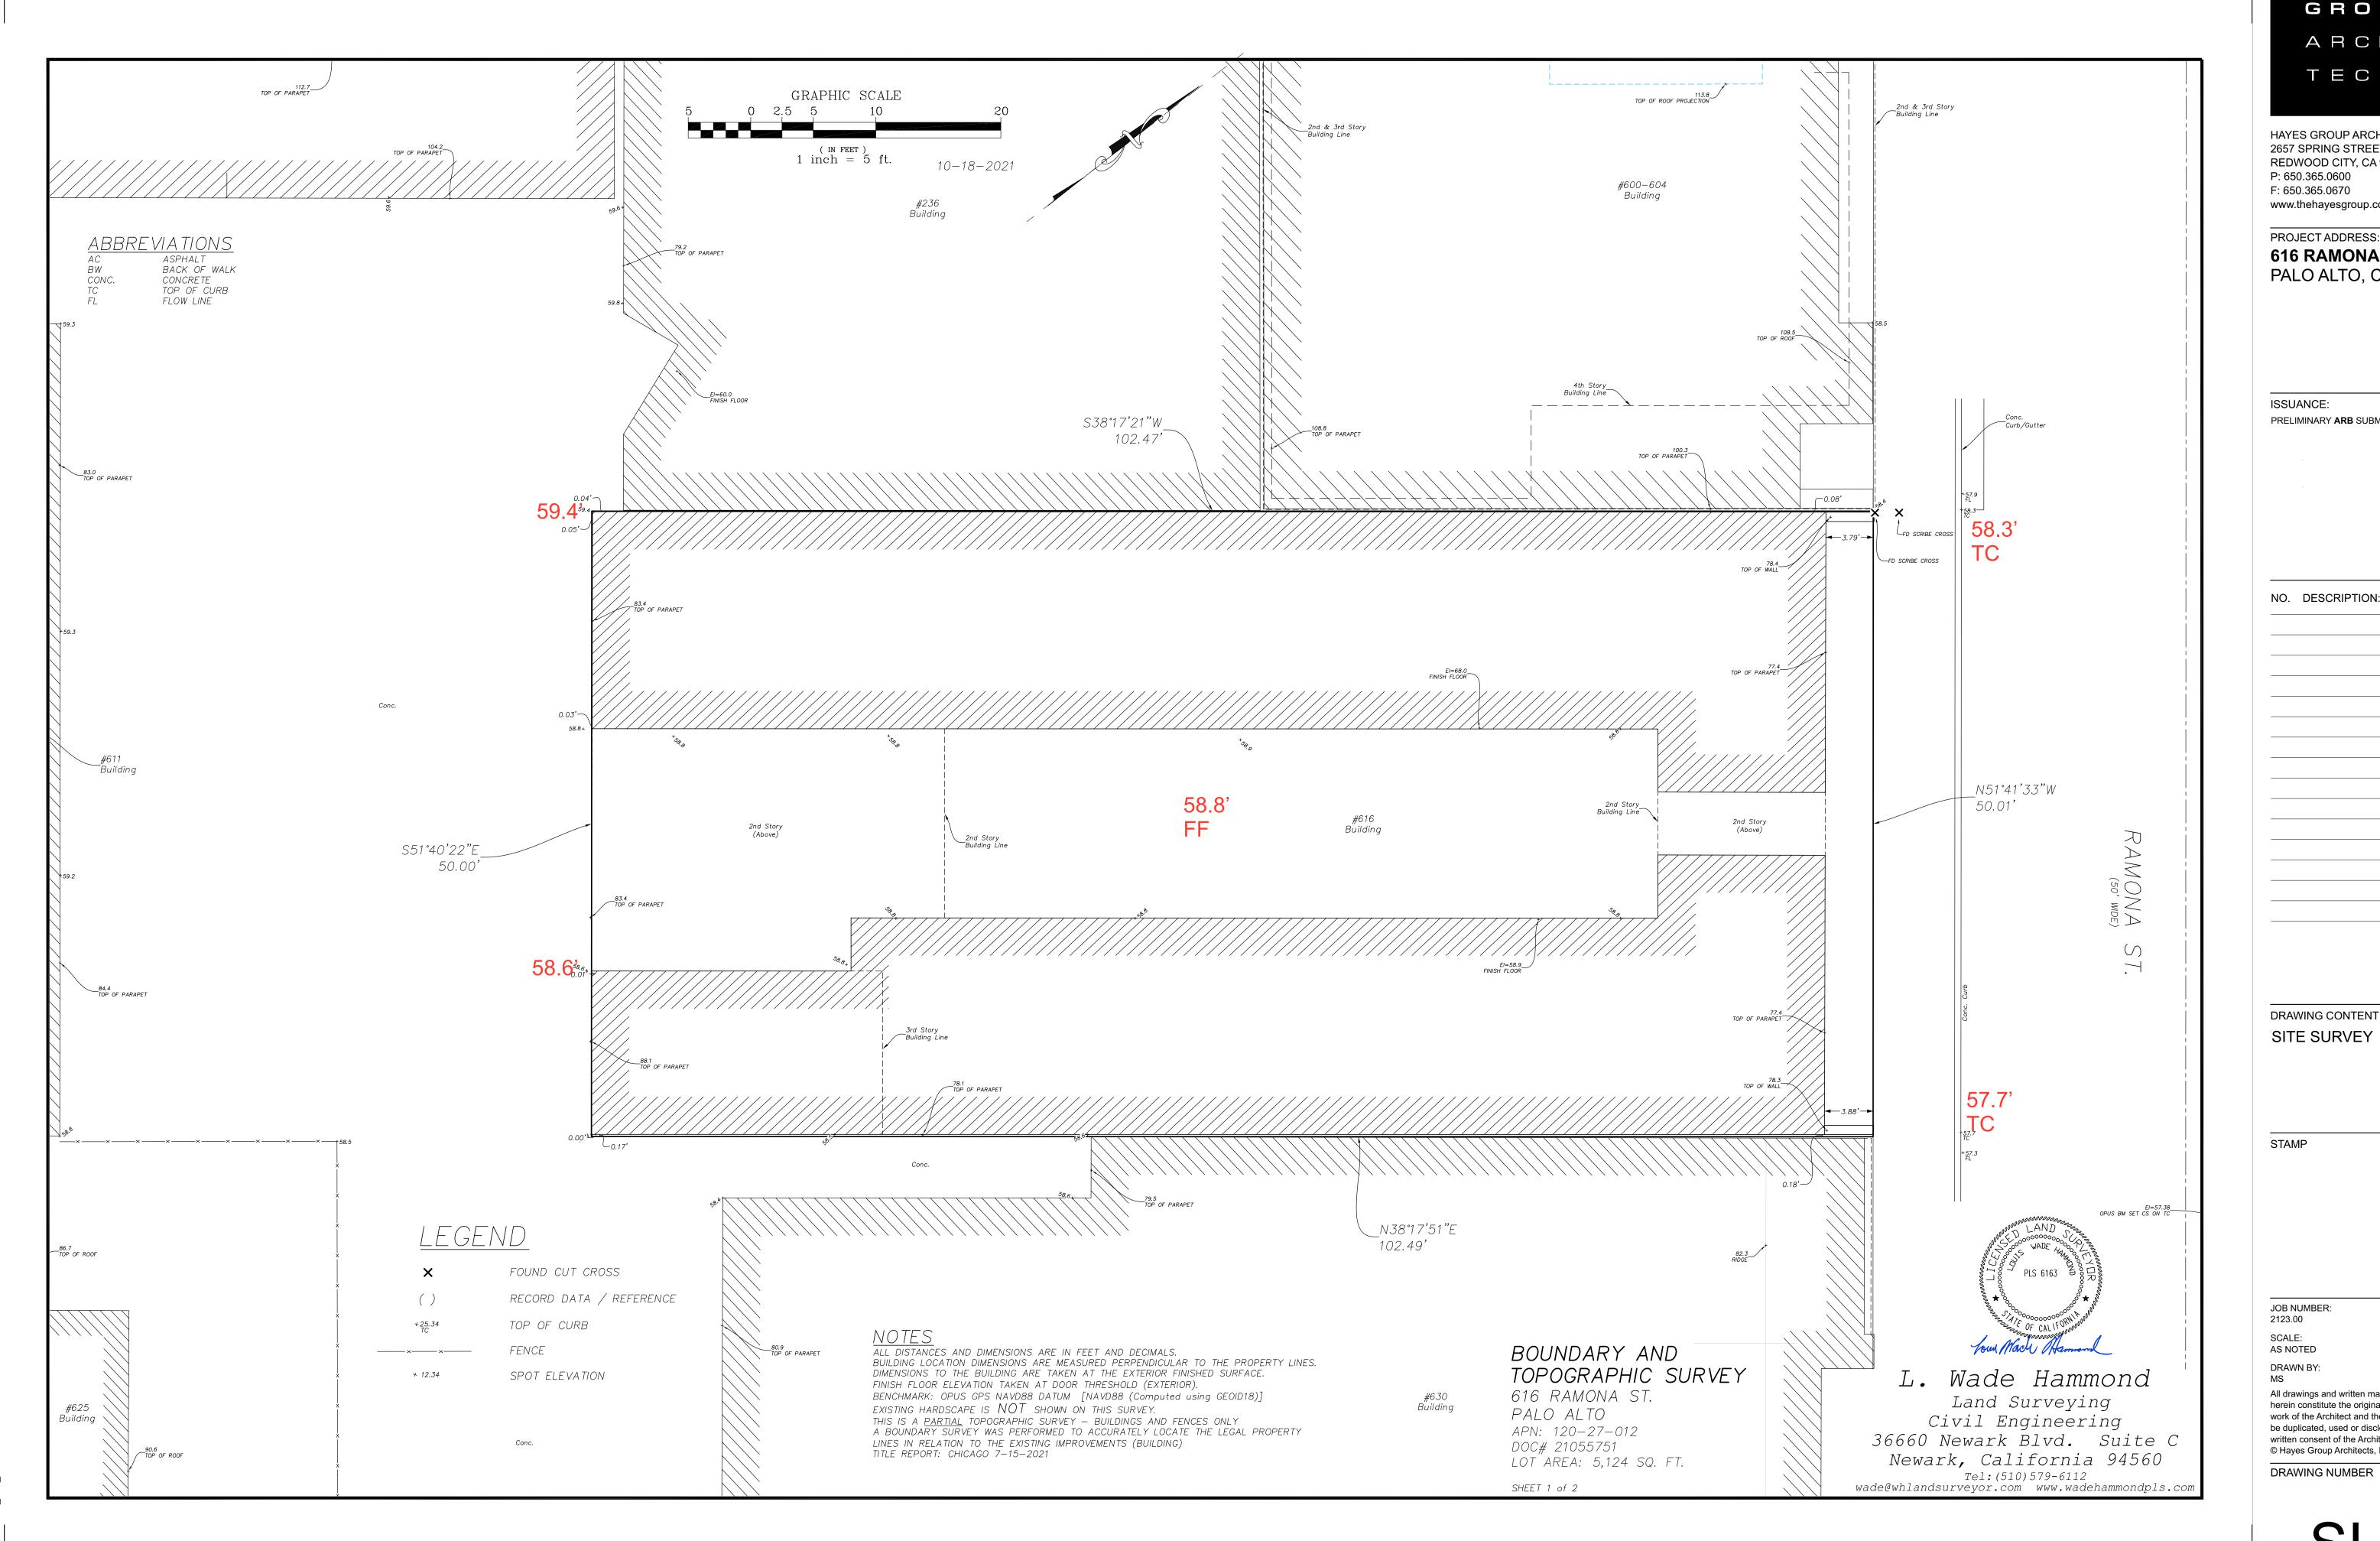

HAYES GROUP ARCHITECTS, INC. 2657 SPRING STREET REDWOOD CITY, CA 94063 P: 650.365.0600 F: 650.365.0670 www.thehayesgroup.com

PROJECT ADDRESS:

616 RAMONA STREET PALO ALTO, CA 94301

ISSUANCE:

PRELIMINARY **ARB** SUBMISSION 08.16.2023

NO. DESCRIPTION:

DATE:

DRAWING CONTENT

STAMP

JOB NUMBER:

2123.00 SCALE: AS NOTED

DRAWN BY: MS

All drawings and written materials contained herein constitute the original & unpublished work of the Architect and the same may not be duplicated, used or disclosed without the written consent of the Architect. © Hayes Group Architects, Inc.

GROUP ARCHI TECTS HAYES GROUP ARCHITECTS, INC. 2657 SPRING STREET REDWOOD CITY, CA 94063 P: 650.365.0600 F: 650.365.0670 www.thehayesgroup.com PROJECT ADDRESS: 616 RAMONA STREET PALO ALTO, CA 94301 ISSUANCE: PRELIMINARY **ARB** SUBMISSION 08.16.2023 DATE: NO. DESCRIPTION: HAMILTON AVE. 235 HAMILTON AVE. 548 RAMONA ST. 542 RAMONA ST. PROJECT SITE 616 RAMONA ST. 630 RAMONA ST. 240 HAMILTON AVE. EXISTING RAMONA STREETSCAPE ELEVATION DRAWING CONTENT SCALE: N.T.S. STREETSCAPES, SITE PHOTOS STAMP JOB NUMBER: 2123.00 SCALE: AS NOTED

HAMILTON AVE.

PROJECT SITE 616 RAMONA ST.

240 HAMILTON AVE.

630 RAMONA ST.

235 HAMILTON AVE.

HAYES

DRAWN BY: MS All drawings and written materials contained


herein constitute the original & unpublished work of the Architect and the same may not be duplicated, used or disclosed without the written consent of the Architect.

© Hayes Group Architects, Inc.

DRAWING NUMBER

542 RAMONA ST.

548 RAMONA ST.

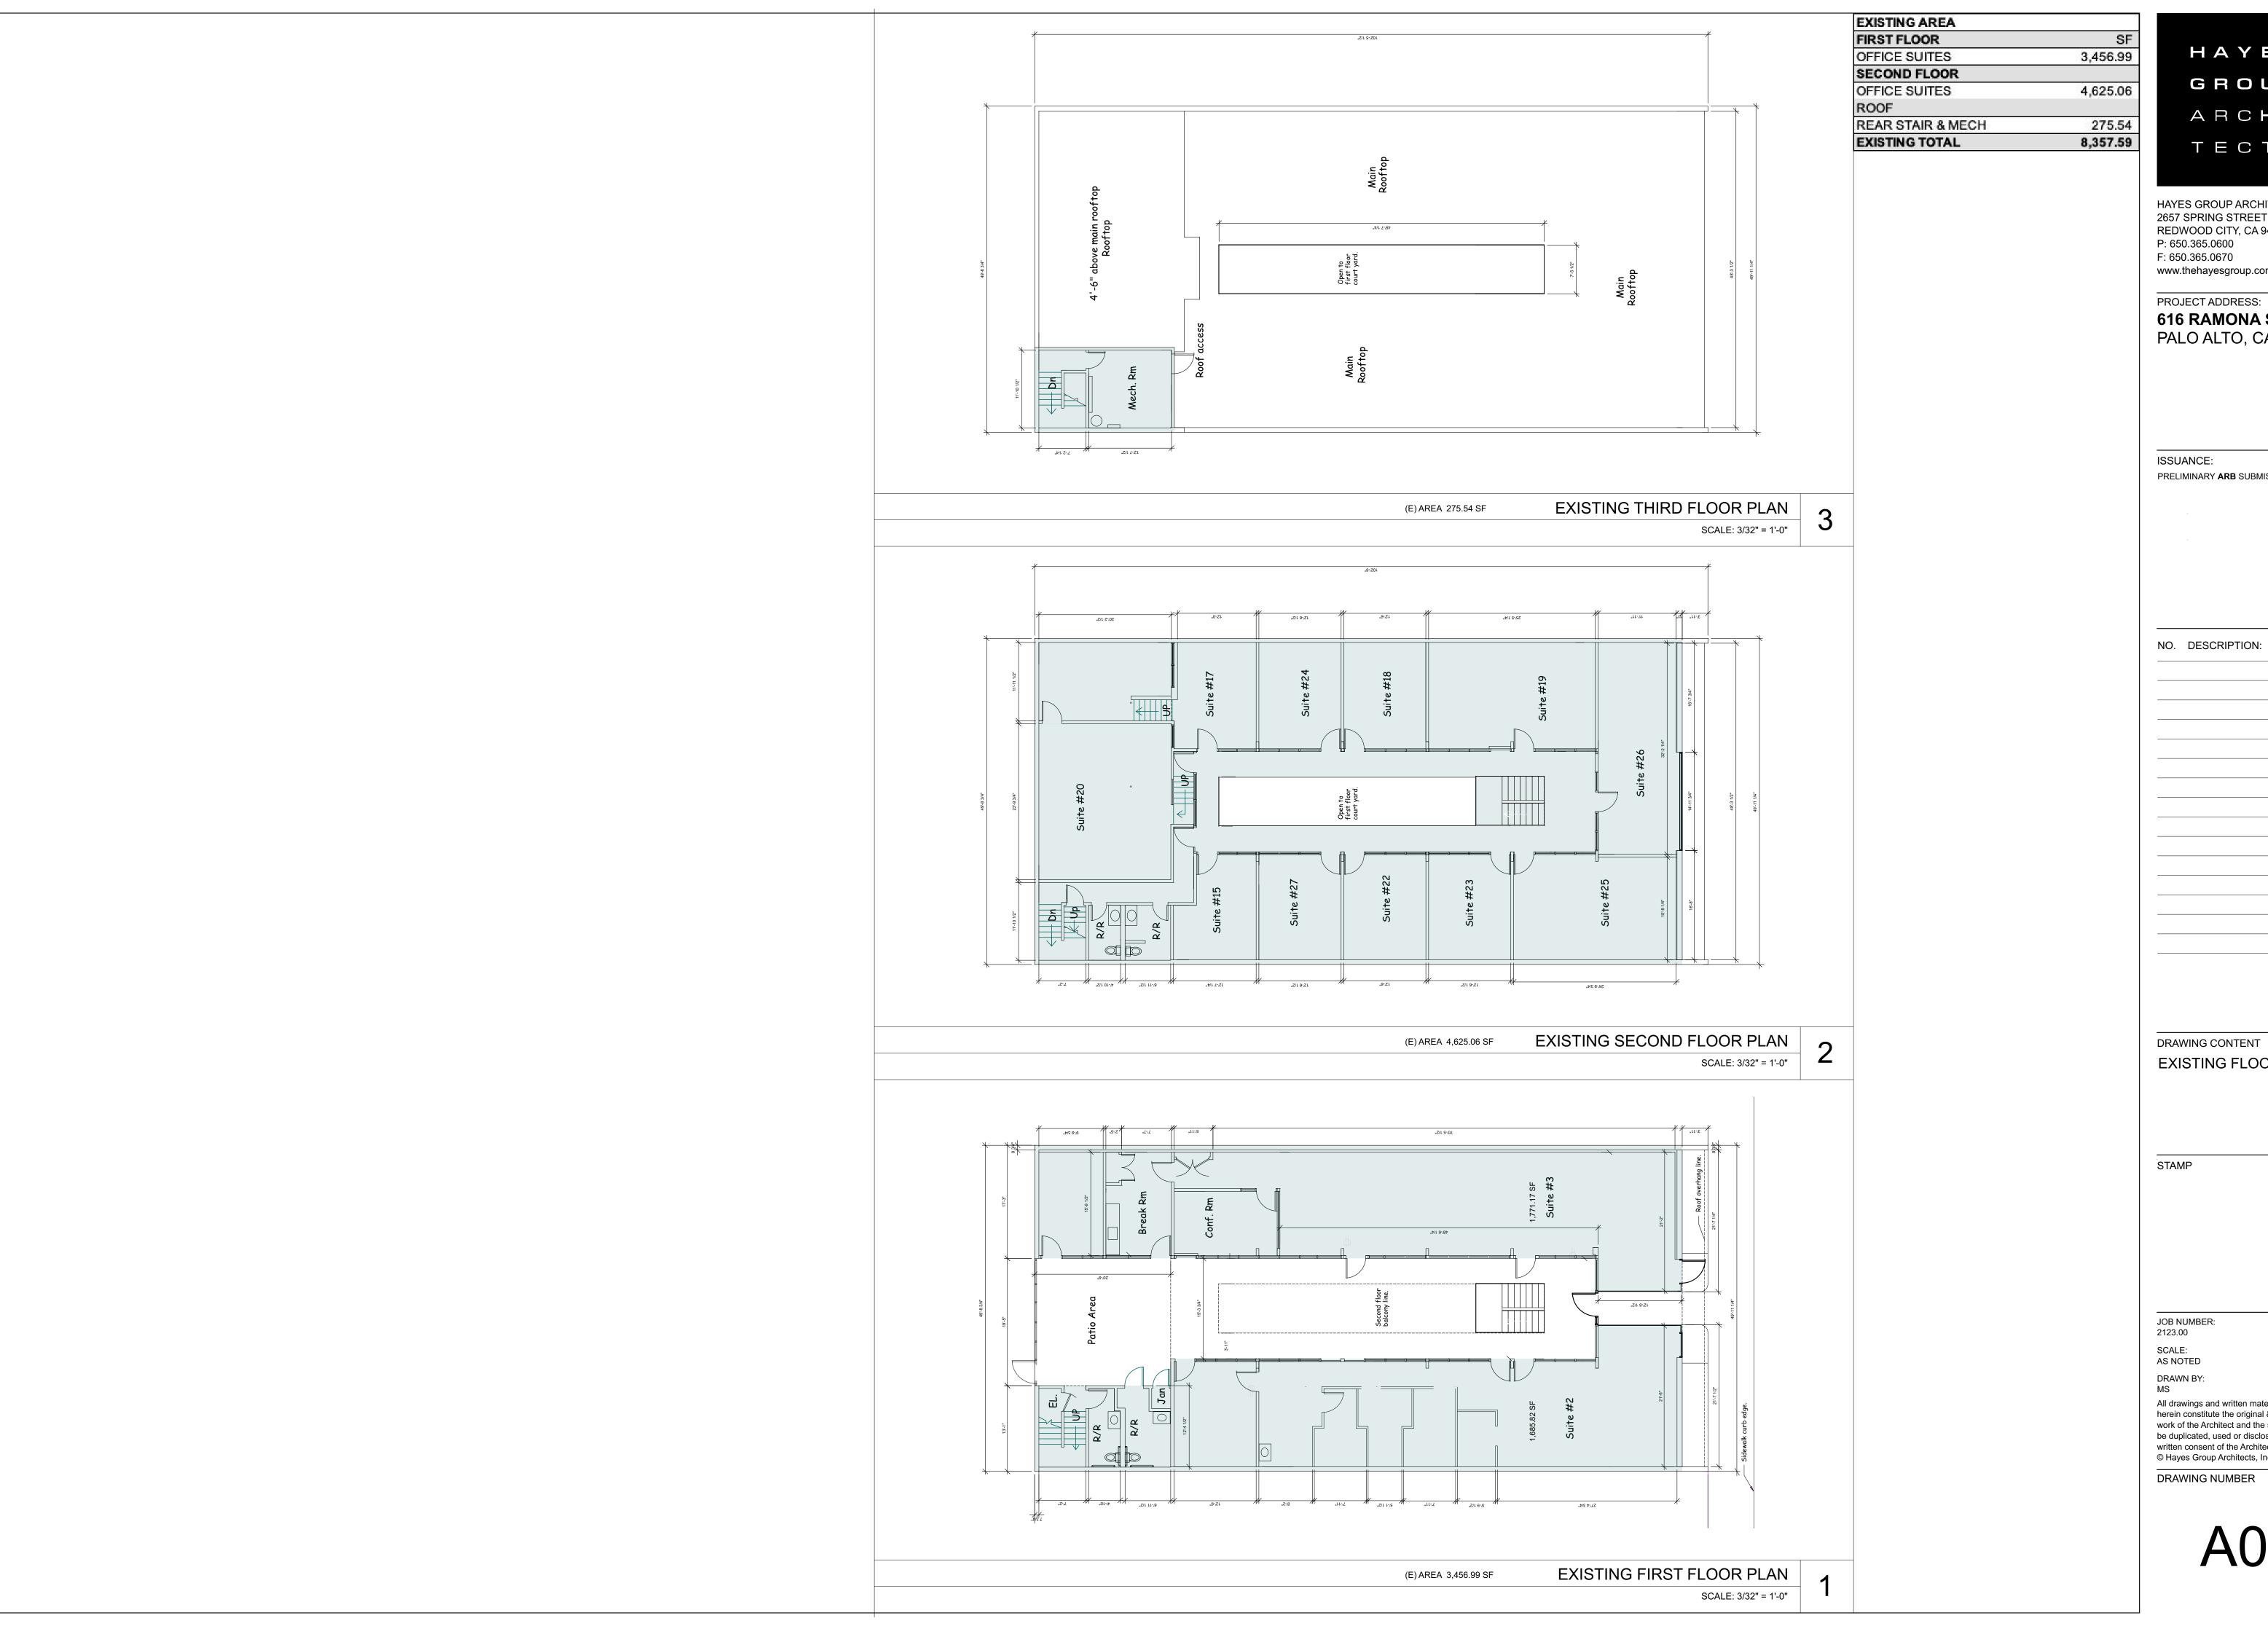

HAYES GROUP ARCHITECTS, INC. 2657 SPRING STREET REDWOOD CITY, CA 94063 P: 650.365.0600 F: 650.365.0670 www.thehayesgroup.com

PROJECT ADDRESS:

616 RAMONA STREET PALO ALTO, CA 94301

PRELIMINARY **ARB** SUBMISSION 08.16.2023


NO. DESCRIPTION:

DATE:

EXISTING FLOOR PLANS

All drawings and written materials contained herein constitute the original & unpublished work of the Architect and the same may not be duplicated, used or disclosed without the written consent of the Architect.

© Hayes Group Architects, Inc.

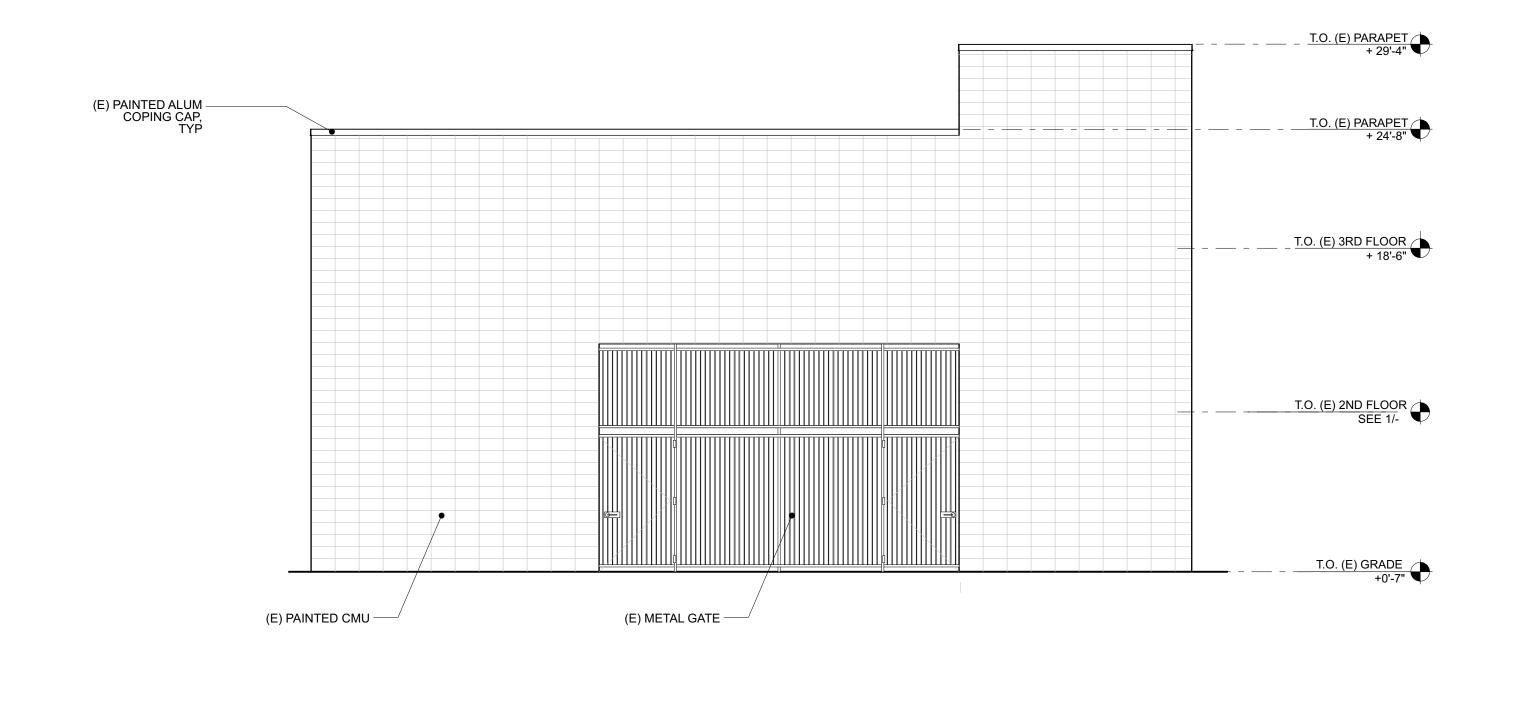

HAYES GROUP ARCHITECTS, INC. 2657 SPRING STREET REDWOOD CITY, CA 94063 P: 650.365.0600 F: 650.365.0670 www.thehayesgroup.com

PROJECT ADDRESS:

616 RAMONA STREET PALO ALTO, CA 94301

ISSUANCE:

PRELIMINARY **ARB** SUBMISSION 08.16.2023

NO. DESCRIPTION:

DATE:

DRAWING CONTENT **EXISTING ELEVATIONS**; FRONT & REAR

STAMP

JOB NUMBER: 2123.00

SCALE: AS NOTED DRAWN BY: MS

All drawings and written materials contained herein constitute the original & unpublished work of the Architect and the same may not be duplicated, used or disclosed without the written consent of the Architect.


© Hayes Group Architects, Inc.

DRAWING NUMBER



EXISTING REAR ELEVATION

SCALE: 3/16" = 1'-0"

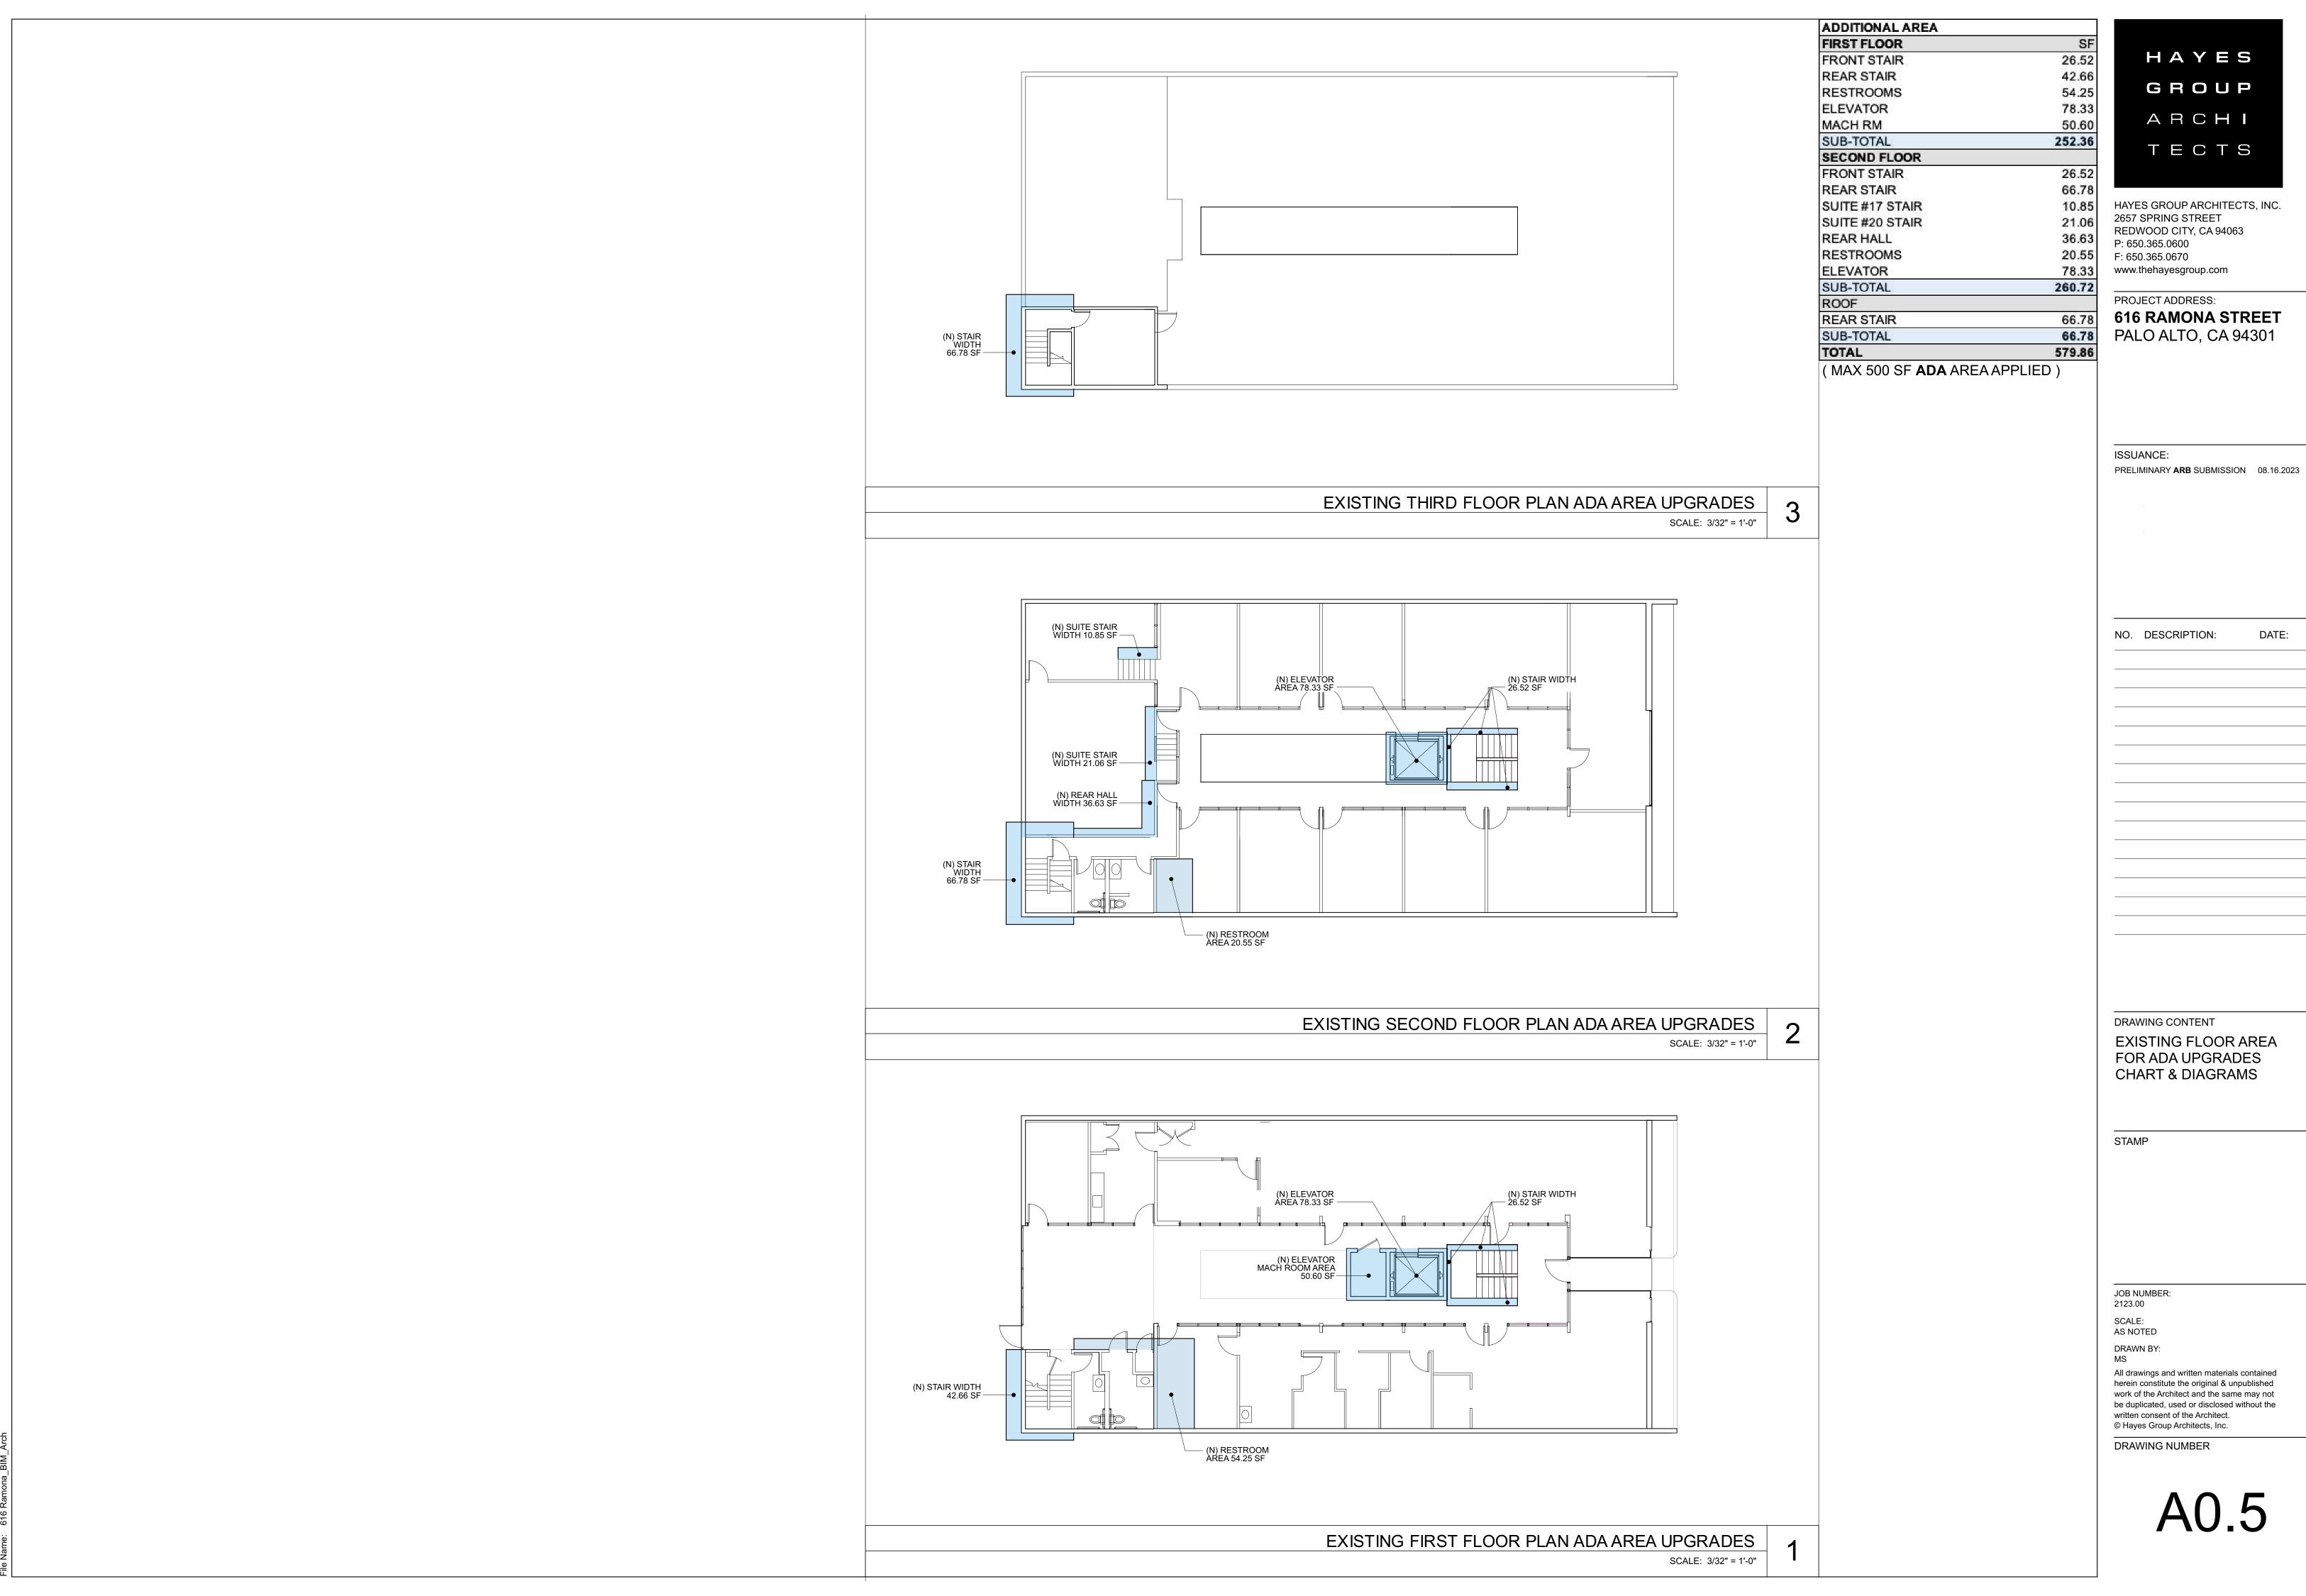


HAYES GROUP ARCHITECTS, INC. 2657 SPRING STREET REDWOOD CITY, CA 94063


PALO ALTO, CA 94301


DATE:

EXISTING FLOOR AREA FOR ADA UPGRADES

herein constitute the original & unpublished work of the Architect and the same may not be duplicated, used or disclosed without the

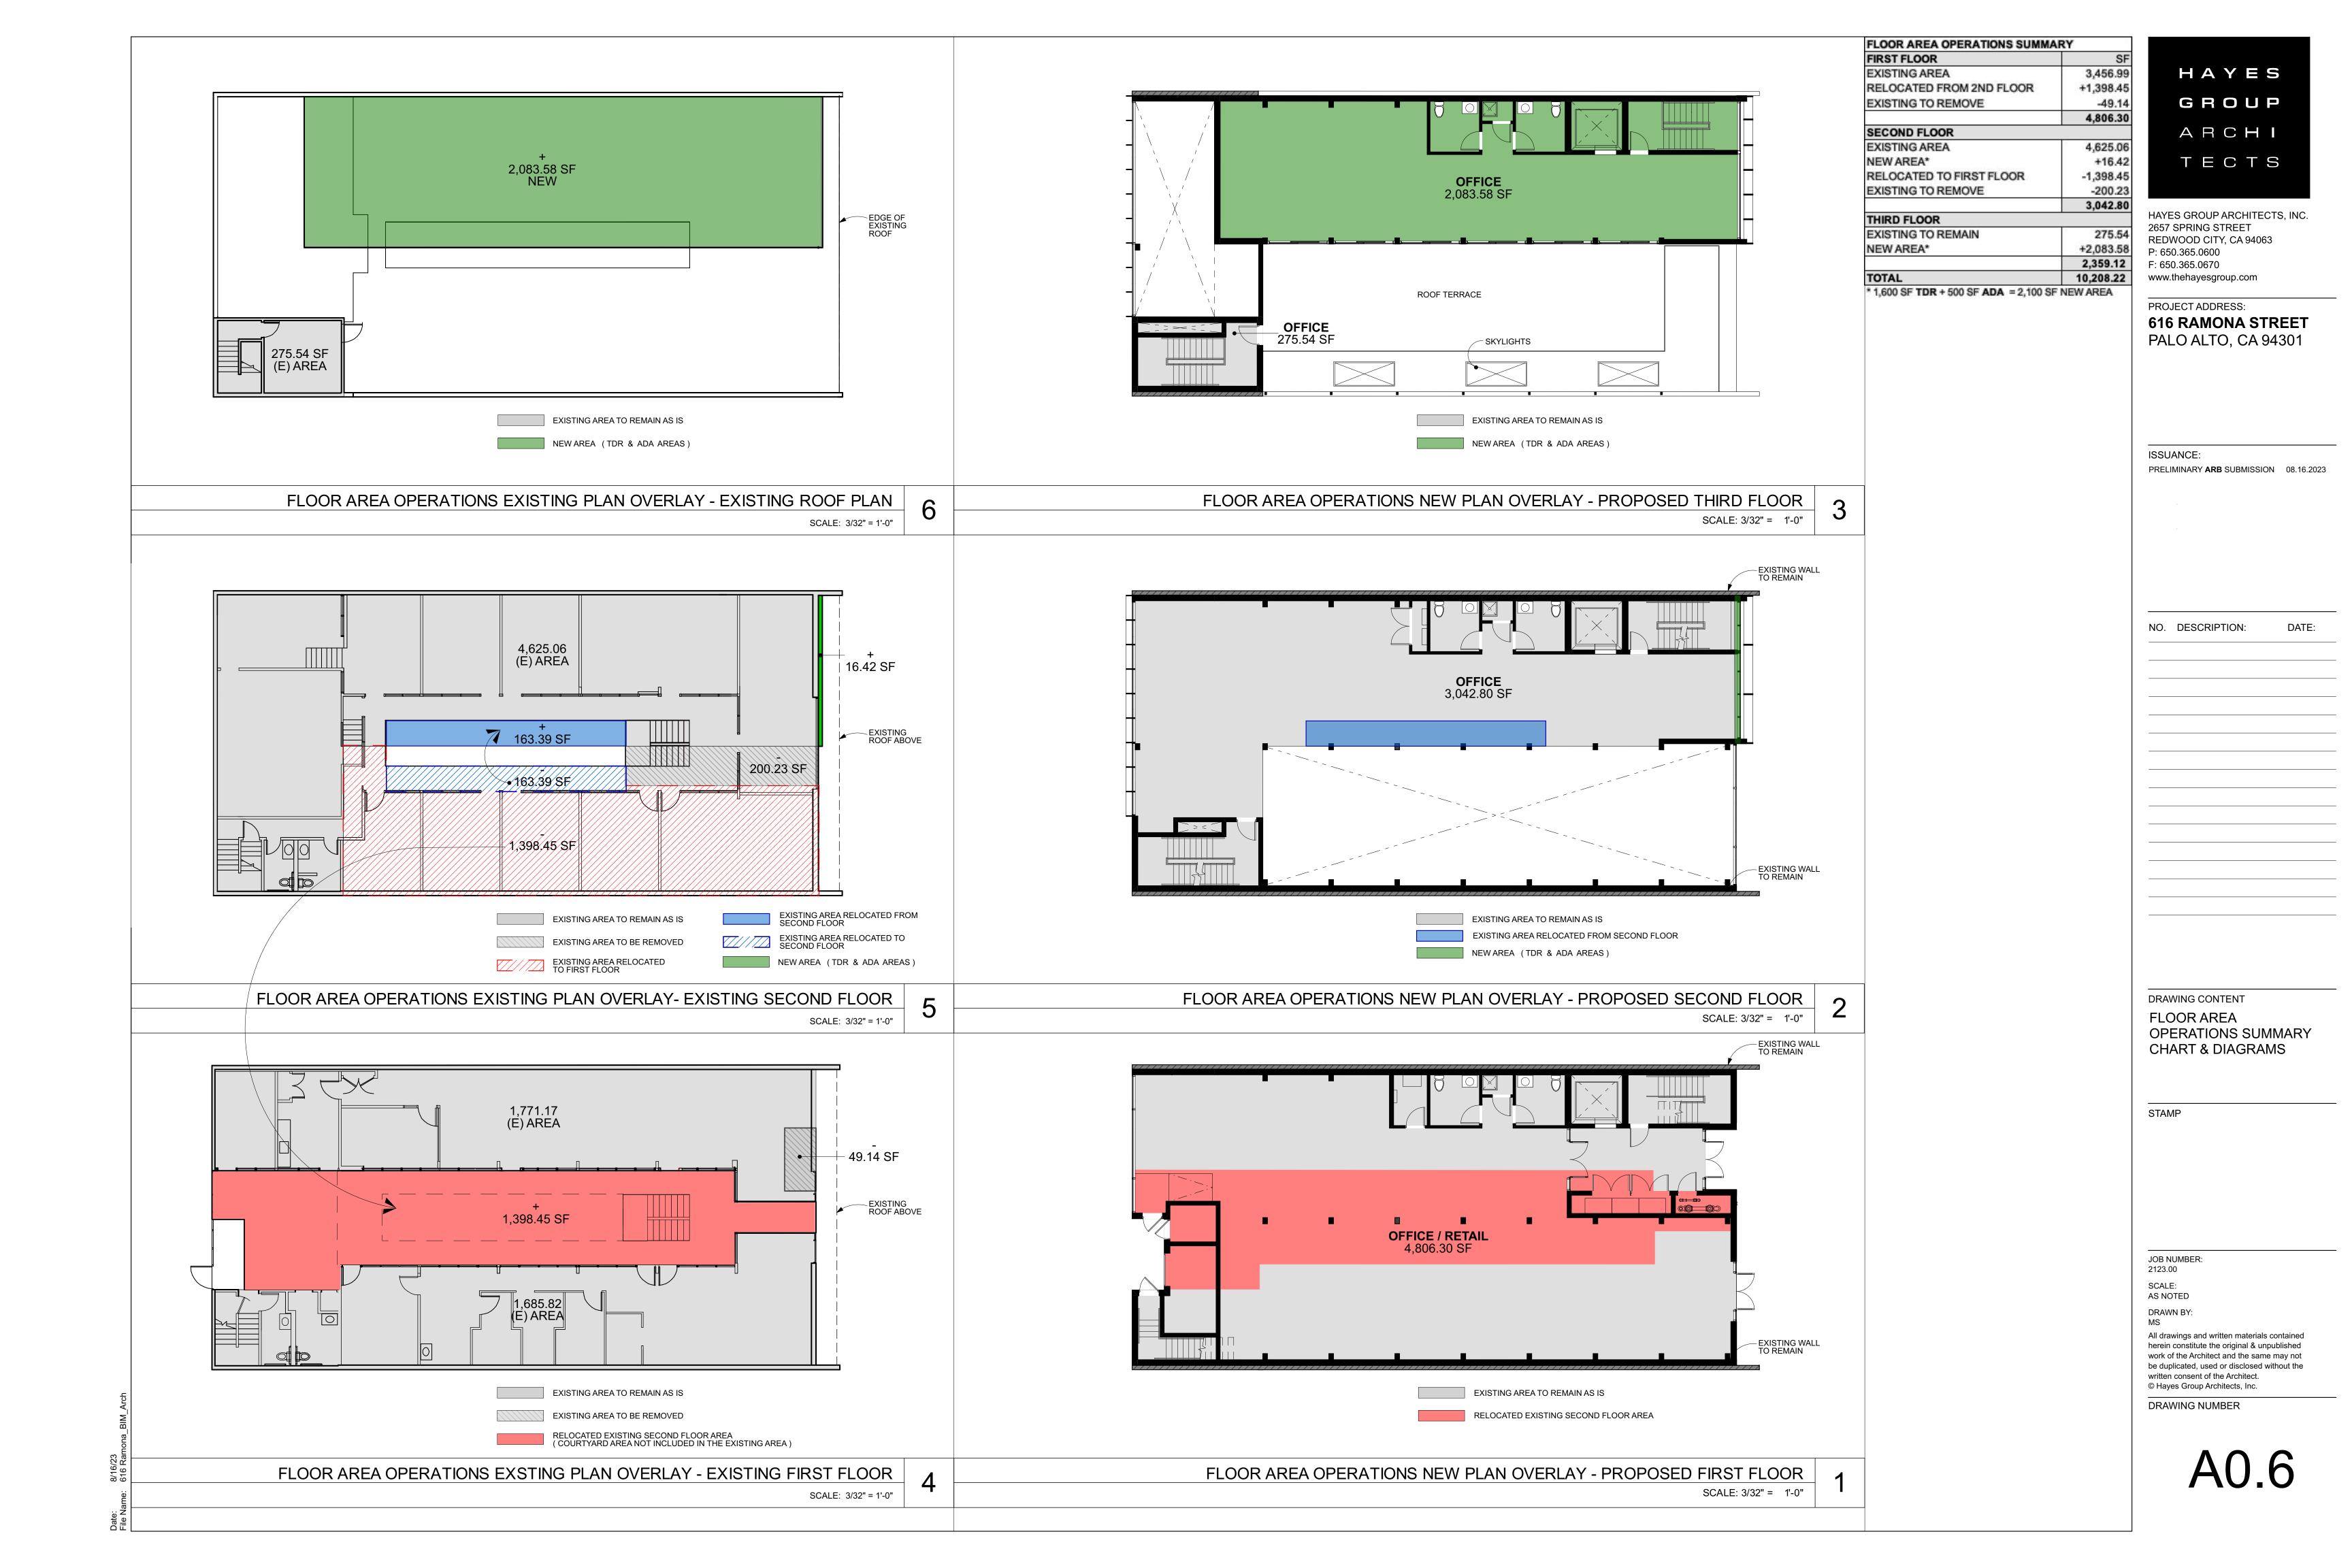


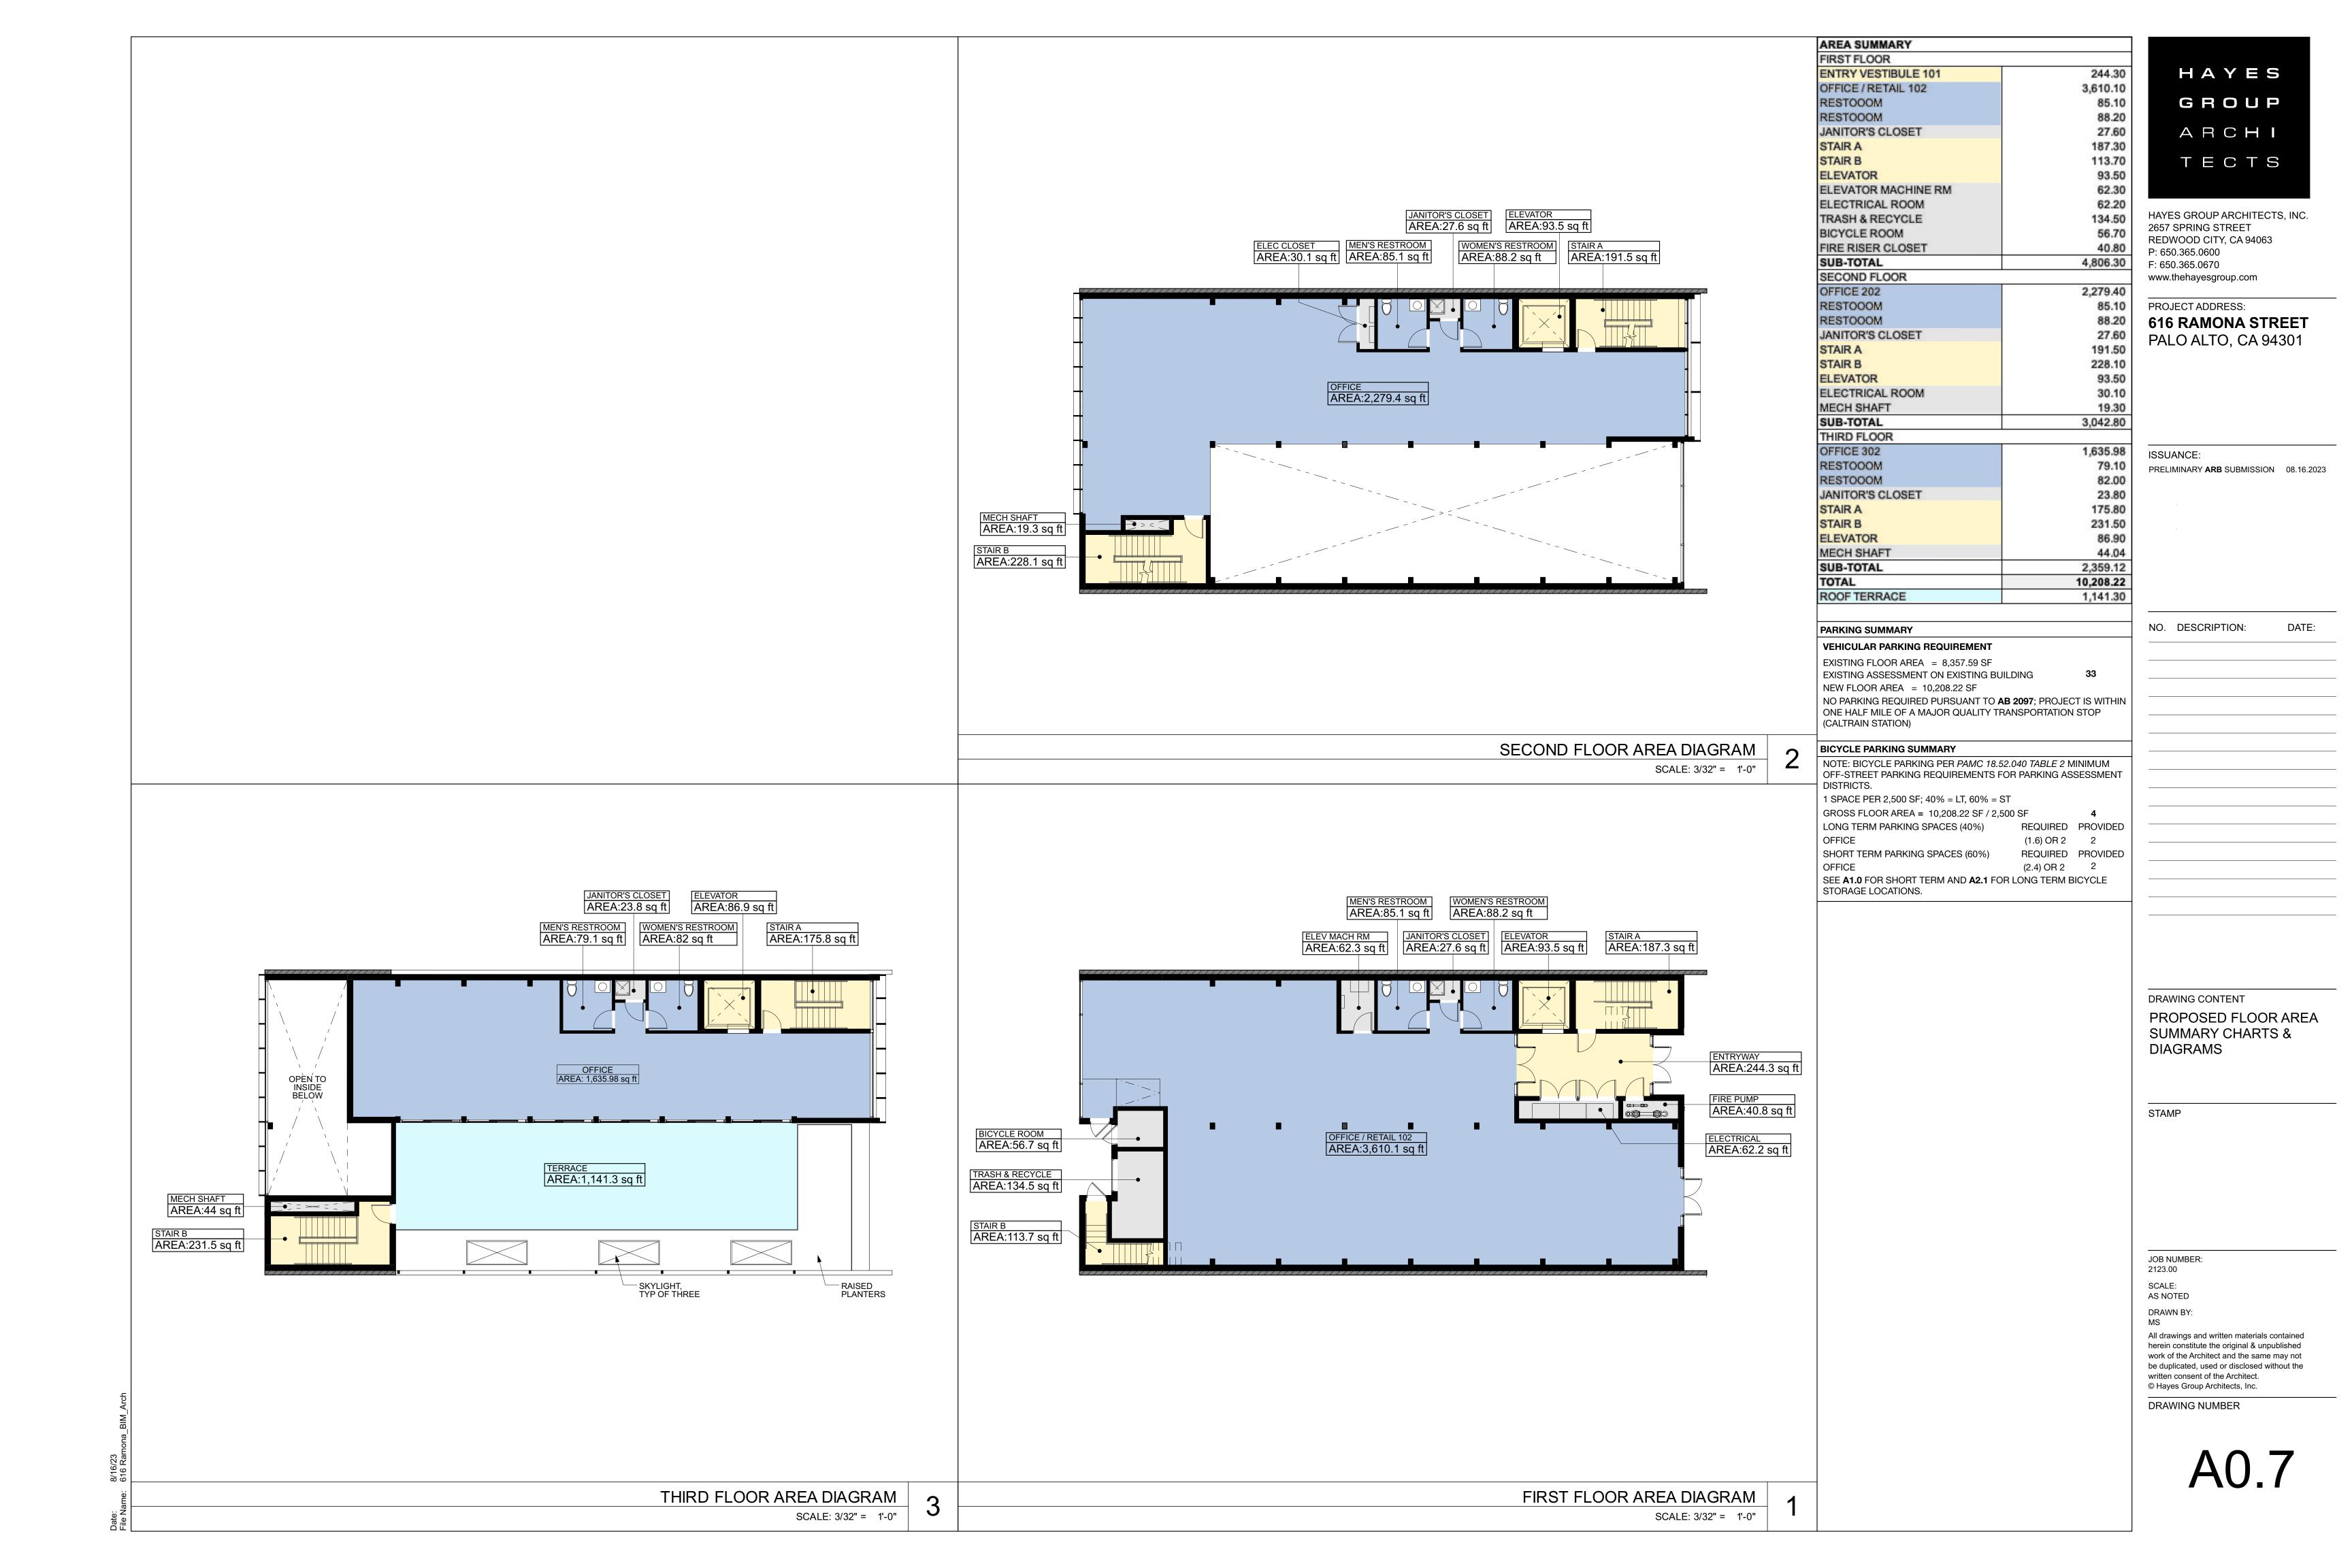

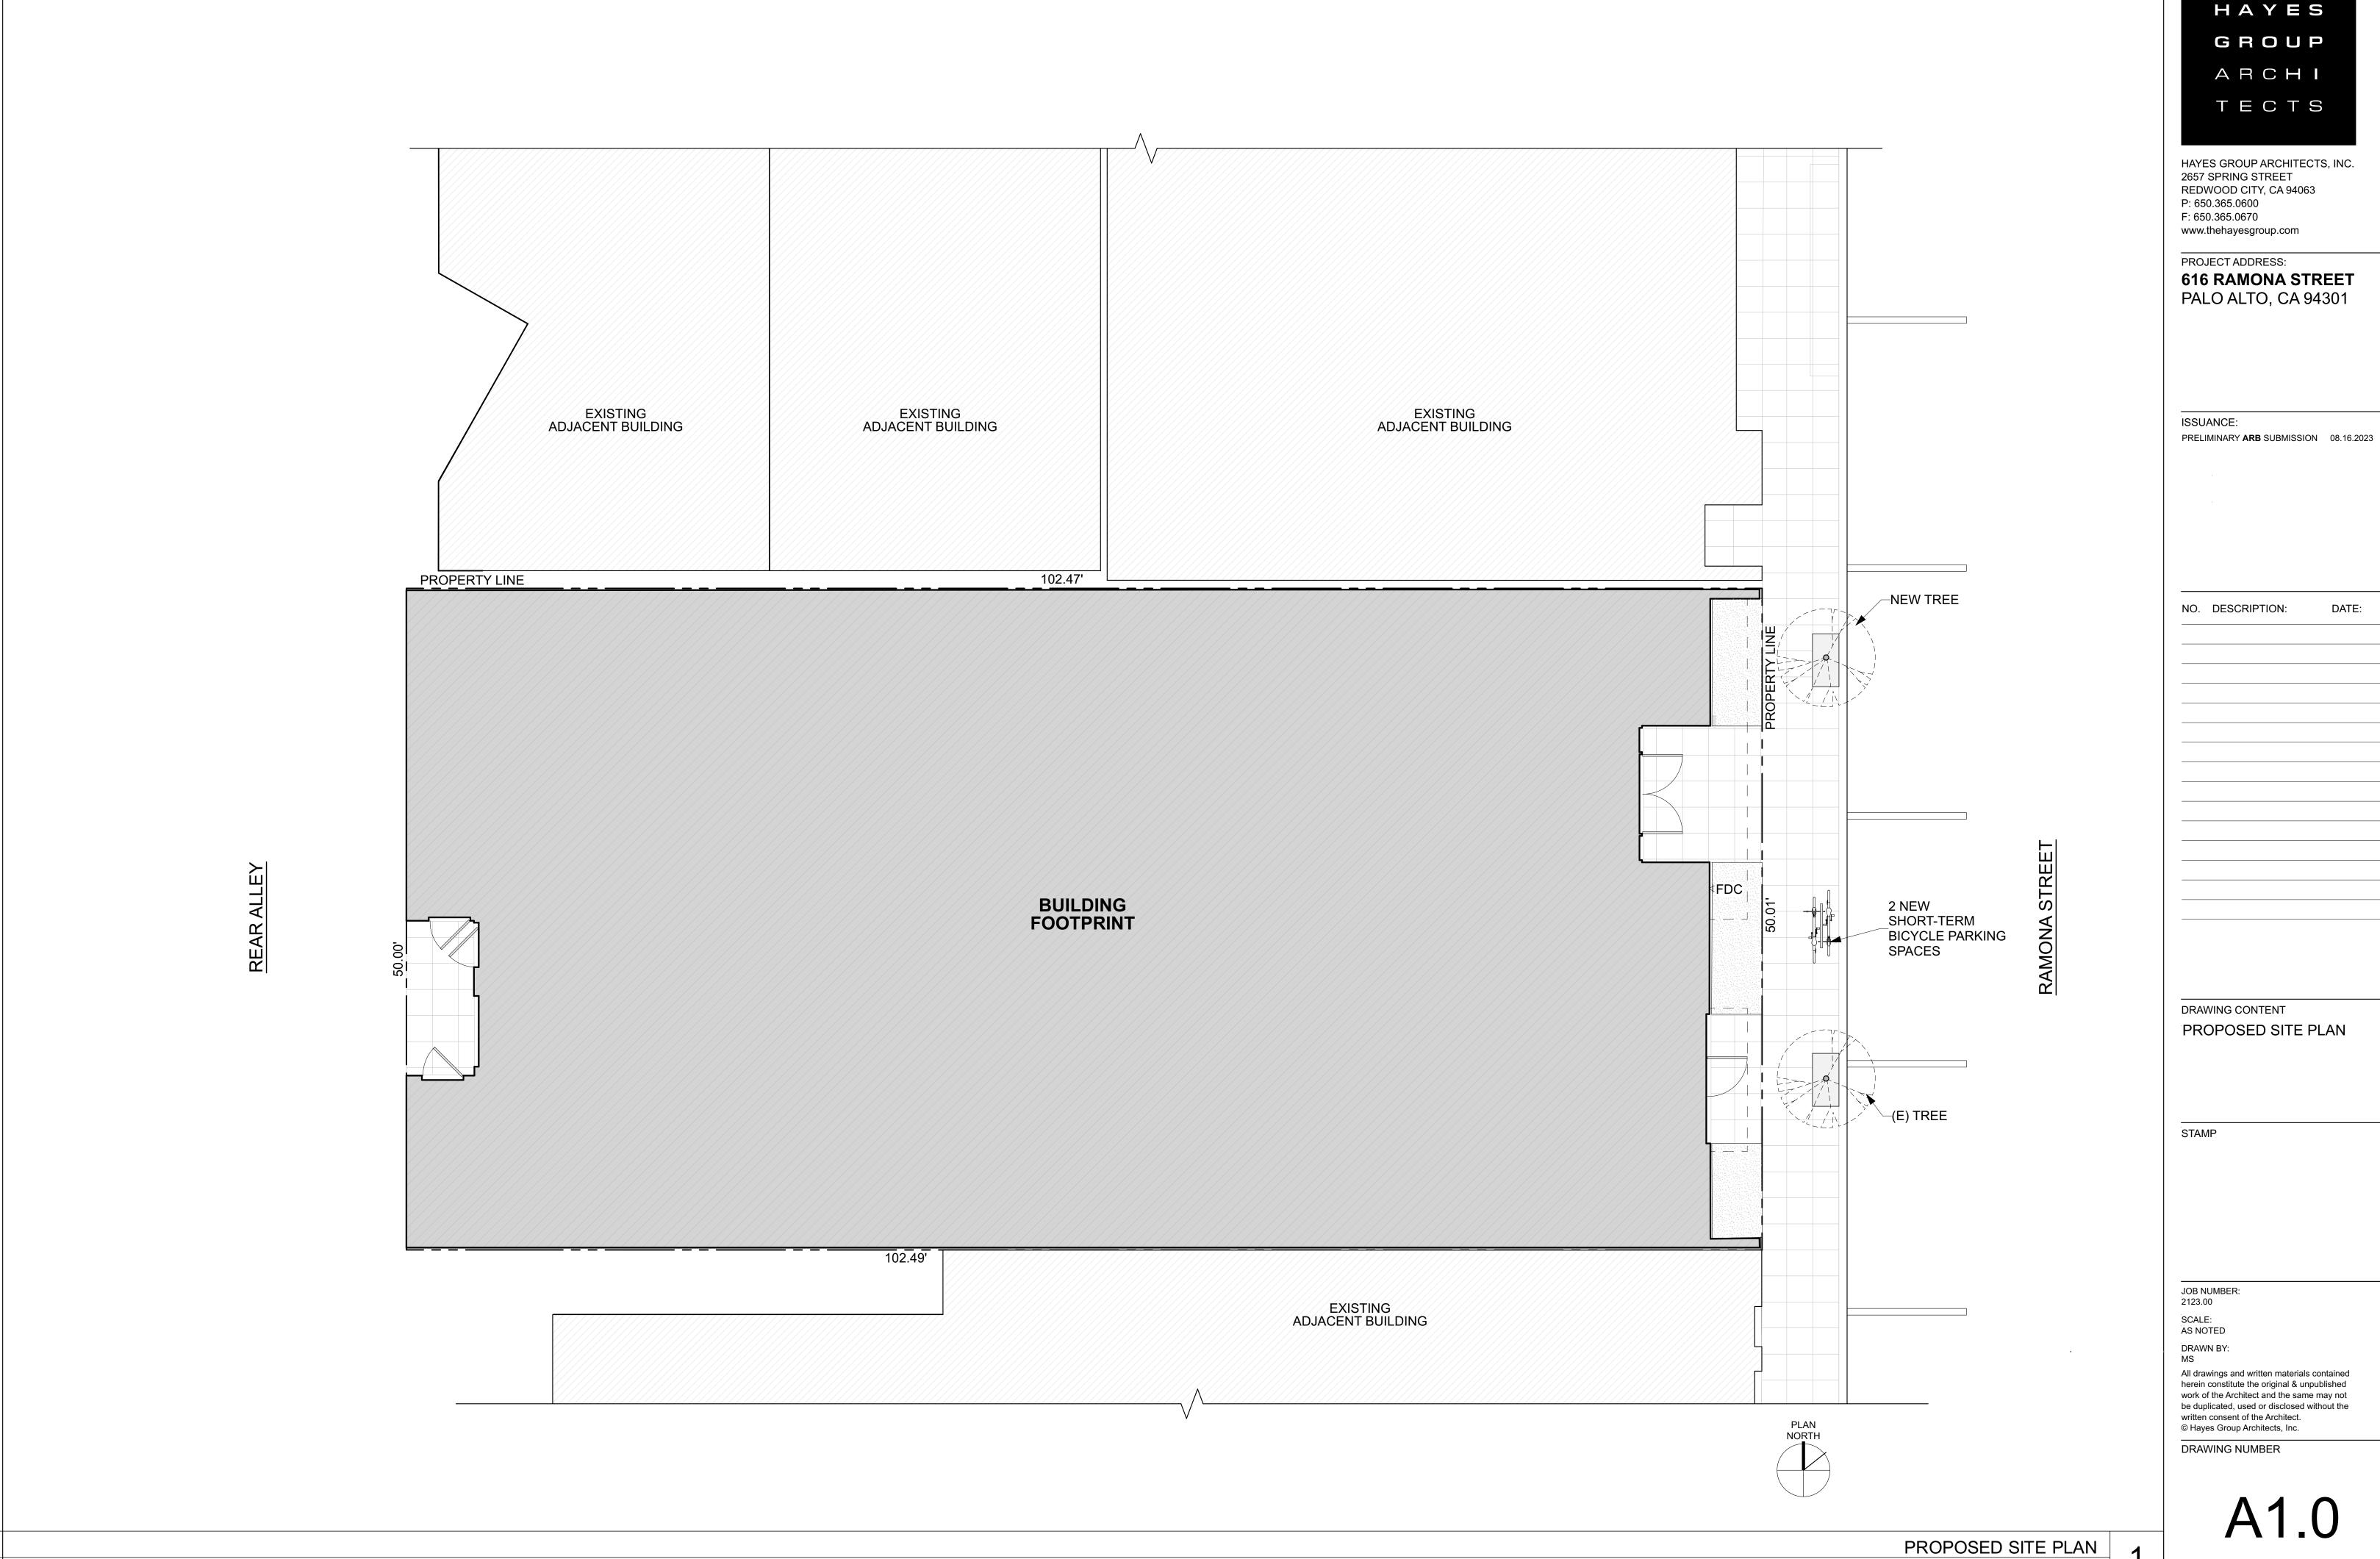

HAYES

SCALE: 3/16" = 1'-0"

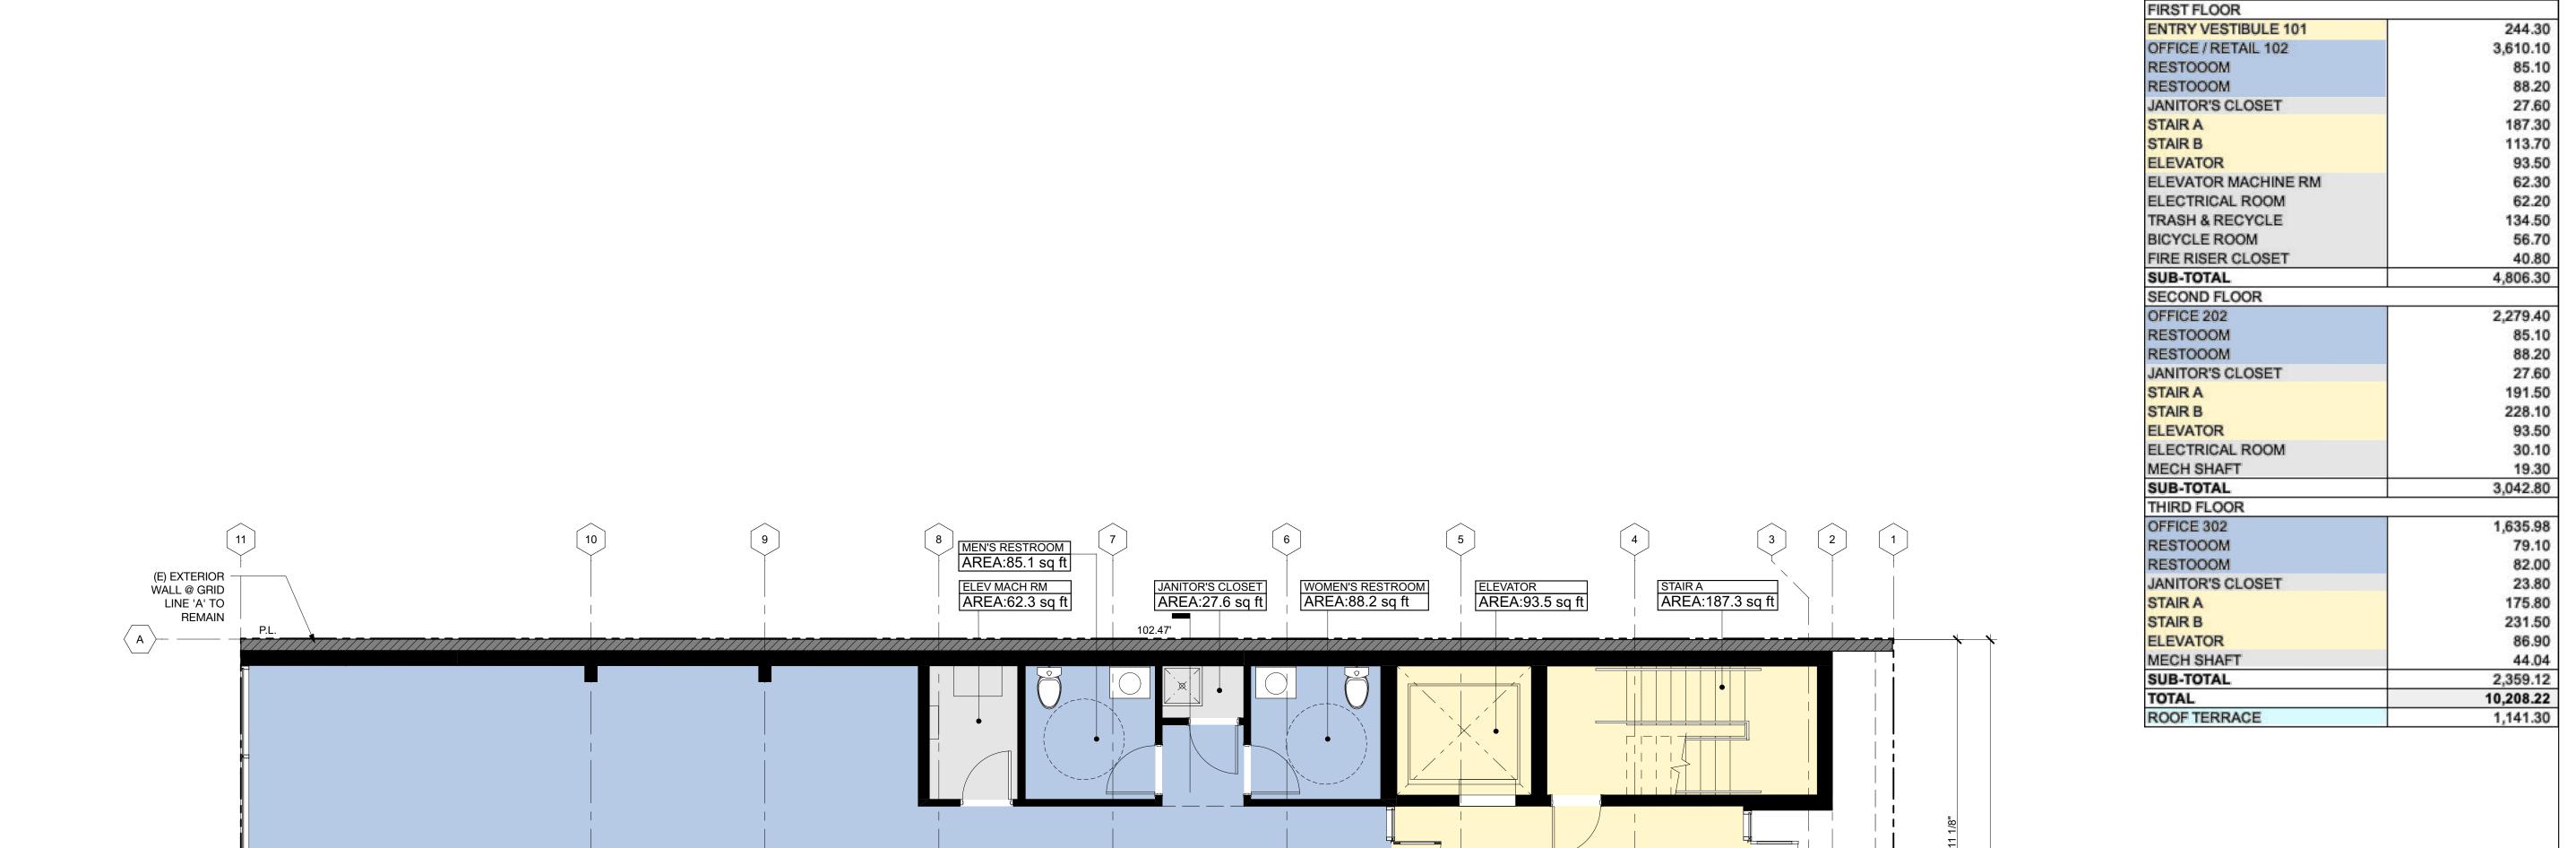

OFFICE / RETAIL 102 AREA:3,610.1 sq ft

102'-4 1/8"

 $\begin{pmatrix} 3 \\ A3.1 \end{pmatrix}$

BICYCLE ROOM
AREA:56.7 sq ft

STAIR B AREA:113.7 sq ft

(E) EXTERIOR -WALL @ GRID LINE 'C' TO

REMAIN

ACCESSIBLE H
AUTOMATIC I
DOOR

TRASH & RECYCLE AREA:134.5 sq ft

10'-9 3/8"

10'-9 3/8"

ENTRYWAY 101 AREA:244.3 sq ft

AREA:62.2 sq ft

FIRE RISER
AREA:40.8 sq ft

1'-5 5/8"

 $\begin{pmatrix} 1 \\ A3.1 \end{pmatrix}$

PLAN NORTH

HAYES GROUP ARCHI TECTS HAYES GROUP ARCHITECTS, INC.

2657 SPRING STREET REDWOOD CITY, CA 94063 P: 650.365.0600 F: 650.365.0670 www.thehayesgroup.com

PROJECT ADDRESS:

616 RAMONA STREET PALO ALTO, CA 94301

ISSUANCE:

PRELIMINARY **ARB** SUBMISSION 08.16.2023

NO. DESCRIPTION:

DATE:

DRAWING CONTENT PROPOSED FIRST

FLOOR PLAN

STAMP

JOB NUMBER: 2123.00

SCALE: AS NOTED

DRAWN BY: MS

All drawings and written materials contained herein constitute the original & unpublished work of the Architect and the same may not be duplicated, used or disclosed without the written consent of the Architect. © Hayes Group Architects, Inc.

DRAWING NUMBER

AREA SUMMARY



OFFICE 202 AREA:2,279.4 sq ft

77'-3 3/4"

102'-4 1/8"

MECH SHAFT 19.3 sq ft

(E) EXTERIOR -WALL @ GRID LINE 'C' TO REMAIN

STAIR B AREA:228.1 sq ft

HAYES GROUP ARCHI TECTS

HAYES GROUP ARCHITECTS, INC. 2657 SPRING STREET REDWOOD CITY, CA 94063 P: 650.365.0600 F: 650.365.0670 www.thehayesgroup.com

PROJECT ADDRESS:

616 RAMONA STREET PALO ALTO, CA 94301

ISSUANCE:

PRELIMINARY **ARB** SUBMISSION 08.16.2023

NO. DESCRIPTION:

DATE:

DRAWING CONTENT

PROPOSED SECOND

FLOOR PLAN

STAMP

JOB NUMBER: 2123.00

SCALE: AS NOTED


DRAWN BY: MS

All drawings and written materials contained herein constitute the original & unpublished work of the Architect and the same may not be duplicated, used or disclosed without the written consent of the Architect. © Hayes Group Architects, Inc.

DRAWING NUMBER

3'-8 3/8"

AREA SUMMARY

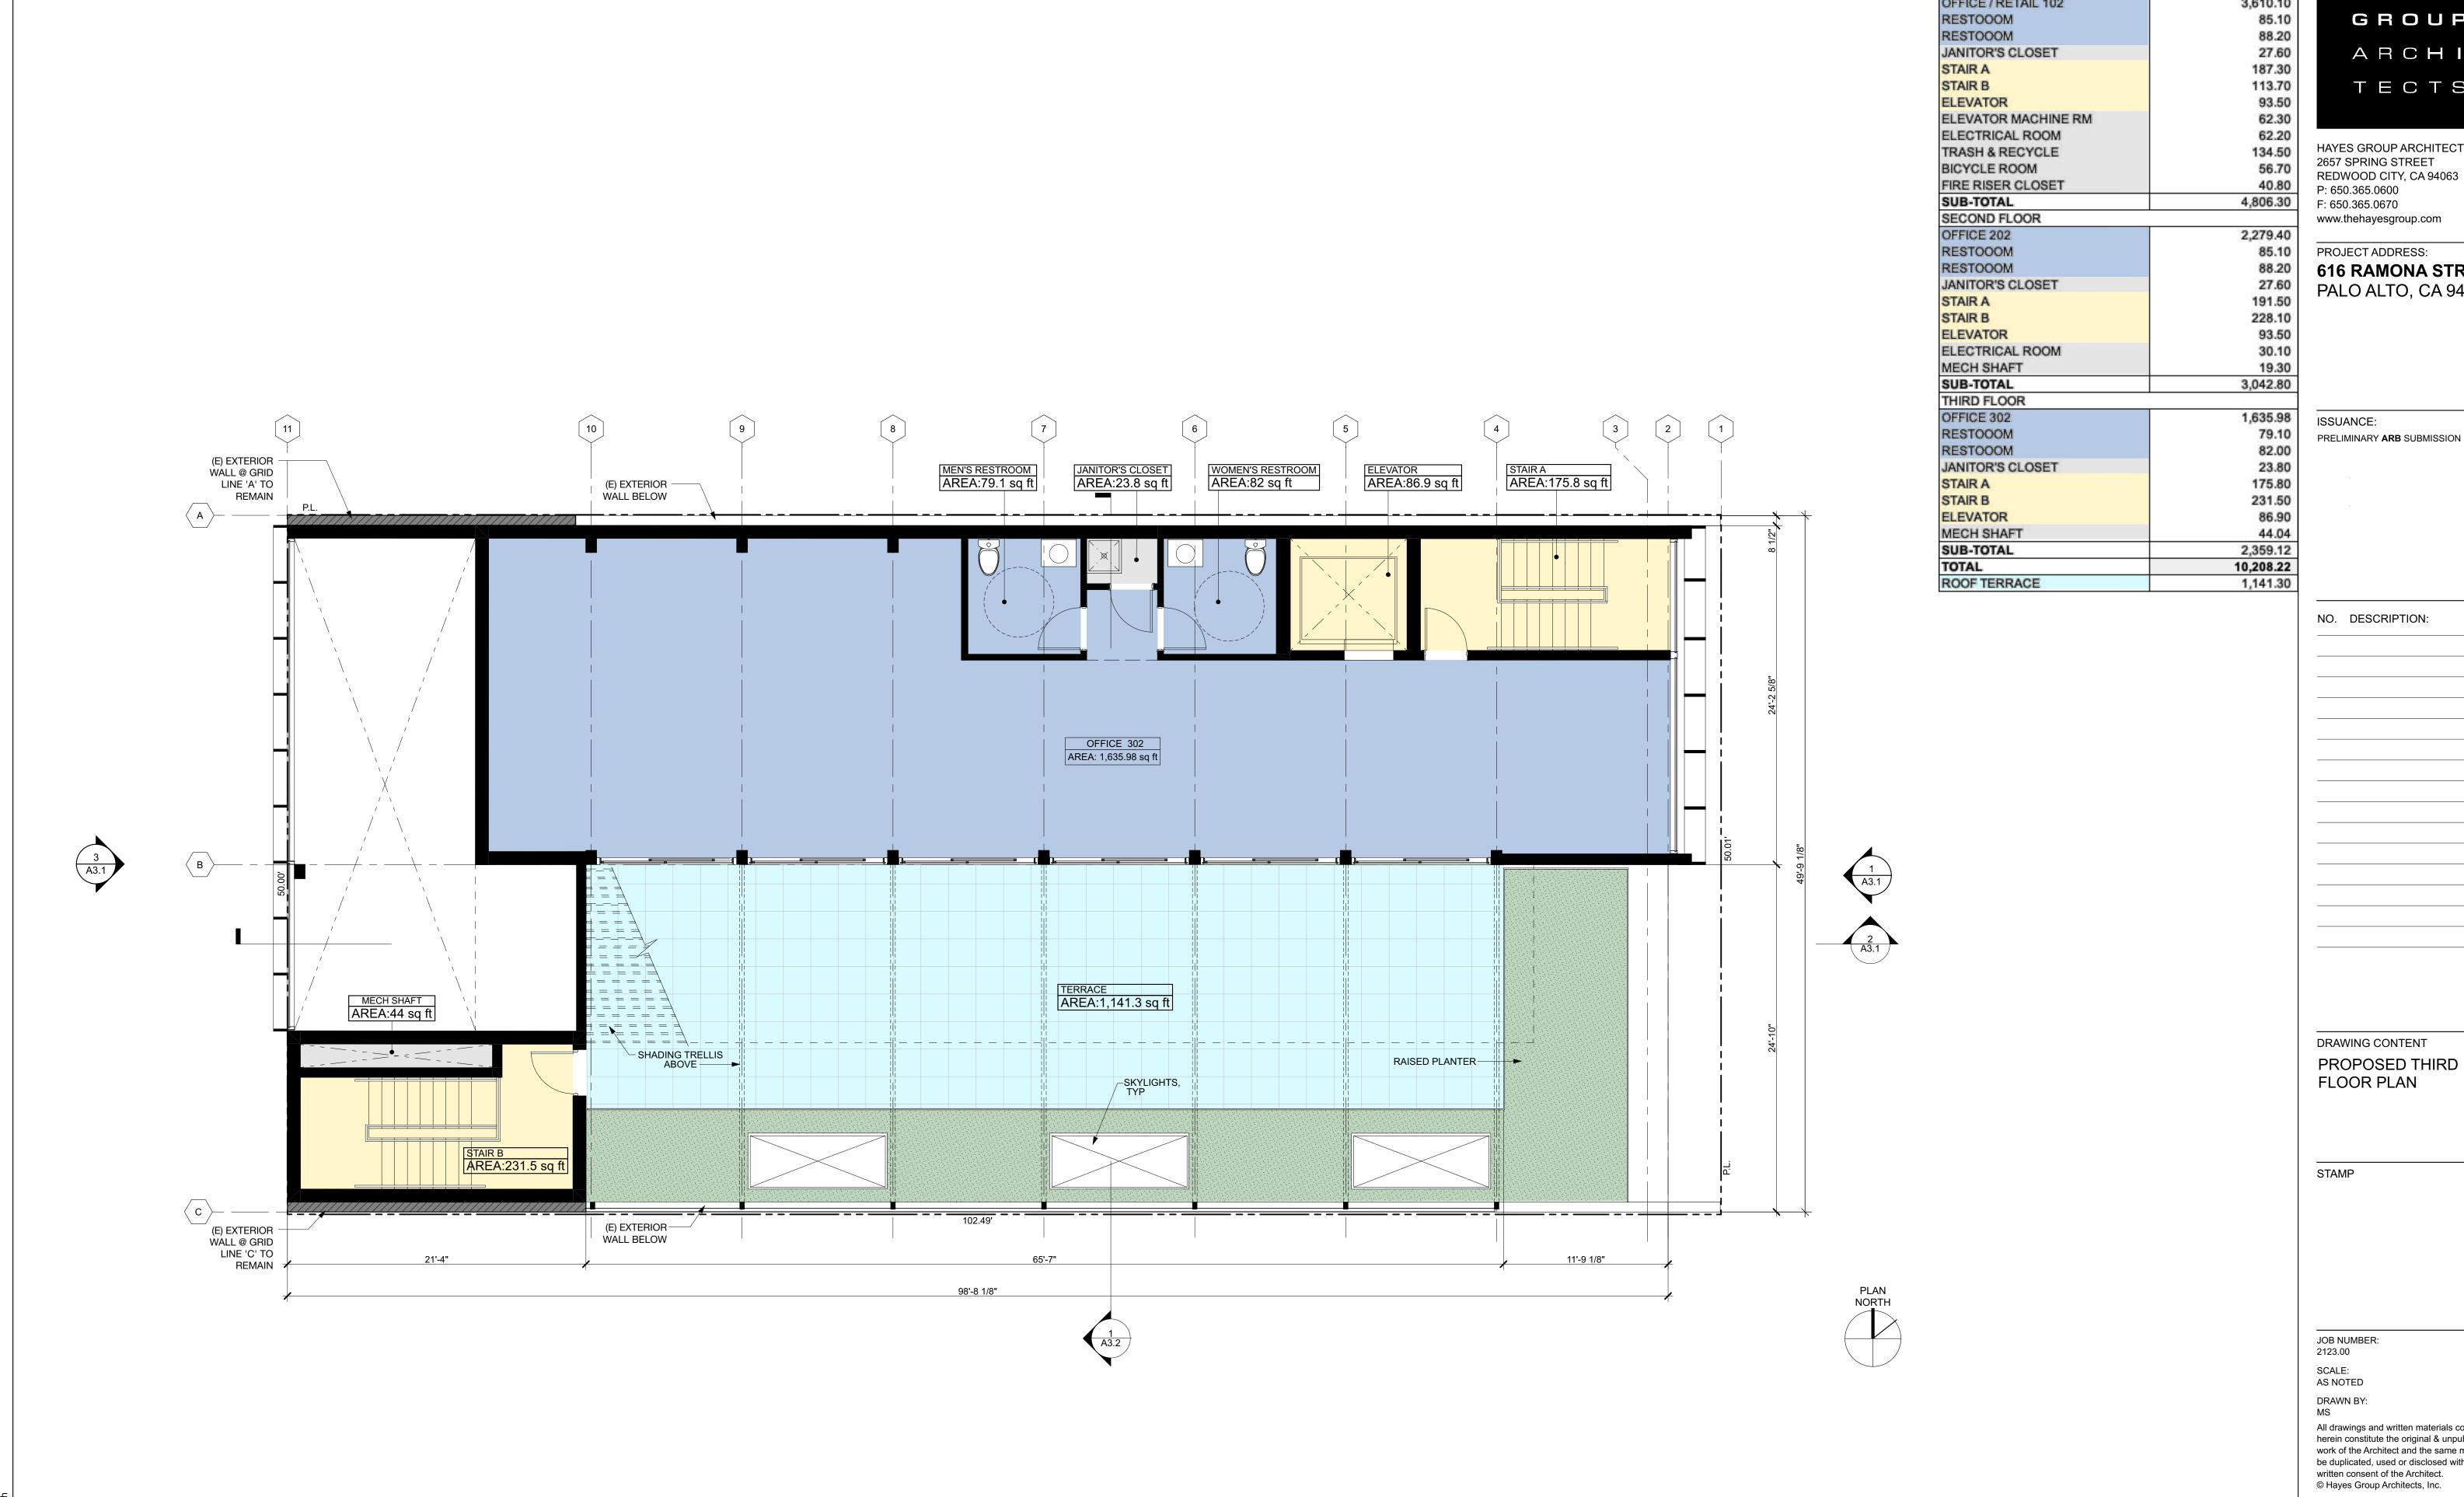

AREA SUMMARY FIRST FLOOR 244.30 **ENTRY VESTIBULE 101** OFFICE / RETAIL 102 3,610.10

HAYES GROUP ARCHI TECTS


HAYES GROUP ARCHITECTS, INC. 2657 SPRING STREET REDWOOD CITY, CA 94063

616 RAMONA STREET PALO ALTO, CA 94301

PRELIMINARY **ARB** SUBMISSION 08.16.2023

DATE:

All drawings and written materials contained herein constitute the original & unpublished work of the Architect and the same may not be duplicated, used or disclosed without the written consent of the Architect.

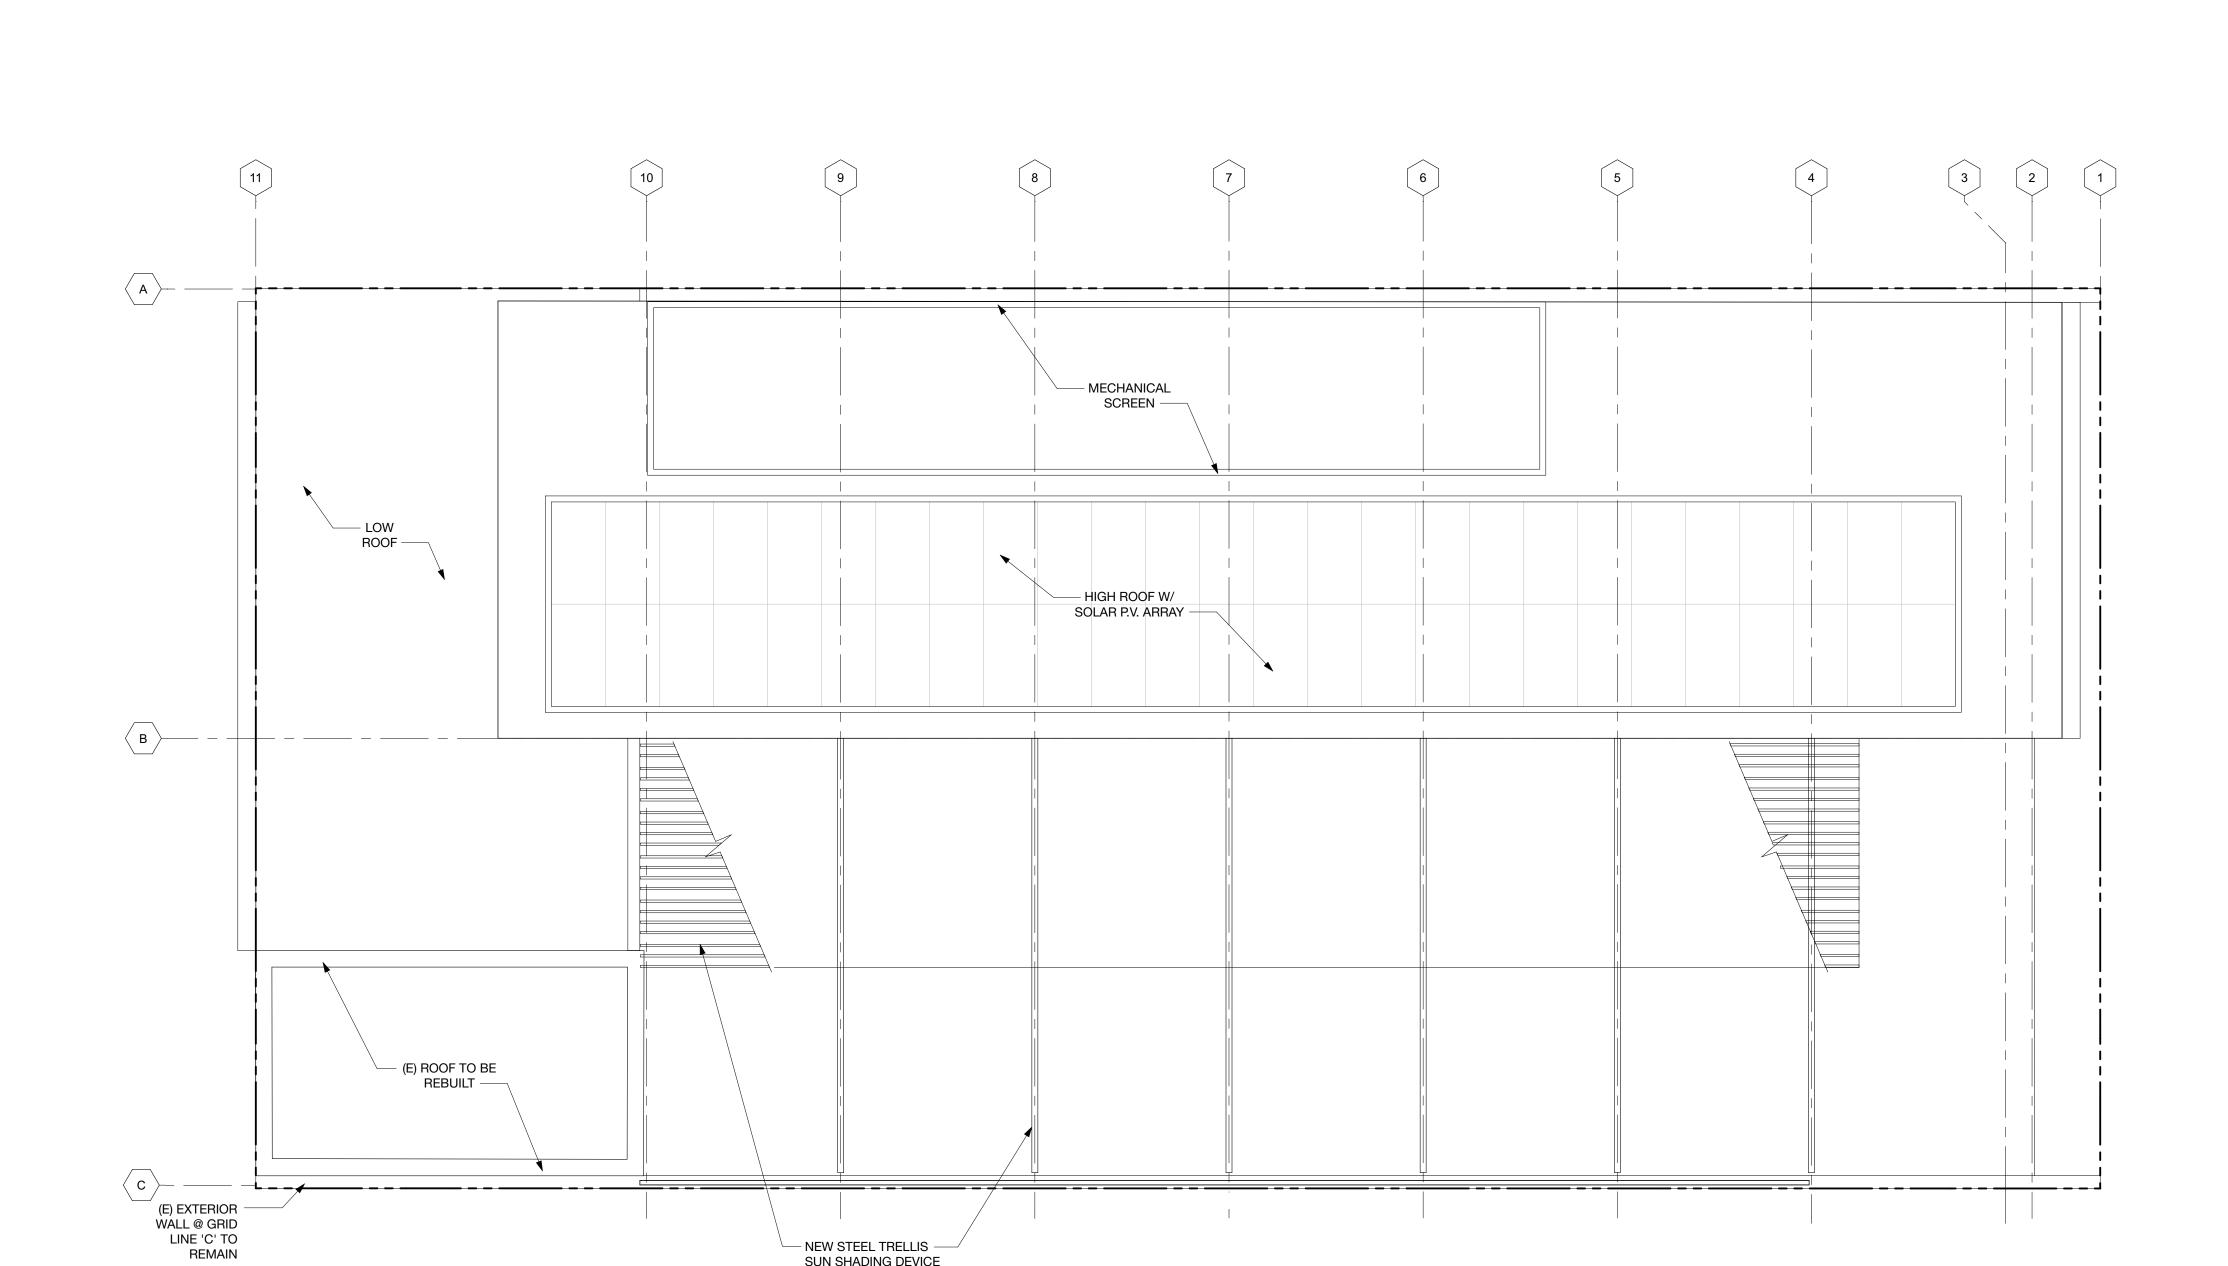

— NEW STEEL TRELLIS — SUN SHADING DEVICE



HAYES GROUP ARCHITECTS, INC. 2657 SPRING STREET REDWOOD CITY, CA 94063 P: 650.365.0600 F: 650.365.0670 www.thehayesgroup.com

PROJECT ADDRESS:

616 RAMONA STREET PALO ALTO, CA 94301

ISSUANCE:

PRELIMINARY **ARB** SUBMISSION 08.16.2023

NO. DESCRIPTION:

DATE:

DRAWING CONTENT PROPOSED ROOF PLAN

STAMP

JOB NUMBER: 2123.00

SCALE: AS NOTED


DRAWN BY: MS


All drawings and written materials contained herein constitute the original & unpublished work of the Architect and the same may not be duplicated, used or disclosed without the written consent of the Architect.


© Hayes Group Architects, Inc.






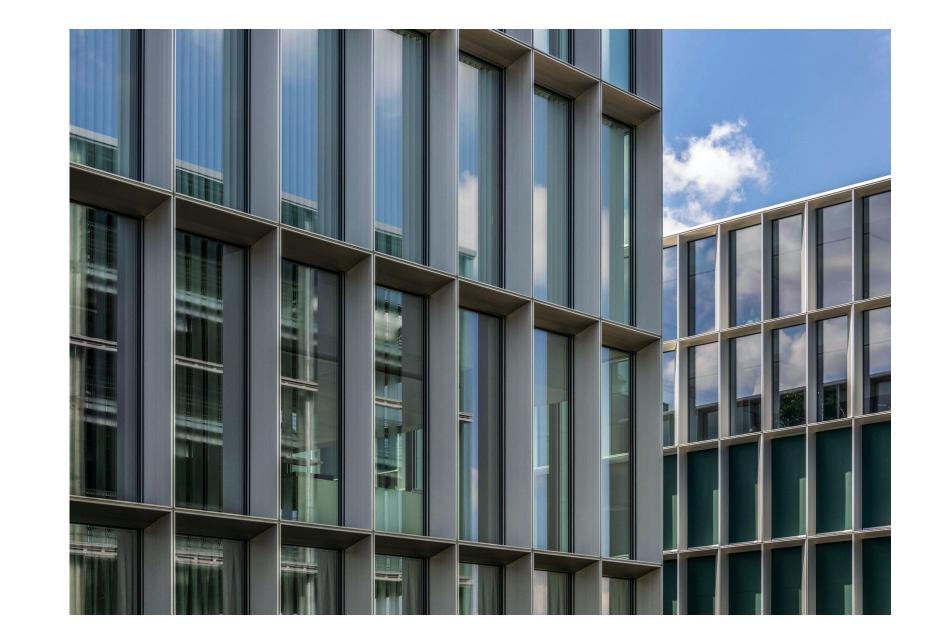

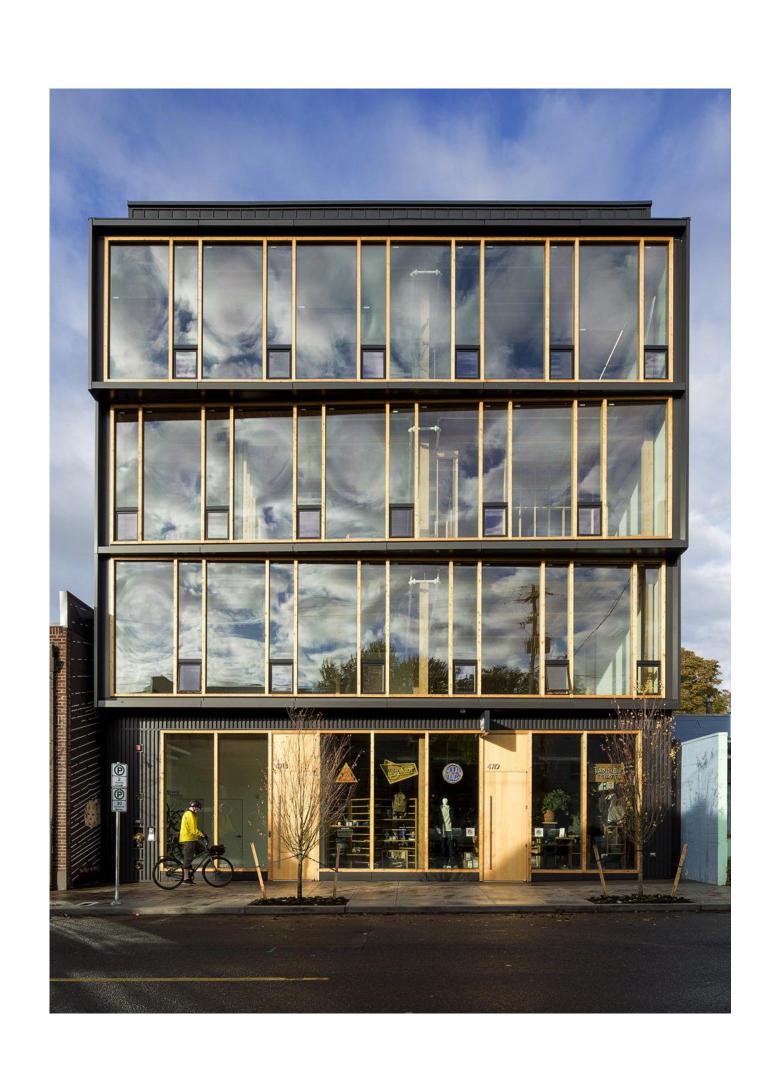

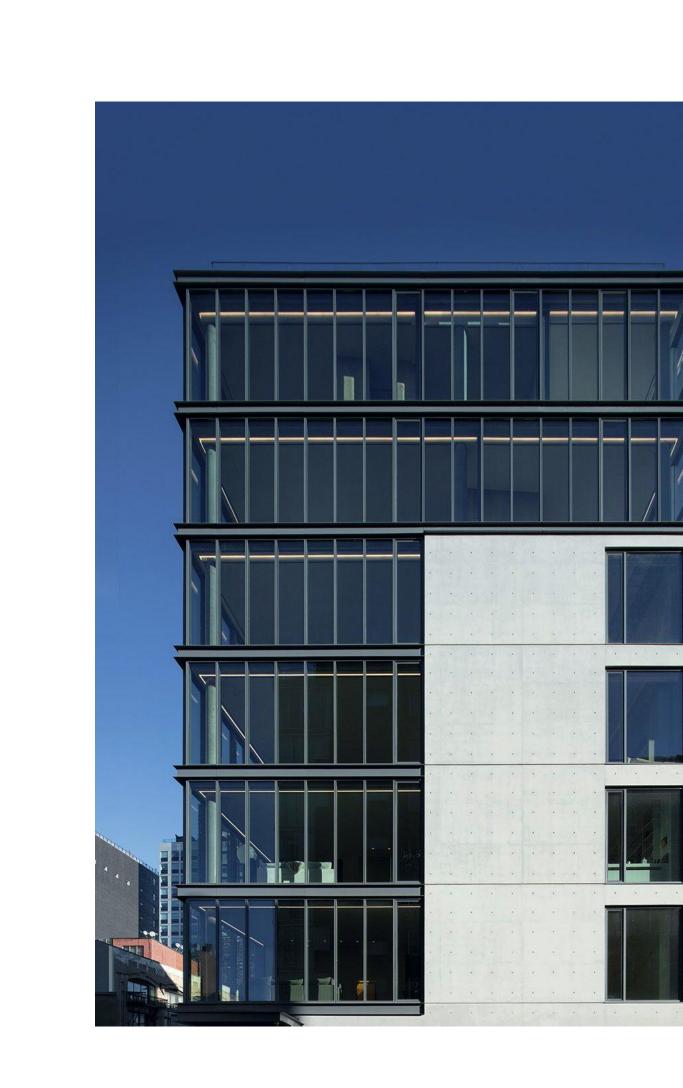

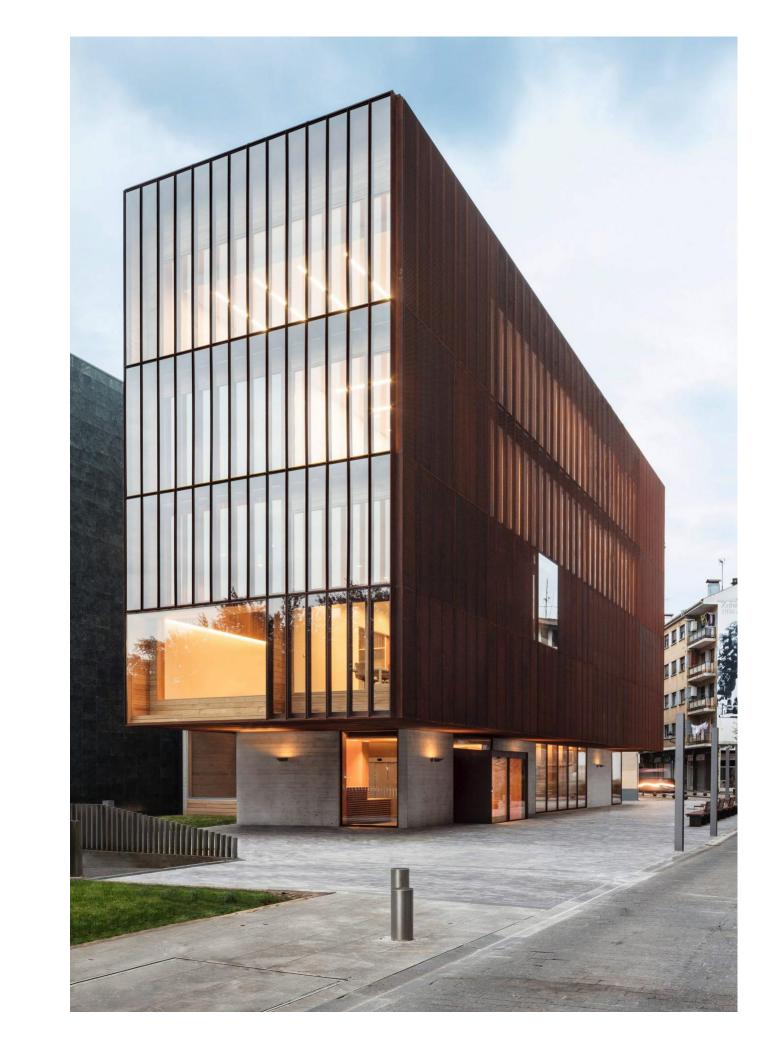



HAYES GROUP ARCHITECTS, INC. 2657 SPRING STREET REDWOOD CITY, CA 94063 P: 650.365.0600 F: 650.365.0670 www.thehayesgroup.com

PROJECT ADDRESS:

616 RAMONA STREET PALO ALTO, CA 94301

ISSUANCE:

PRELIMINARY **ARB** SUBMISSION 08.16.2023

NO. DESCRIPTION: DATE:

DRAWING CONTENT

DESIGN PRECEDENT

STAMP

IMAGERY

JOB NUMBER: 2123.00

SCALE: AS NOTED


DRAWN BY:
MS


All drawings and written materials contained herein constitute the original & unpublished work of the Architect and the same may not be duplicated, used or disclosed without the written consent of the Architect.


© Hayes Group Architects, Inc.

DRAWING NUMBER

A3.0

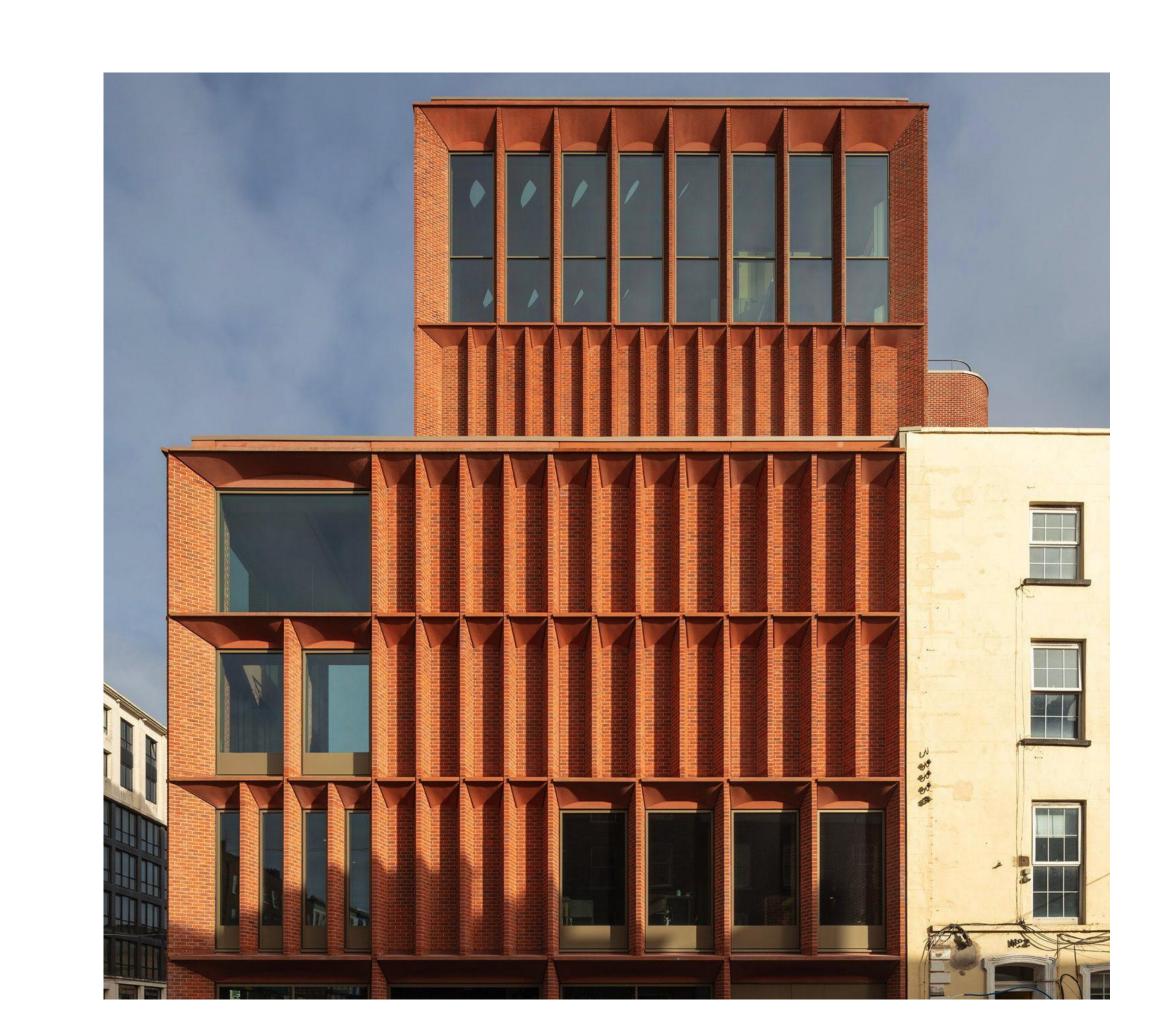

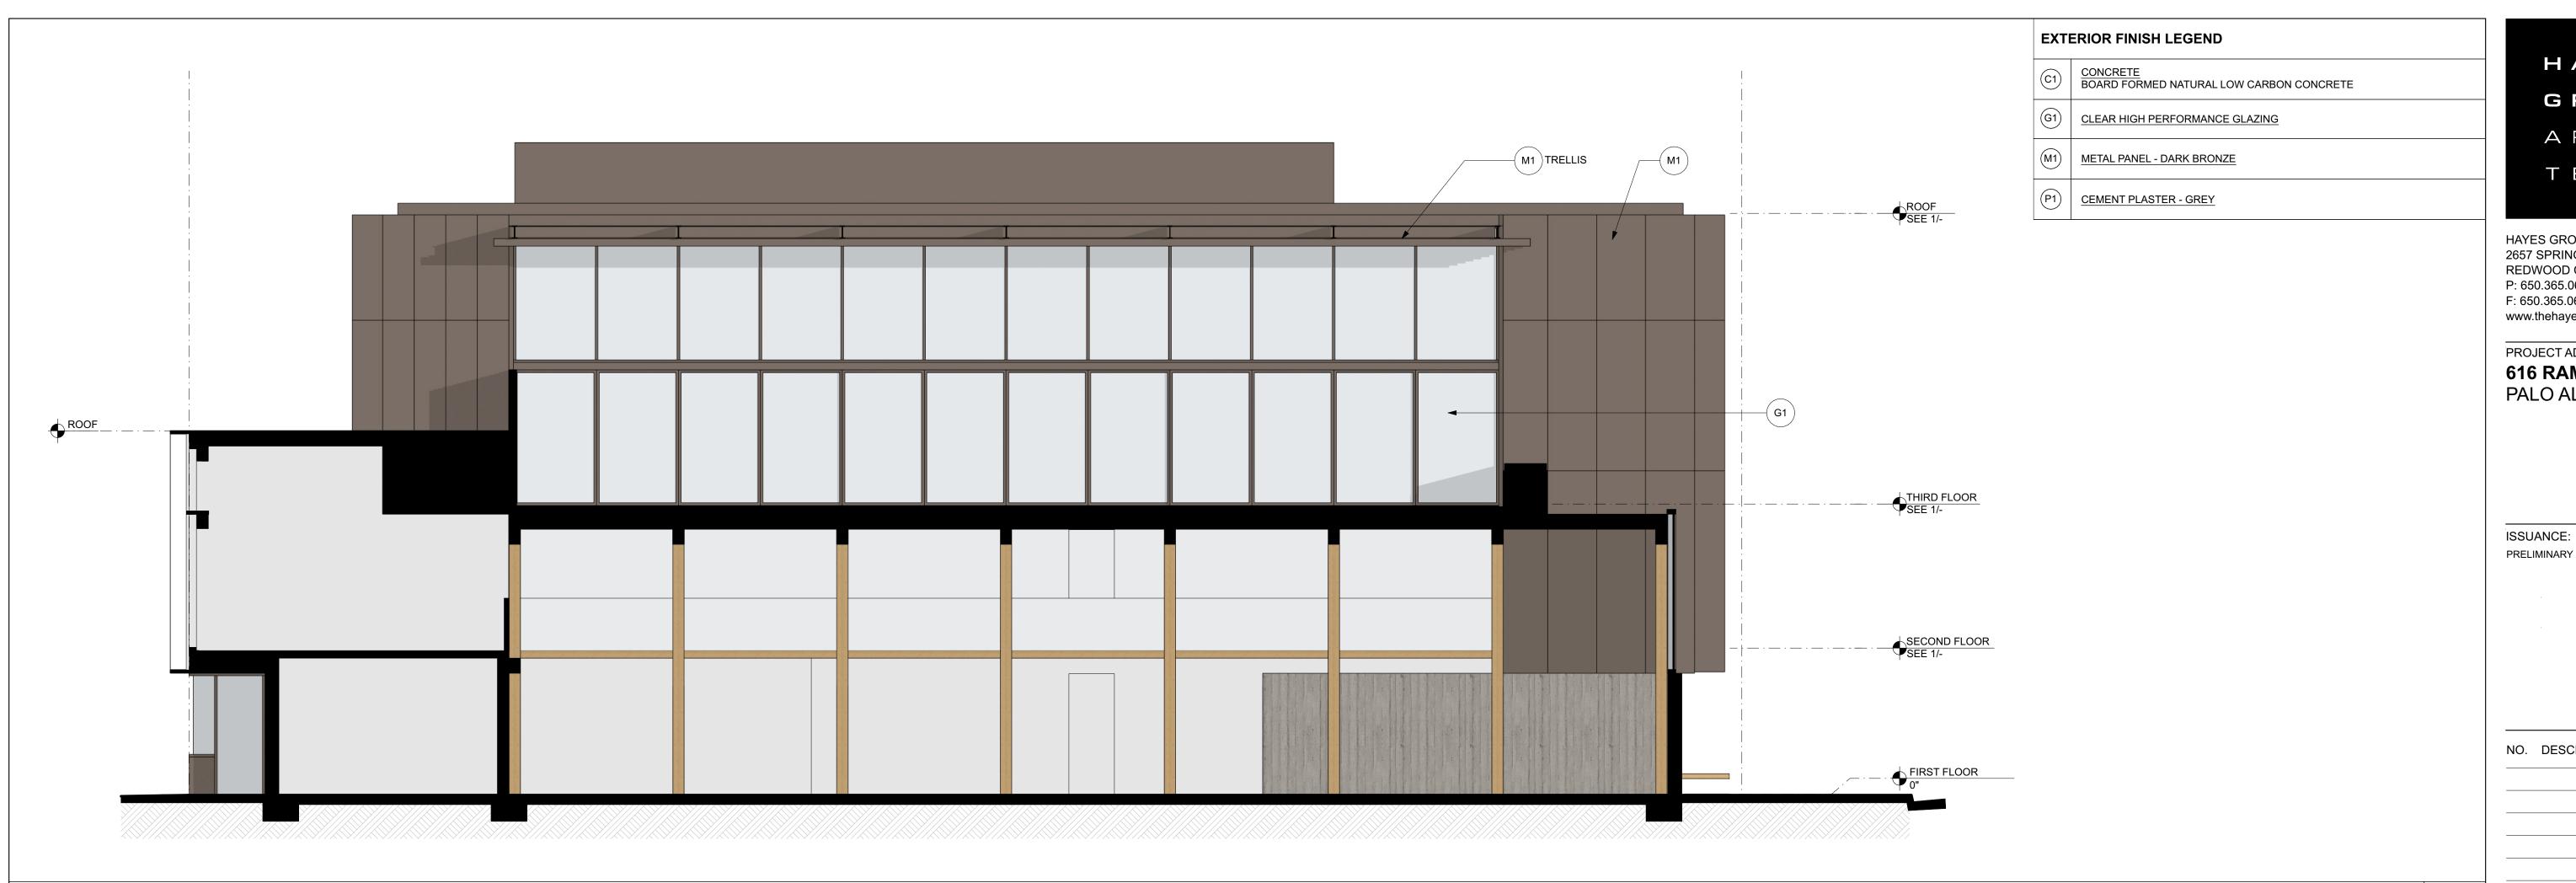

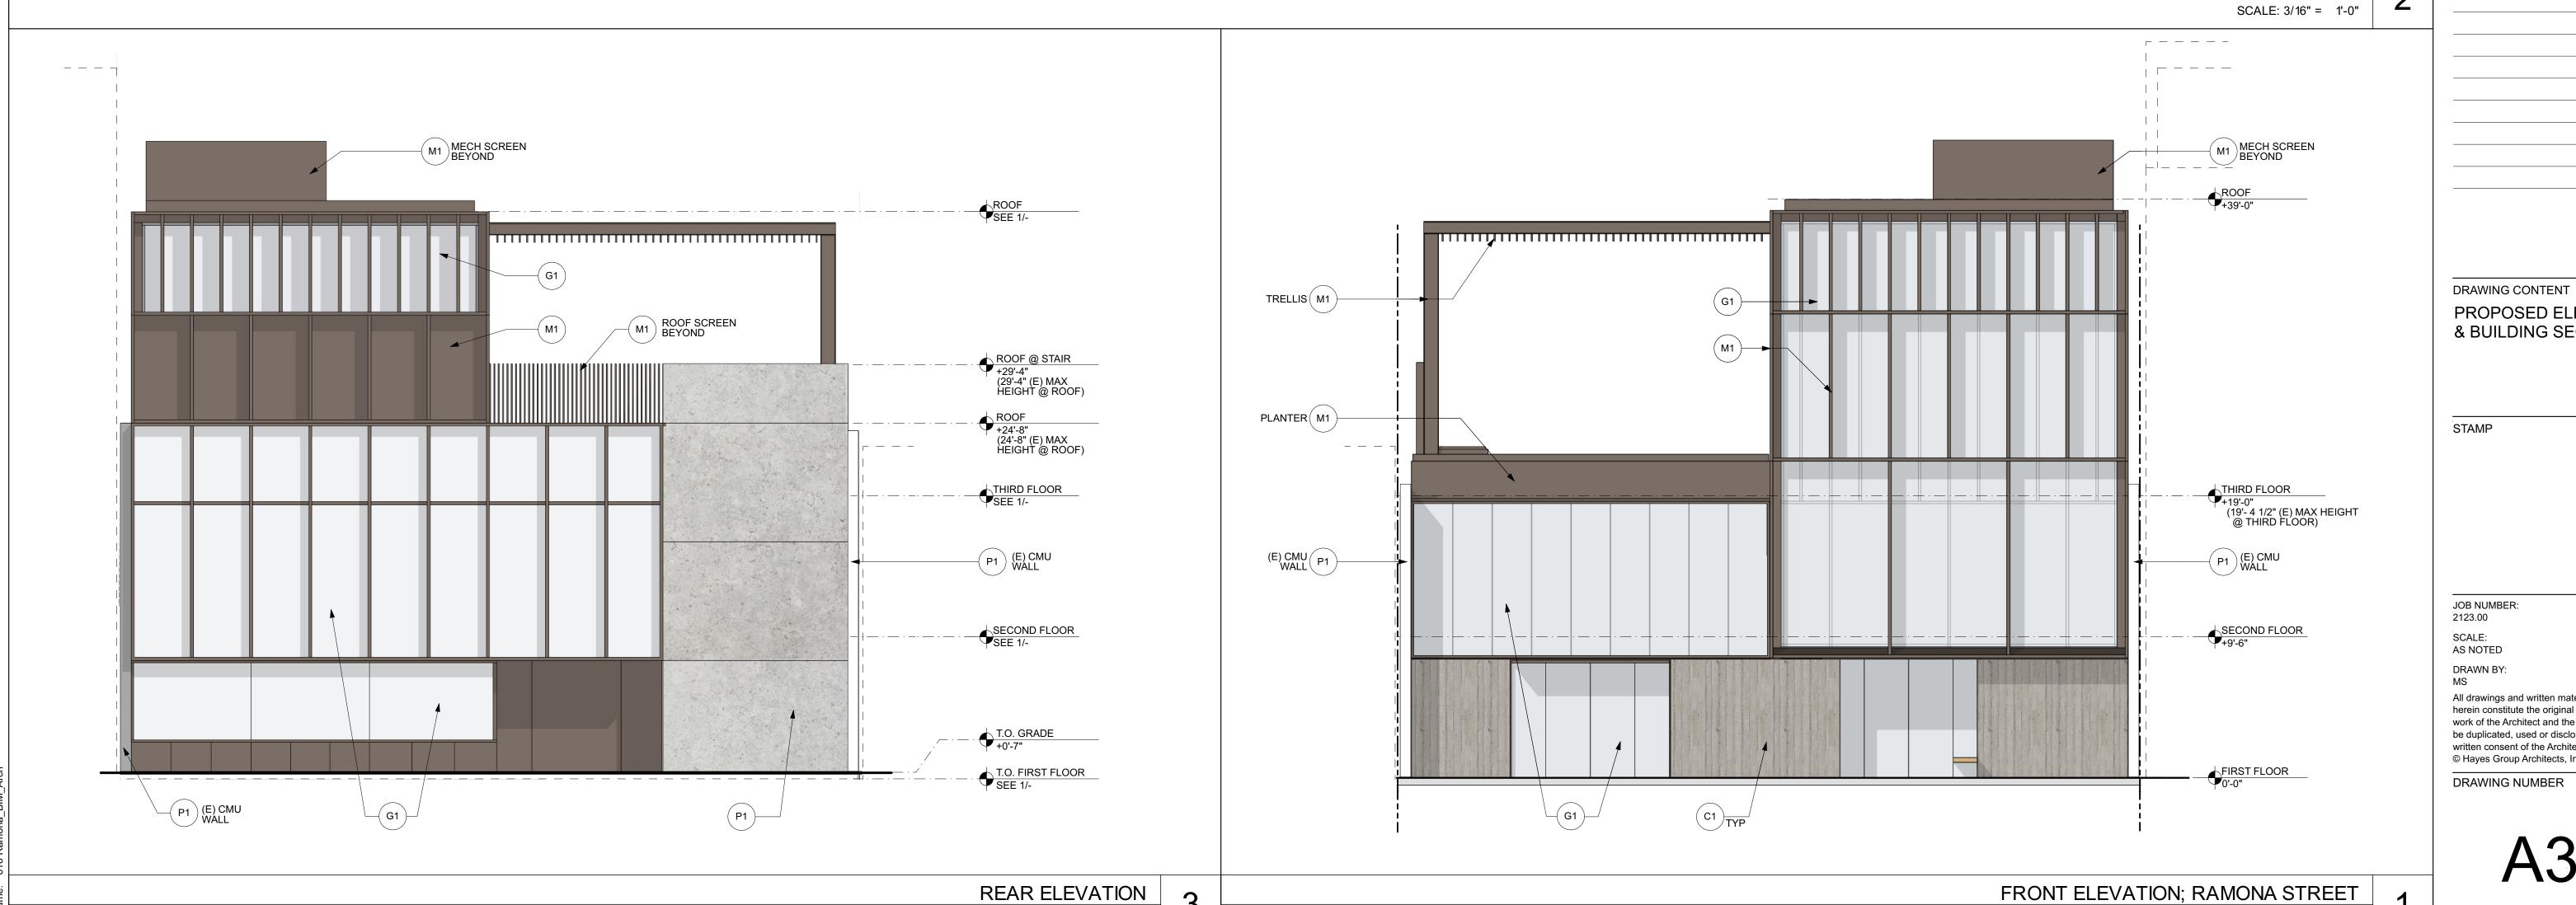

SCALE: 3/16" = 1'-0"

HAYES GROUP ARCHI TECTS

HAYES GROUP ARCHITECTS, INC. 2657 SPRING STREET REDWOOD CITY, CA 94063 P: 650.365.0600 F: 650.365.0670 www.thehayesgroup.com

PROJECT ADDRESS:

616 RAMONA STREET PALO ALTO, CA 94301

PRELIMINARY **ARB** SUBMISSION 08.16.2023

DATE:

NO. DESCRIPTION:

LEFT ELEVATION & BUILDING SECTION


PROPOSED ELEVATIONS & BUILDING SECTION

All drawings and written materials contained

herein constitute the original & unpublished work of the Architect and the same may not be duplicated, used or disclosed without the written consent of the Architect.
© Hayes Group Architects, Inc.

DRAWING NUMBER

SCALE: 3/16" = 1'-0"

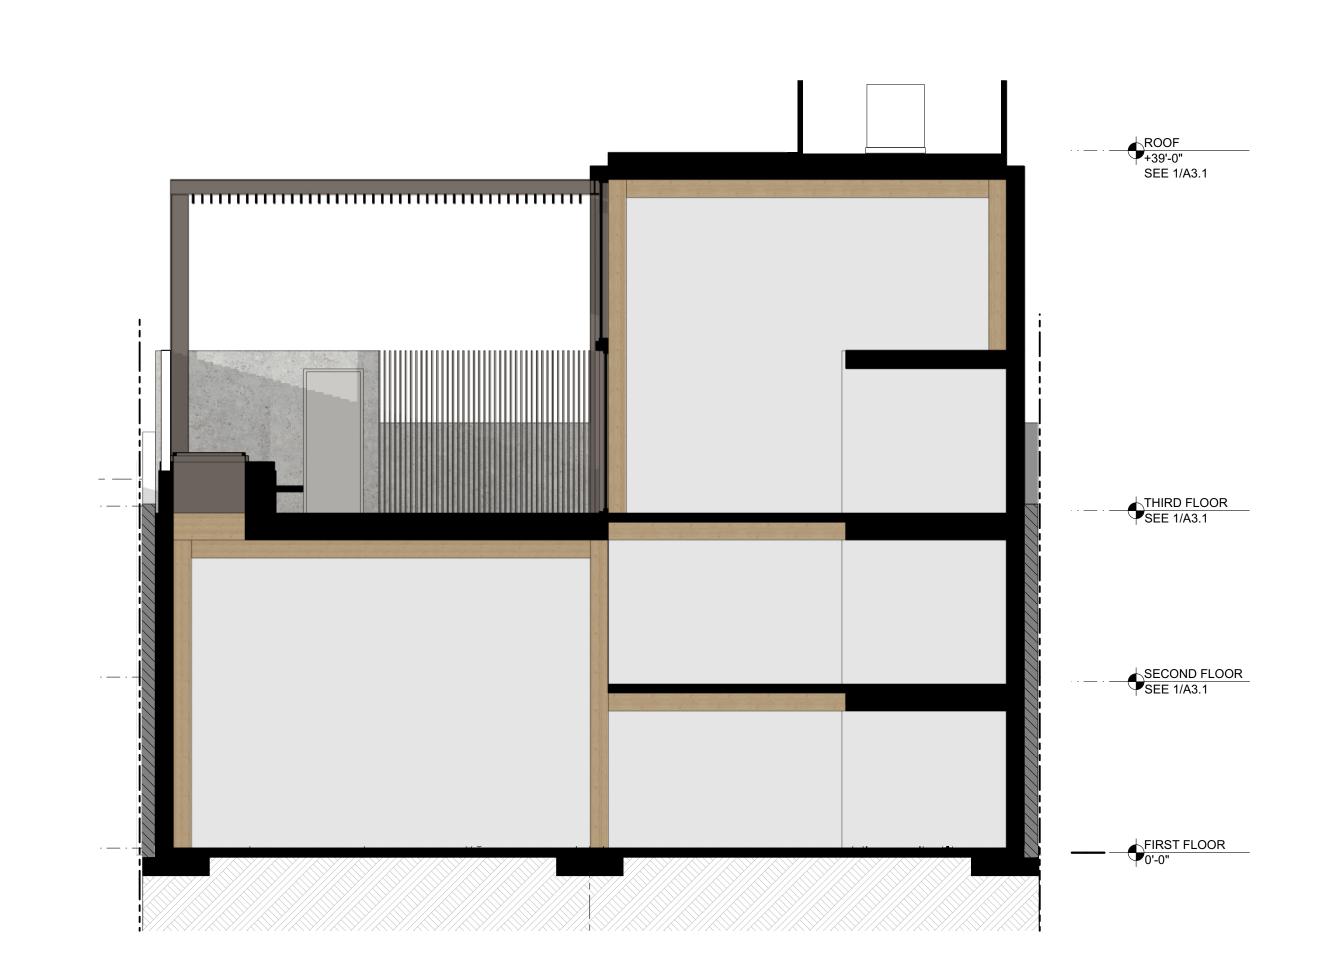

HAYES GROUP ARCHITECTS, INC. 2657 SPRING STREET REDWOOD CITY, CA 94063 P: 650.365.0600 F: 650.365.0670 www.thehayesgroup.com

PROJECT ADDRESS:

616 RAMONA STREET PALO ALTO, CA 94301

ISSUANCE:

PRELIMINARY **ARB** SUBMISSION 08.16.2023

NO. DESCRIPTION:

DATE:

DRAWING CONTENT

PROPOSED BUILDING CROSS SECTION

STAMP

JOB NUMBER: 2123.00

SCALE: AS NOTED

AS NOTED
DRAWN BY:
MS

All drawings and written materials contained herein constitute the original & unpublished work of the Architect and the same may not be duplicated, used or disclosed without the written consent of the Architect.

© Hayes Group Architects, Inc.

DRAWING NUMBER

A3.2





HAYES GROUP ARCHITECTS, INC. 2657 SPRING STREET REDWOOD CITY, CA 94063 P: 650.365.0600 F: 650.365.0670 www.thehayesgroup.com PROJECT ADDRESS: **616 RAMONA STREET** PALO ALTO, CA 94301

HAYES

GROUP

ARCHI

TECTS

ISSUANCE:

PRELIMINARY **ARB** SUBMISSION 08.16.2023

NO. DESCRIPTION:

DATE:

VIEW FROM NORTH

DRAWING CONTENT PERSPECTIVE RENDERINGS

STAMP


JOB NUMBER: 2123.00

SCALE: AS NOTED

All drawings and written materials contained herein constitute the original & unpublished work of the Architect and the same may not be duplicated, used or disclosed without the written consent of the Architect.

© Hayes Group Architects, Inc.

DRAWING NUMBER

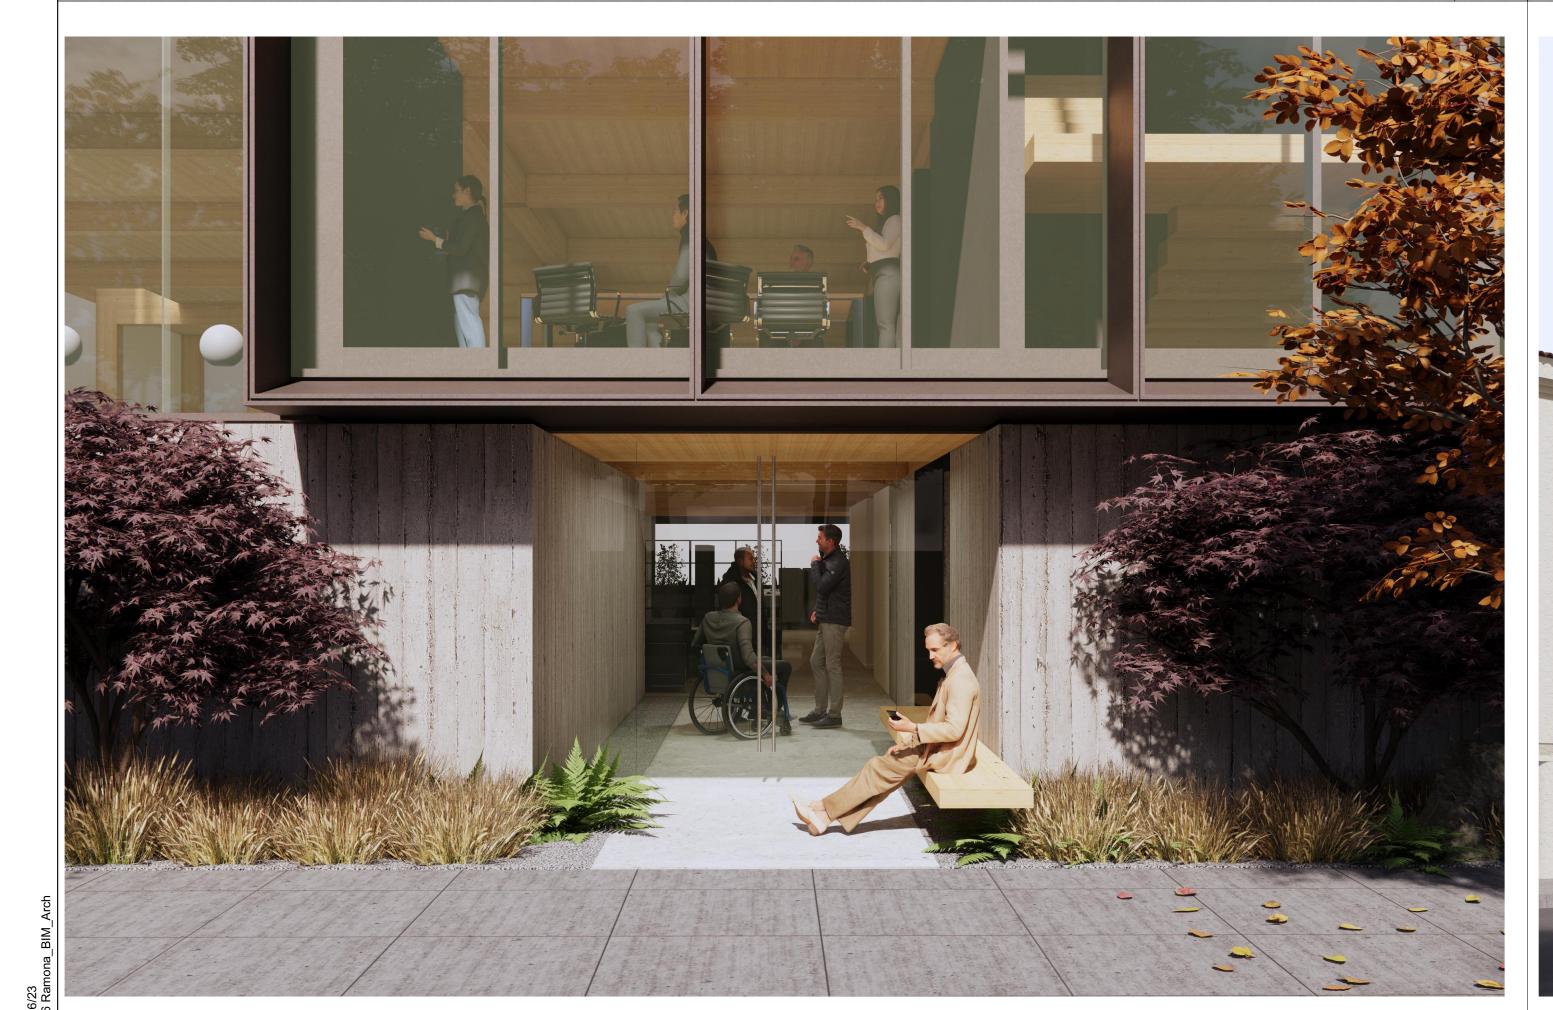

VIEW TOWARD LOBBY ENTRY

VIEW FROM SOUTHEAST



AERIAL VIEW FROM SOUTHEAST



VIEW OF ROOF TERRACE FROM EAST

HAYES
GROUP
ARCHI
TECTS

HAYES GROUP ARCHITECTS, INC. 2657 SPRING STREET REDWOOD CITY, CA 94063 P: 650.365.0600 F: 650.365.0670 www.thehayesgroup.com

PROJECT ADDRESS:

616 RAMONA STREET PALO ALTO, CA 94301

ISSUANCE:

PRELIMINARY **ARB** SUBMISSION 08.16.2023

DATE:

NO. DESCRIPTION:

2

PERSPECTIVE RENDERINGS

STAMP

JOB NUMBER: 2123.00

SCALE: AS NOTED

All drawings and written materials contained herein constitute the original & unpublished work of the Architect and the same may not be duplicated, used or disclosed without the written consent of the Architect.

© Hayes Group Architects, Inc.

DRAWING NUMBER

A4.2


City of Palo Alto Tree Protection - It's Part of the Plan!


Make sure your crews and subs do the job right!

Fenced enclosures around trees are essential to protect them by keeping the foliage canopy and branching structure clear from contact by equipment, materials and activities, preserving roots and soil conditions in an intact and non-compacted state, and identifying the Tree Protection Zone (TPZ) in which no soil disturbance is permitted and activities are restricted, unless otherwise approved. An approved tree protection report must be added to this sheet when project activity occurs within the TPZ of a regulated tree.

For detailed information on Palo Alto's regulated trees and protection during development, review the City Tree Technical Manual (TTM) found at www.cityofpaloalto.org/trees/.

IFOS	TREE DISCLOSURE STATEMENT	CITY OF PALO ALTO Planning Division, 250 Hamilton Avenue Palo Alto, CA 94301 (650) 329-2441 http://www.cityofpaloalto.org
property, and that the	Code, Chapter 8.10.040, requires disclosure and protection hey be shown on approved site plans. A completed disclosuclude exterior work, all demolition or grading permit application	re statement must accompany all building permit
PROPERTY ADDR	RESS:	
Are there Regulate	ed trees on or adjacent to the property?	NO (If no, proceed to Section 4)
[Sections 1- 4 MUS	ST be completed by the applicant. Please circle and/or o	check where applicable.]
1. Where are the tre	ees? Check those that apply. (Plans must be submitted sh	nowing over 4" diameter trees)
☐ On adja	property acent property overhanging the project site city planter strip or right-of-way easement within 30' of prope	rty line (Street Trees)*
	e special protection by a fenced enclosure, per the attached instruction Protection Verification form by calling Public Works Operation Detail #605).	
Protecte Designa On or o	otected or Designated Trees? YES (Check where applied Tree (s) ated Tree (s) verhanging the property or grading within the dripline? (radius 10 times the trunk diam	neter) of these trees?
Attach this report to S	vation Report must be prepared by an ISA certified arborist and si Sheet T-1,:Tree Protection, its Part of the Plan!", per Site Plan Re	
4. Are the Site Plan	Requirements** completed? YES NO	
**D	1.1. 1.1 1.1 1.1 1.1 1.1 1.1 1.1 1.1 1.	
dripline; (2) Plans mu	alated trees during development require the following: (1) Plans must denote, as a bold dashed line, a fenced enclosure area out to the palto.org/trees/forms.htm (See also TTM, Section 2.15 for area to	e dripline, per Sheet T-1 and Detail #605 -
dripline; (2) Plans mu http://www.cityofpalo I, the undersigned misleading informat	ust denote, as a bold dashed line, a fenced enclosure area out to the	e dripline, per Sheet T-1 and Detail #605 - b be fenced) that knowingly or negligently providing false or
dripline; (2) Plans mu http://www.cityofpalo I, the undersigned misleading informat	ust denote, as a bold dashed line, a fenced enclosure area out to the coalto.org/trees/forms.htm (See also TTM, Section 2.15 for area to a square to the conditions of this disclosure. I understand tion in response to this disclosure requirement constitutes a	e dripline, per Sheet T-1 and Detail #605 - b be fenced) that knowingly or negligently providing false or
dripline; (2) Plans mu http://www.cityofpale I, the undersigned misleading informat 8.10.040, which car Signature:	ust denote, as a bold dashed line, a fenced enclosure area out to the balto.org/trees/forms.htm (See also TTM, Section 2.15 for area to a section 2.15 for a section 2.15 for area to a section 2.15 for a section 2.15 f	that knowingly or negligently providing false or violation of the Palo Alto Municipal Code Section
dripline; (2) Plans mu http://www.cityofpale I, the undersigned misleading informat 8.10.040, which car Signature: (Prop.	Is the denote, as a bold dashed line, a fenced enclosure area out to the coalto.org/trees/forms.htm (See also TTM2, Section 2.15 for area to also the conditions of this disclosure. I understand tion in response to this disclosure requirement constitutes an lead to criminal and/or civil legal action. Print: Owner or Agent) FOR STAFF USE:	that knowingly or negligently providing false or violation of the Palo Alto Municipal Code Section Date:
dripline; (2) Plans mu http://www.cityofpale I, the undersigned misleading informat 8.10.040, which car Signature: (Prop. Protective Fencing Sections 5-6 must b 5. Protected Trees. protective fencing is	Is a denote, as a bold dashed line, a fenced enclosure area out to the coalto.org/trees/forms.htm (See also TTM, Section 2.15 for area to a section 2.15 for a section 2.15 for area to a section 2.15 for area to a section 2.15 for area to	that knowingly or negligently providing false or violation of the Palo Alto Municipal Code Section Date: permit (demolition, grading or building permit).
dripline; (2) Plans mu http://www.cityofpale I, the undersigned misleading informat 8.10.040, which car Signature: (Prop. Protective Fencing Sections 5-6 must b 5. Protected Trees. protective fencing is (N/A if there are no 6. Street Trees. A s	Is a denote, as a bold dashed line, a fenced enclosure area out to the coalto.org/trees/forms.htm (See also TTM, Section 2.15 for area to a large to the conditions of this disclosure. I understand tion in response to this disclosure requirement constitutes a n lead to criminal and/or civil legal action. Print: Owner or Agent) FOR STAFF USE: go be completed by staff for the issuance of any development. The specified tree fencing is in place. A written statement is a correctly in place around protected and/or designated trees.	that knowingly or negligently providing false or violation of the Palo Alto Municipal Code Section Date: permit (demolition, grading or building permit). stattached verifying that stattached verifying that
dripline; (2) Plans muhttp://www.cityofpale I, the undersigned misleading informat 8.10.040, which car Signature: (Prop. Protective Fencing Sections 5-6 must be 5. Protected Trees. protective fencing is (N/A if there are no 6. Street Trees. A s (N/A if there are no 1 Regulated Trees – a) S Redwoods which are 18 Redwoods which are 18	Is denote, as a bold dashed line, a fenced enclosure area out to the balto.org/trees/forms.htm (See also TTM, Section 2.15 for area to a line and to continuous forms.htm (See also TTM, Section 2.15 for area to a line at the conditions of this disclosure. I understand tion in response to this disclosure requirement constitutes a note lead to criminal and/or civil legal action. Print: Owner or Agent) FOR STAFF USE: go be completed by staff for the issuance of any development. The specified tree fencing is in place. A written statement is a correctly in place around protected and/or designated trees protected trees, check here signed Public Works Street Tree Protection Verification form.	that knowingly or negligently providing false or violation of the Palo Alto Municipal Code Section Date: permit (demolition, grading or building permit). stattached verifying that s. YES NO is attached. YES NO

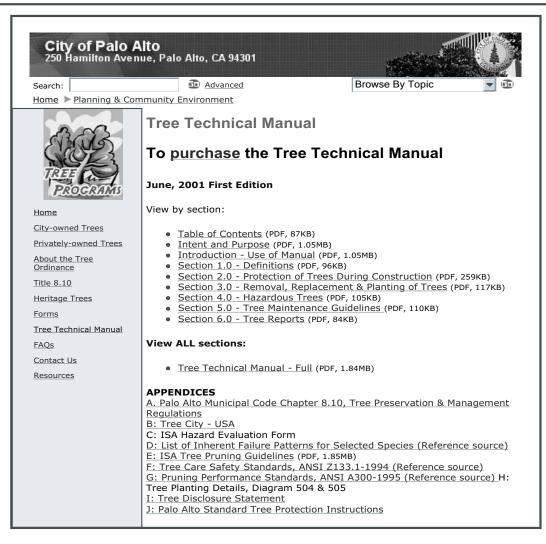

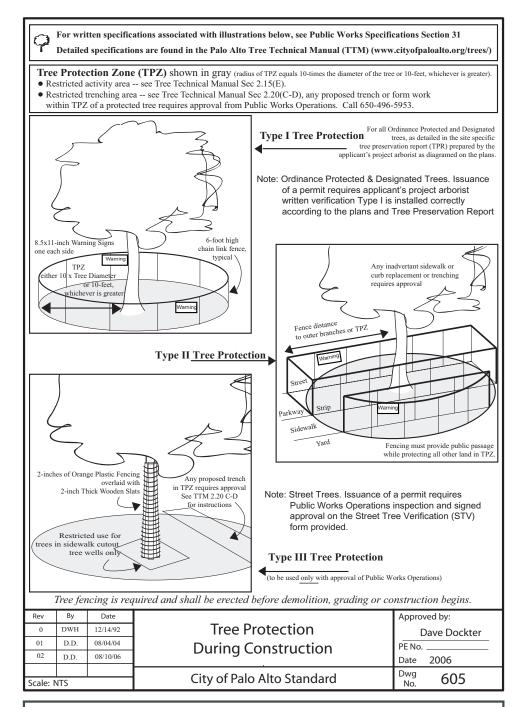

*6	i i i i i i i i i i i i i i i i i i i	APPENDIX J PALO ALTO STREET TREE PROTECTION INSTRUCTIONSSECTION 31				
31-1	Genera					
	a.	Tree protection has three primary functions, 1) to keep the foliage canopy and branching structure clear from contact by equipment, materials and activities; 2) to preserve roots and soil conditions in an intact and non-compacted state and 3) to identify the Tree Protection Zone (TPZ) in which no soil disturbance is permitted and activities are restricted, unless otherwise approved.				
	b.	The Tree Protection Zone (TPZ) is a restricted area around the base of the tree with a radius of ten-times the diameter of the tree's trunk or ten feet; whichever is greater, enclosed by fencing.				
31-2	Reference Documents					
	a.	Detail 605 – Illustration of situations described below.				
	b.	Tree Technical Manual (TTM) Forms (http://www.cityofpaloalto.org/trees/)				
		 Trenching Restriction Zones (<u>TTM</u>, Section 2.20(C)) Arborist Reporting Protocol (<u>TTM</u>, Section 6.30) 				
		3. Site Plan Requirements (TTM, Section 6.35)				
		4. Tree Disclosure Statement (TTM, Appendix J)				
	c.	Street Tree Verification (STV) Form (http://www.cityofpaloalto.org/trees/forms)				
31-3	Execut	ion				
	a.	$\textbf{Type I Tree Protection:} \ \text{The fence shall enclose the entire TPZ of the tree}(s) \ \text{to be protected throughout the}$				
		life of the construction project. In some parking areas, if fencing is located on paving or concrete that will not be demolished, then the posts may be supported by an appropriate grade level concrete base, if approved by Public Works Operations.				
	b.	Type II Tree Protection: For trees situated within a planting strip, only the planting strip and yard side of the TPZ shall be enclosed with the required chain link protective fencing in order to keep the sidewalk and street open for public use.				
	c.	Type III Tree Protection: To be used only with approval of Public Works Operations. Trees situated in a tree well or sidewalk planter pit, shall be wrapped with 2-inches of orange plastic fencing from the ground to the first branch and overlaid with 2-inch thick wooden slats bound securely (slats shall not be allowed to dig into the bark). During installation of the plastic fencing, caution shall be used to avoid damaging any branches. Major limbs may also require plastic fencing as directed by the City Arborist.				
	d.	Size, type and area to be fenced. All trees to be preserved shall be protected with six (6') foot high chain link fences. Fences are to be mounted on two-inch diameter galvanized iron posts, driven into the ground to a depth of at least 2-feet at no more than 10-foot spacing. Fencing shall extend to the outer branching, unless specifically approved on the STV Form.				
	e.	"Warning' signs. A warning sign shall be weather proof and prominently displayed on each fence at 20-foot intervals. The sign shall be minimum 8.5-inches x 11-inches and clearly state in half inch tall letters: "WARNING - Tree Protection Zone - This fence shall not be removed and is subject to a fine according to PAMC Section 8.10.110."				
	f.	Duration. Tree fencing shall be erected before demolition; grading or construction begins and remain in place until final inspection of the project, except for work specifically allowed in the TPZ. Work or soil disturbance in the TPZ requires approval by the project arborist or City Arborist (in the case of work around Street Trees). Excavations within the public right of way require a Street Work Permit from Public Works.				
	g.	During construction				
		 All neighbors' trees that overhang the project site shall be protected from impact of any kind. The applicant shall be responsible for the repair or replacement plus penalty of any publicly owned trees that are damaged during the course of construction, pursuant to Section 8.04.070 of the Palo Alto Municipal Code. The following tree preservation measures apply to all trees to be retained: a. No storage of material, topsoil, vehicles or equipment shall be permitted within the TPZ. 				
		 b. The ground under and around the tree canopy area shall not be altered. c. Trees to be retained shall be irrigated, aerated and maintained as necessary to ensure survival. 				
		END OF SECTION				
		o 2004 Standard Drawings and Specifications				

Table 2-2 Palo Alto Tree Technical Manual				
CONTRACTOR & ARBORIST INSPECTION SCHEDULE				
Reference: the Palo Alto Tree Technical Manual is available at www.cityofpaloalto.org/environment/				
ALL CHECKED ITEMS APPLY TO THIS PROJECT: 1. Inspection of Protective Tree Fencing. For Public Trees, the Street Tree Verification Form shall be signed by the City Arborist. For Protected Trees, the project site arborist shall provide an initial Monthly Tree Activity Report form with a photograph verifying that he has conducted a field inspection of the trees and that the correct type of protective fencing is in place around the designated tree protection zone (TPZ) prior to issuance of a demolition, grading, or building permit. (See TTM, Verification of Tree Protection, Section 1.39).				
 Pre-Construction Meeting. Prior to commencement of construction, the applicant or contractor shall conduct a pre-construction meeting to discuss tree protection with the job site superintendent, grading operators, project site arborist, City Arborist, and, if a city maintained irrigation system is involved, the Parks Manager (Contact 650-496-6962). 				
3. Inspection of Rough Grading or Trenching. Contractor shall ensure the project site arborist performs an inspection during the course of rough grading or trenching adjacent to or within the TPZ to ensure trees will not be injured by compaction, cut or fill, drainage and trenching, and if required, inspect aeration systems, tree wells, drains and special paving. The contractor shall provide the project arborist at least 24 hours advance notice of such activity.				
4. Monthly Tree Activity Report Inspections. The project site arborist shall perform a minimum monthly activity inspection to monitor and advise on conditions, tree health and retention or, immediately if there are any revisions to the approved plans or protection measures. The Tree Technical Manual Monthly Tree Activity Report format shall be used and sent to the Planning Dept. landscape review staff no later than 14 days after issuance of building permit date. Fax to (650) 329-2154. (See TTM, Monthly Tree Activity Inspection Report, Addendum 11 & section 1.17).				
 Special activity within the Tree Protection Zone. Work in the TPZ area (see also #7 below) requires the direct onsite supervision of the project arborist (see TTM, Trenching, Excavation & Equipment, Section 2.20 C). 				
6. Landscape Architect Inspection. For discretionary development projects, prior to temporary or final occupancy the applicant or contractor shall arrange for the Landscape Architect to perform an on site inspection of all plant stock, quality of the materials and planting (see TTM, Planting Quality, Section 5.20.1 A) and that the irrigation is functioning consistent with the approved construction plans. The Planning Dept. landscape review staff shall be in receipt of written verification of Landscape Architect approval prior to scheduling the final inspection, unless otherwise approved.				
7. List Other (please describe as called out in the site Tree Preservation Report, Sheet T-1, T-2, etc.)				
*				

PALO	City of Palo Al Tree Department Public Works Operations PO Box 10250 Palo Alto, CA 650/496-5953 FAX: 650/85: treeprotection@CityofPaloAl	A 94303 2-9289	Verification of Street Tree Protection
			rm. Mail or FAX this form along with signed Tree ks Tree Staff will inspect and notify applicant.
APPLICATION	DATE:		
ADDRESS/LOC TREES TO BE	CATION OF STREET PROTECTED:		
APPLICANT'S NAME:			
APPLICANT'S	ADDRESS:		
APPLICANT'S & FAX NUMBE			
This section to b	oe filled out by City Tree Sta	aff	
The Street Trees at the above address(es) are adequately protected. The type of protection used is:			YES NO*
		* If NO, go to #2 below	
Inspected by	:		
Date of Inspe	ection:		
address are protected. T modification	Trees at the above NOT adequately he following as are required: v the required ss were communicated cant.		
Subsequent Insp	pection		
Street trees at a to be adequately	bove address were found y protected:	*	YES ☐ NO* ☐ NO, indicate in "Notes" below the disposition of case.
Inpsected by:			
Date of Inspect	tion:		
site, condition ar	y street trees by species, nd type of tree protection note if pictures were k of sheet if necessary.		
Return approve S:PWD/OPS/Tree/DS/S	• •	demolition	or building permit issuance.

			RCA/ISA C	Certified Arborist #WE Contact C
M	lonthly Tree Ac	tivity Repo	rt- Construction	Site
Inspection Date: Inspection #	Site address: Palo Alto, CA	Contractor- Main Site Contact Information	#1: Job site superintende Company: Email: Job site Office: Cell: Mail:	ent
		Also present:	:	
Distribution:	City of Palo Alto Others	Attn: Dave Dockter	Dave.dockter@cityofpaloa 650-329-2440	alto.org
a. Tree P	vations (general site-wide rotection Fences (TPF) ar ning has/will occur		lual tree number)	
a. Tree P b. Root z c. Sched 4. Photographs 5. Tree Location	rotection Fence (TPF) ne cone buffer material (woo ule sewer trench, foundati	eds adjusting (tree d chips) can be inst ion dig with 11 sheet)	talled next	
a. Tree P b. Root z c. Schedi 4. Photographs 5. Tree Locati 6. Recommend	rotection Fence (TPF) ne cone buffer material (wood ale sewer trench, foundati is (use often) on Map (mandatory 8.5 x	eds adjusting (tree d chips) can be inst ion dig with 11 sheet)	# x, x, x) talled next aff/schedule	
a. Tree P b. Root z c. Schedi 4. Photographs 5. Tree Locatio 6. Recommend • 7. Past visits (1	rotection Fence (TPF) ne cone buffer material (woo- ule sewer trench, foundati is (use often) on Map (mandatory 8.5 x dations, notes or monitor) dist carry-over items satisf	eds adjusting (tree d chips) can be inst ion dig with 11 sheet) items for project/st fied/still outstandin	# x, x, x) talled next aff/schedule	

---WARNING---**Tree Protection Zone**

This fencing shall not be removed without City Arborist approval (650-496-5953)

Removal without permission is subject to a \$500 fine per day*

*Palo Alto Municipal Code Section 8.10.110 City of Palo Alto Tree Protection Instructions are located at http://www.city.palo-alto.ca.us/trees/technical-manual.htm

SPECIAL INSPECTIONS	PLANNING DEPARTMENT			
TREE PROTECTION INSPECTIONS MANDATORY				
PAMC 8.10 PROTECTED TREES. CONTRACTOR SHALL ENSURE PROJ REQUIRED TREE INSPECTION AND SITE MONITORING. PROVIDE WRI REPORTS TO THE PLANNING DEPARTMENT LANDSCAPE REVIEW ST BUILDING PERMIT ISSUANCE.	TTEN MONTHLY TREE ACTIVITY			
BUILDING PERMIT DATE:				
DATE OF 1ST TREE ACTIVITY REPORT:				
CITY STAFF:				
REPORTING DETAILS OF THE MONTHLY TREE ACTIVITY REPORT SHALL CONFORM TO SHEET T-1 FORMAT, VERIFY THAT ALL TREE PROTECTION MEASURES ARE IMPLIMENTED AND WILL INCLUDE ALL CONTRACTOR ACTIVITY, SCHEDULED OR UNSCHEDULED, WITHIN A TREE PROTECTION ROOT ZONE. NON-COMPLIANCE IS SUBJECT TO VIOLATION OF PAMC 8.10.080. REFERENCE: PALO ALTO TREE TECHNICAL MANUAL, SECTION 2.00 AND ADDENDUM 11.				

Apply Tree Protection Report on sheet(s) T-2

Use addtional "T" sheets as needed

All other tree-related reports shall be added to the space provided on this sheet (adding as needed) Include this sheet(s) on Project Sheet Index or Legend Page. A copy of T-1 can be downloaded at

http://www.cityofpaloalto.org/civica/filebank/blobdload.asp?BlobID=6460

Special Tree Protection Instruction Sheet City of Palo Alto



1-1

HAYES GROUP ARCHI TECTS

HAYES GROUP ARCHITECTS, INC 2657 SPRING STREET REDWOOD CITY, CA 94063 P: 650.365.0600 F: 650.365.0670 www.thehayesgroup.com

PROJECT ADDRESS:

616 RAMONA STREET PALO ALTO, CA 94301

ISSUANCE:

PRELIMINARY **ARB** SUBMISSION 08.16.2023

NO. DESCRIPTION:

DRAWING CONTENT TREE PROTECTION

STAMP

SHEET

JOB NUMBER:

DRAWN BY:

2123.00 SCALE: AS NOTED

> All drawings and written materials contained herein constitute the original & unpublished work of the Architect and the same may not be duplicated, used or disclosed without the written consent of the Architect.

© Hayes Group Architects, Inc.