

660 UNIVERSITY AVE.

PALO ALTO, CA



PLANNING RESUBMITTAL #7
02.07.2024

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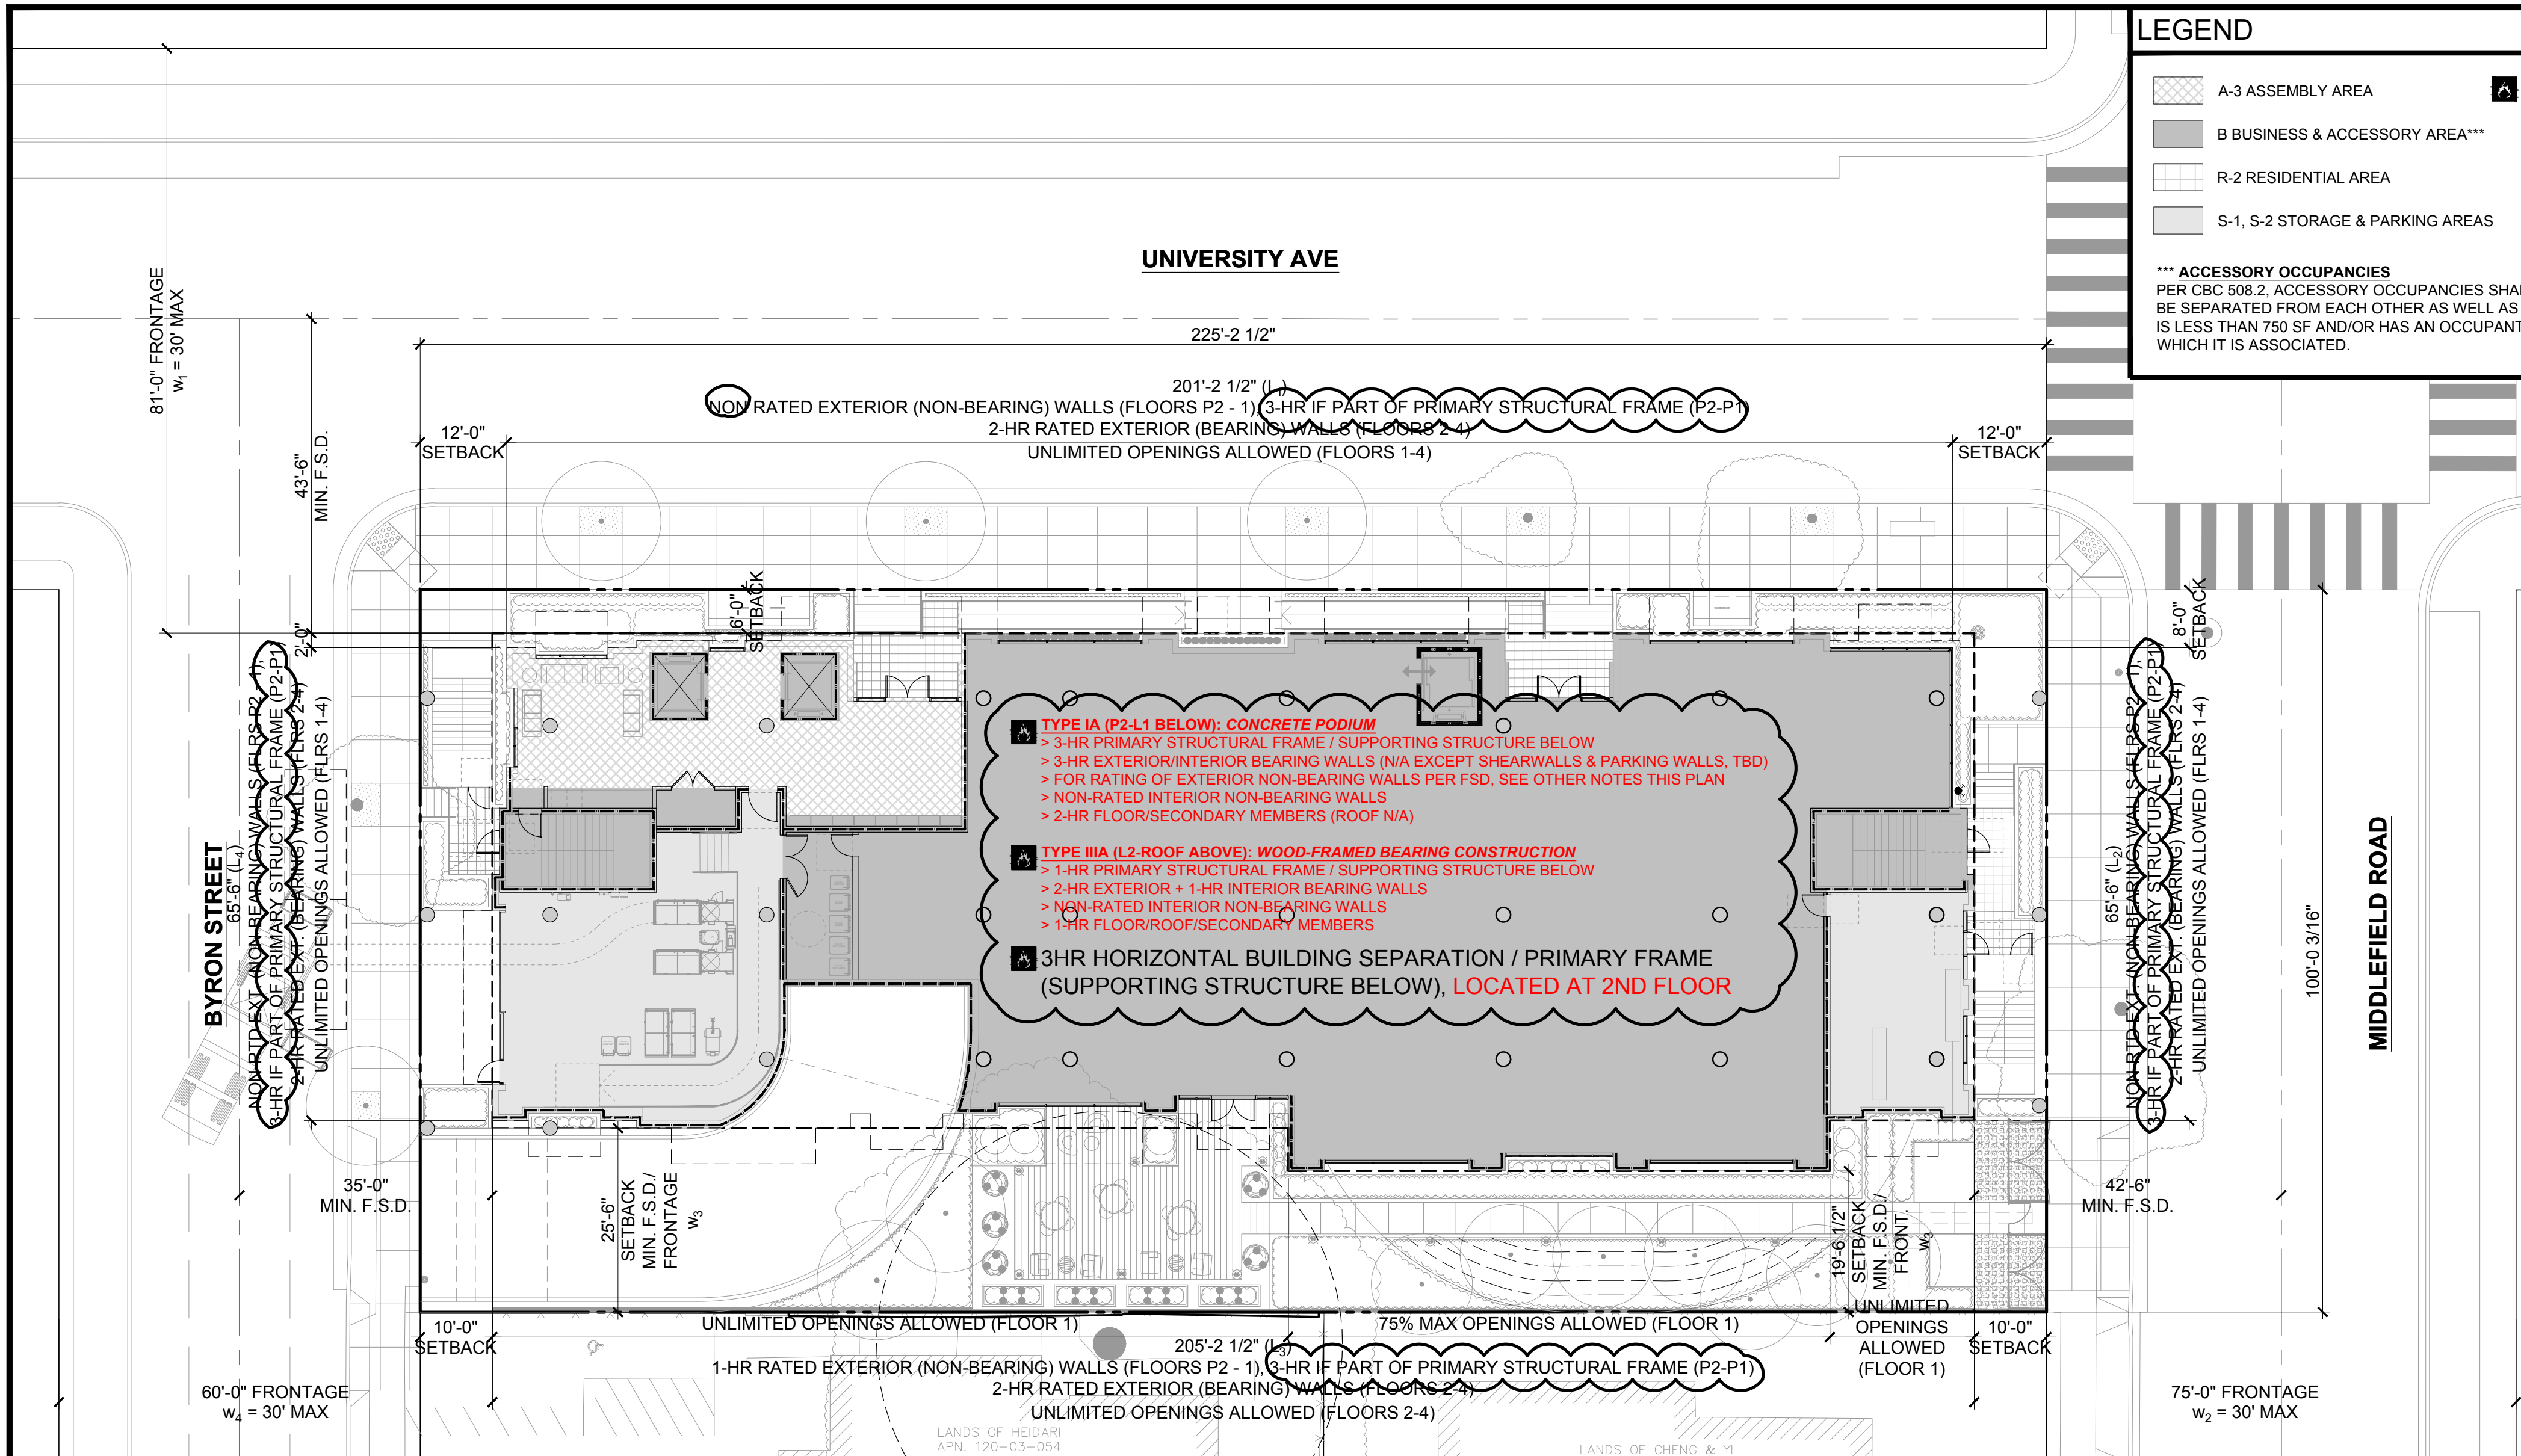
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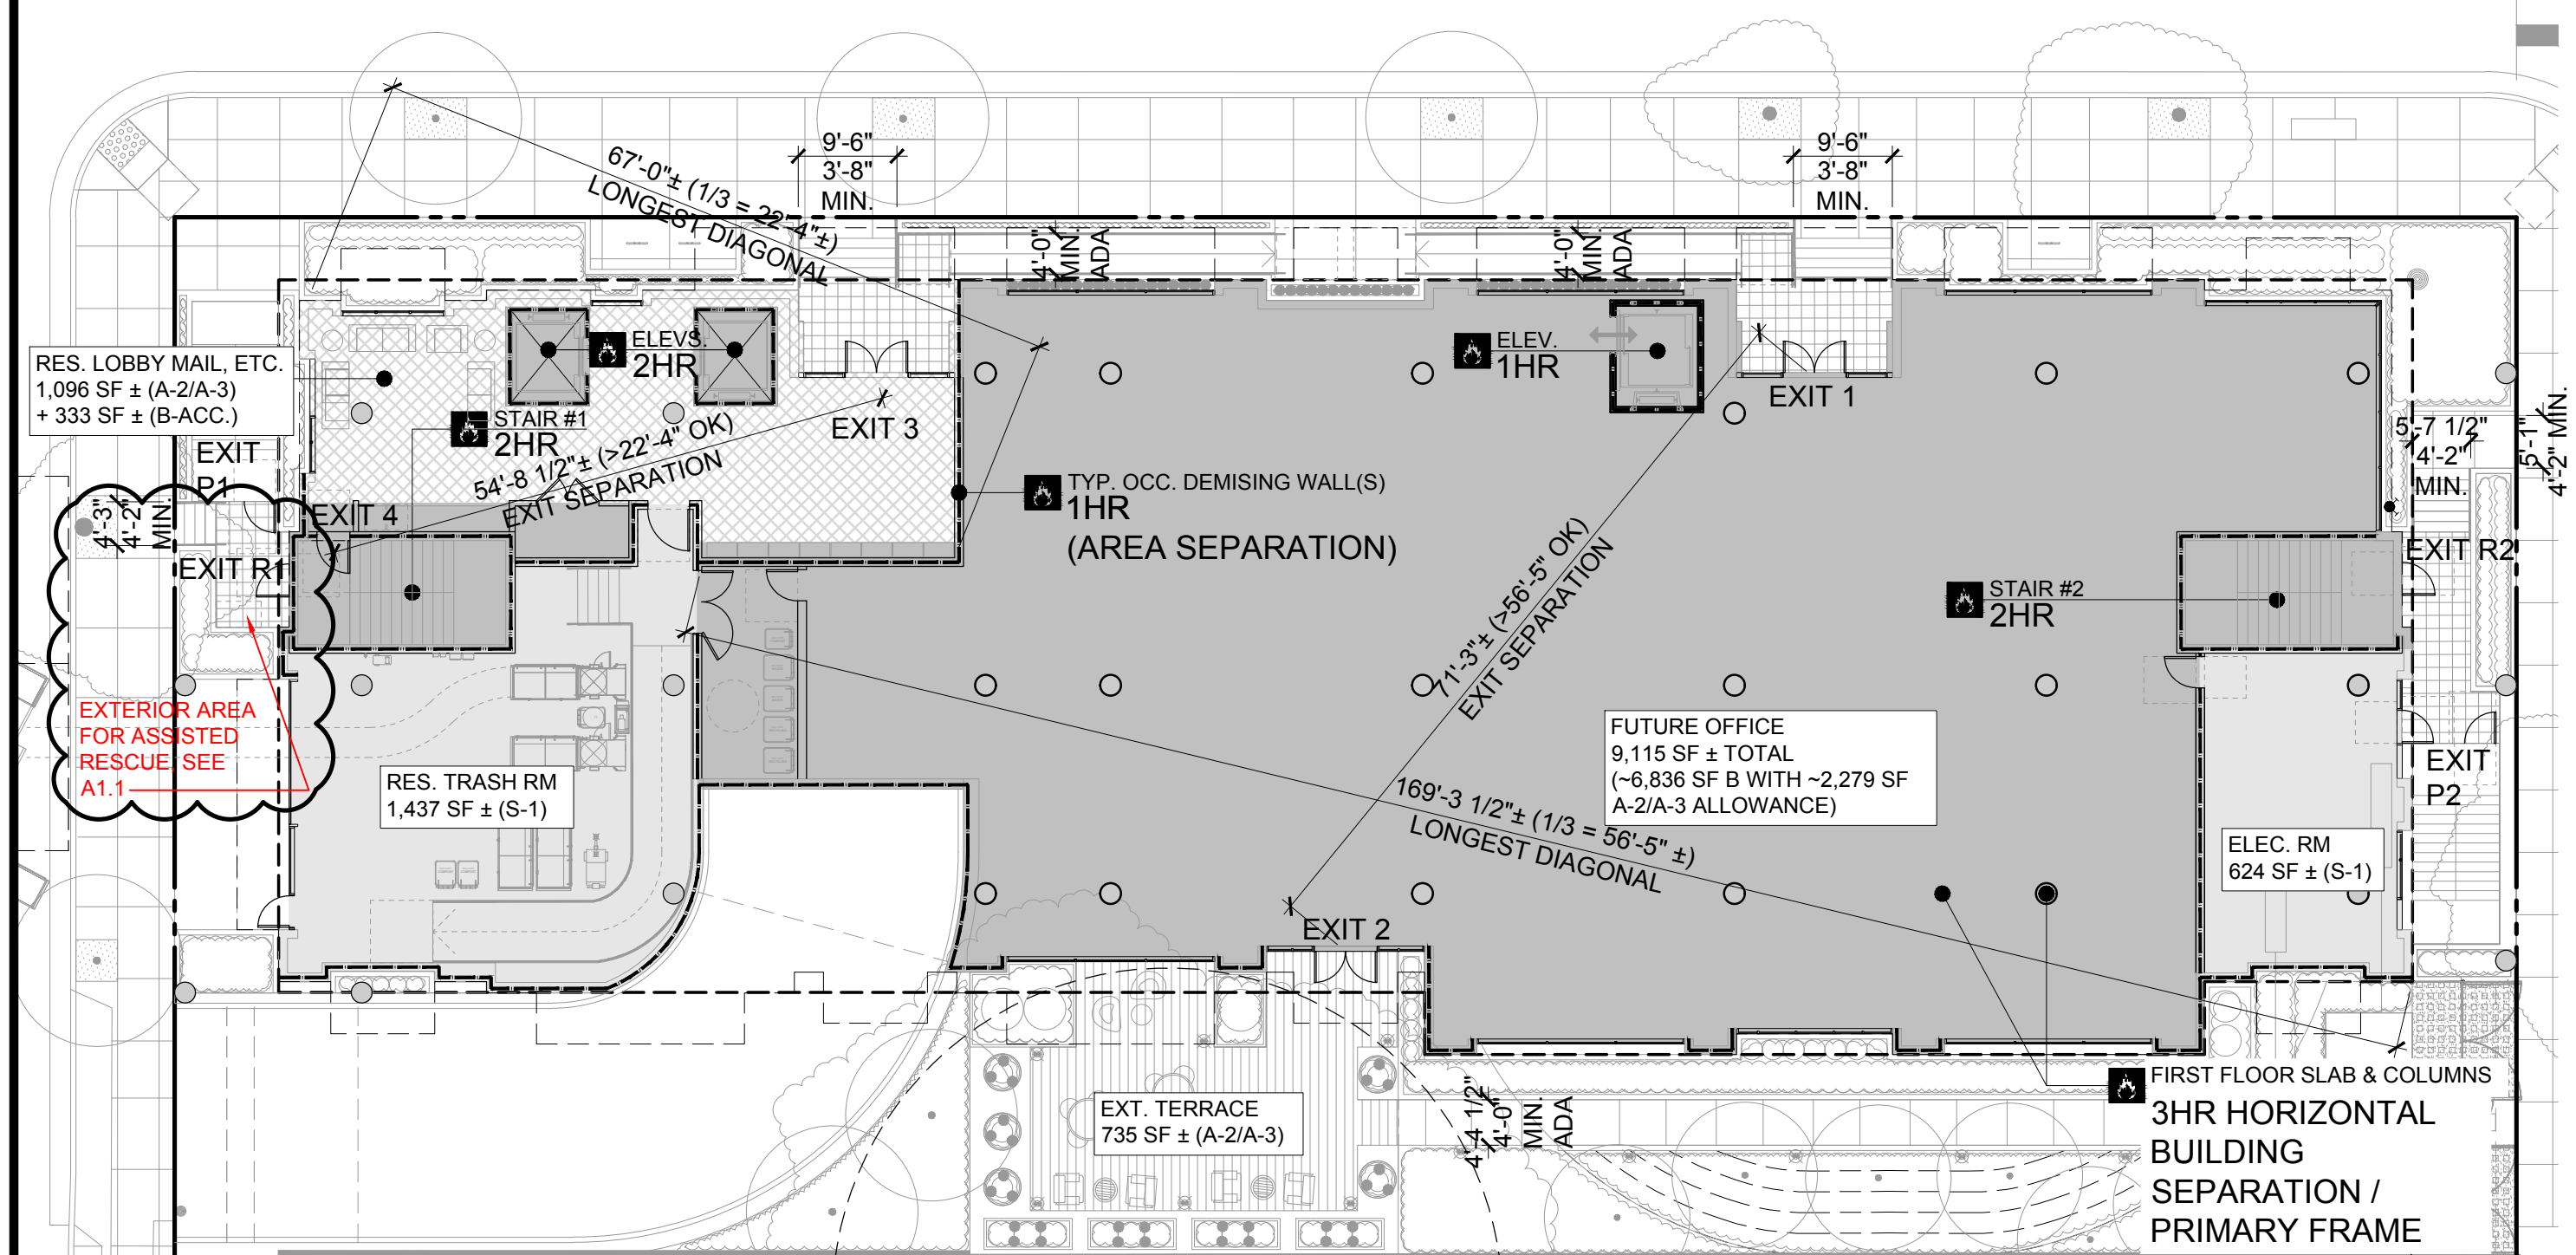
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2 SITE COMPLIANCE PLAN
1/16"=1'-0"



1 FIRST FLOOR EGRESS PLAN
1/16"=1'-0"

FIRST FLOOR OCCUPANCY CALCULATIONS:
OFFICE OCCUPANCY (9,115 SF TOTAL INTERIOR + 735 SF EXTERIOR), GROUPS A-2/A-3, B

FUTURE OFFICE AREA (75% OF GROSS, 1 OCC. / 150 SF)
GROUP B, SUB AREA: 6,836 SF. / 150 = **46 OCC.**

FUTURE CONFERENCE/BREAKROOM ALLOWANCE (25% OF GROSS, 1 OCC. / 15 SF)
GROUPS A-2, A-3, SUB AREA: 2,279 SF. / 15 = **152 OCC.**

198 TOTAL (INTERIOR) OFFICE OCCUPANTS (2 EXITS REQUIRED / PROVIDED)

OFFICE EGRESS (DOOR) WIDTH: 198 X 0.2 = 39.6" MIN. REQ.
2 DOORS (EXITS 1 & 2) @ 64" MIN. CLR. EA. (128" TOTAL) PROV.

OFFICE STAIR/RAMP WIDTH: 198 X 0.3 = 59.4" MIN. REQ.
2 PATHS (EXITS 1 & 2) @ 44" MIN. CLR. EA. (88" TOTAL) PROV.

EXTERIOR GARDEN TERRACE (1 OCC. / 15 SF) GROUPS A-2, A-3
735 SF. / 15 = **49 OCC.** (1 EXIT REQUIRED / PROVIDED)

RESIDENTIAL OCCUPANCY (3,956 SF TOTAL), GROUPS A-2/A-3, B, S-1

LOBBY/LOUNGE (1,096 SF) GROUP A-2/A-3 (1 OCC. / 15 SF)
1,096 / 15 = **74 OCCUPANTS** (2 EXITS REQ/PROV. - EXITS 3 & 4)

MAIL, CIRCULATION, ETC. (333 SF) GROUP B (1 OCC. / 150 SF)
333 / 150 = **3 OCCUPANTS** (1 EXIT REQ / 2 PROV)

77 TOTAL RESIDENTIAL OCCUPANTS (2 EXITS REQUIRED / PROVIDED)

RESIDENTIAL EGRESS (DOOR) WIDTH: 77 X 0.2 = 15.4" MIN. REQ.
1 DOOR @ 64" MIN. CLR. + 1 DOOR @ 32" MIN. CLR. (EXITS 3 & 4) (128" TOTAL) PROV.

RESIDENTIAL STAIR/RAMP WIDTH: 77 X 0.3 = 23.1" MIN. REQ.
1 PATH @ 44" MIN. CLR. + 1 PATH @ 50" MIN. CLR (EXITS 3 & 4) (94" TOTAL) PROV.

OCCUPANCIES EXCLUDED FROM OVERALL DUE TO DIRECT EXITS TO EXTERIOR
ELEC. RM + RES. TRASH RM (624 SF + 1,437 SF), GROUP S-1 (1 OCC. / 300 SF)
624 / 300 = **3 OCC.** + 1,437 / 300 = **5 OCC.** (1 EXIT REQ/PROV AT EACH ROOM)

STAIRS #1/2 (233 SF EA.) GROUP B-ACCESSORY (1 OCC. / 150 SF)
233 / 150 = **2 OCCUPANTS EA.**

EXIT DOORS R1 / R2 & STAIR WIDTH (ABOVE / AT GRADE) BASED ON ROOF OCC. CALCS
MIN. DOOR WIDTH = 34" CLR. EA. I.E. 38" DOOR (EXITS R1/R2 ONLY)
MIN. AT GRADE STAIR WIDTH = 50" (EXITS R1/R2 ONLY)

LEGEND

- A-3 ASSEMBLY AREA
- B BUSINESS & ACCESSORY AREA***
- R-2 RESIDENTIAL AREA
- S-1, S-2 STORAGE & PARKING AREAS
- RATED BUILDING ELEMENT (AS NOTED)
- * COMMON PATH OF EGRESS (CBC T 1006.2.1)
A, M = 75' MAX. (SPRINKLERED)
B, S = 100' MAX. (SPRINKLERED)
- ** EXIT ACCESS TRAVEL DISTANCE (CBC T 1017.2)
A, M, R, S-1 = 250' MAX. (SPRINKLERED)
B = 300' MAX. (SPRINKLERED)
S-2 = 400' MAX. (SPRINKLERED)
- EGRESS PATH OF TRAVEL
- ACCESSIBLE PATH OF TRAVEL (SEE 3/-)
- POINT OF DECISION
(END OF COMMON PATH OF TRAVEL)

*** ACCESSORY OCCUPANCIES
PER CBC 508.2, ACCESSORY OCCUPANCIES SHALL BE INDIVIDUALLY CLASSIFIED BUT ARE NOT REQUIRED TO BE SEPARATED (EXCEPT R-2 DWELLINGS ARE TO BE SEPARATED FROM EACH OTHER AS WELL AS CONTIGUOUS ACCESSORY SPACE, I.E. CORRIDORS). IN ADDITION, PER CBC 303.1.2, A ROOM OR SPACE THAT IS LESS THAN 750 SF AND/OR HAS AN OCCUPANT LOAD OF LESS THAN 50 SHALL BE CLASSIFIED AS B-OCCUPANCY OR AS A PART OF THAT OCCUPANCY WITH WHICH IT IS ASSOCIATED.

BUILDING CODE SUMMARY

BUILDING CODE: 2022 CALIFORNIA BUILDING CODE & ASSOCIATED					
AREAS:	GROUP A	GROUP B	GROUP R-2	GROUP S-1	GROUP S-2
ROOF	4,672 SF	928 SF	0 SF	407 SF	0 SF
4TH FLR	0 SF	0 SF	11,840 SF	0 SF	0 SF
3RD FLR	0 SF	0 SF	13,324 SF	0 SF	0 SF
2ND FLR	0 SF	0 SF	13,224 SF	0 SF	0 SF
1ST FLR	3,375 SF	7,635 SF	0 SF	2,061 SF	0 SF
LEVEL P1	0 SF	0 SF	0 SF	0 SF	19,767 SF
LEVEL P2	0 SF	0 SF	0 SF	0 SF	18,038 SF
TOTAL	8,047 SF	8,563 SF	38,388 SF	2,468 SF	37,805 SF

GRAND TOTAL GROSS BUILDING AREA: 95,271 SF
NO. OF STORIES: 4 (PLANNING), 4 STORY TYPE IIIA OVER 1 STORY TYPE IA (BUILDING)
HEIGHT: 45'-5" (TO TOP OF OCCUPIED EXTERIOR TERRACE (ABOVE B.F.E.) / 47'-7 1/2" FROM GRADE
SEE ALSO A3 - ELEV. & SECT. FOR MORE DETAIL

CONSTRUCTION TYPE:
TYPE IIIA (L2/L4, ROOF), GROUPS A/B/R-2/S-1 OVER TYPE IA (P2-L1), GROUPS A/B/S-1/S-2
FULLY SPRINKLERED, SEPARATED OCCUPANCIES

RATING REQUIREMENTS (CBC TABLE 601):
PRIMARY STRUCTURAL FRAME: 1 HR (TYPE IIIA) / 3 HR (TYPE IA)
BEARING WALLS EXTERIOR: 2 HR (TYPE IIIA) / 3 HR (TYPE IA)
BEARING WALLS INTERIOR: 1 HR (TYPE IIIA) / 3 HR (TYPE IA)
NON-BEARING WALLS EXTERIOR: PER CBC TABLE 705.5
NON-BEARING WALLS INTERIOR: 0 HR
FLOOR CONSTRUCTION AND SECONDARY MEMBERS: 1 HR (TYPE IIIA) / 2 HR (TYPE IA)
ROOF CONSTRUCTION AND SECONDARY MEMBERS: 1 HR (TYPE IIIA) / 1 1/2 HR (TYPE IA)

RATING REQUIREMENTS FOR EXTERIOR WALLS BASED ON FIRE SEPARATION DISTANCE (CBC T 705.5):
FSD < 5': 1-HR (GROUP A, B, R, S-2), 2-HR (GROUP S-1)
5' < FSD < 10': 1-HR (GROUP A, B, R, S-2), 2-HR (GROUP S-1 TYPE 1A), 1-HR (GROUP S-1 TYPE IIIA)
10' < FSD < 30': 1-HR (GROUP A, B, R, S)
30' < FSD: NON-RATED (ALL GROUPS)

ALLOWABLE OPENINGS IN EXTERIOR WALLS BASED ON FIRE SEPARATION DISTANCE (CBC T 705.8):
EXTERIOR WALLS (15' < FSD < 20'): 75% MAX (SPRINKLERED)
EXTERIOR WALLS (20' < FSD): NO LIMIT (SPRINKLERED)

ALLOWABLE PROJECTIONS FROM EXT. WALLS BASED ON FIRE SEPARATION DISTANCE (CBC T 705.2):
5' < FSD: 40" MAX. (NON-COMBUSTIBLE) PROJECTIONS ALLOWED

MIXED-OCCUPANCY, MULTISTORY BUILDING ANALYSIS
PER CBC 506.2.2 EA. STORY OF A MIXED-OCCUPANCY BUILDING WITH MORE THAN ONE STORY ABOVE GRADE PLANE SHALL INDIVIDUALLY COMPLY WITH THE APPLICABLE REQUIREMENTS OF SECTION 508.1. FOR BUILDINGS WITH MORE THAN THREE STORIES ABOVE GRADE PLANE, THE TOTAL BUILDING AREA SHALL BE SUCH THAT THE AGGREGATE SUM OF THE RATIOS OF THE ACTUAL AREA OF EACH STORY DIVIDED BY THE ALLOWABLE AREA OF SUCH STORIES, DETERMINED IN ACCORDANCE WITH EQUATION 5-3 SHALL NOT EXCEED THREE (OR TWO FOR BUILDINGS CONTAINING R OCCUPANCIES)

ALLOWABLE AREA / HEIGHT WITH INCREASES (TABLES 504.3, 504.4, 506.2)
> OCCUPANCY A-2/A-3 (FIRST FLOOR RES. LOBBY/LOUNGE & EXT. TERRACES AT FOURTH FLOOR & ROOF*)
ALLOWABLE HEIGHT PER TABLE 504.3 & 504.4:
65' / 4 STORIES, W/O AREA INCREASE, UNLIMITED (TYPE IA)
ALLOWABLE AREA PER TABLE 506.2:
21,000 SF WITH FRONTAGE INCREASE FACTOR OF .5 (TYPE IIIA), UNLIMITED (TYPE IA)
> OCCUPANCY B (PROPOSED 1 STORY / FIRST FLOOR ONLY)
ALLOWABLE HEIGHT PER TABLE 504.3 & 504.4: UNLIMITED (TYPE IA)
ALLOWABLE AREA PER TABLE 506.2: UNLIMITED (TYPE IA)

> OCCUPANCY R-2
ALLOWABLE HEIGHT PER TABLE 504.3 & 504.4:
65' / 4 STORIES, W/ AREA INCREASE
ALLOWABLE AREA PER TABLE 506.2:
84,000 SF WITH FRONTAGE INCREASE FACTOR OF .5 (TYPE IIIA)
> OCCUPANCY S-1, S-2
ALLOWABLE HEIGHT PER TABLE 504.3 & 504.4: 85' / 4 STORIES (TYPE IIIA), UNLIMITED (TYPE IA)
ALLOWABLE AREA PER TABLE 506.2:
136,500 SF WITH FRONTAGE INCREASE FACTOR OF .5 (TYPE IIIA), UNLIMITED (TYPE IA)

*FRONTAGE (AREA) INCREASE OF .5 PER CBC TABLE 506.3.3 IS BASED ON OPEN SPACE OF 67% GREATER THAN 30 FEET, 20% 25-30 FEET, 13% 0-20 FEET WHICH PROVIDES FOR +7,000 SF (A-3), +14,250 SF (B), +19,500 SF (S-2), +12,000 SF (R-2) FOR TYPE IIIA.

MIXED OCCUPANCY FLOOR RATIOS, SEPARATED PER CBC 508.4
FIRST FLOOR: A-2/A-3, B, R-2, S-1 OCCUPANCIES, UNLIMITED (TYPE IA)

SECOND FLOOR: R-2 OCC.
GROUP R-2: 13,224 SF ACTUAL / 84,000 SF ALLOWED = .157 (OK, < 1)

THIRD FLOOR: R-2 OCC.
GROUP R-2: 13,324 SF ACTUAL / 84,000 SF ALLOWED = .159 (OK, < 1)

FOURTH FLOOR: R-2 OCC.
GROUP R-2: 11,840 SF ACTUAL / 84,000 SF ALLOWED = .141 (OK, < 1)

ROOF: A-3, B + S-1 OCC. (TREATED AS ACCESSORY TO A-3)
GROUP R-2: 6,007 SF ACTUAL / 21,000 SF ALLOWED = .286 (OK, < 1)
BUILDING TOTAL = .743 (OK, < 2 ALLOWED)

THE DESIGN PROPOSES AN OCCUPIED ROOF WITH GROUP A-3 AMENITY SPACE, PARTIALLY COVERED BY TRELLIS STRUCTURES. THE ROOF IS PROPOSED TO BE CONSIDERED A STORY ABOVE GRADE WITH COMPLIANCE WITH CBC CHAPTER 5 REQUIREMENTS FOR A GROUP A OCCUPANCY, INCLUDING THE HEIGHT, NUMBER OF STORIES, AND BUILDING AREA.

OCCUPANCY SEPARATIONS
HORIZONTAL BUILDING SEPARATION WILL BE PROVIDED AT THE SECOND FLOOR (3-HR SLAB + SUPPORT) PER CBC 510.2.

SPECIAL CONDITIONS - GROUP R-2 (CBC 420)
DWELLING UNITS TO BE SEPARATED BY (1-HR) FIRE PARTITIONS (VERTICAL SEPARATION) & (1-HR) FLOORS (HORIZONTAL SEPARATION), SUPPORTED BY MIN. 1-HR RATED STRUCTURE/SUPPORT, TYP.

SPECIAL CONDITIONS - ELECTRICAL ROOMS (CALIFORNIA ELECTRICAL CODE)
TO BE CONFIRMED BASED ON EQUIPMENT SPECIFIED AT TIME OF BUILDING PERMIT SUBMITTAL

REQUIRED SEPARATION OF OCCUPANCIES (HOURS) PER CBC TABLE 508.4
A/B & R-2: 1-HR FIRE BARRIER
A & S-1/S-2 AS WELL AS B & S-1: NO SEPARATION REQUIRED
B & S-2 AS WELL AS R-2 & S-1/S-2: 1-HR FIRE BARRIER

SMITH DEVELOPMENT

660 UNIVERSITY
PALO ALTO, CA 94301



ISSUES AND REVISIONS		
NO.	DATE	DESCRIPTION
05.13.22		PLANNING RESUBMITTAL #1
08.15.22		PLANNING RESUBMITTAL #2
11.02.22		PLANNING RESUBMITTAL #3
08.28.23		PLANNING RESUBMITTAL #4
10.31.23		PLANNING RESUBMITTAL #5
12.21.23		PLANNING RESUBMITTAL #6
02.07.24		PLANNING RESUBMITTAL #7

PROJECT NUMBER
21003

SHEET TITLE
CODE & EGRESS COMPLIANCE

SCALE
1/16" = 1'-0"
0 16' 32'
PROJ. N TRUE N

SHEET NUMBER

A0.2A



ISSUES AND REVISIONS


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02.07.24		PLANNING RESUBMITTAL #7

PROJECT NUMBER
21003

SHEET TITLE
CODE & EGRESS COMPLIANCE

SCALE

1/16" = 1'-0"

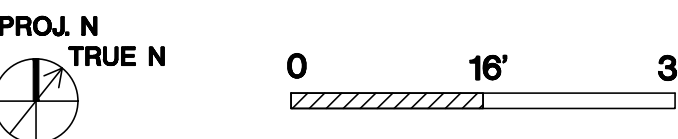

SHEET NUMBER

A0.2B

LEGEND

- A-3 ASSEMBLY AREA
- B BUSINESS & ACCESSORY AREA***
- R-2 RESIDENTIAL AREA
- S-1, S-2 STORAGE & PARKING AREAS
- EGRESS PATH OF TRAVEL
- ACCESSIBLE PATH OF TRAVEL (SEE 3/-)
- POINT OF DECISION (END OF COMMON PATH OF TRAVEL)
- RATED BUILDING ELEMENT (AS NOTED)
- * COMMON PATH OF EGRESS (CBC T 1006.2.1)
A, M = 75' MAX. (SPRINKLERED)
B, S = 100' MAX. (SPRINKLERED)
- ** EXIT ACCESS TRAVEL DISTANCE (CBC T 1017.2)
A, M, R, S-1 = 250' MAX. (SPRINKLERED)
B = 300' MAX. (SPRINKLERED)
S-2 = 400' MAX. (SPRINKLERED)

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SECOND FLOOR RESIDENTIAL OCCUPANCY CALCULATIONS:
RESIDENTIAL OCCUPANCY (13,224 SF TOTAL)
GROUPS R-2, S-1

CIRCULATION (2,094 SF) GROUP R-2 (1 OCC. / 200 SF)
2,094 / 200 = 11 OCCUPANTS
STORAGE (243 SF, ELEC. + TRASH ROOMS), GROUP S-1 (1 OCC. / 300 SF)
243 / 300 = 1 OCC.

22 RESIDENTIAL UNITS (10,879 SF), GROUP R-2 (1 OCC. / 200 SF)
10,879 / 200 = 55 OCC. (BY AREA) **USE SUB-CALC BELOW BY UNIT**

UNIT TYPE A1 (419 SF) W/ UNIQUE BALCONY (120 SF), TYP. OF 1
419 / 200 = 3 OCC. (INT) + 1 OCC. (EXT) = 4 OCC. TOTAL

UNIT TYPE A1/A3 (431 - 501 SF) W/O BALCONY, TYP. OF 3
501 / 200 = 3 OCC. (INT) = 3 OCC. EA / 9 TOTAL

UNIT TYPE A2 (448 - 455 SF) W/ BALCONY TYPE 1, TYP. OF 2
455 / 200 = 3 OCC. (INT) + 1 OCC. (EXT) = 4 OCC. / 8 TOTAL

UNIT TYPE B1/B2 (438 SF) W/ UNIQUE BALCONY (131 SF), TYP. OF 3
438 / 200 = 3 OCC. (INT) + 1 OCC. (EXT) = 4 OCC. EA / 12 TOTAL

UNIT TYPE B2/B3/B4 (450 - 468 SF) W/ BALCONY TYPE 2, TYP. OF 7
468 / 200 = 3 OCC. (INT) + 1 OCC. (EXT) = 4 OCC. EA / 28 TOTAL

UNIT TYPE C (399 SF) W/ BALCONY TYPE 2, TYP. OF 1
399 / 200 = 2 OCC. (INT) + 1 OCC. (EXT) = 3 OCC. TOTAL

UNIT TYPE D (611 SF) W/ BALCONY TYPE 1, TYP. OF 2
611 / 200 = 4 OCC. (INT) + 1 OCC. (EXT) = 5 OCC. EA / 10 TOTAL

UNIT TYPE E1 (842 SF) W/ BALCONY TYPE 1 + 2, TYP. OF 1
842 / 200 = 5 OCC. (INT) + 2 OCC. (EXT) = 7 OCC. TOTAL

UNIT TYPE E2 (576 SF) W/ BALCONY TYPE 1, TYP. OF 1
576 / 200 = 3 OCC. (INT) + 1 OCC. (EXT) = 4 OCC. TOTAL

UNIT TYPE G (655 SF) W/ (2) BALCONY TYPE 2, TYP. OF 1
655 / 200 = 4 OCC. (INT) + 2 (EXT) = 6 OCC. TOTAL

SUBTOTAL UNIT OCCUPANTS: 91

BALCONY CALCULATIONS, INCLUDED IN COUNTS ABOVE
CALCULATED AT 1,200 SF AS ACCESSORY TO PRIVATE RESIDENTIAL AREA:
6 TYPE 1 BALCONIES 60 SF EA. / 200 = 1 OCC. EA.
10 TYPE 2 BALCONIES 66 SF EA. / 200 = 1 OCC. EA.
5 UNIQUE BALCONIES 131 SF MAX. EA. / 200 = 1 OCC. EA.

103 TOTAL RESIDENTIAL OCCUPANTS
(2 EXITS REQUIRED / PROVIDED)

RESIDENTIAL EGRESS (DOOR) WIDTH: 103 X 0.2 = 20.6" MIN. REQ.
2 DOORS (EXITS R1 & R2) @ 32" MIN. CLR. EA. (64" TOTAL) PROV.

RESIDENTIAL STAIR WIDTH: 103 X 0.3 = 30.9" MIN. REQ.
2 STAIRS (EXITS R1 & R2) @ 50" MIN. CLR. EA. (100" TOTAL) PROV.

THIRD FLOOR RESIDENTIAL OCCUPANCY CALCULATIONS:
RESIDENTIAL OCCUPANCY (13,324 SF TOTAL)
GROUPS R-2, S-1

CIRCULATION (2,094 SF) GROUP R-2 (1 OCC. / 200 SF)
2,094 / 200 = 11 OCCUPANTS
STORAGE (243 SF, ELEC. + TRASH ROOMS), GROUP S-1 (1 OCC. / 300 SF)
243 / 300 = 1 OCC.

22 RESIDENTIAL UNITS (10,986 SF), GROUP R-2 (1 OCC. / 200 SF)
10,986 / 200 = 55 OCC. (BY AREA) **USE SUB-CALC BELOW BY UNIT**

UNIT TYPE A1/A2 (419 - 475 SF) W/ BALCONY TYPE 1, TYP. OF 5
419 / 200 = 3 OCC. (INT) + 1 OCC. (EXT) = 4 OCC. / 20 TOTAL

UNIT TYPE A3 (521 SF) W/ BALCONY TYPE 1, TYP. OF 1
501 / 200 = 3 OCC. (INT) + 1 OCC. (EXT) = 4 OCC. TOTAL

UNIT TYPE B1/B2/B3/B4 (438 - 468 SF) W/ BALCONY TYPE 2, TYP. OF 10
468 / 200 = 3 OCC. (INT) + 1 OCC. (EXT) = 4 OCC. EA / 40 TOTAL

UNIT TYPE C (399 SF) W/ BALCONY TYPE 2, TYP. OF 1
399 / 200 = 2 OCC. (INT) + 1 OCC. (EXT) = 3 OCC. TOTAL

UNIT TYPE D (611 SF) W/ BALCONY TYPE 1, TYP. OF 2
611 / 200 = 4 OCC. (INT) + 1 OCC. (EXT) = 5 OCC. EA / 10 TOTAL

UNIT TYPE E1 (842 SF) W/ BALCONY TYPE 1 + 2, TYP. OF 1
842 / 200 = 5 OCC. (INT) + 2 OCC. (EXT) = 7 OCC. TOTAL

UNIT TYPE E2 (576 SF) W/ BALCONY TYPE 1, TYP. OF 1
576 / 200 = 3 OCC. (INT) + 1 OCC. (EXT) = 4 OCC. TOTAL

UNIT TYPE G (655 SF) W/ (2) BALCONY TYPE 2, TYP. OF 1
655 / 200 = 4 OCC. (INT) + 2 (EXT) = 6 OCC. TOTAL

SUBTOTAL UNIT OCCUPANTS: 94


BALCONY CALCULATIONS, INCLUDED IN COUNTS ABOVE
CALCULATED AT 1,200 SF AS ACCESSORY TO PRIVATE RESIDENTIAL AREA:
10 TYPE 1 BALCONIES 60 SF EA. / 200 = 1 OCC. EA.
14 TYPE 2 BALCONIES 66 SF EA. / 200 = 1 OCC. EA.

106 TOTAL RESIDENTIAL OCCUPANTS
(2 EXITS REQUIRED / PROVIDED)


RESIDENTIAL EGRESS (DOOR) WIDTH: 106 X 0.2 = 21.2" MIN. REQ.
2 DOORS (EXITS R1 & R2) @ 32" MIN. CLR. EA. (64" TOTAL) PROV.

RESIDENTIAL STAIR WIDTH: 106 X 0.3 = 31.8" MIN. REQ.
2 STAIRS (EXITS R1 & R2) @ 50" MIN. CLR. EA. (100" TOTAL) PROV.


3 THIRD FLOOR EGRESS PLAN
1/16"=1'-0"

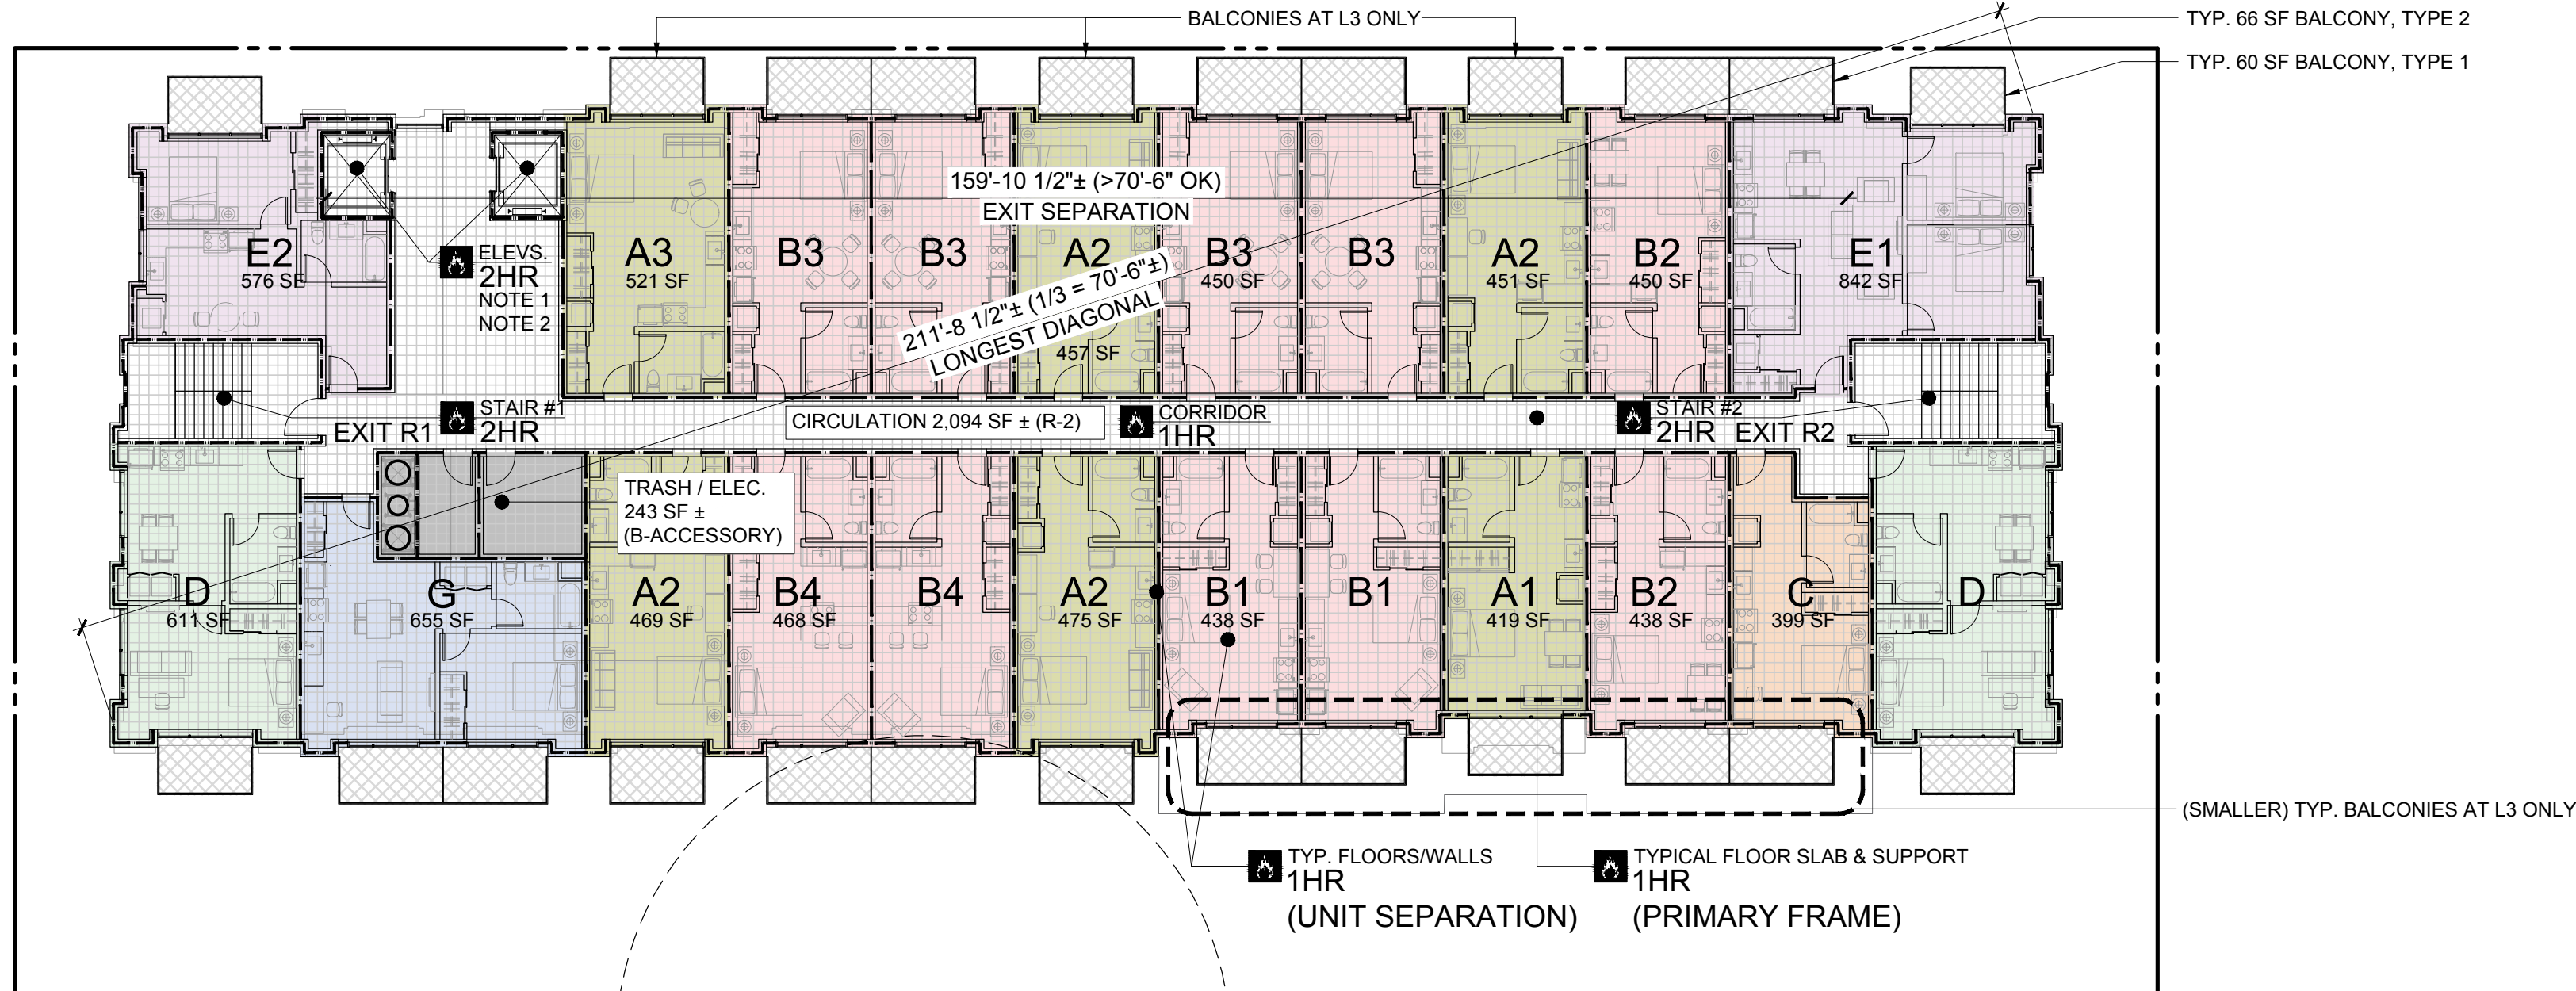

2 SECOND FLOOR EGRESS PLAN
1/16"=1'-0"

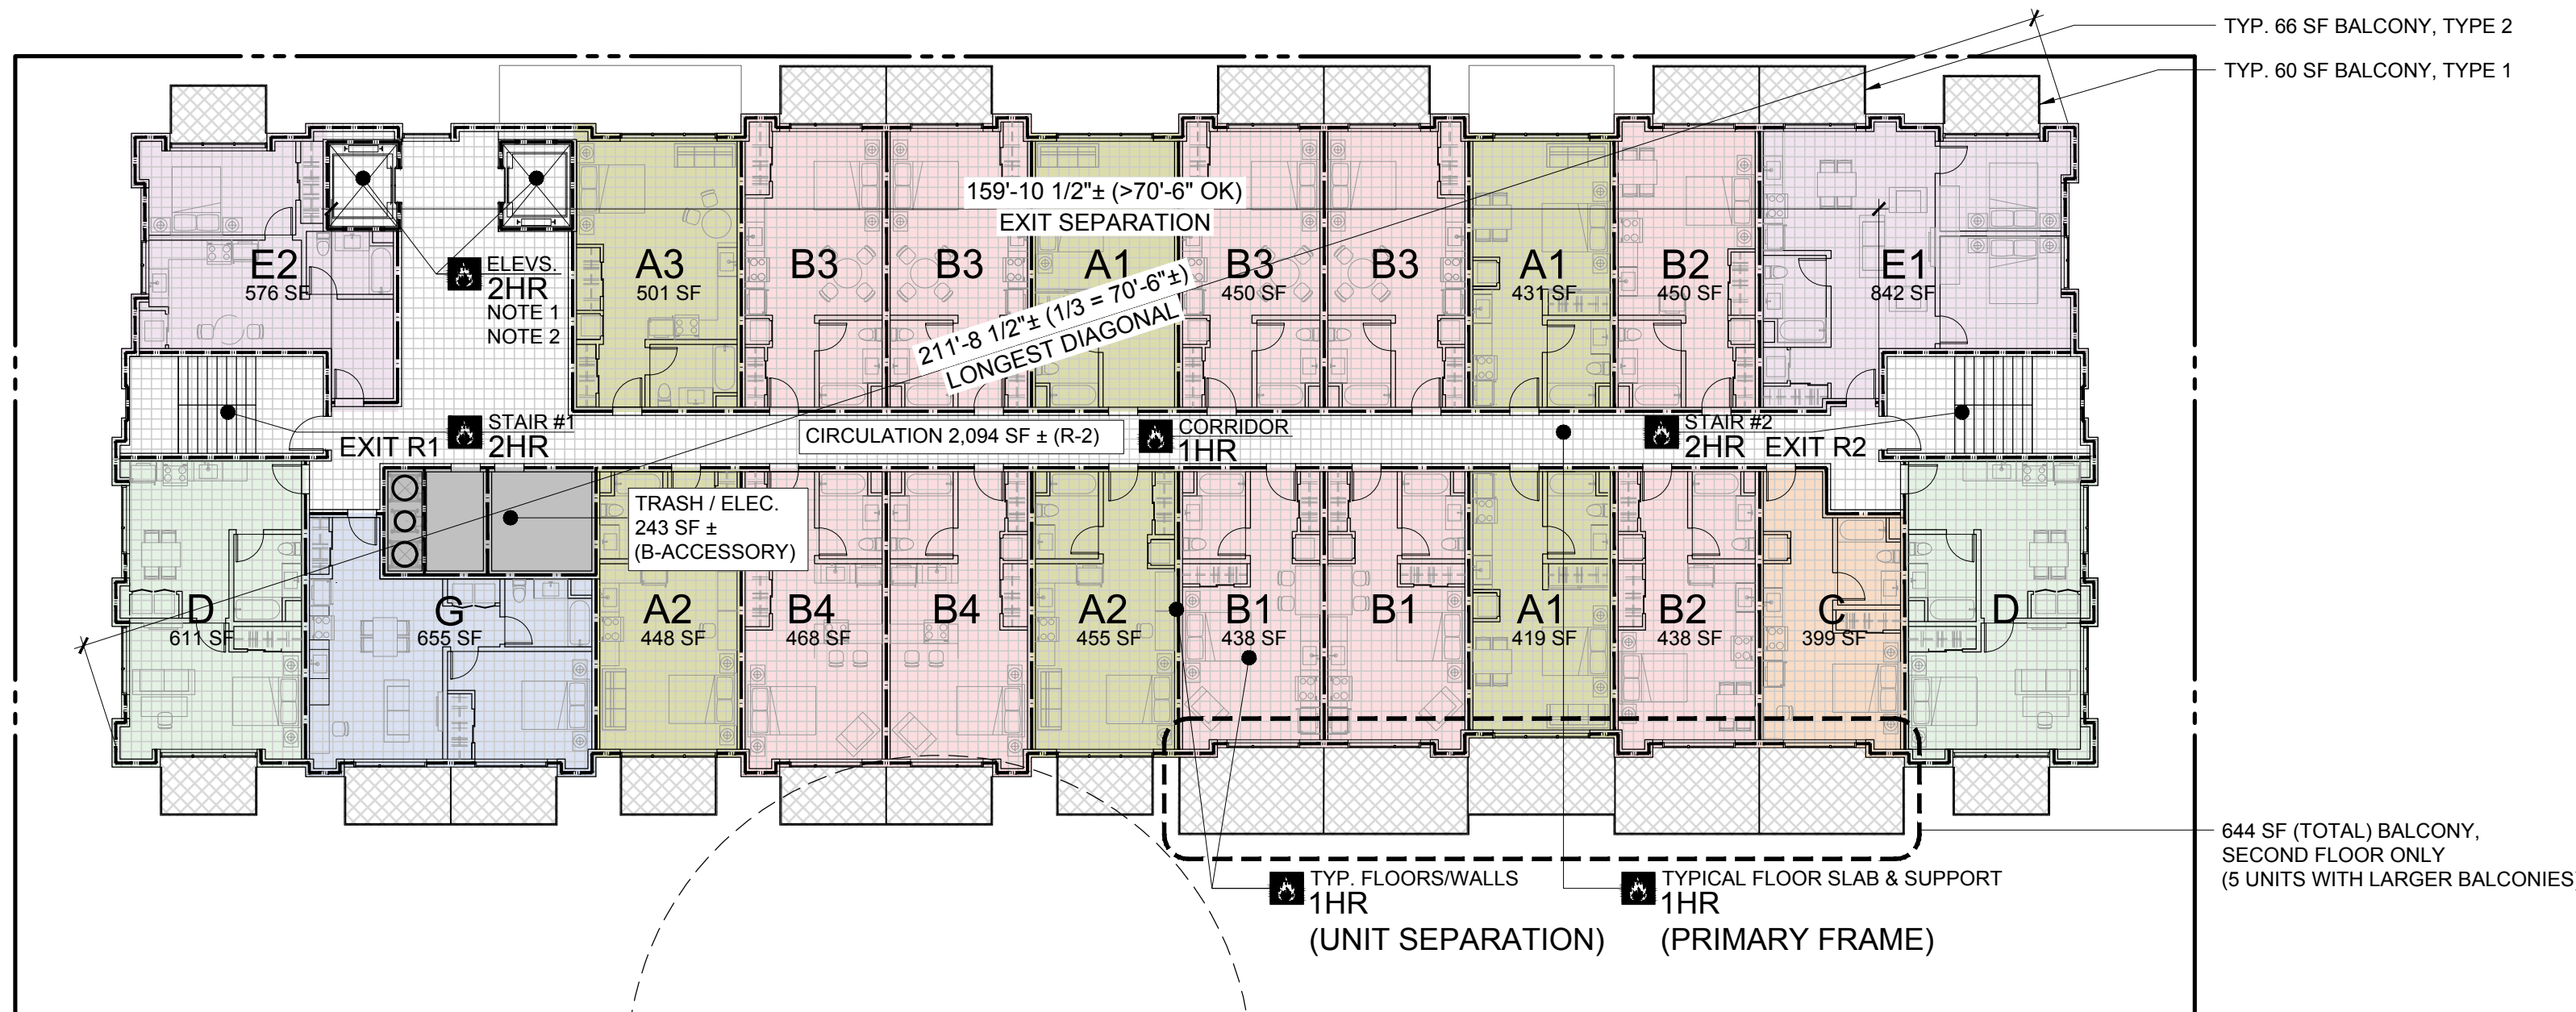

1 PARKING P2 LEVEL EGRESS PLAN (P1 LEVEL SIM)
1/16"=1'-0"

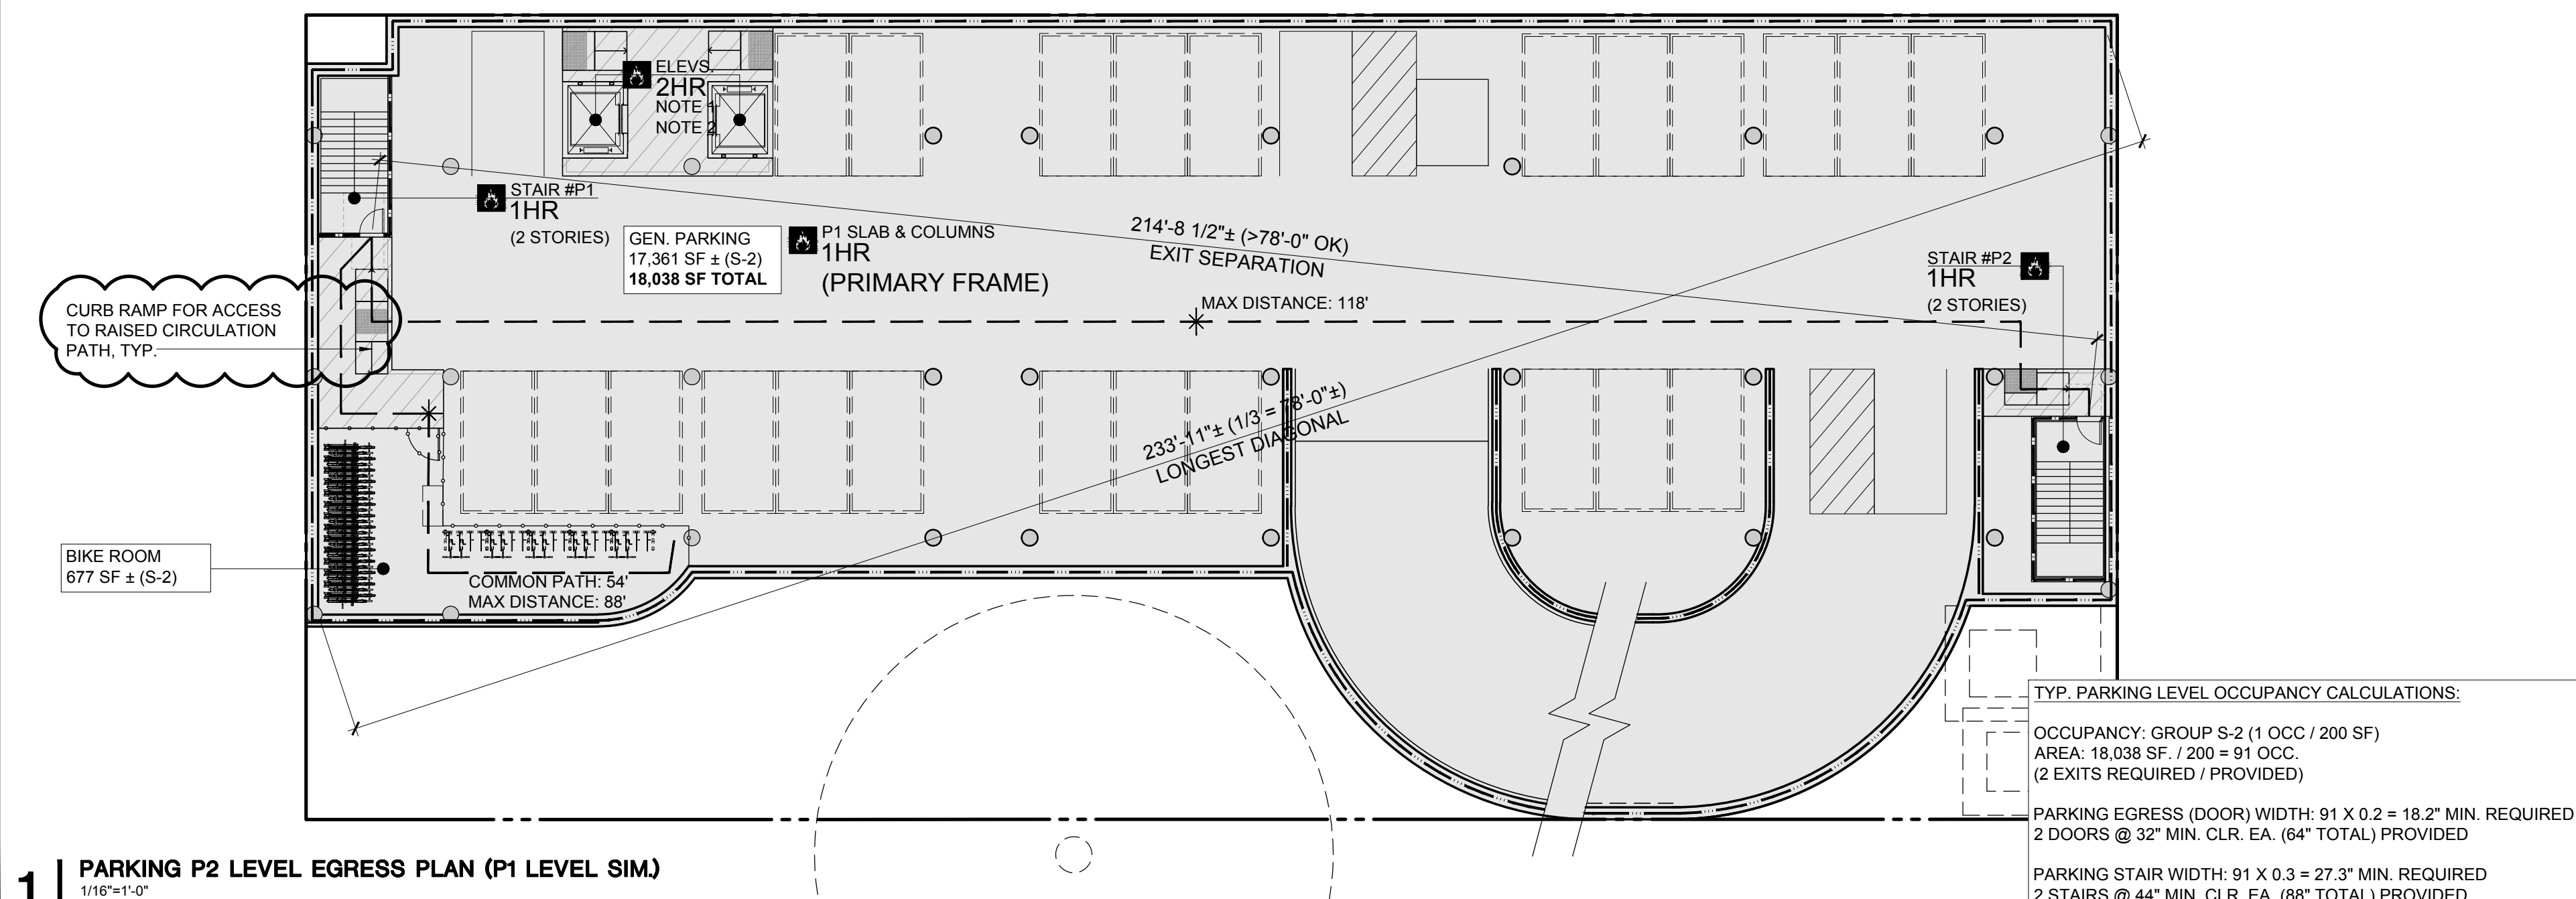



ARCHITECTS
KORTH SUNSERI HAGEY

ISSUES AND REVISIONS


NO.	DATE	DESCRIPTION
05.13.22		PLANNING RESUBMITTAL #1
08.15.22		PLANNING RESUBMITTAL #2
11.02.22		PLANNING RESUBMITTAL #3
08.28.23		PLANNING RESUBMITTAL #4
10.31.23		PLANNING RESUBMITTAL #5
12.21.23		PLANNING RESUBMITTAL #6
02.07.24		PLANNING RESUBMITTAL #7

PROJECT NUMBER
21003

SHEET TITLE

CODE & EGRESS COMPLIANCE

SCALE

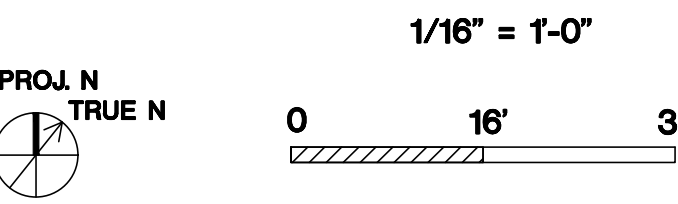

SHEET NUMBER

A0.2C

LEGEND

- A-3 ASSEMBLY AREA
- B BUSINESS & ACCESSORY AREA***
- R-2 RESIDENTIAL AREA
- S-1, S-2 STORAGE & PARKING AREAS
- EGRESS PATH OF TRAVEL
- ACCESSIBLE PATH OF TRAVEL (SEE 3/-)
- POINT OF DECISION (END OF COMMON PATH OF TRAVEL)
- RATED BUILDING ELEMENT (AS NOTED)
- * COMMON PATH OF EGRESS (CBC T 1006.2.1)
A, M = 75' MAX. (SPRINKLERED)
B, S = 100' MAX. (SPRINKLERED)
- ** EXIT ACCESS TRAVEL DISTANCE (CBC T 1017.2)
A, M, R, S-1 = 250' MAX. (SPRINKLERED)
B = 300' MAX. (SPRINKLERED)
S-2 = 400' MAX. (SPRINKLERED)

*** ACCESSORY OCCUPANCIES
PER CBC 908.2, ACCESSORY OCCUPANCIES SHALL BE INDIVIDUALLY CLASSIFIED BUT ARE NOT REQUIRED TO BE SEPARATED (EXCEPT R-2 DWELLINGS ARE TO BE SEPARATED FROM EACH OTHER AS WELL AS CONTIGUOUS ACCESSORY SPACE, I.E. CORRIDORS). IN ADDITION, PER CBC 303.1.2, A ROOM OR SPACE THAT IS LESS THAN 750 SF AND/OR HAS AN OCCUPANT LOAD OF LESS THAN 50 SHALL BE CLASSIFIED AS B-OCCUPANCY OR AS A PART OF THAT OCCUPANCY WITH WHICH IT IS ASSOCIATED.

NOTE 1: ELEVATORS TO BE PROVIDED WITH SMOKE DOORS OR A SMOKEPROOF LOBBY (TYP. ALL FLOORS EXCEPT FIRST FLOOR)

NOTE 2: (1) RESIDENTIAL ELEVATOR (SERVING FLOORS P2 THROUGH ROOF) TO BE PROVIDED WITH STAND-BY POWER PER CBC 1009.4.1 AS REQUIRED TO PROVIDE AN ACCESSIBLE MEANS OF EGRESS

ROOF OCCUPANCY CALCULATIONS:

RESIDENTIAL ROOF OCCUPANCY (6,007 SF TOTAL INTERIOR/ENCL. + 3,189 SF EXT.), GROUPS A-2/A-3, B-ACCESSORY, S-1 ACCESSORY

PENTHOUSE/STAIR AREA (450 SF + 608 SF = 958 SF)
(1 OCC. / 150 SF) GROUP B-ACCESSORY
SUB AREA: 958 SF. / 150 = 7 OCC.

HVAC / ENCLOSURE AREA (2,855 SF + 334 SF + 407 SF = 3,596 SF)
407 SF PLUMBING EQUIP. ROOM TREATED AS ENCLOSED AREA
(1 OCC. / 300 SF) GROUP S-1
SUB AREA: 3,596 SF. / 300 = 12 OCC.

EXTERIOR TERRACE (4,642 SF), TREATED AS ENCLOSED AREA
(1 OCC. / 15 SF) GROUP A-3
4,642 SF. / 15 = 310 OCC. (2 EXITS REQUIRED / PROVIDED)

329 TOTAL OCCUPANTS
(2 EXITS REQUIRED / PROVIDED)

ROOF EGRESS (DOOR) WIDTH: 329 X 0.2 = 65.8' MIN. REQ.
2 DOORS (EXITS R1 & R2) @ 34" MIN. CLR. EA. (68" TOTAL) PROV.

ROOF STAIR WIDTH: 329 X 0.3 = 98.7' MIN. REQ.
2 STAIRS (EXITS R1 & R2) @ 50" MIN. CLR. EA. (100" TOTAL) PROV.

THIRD FLOOR RESIDENTIAL OCCUPANCY CALCULATIONS:

RESIDENTIAL OCCUPANCY (11,840 SF TOTAL)
GROUPS R-2, S-1

CIRCULATION (2,053 SF) GROUP R-2 (1 OCC. / 200 SF)
2,053 / 200 = 11 OCCUPANTS

STORAGE (243 SF, ELEC. + TRASH ROOMS), GROUP S-1 (1 OCC. / 300 SF)
243 / 300 = 1 OCC.

19 RESIDENTIAL UNITS (9,612 SF), GROUP R-2 (1 OCC. / 200 SF)
9,612 / 200 = 49 OCC. (BY AREA) USE SUB-CALC BELOW BY UNIT

UNIT TYPE A1 (451 - 475 SF) W/ BALCONY TYPE 1, TYP. OF 4
475 / 200 = 3 OCC. (INT) + 1 OCC. (EXT) = 4 OCC. / 16 TOTAL

UNIT TYPE A3 (521 SF) W/ BALCONY TYPE 1, TYP. OF 1
501 / 200 = 3 OCC. (INT) + 1 OCC. (EXT) = 4 OCC. TOTAL

UNIT TYPE B1/B2 (425 - 443 SF) W/O BALCONY, TYP. OF 5
443 / 200 = 3 OCC. (INT) = 3 OCC. EA. / 15 TOTAL

UNIT TYPE B3 (444 SF) W/ BALCONY TYPE 2, TYP. OF 2
444 / 200 = 3 OCC. (INT) + 1 OCC. (EXT) = 4 OCC. EA. / 8 TOTAL

UNIT TYPE B4 (468 - 475 SF) W/ BALCONY TYPE 1, TYP. OF 2
475 / 200 = 3 OCC. (INT) + 1 OCC. (EXT) = 4 OCC. EA. / 8 TOTAL

UNIT TYPE D (611 SF) W/ BALCONY TYPE 1, TYP. OF 1
611 / 200 = 4 OCC. (INT) + 1 OCC. (EXT) = 5 OCC. TOTAL

UNIT TYPE E1 (842 SF) W/ BALCONY TYPE 1, TYP. OF 1
842 / 200 = 5 OCC. (INT) + 1 OCC. (EXT) = 6 OCC. TOTAL

UNIT TYPE E2 (576 SF) W/ BALCONY TYPE 1, TYP. OF 1
576 / 200 = 3 OCC. (INT) + 1 OCC. (EXT) = 4 OCC. TOTAL

UNIT TYPE F1 (464 SF) W/ UNIQUE BALCONY (435 SF), TYP. OF 1
464 / 200 = 3 OCC. (INT) + 3 OCC. (EXT) = 6 OCC. TOTAL

UNIT TYPE F1 (489 SF) W/ UNIQUE BALCONY (378 SF), TYP. OF 1
489 / 200 = 3 OCC. (INT) + 2 OCC. (EXT) = 5 OCC. TOTAL

UNIT TYPE F2 (592 SF) W/ UNIQUE BALCONY (490 SF), TYP. OF 1
592 / 200 = 3 OCC. (INT) + 3 OCC. (EXT) = 6 OCC. TOTAL

UNIT TYPE G (655 SF) W/ (2) BALCONY TYPE 2, TYP. OF 1
655 / 200 = 4 OCC. (INT) + 2 OCC. (EXT) = 6 OCC. TOTAL
SUBTOTAL UNIT OCCUPANTS: 89


BALCONY CALCULATIONS, INCLUDED IN COUNTS ABOVE
CALCULATED AT 1/200 SF AS ACCESSORY TO PRIVATE RESIDENTIAL AREA:
8 TYPE 1 BALCONIES 60 SF EA. / 200 = 1 OCC. EA.
4 TYPE 2 BALCONIES 66 SF EA. / 200 = 1 OCC. EA.
1 UNIT F1 BALCONY @ 435 SF / 200 = 3 OCC.
1 UNIT F1 BALCONY @ 378 SF / 200 = 2 OCC.
1 UNIT F2 BALCONY @ 490 SF / 200 = 3 OCC.

101 TOTAL RESIDENTIAL OCCUPANTS
(2 EXITS REQUIRED / PROVIDED)


RESIDENTIAL EGRESS (DOOR) WIDTH: 101 X 0.2 = 20.2' MIN. REQ.
2 DOORS (EXITS R1 & R2) @ 32" MIN. CLR. EA. (64" TOTAL) PROV.

RESIDENTIAL STAIR WIDTH: 101 X 0.3 = 30.3' MIN. REQ.
2 STAIRS (EXITS R1 & R2) @ 50" MIN. CLR. EA. (100" TOTAL) PROV.

2 ROOF / TERRACE EGRESS PLAN
1/16"=1'-0"

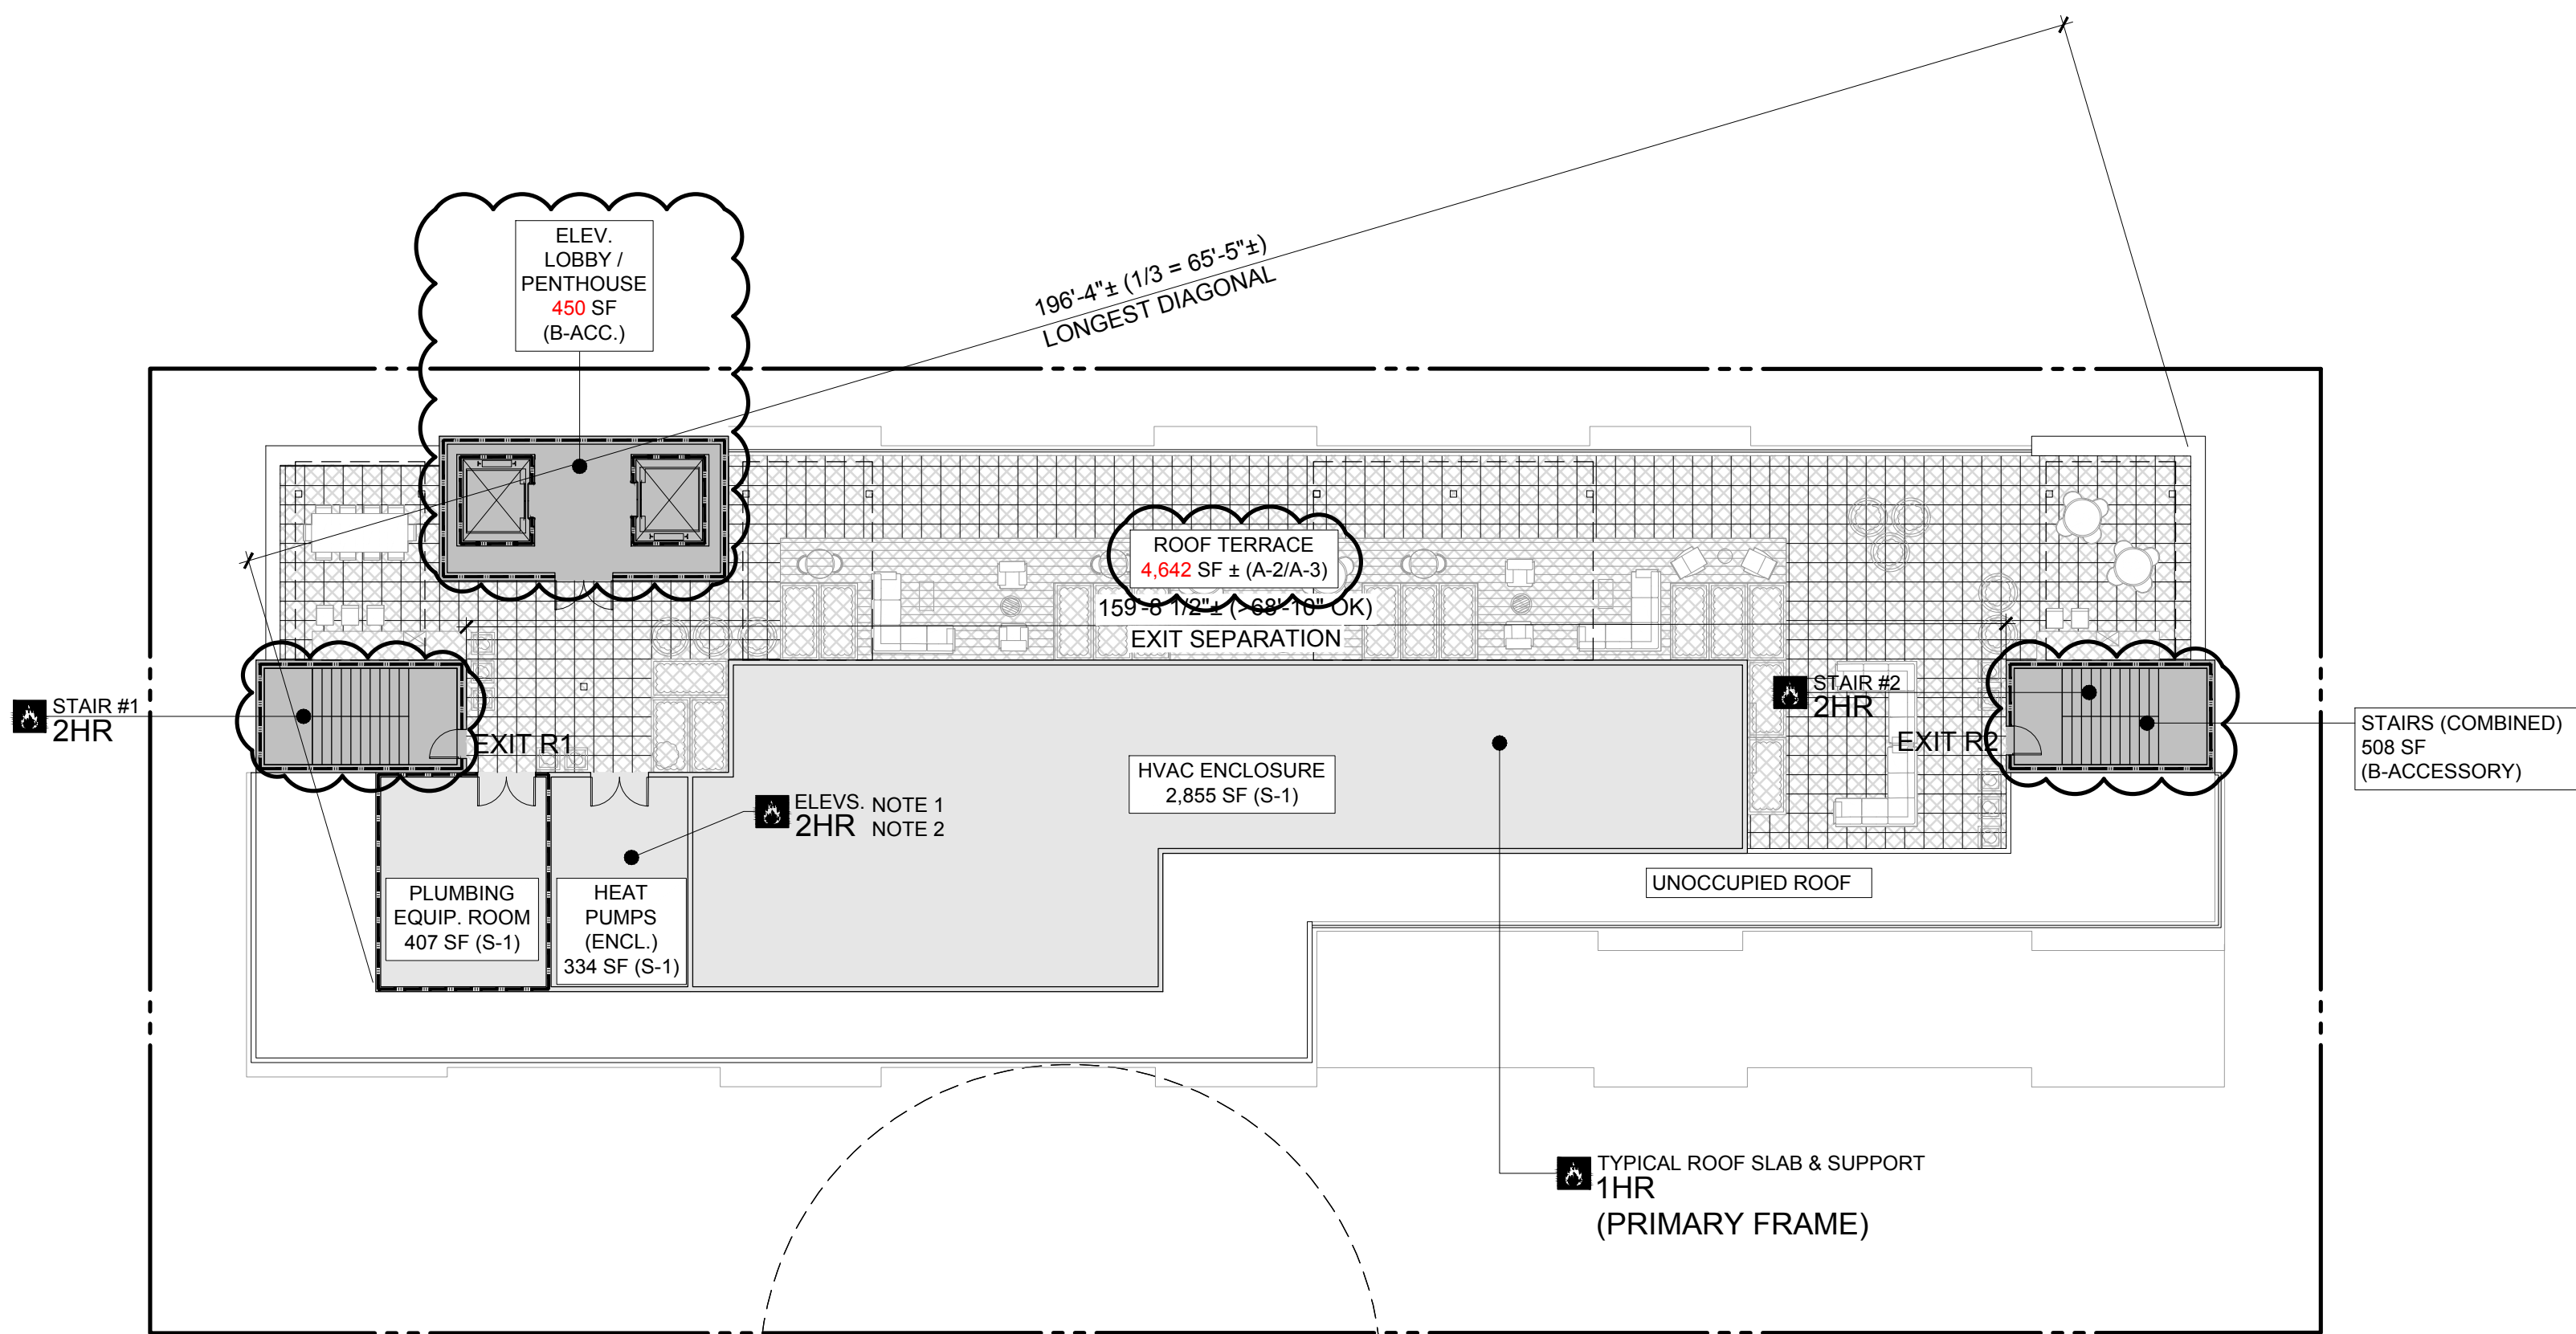

1 FOURTH FLOOR EGRESS PLAN
1/16"=1'-0"

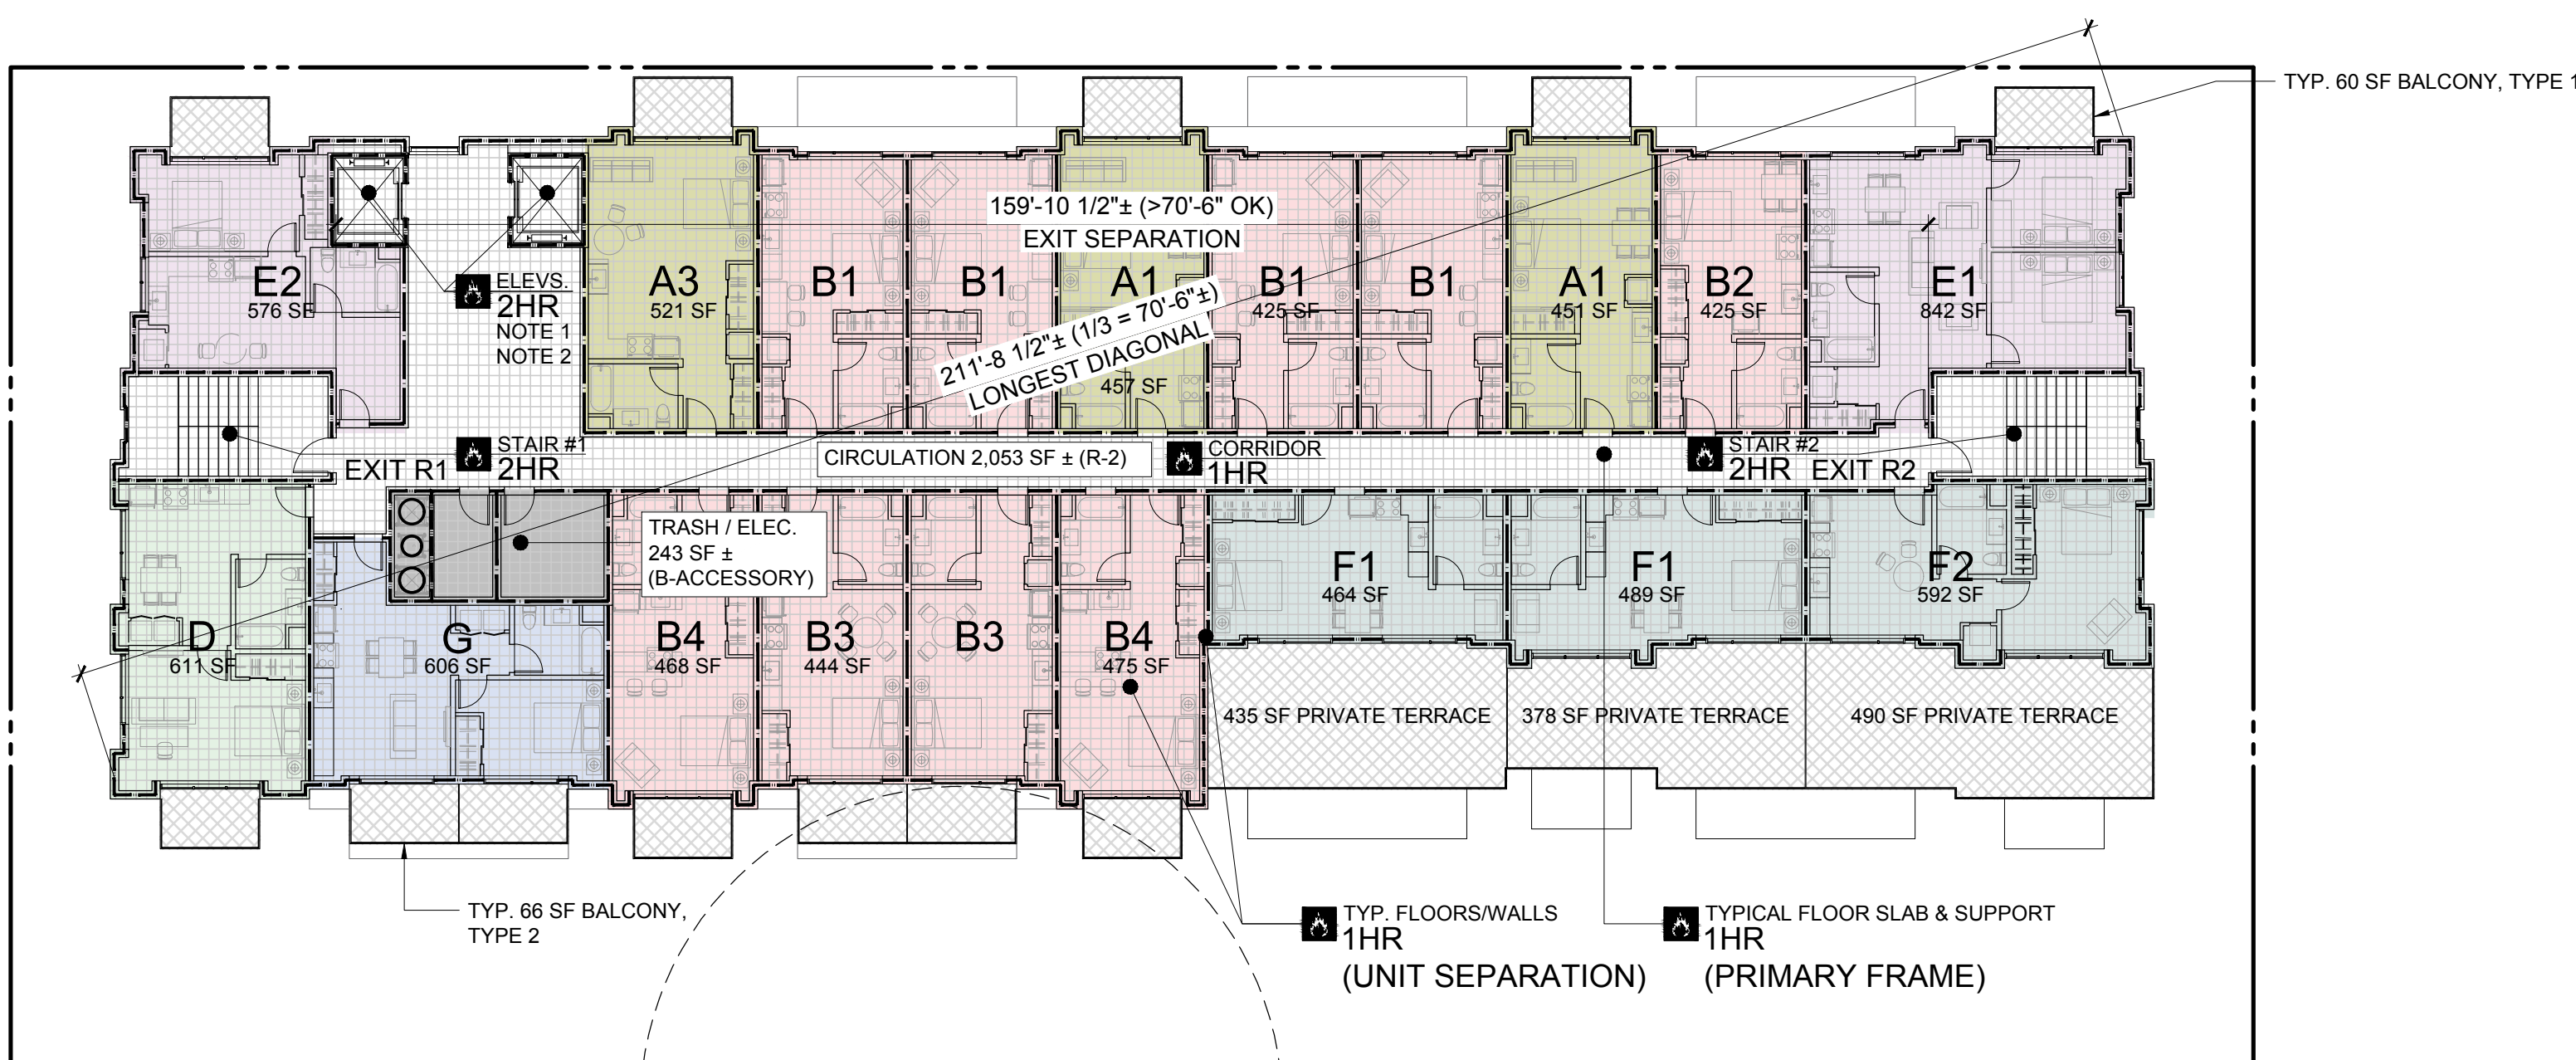




KEY PLAN
N.T.S.



1 VIEW TO OAK TREE FROM BYRON AVE
N.T.S.

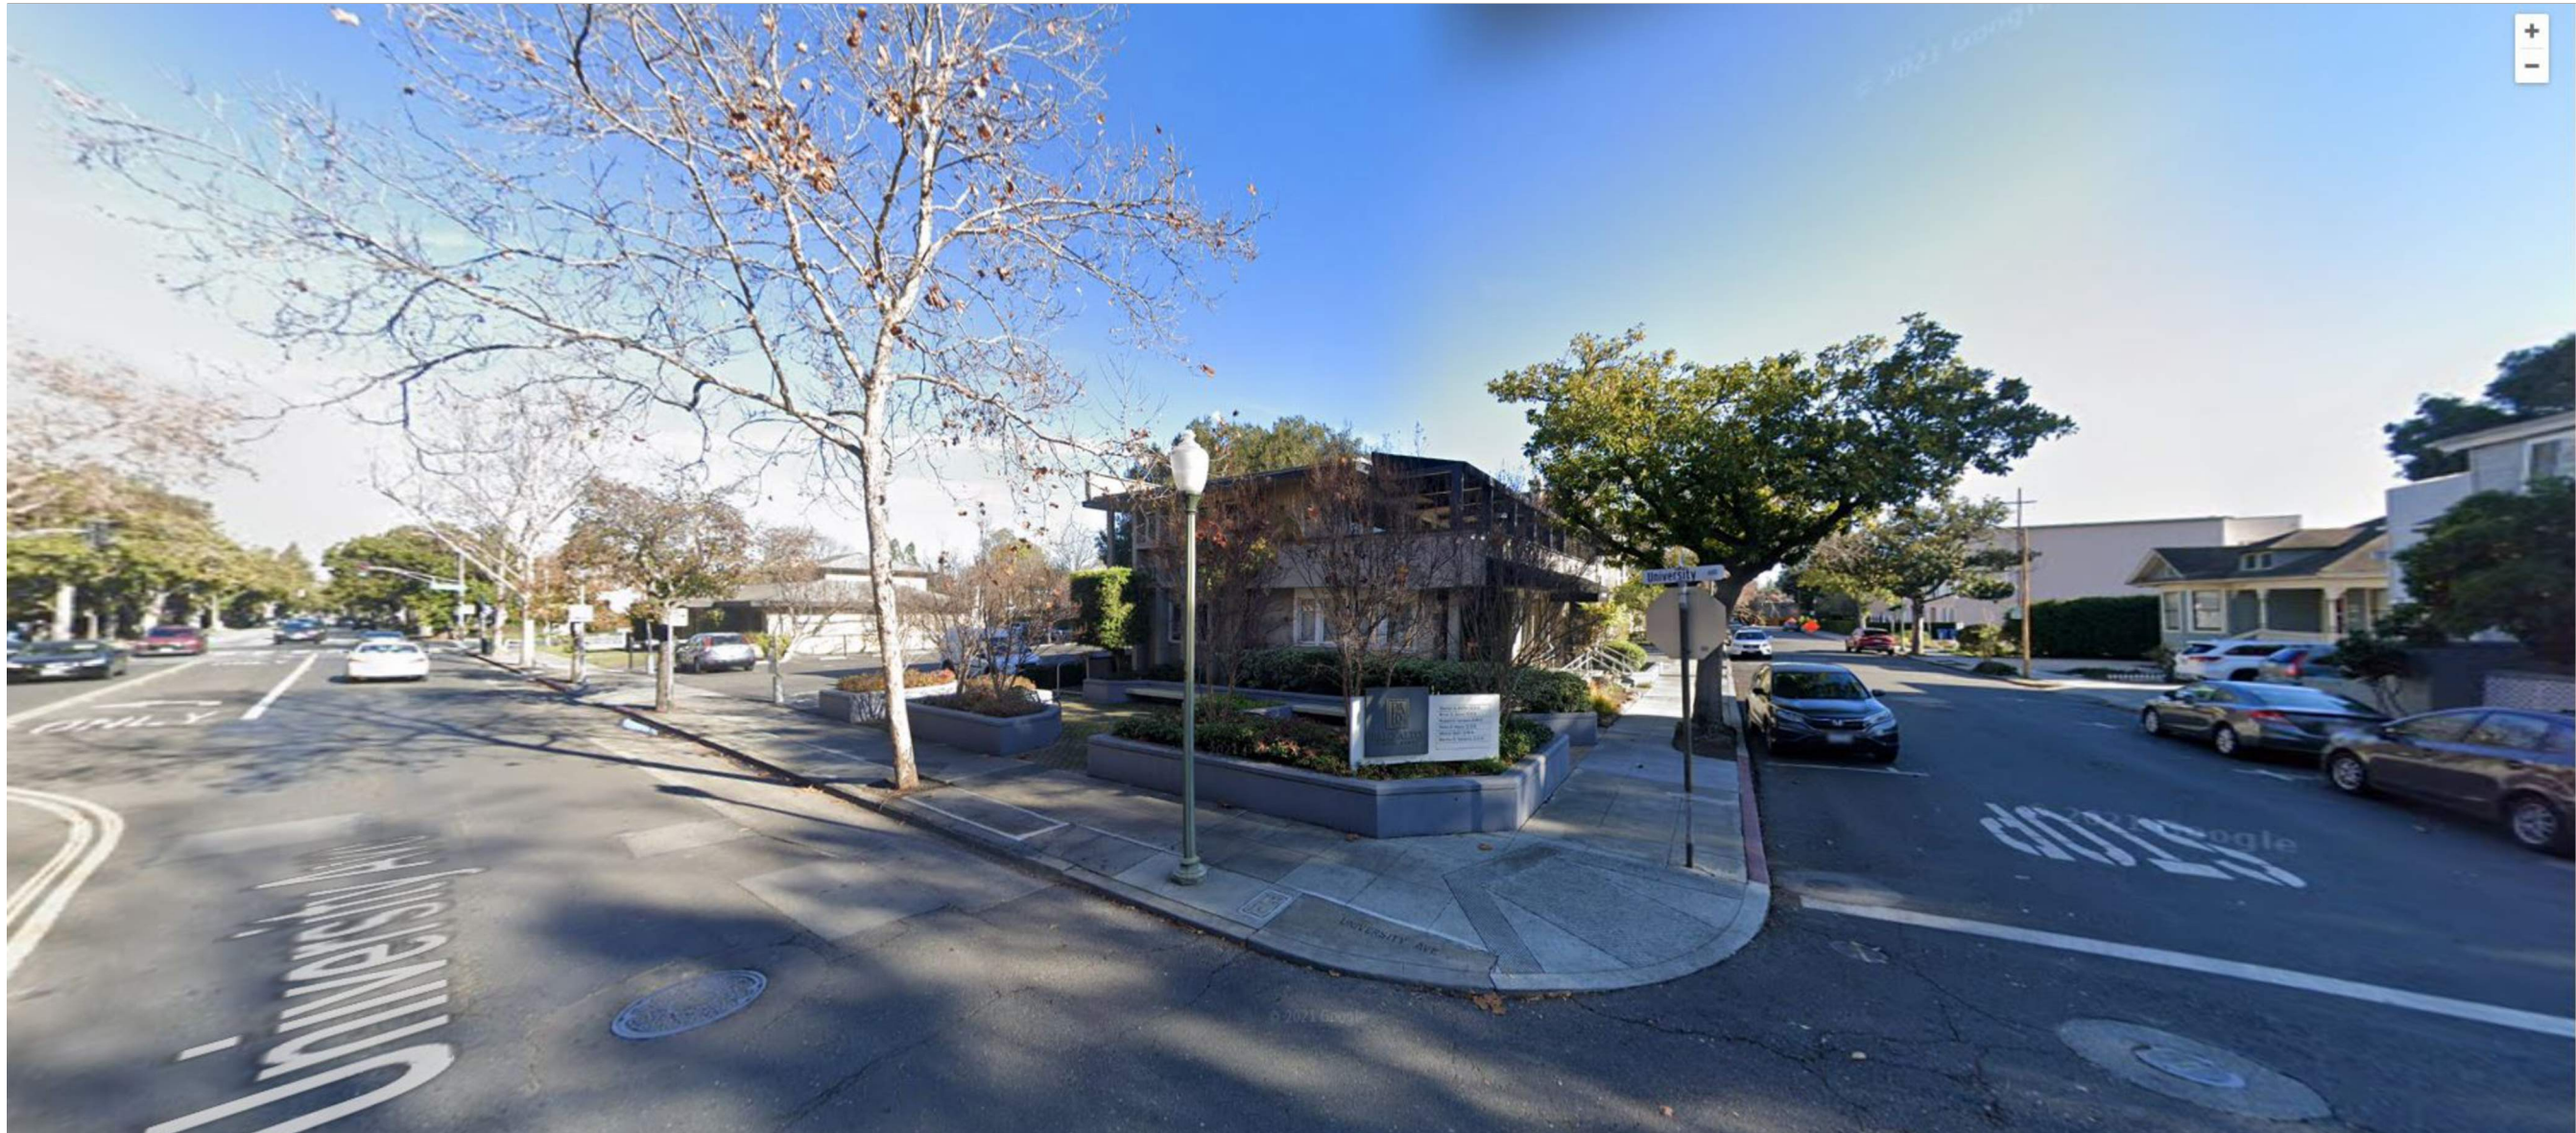

2 CORNER OF UNIVERSITY AVE & BYRON AVE
N.T.S.



3 VIEW OF OAK TREE FROM UNIVERSITY AVE
N.T.S.



4 CORNER OF MIDDLEFIELD ROAD & UNIVERSITY AVE
N.T.S.



5 VIEW TOWARDS SITE FROM MIDDLEFIELD ROAD
N.T.S.

SMITH DEVELOPMENT

660 UNIVERSITY
PALO ALTO, CA 94301



ARCHITECTS
KORTH SUNSERI HAGEY

ISSUES AND REVISIONS		
NO.	DATE	DESCRIPTION
	11.24.21	PLANNING SUBMITTAL
	05.13.22	PLANNING RESUBMITTAL #1
	08.15.22	PLANNING RESUBMITTAL #2
	11.02.22	PLANNING RESUBMITTAL #3
	08.28.23	PLANNING RESUBMITTAL #4
	10.31.23	PLANNING RESUBMITTAL #5
	12.21.23	PLANNING RESUBMITTAL #6
	02.07.24	PLANNING RESUBMITTAL #7


PROJECT NUMBER
21003

SHEET TITLE

EXISTING SITE PHOTOS

SCALE

N.T.S.

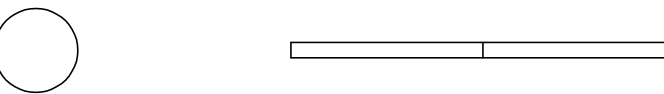

SHEET NUMBER

A0.3



ISSUES AND REVISIONS		
NO.	DATE	DESCRIPTION
12.01.21		PLANNING SUBMITTAL
05.13.22		PLANNING RESUBMITTAL #1
08.15.22		PLANNING RESUBMITTAL #2
11.02.22		PLANNING RESUBMITTAL #3
08.28.23		PLANNING RESUBMITTAL #4
10.31.23		PLANNING RESUBMITTAL #5
12.21.23		PLANNING RESUBMITTAL #6
02.07.24		PLANNING RESUBMITTAL #7

PROJECT NUMBER
21003

SHEET TITLE
**EXISTING
SITE PLAN**


SCALE
1/16" = 1'-0"



0 16' 32'

SHEET NUMBER

A1.0

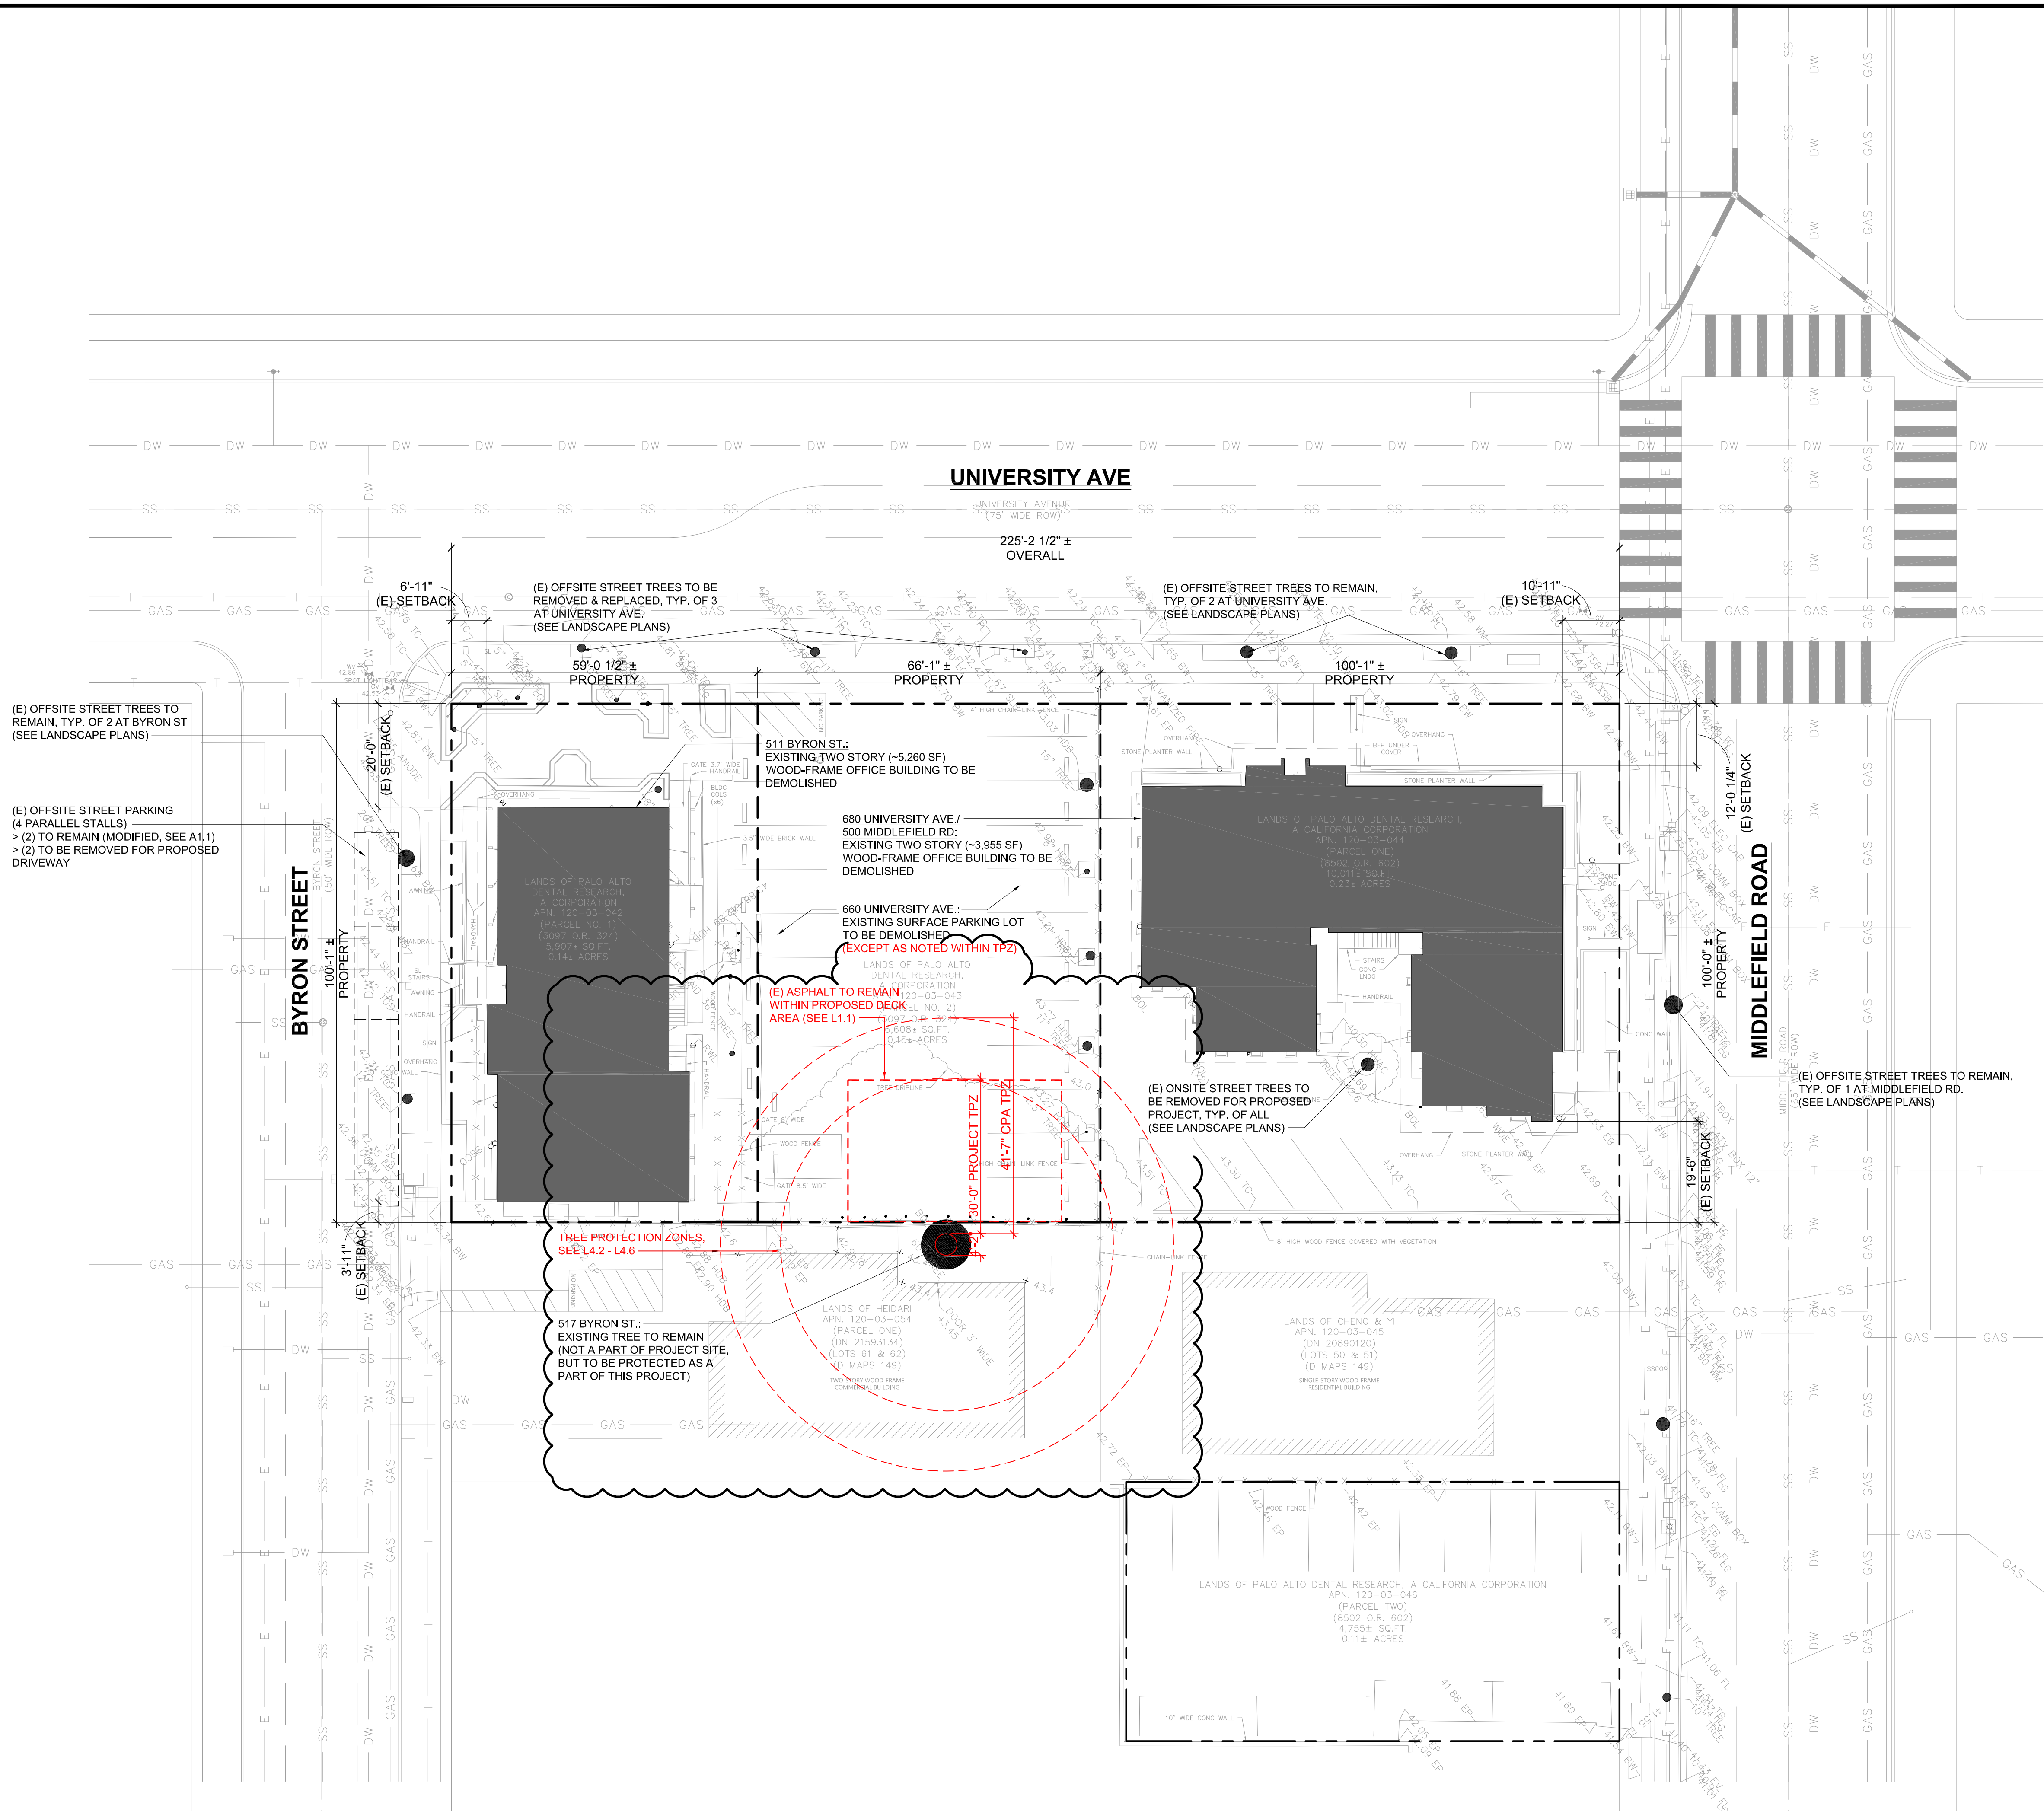

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PROJECT NUMBER
21003

SHEET TITLE

**PROPOSED
SITE PLAN**

SCALE


1/16" = 1'-0"



SHEET NUMBER

A1.1

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MIDDLEFIELD RD SETBACKS

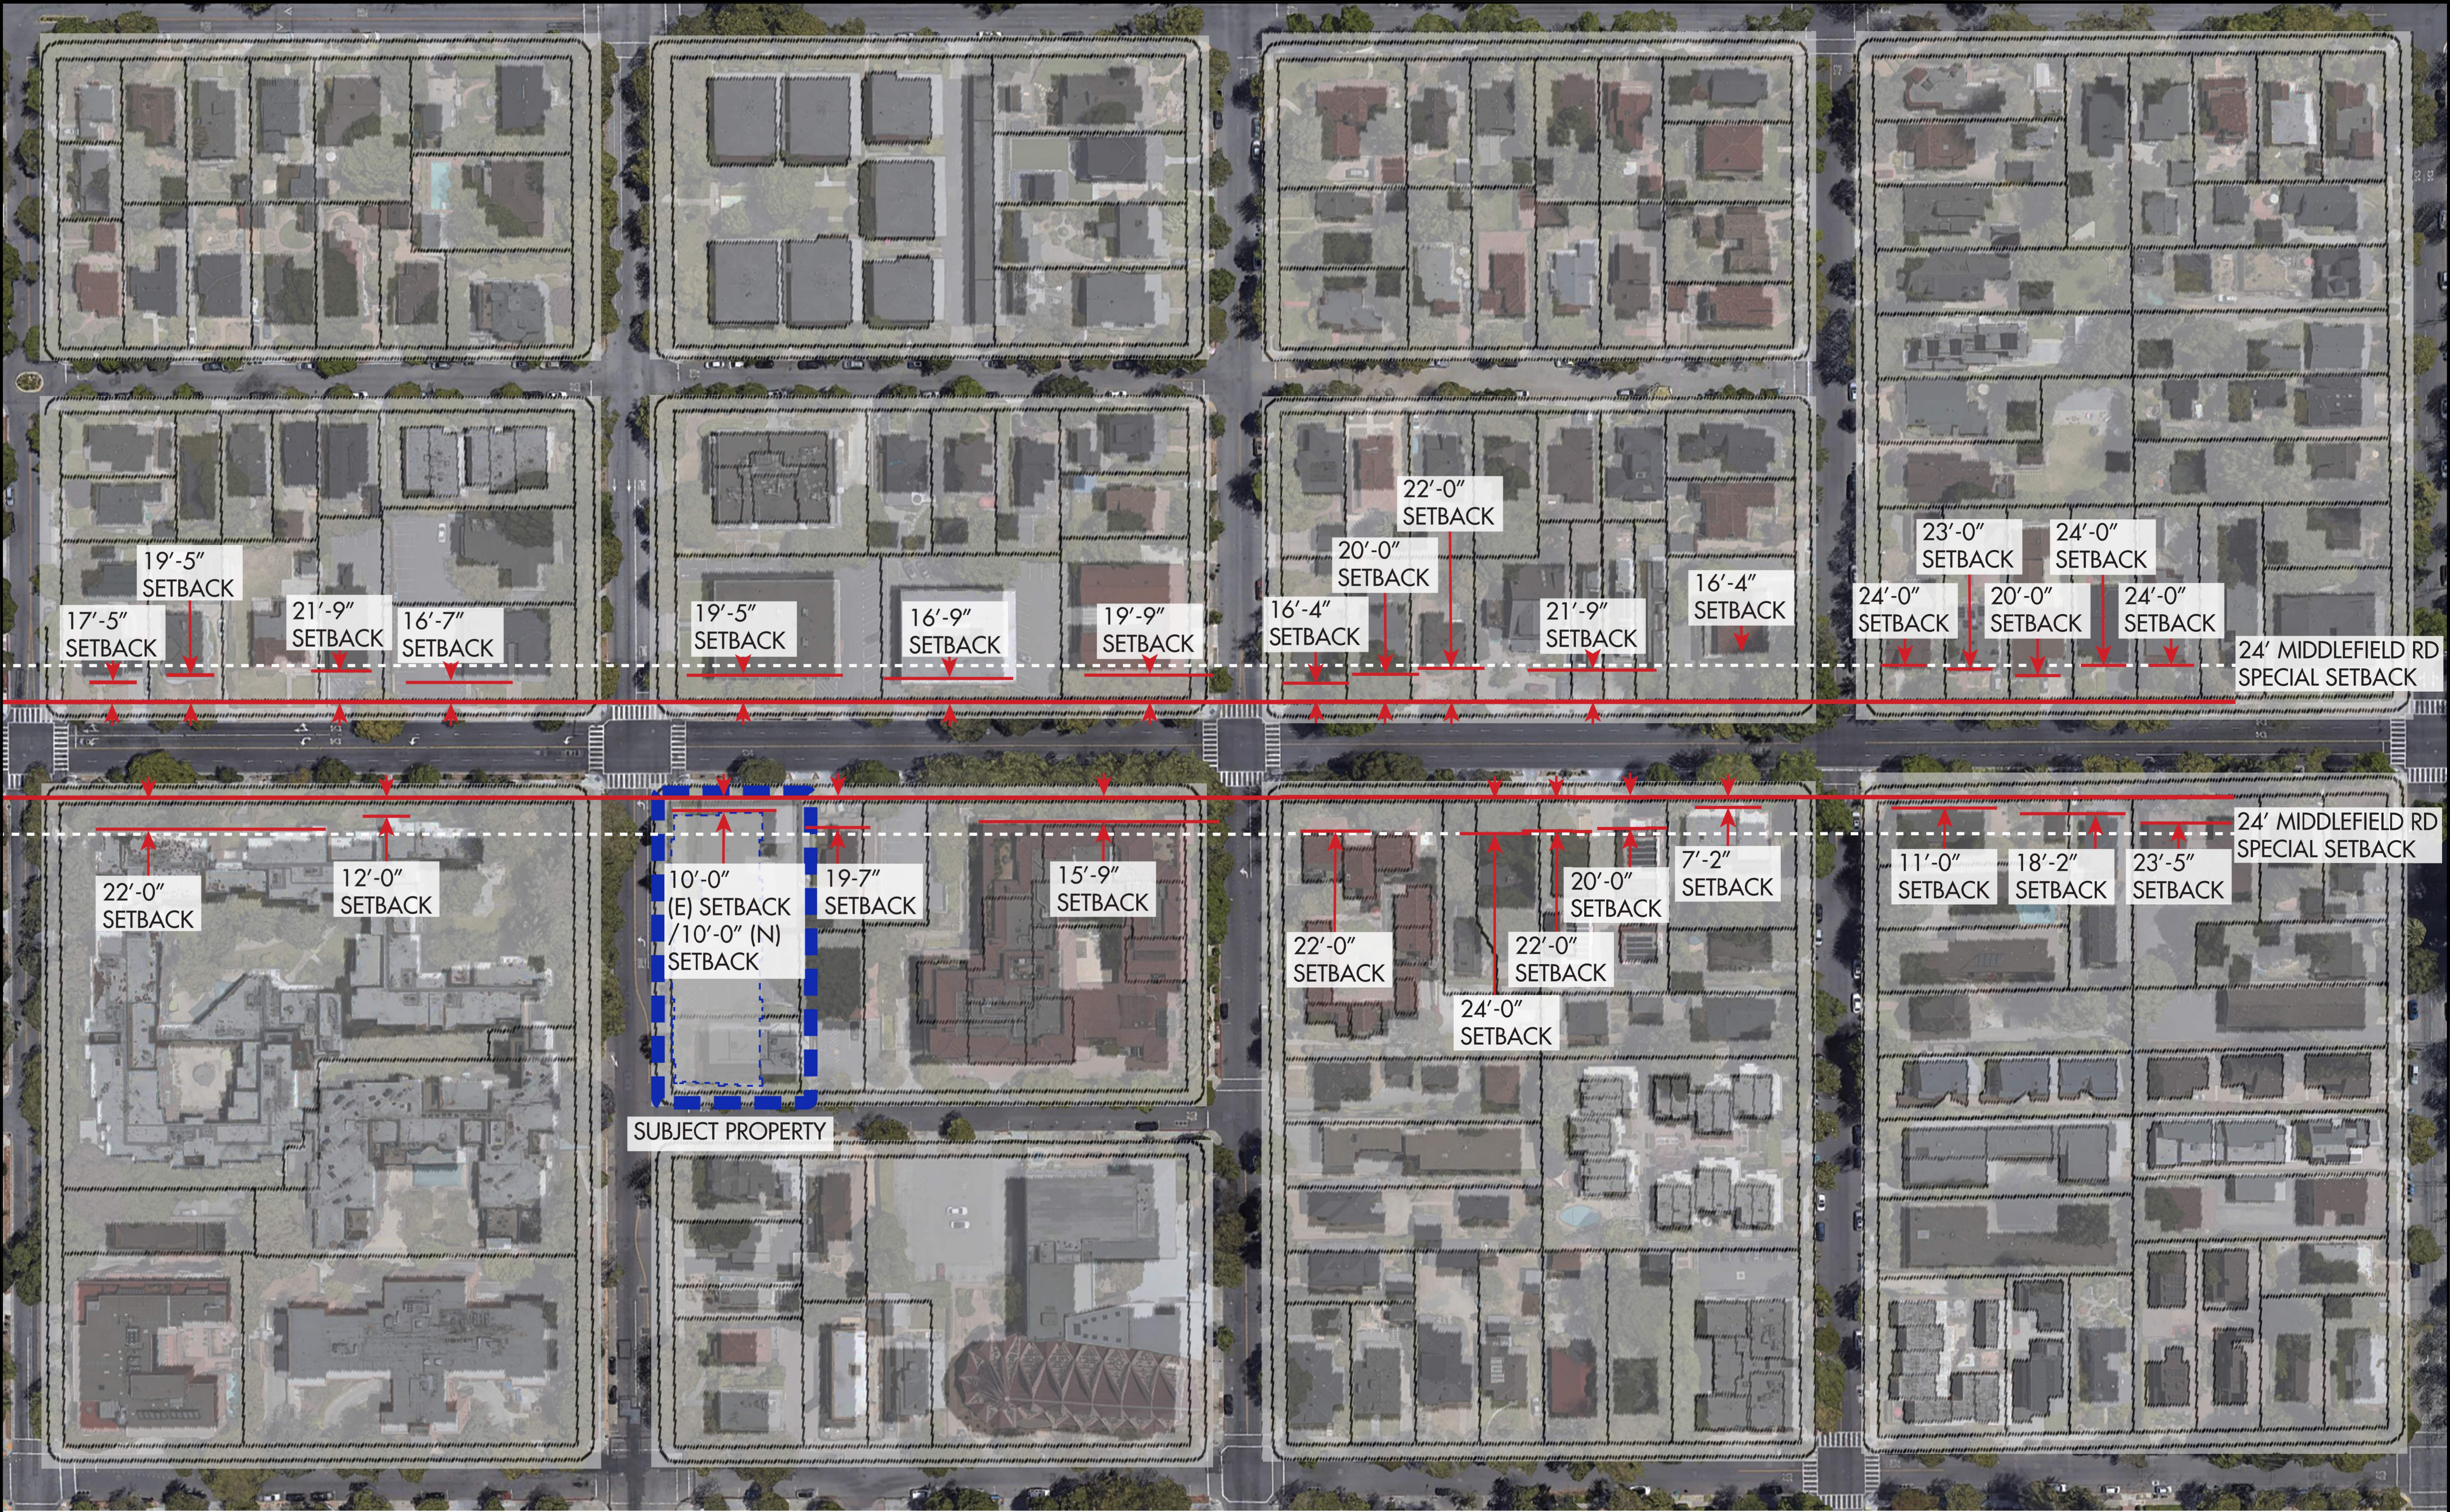SETBACKS (PAMC 18.13.040 TABLE 2):
FRONT YARD (MIDDLEFIELD RD): 24' MIN. (PER ZONING MAP) REQUIRED / 10' PROPOSED

STREET SIDE YARD (UNIVERSITY AVE, ARTERIAL ROADWAY):
16' MIN. REQUIRED OR 0-20' ON ARTERIAL ROADWAYS, PER ZONING MAP / 10' PROPOSED

STREET REAR YARD (BYRON ST): 16' MIN. REQUIRED / 10' PROPOSED

INTERIOR SIDE YARD (>70' LOT WIDTH): 10' MIN. / 25'-6' PROPOSED

SMITH DEVELOPMENT

660 UNIVERSITY
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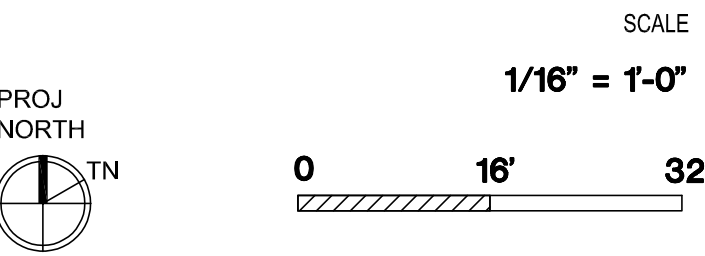


ARCHITECTS
KORTH SUNSERI HAGEY

ISSUES AND REVISIONS		
NO.	DATE	DESCRIPTION
05.13.22		PLANNING RESUBMITTAL #1
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10.31.23		PLANNING RESUBMITTAL #5
12.21.23		PLANNING RESUBMITTAL #6
02.07.24		PLANNING RESUBMITTAL #7


PROJECT NUMBER
21003

SHEET TITLE
OVERALL NEIGHBORHOOD
CONTEXT SITE PLAN



SHEET NUMBER

A1.1B

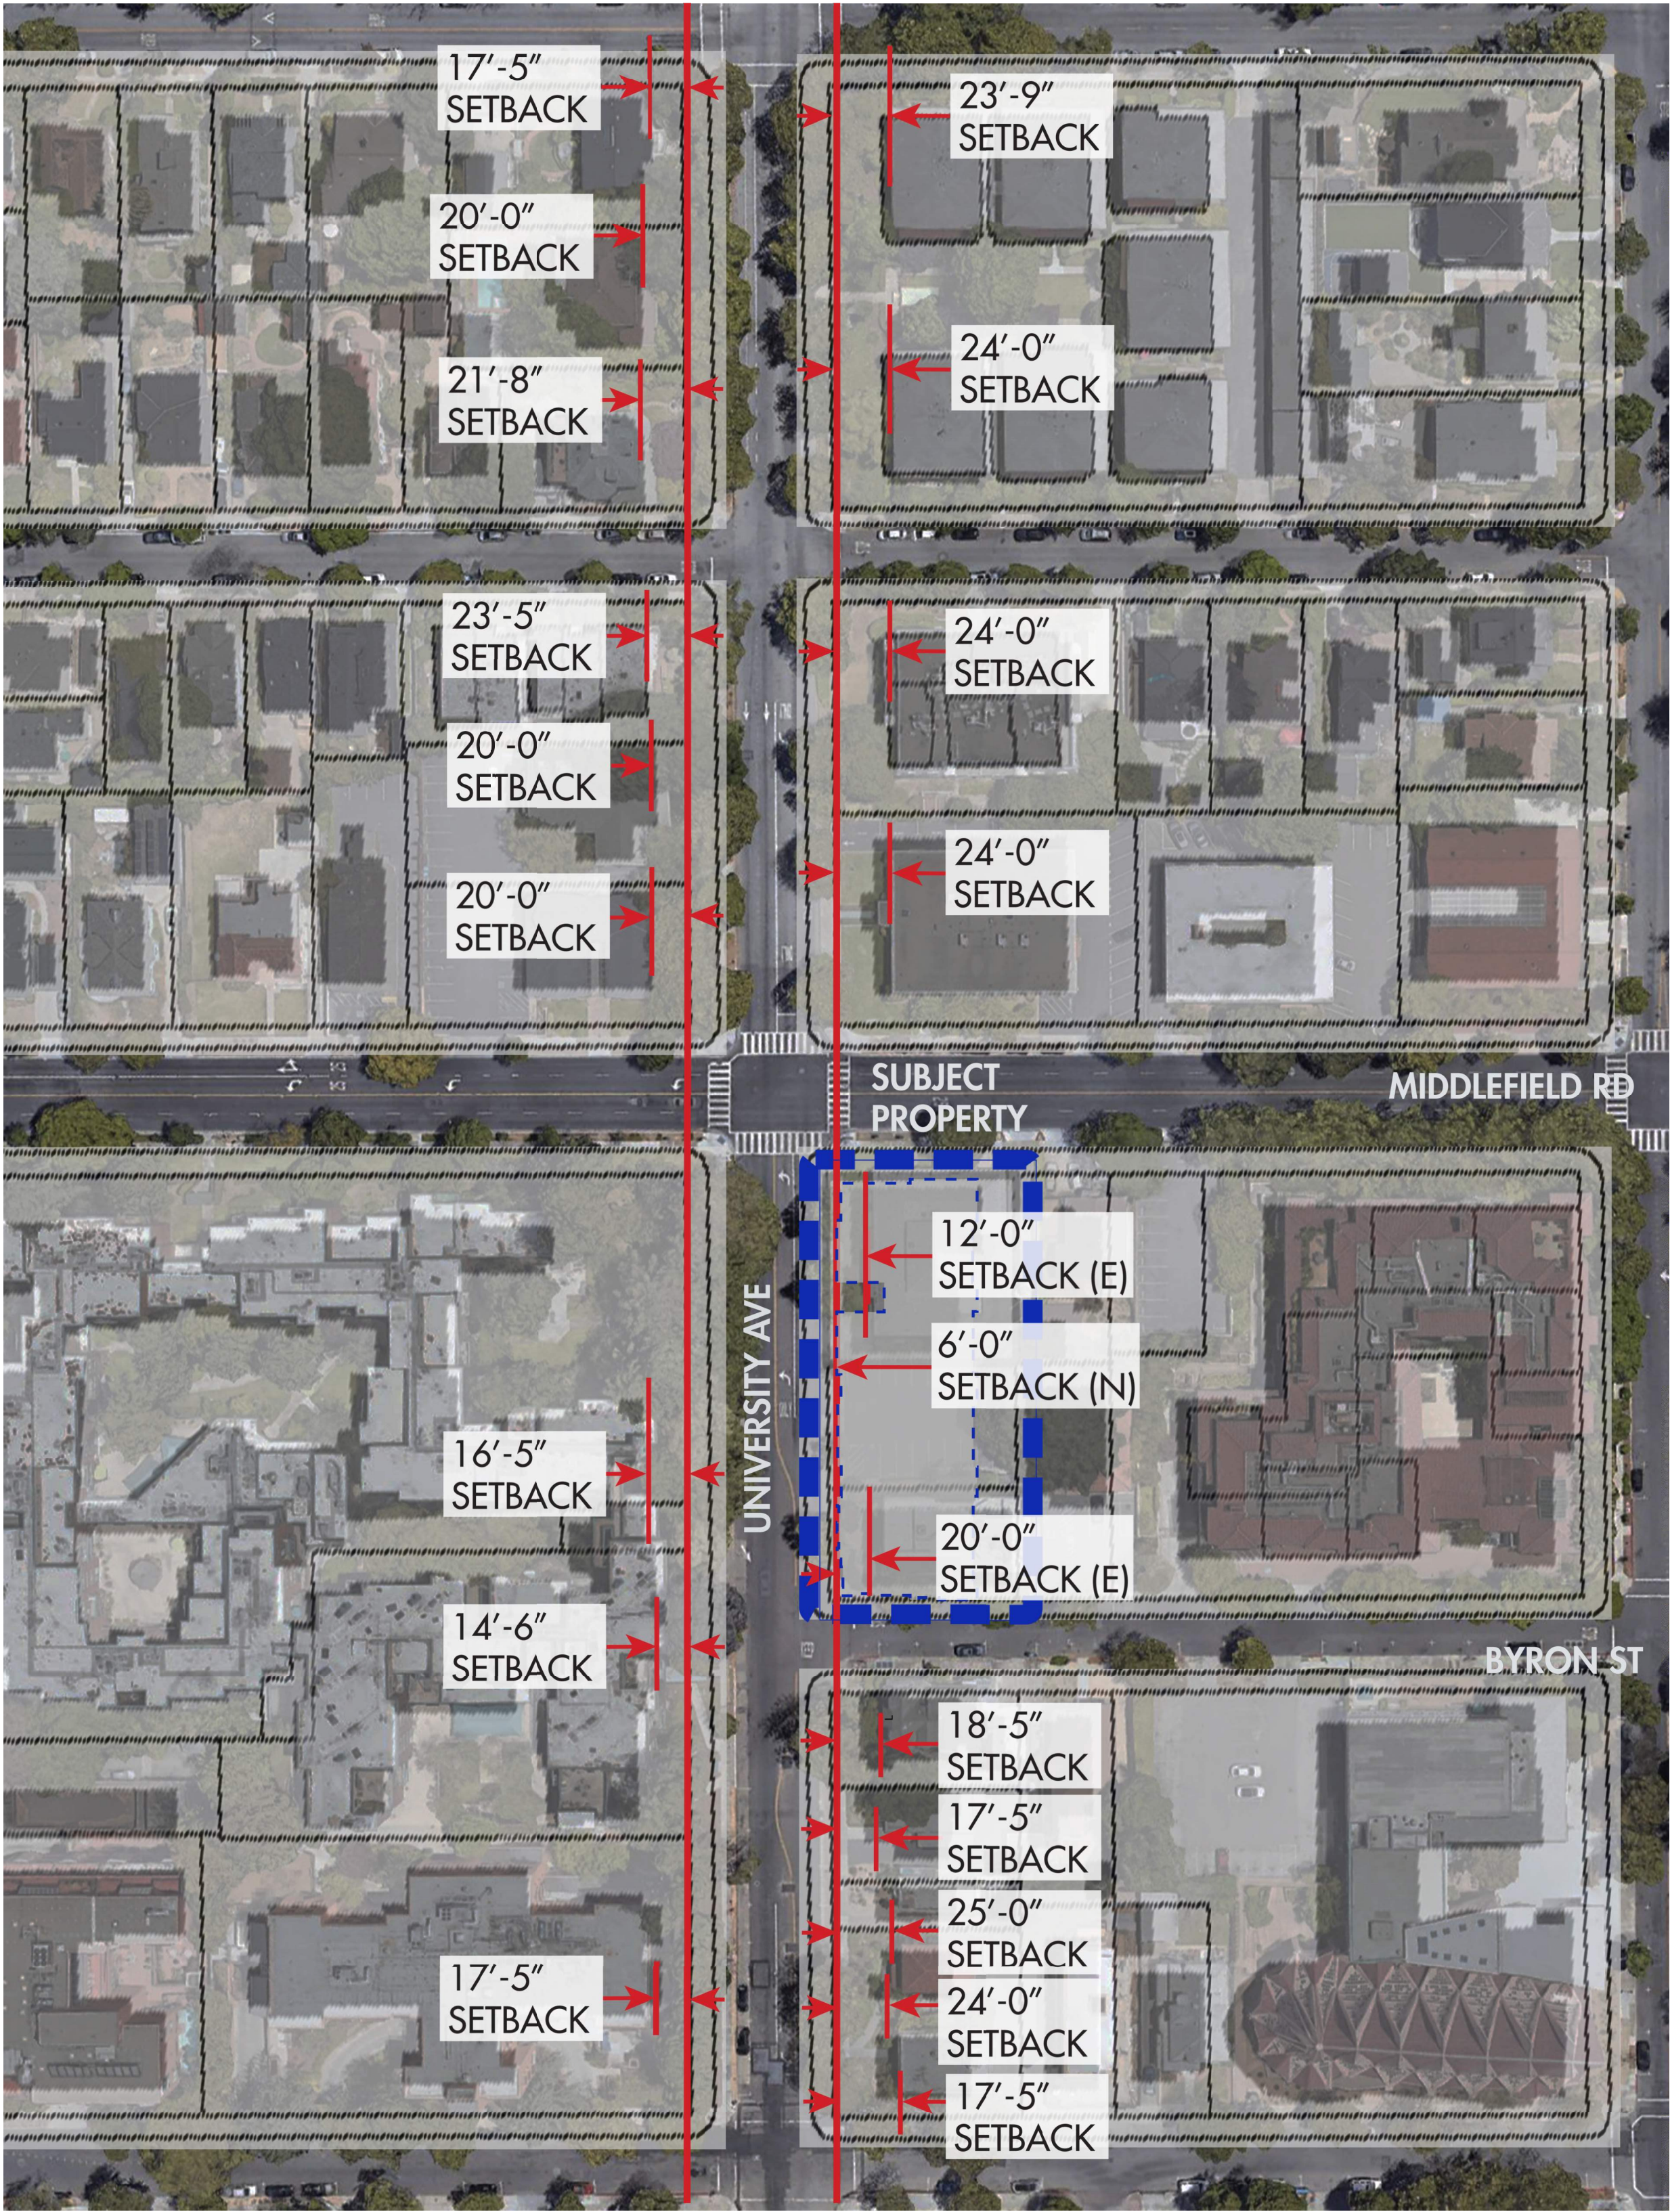


UNIVERSITY AVE SETBACKS

SETBACKS (PAMC 18.13.040 TABLE 2):
FRONT YARD (MIDDLEFIELD RD): 24' MIN. (PER ZONING MAP) REQUIRED / 10' PROPOSED

STREET SIDE YARD (UNIVERSITY AVE, ARTERIAL ROADWAY):
16' MIN. REQUIRED OR 0-20' ON ARTERIAL ROADWAYS, PER ZONING MAP / 10' PROPOSED

STREET REAR YARD (BYRON ST): 16' MIN. REQUIRED / 10' PROPOSED

INTERIOR SIDE YARD (>70' LOT WIDTH): 10' MIN. / 25'-6' PROPOSED

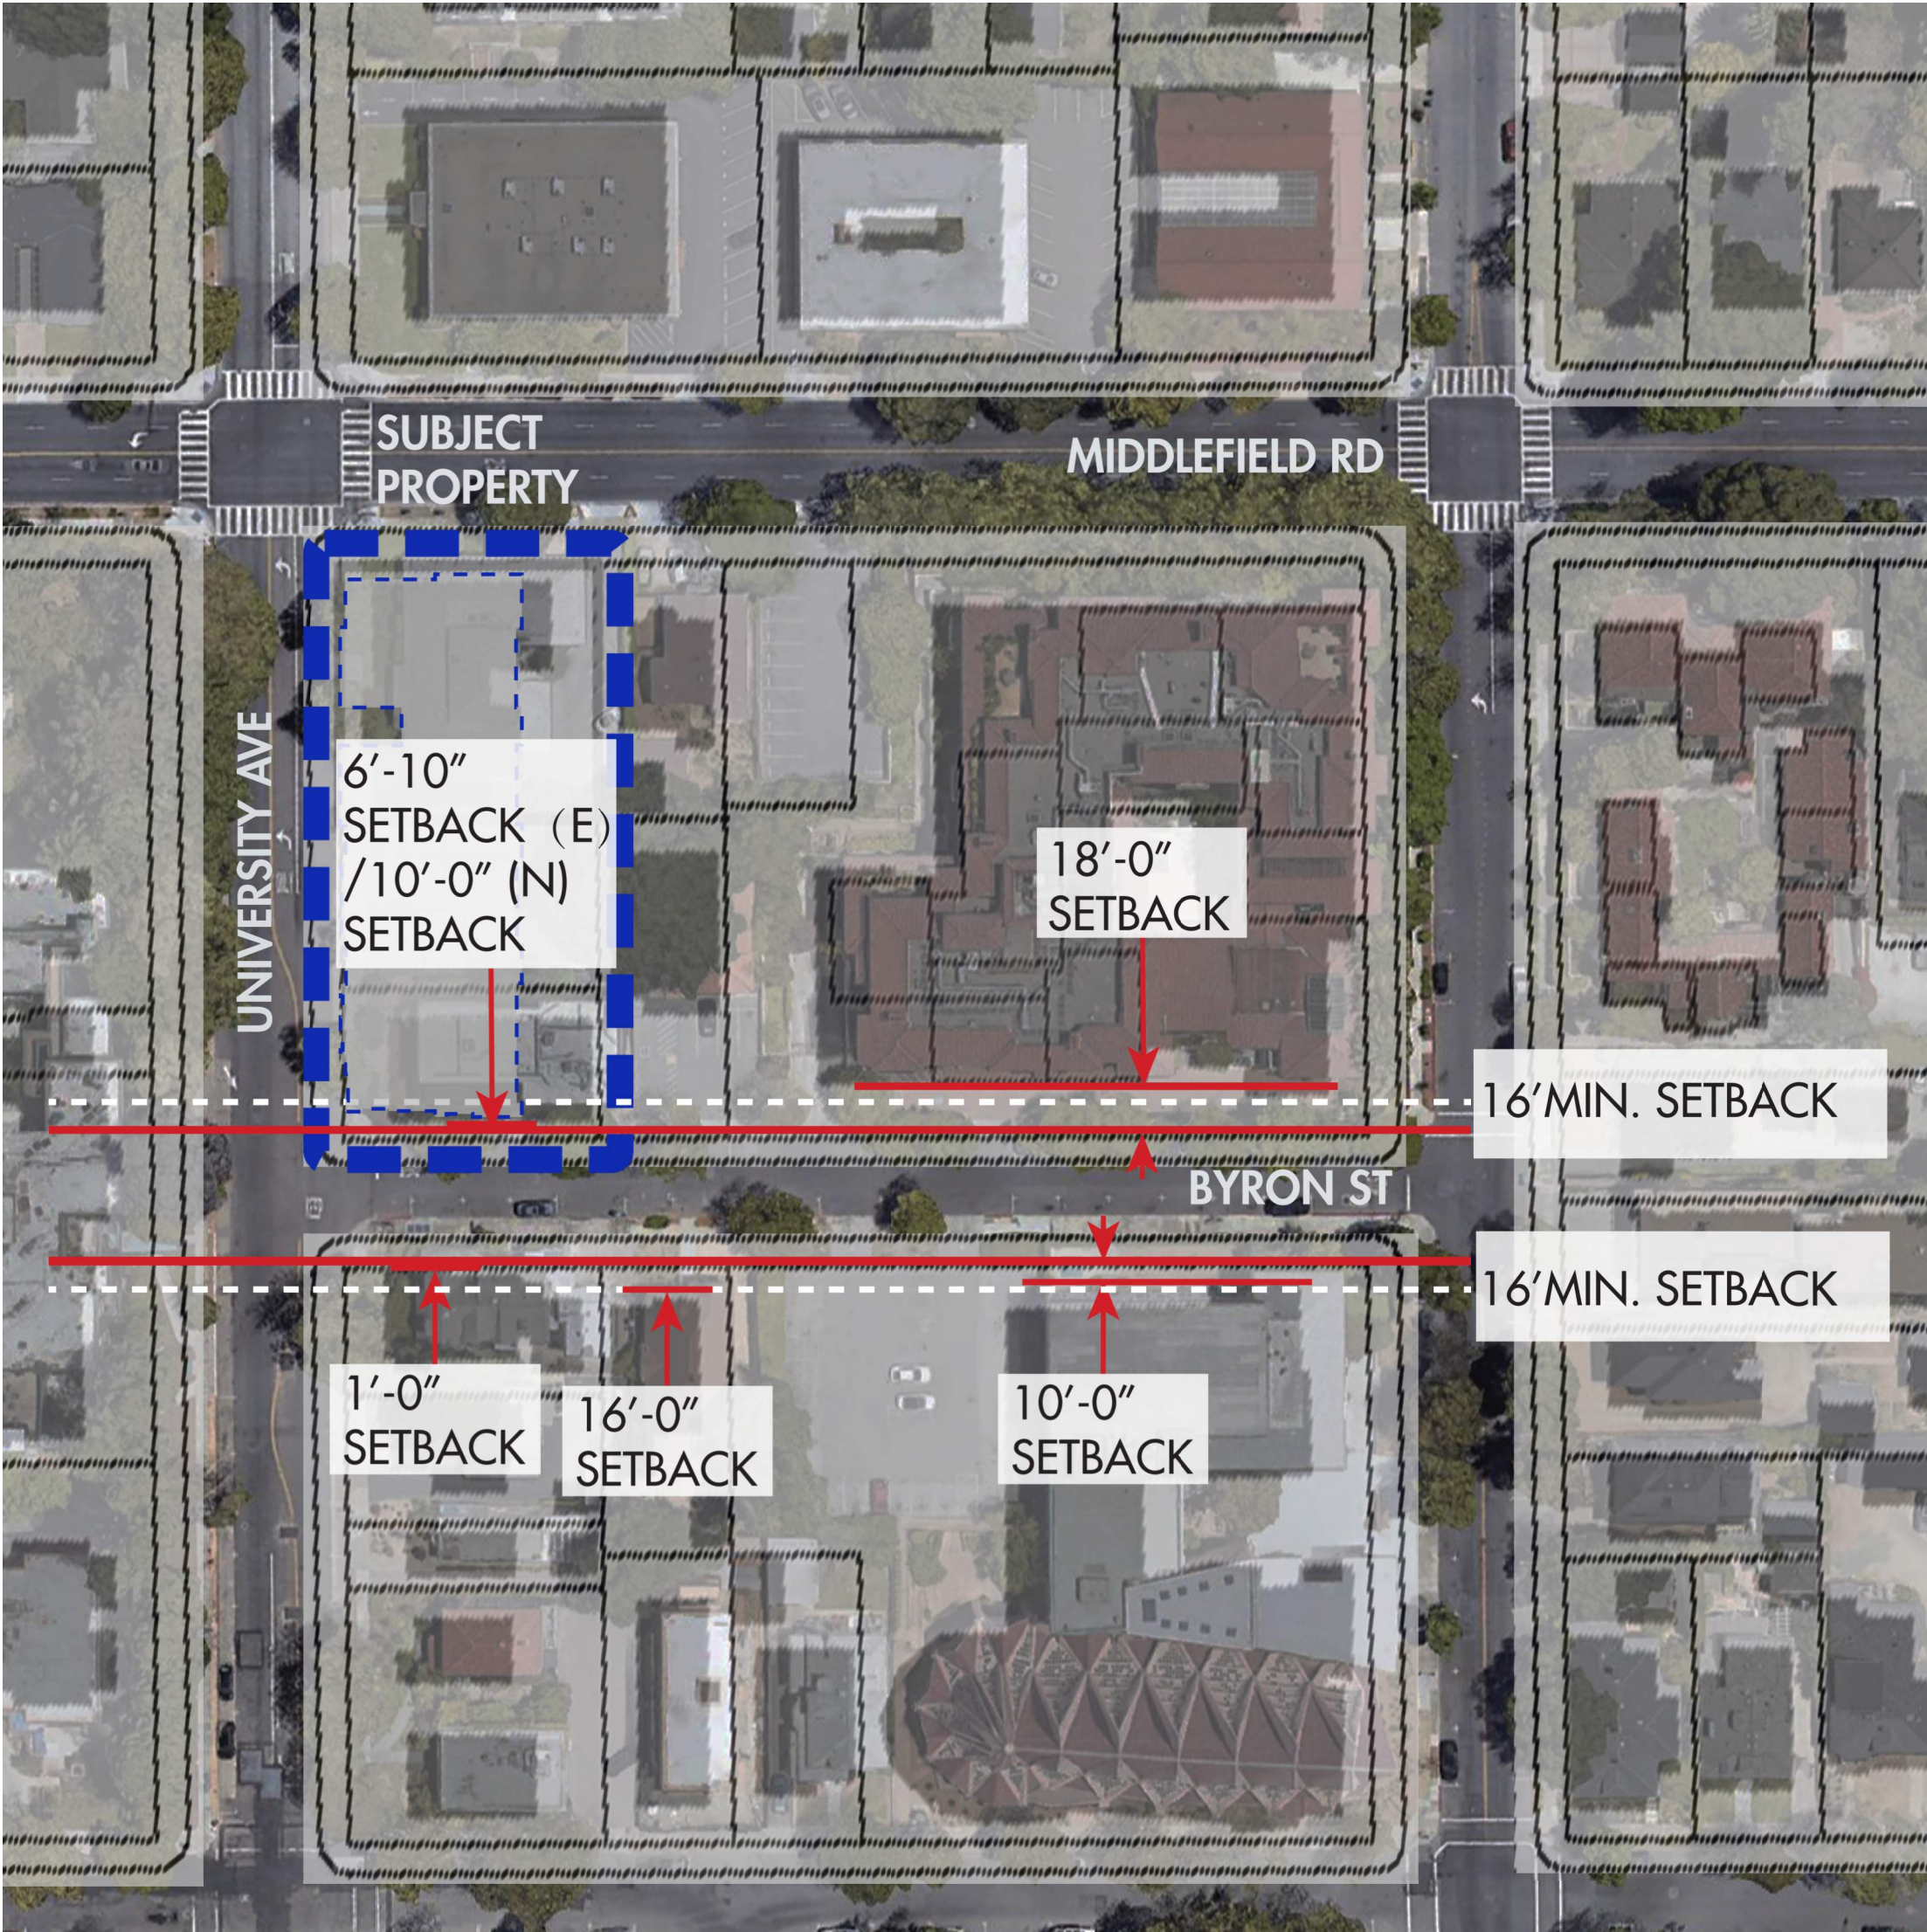

BYRON ST SETBACKS

SETBACKS (PAMC 18.13.040 TABLE 2):
FRONT YARD (MIDDLEFIELD RD): 24' MIN. (PER ZONING MAP) REQUIRED / 10' PROPOSED

STREET SIDE YARD (UNIVERSITY AVE, ARTERIAL ROADWAY):
16' MIN. REQUIRED OR 0-20' ON ARTERIAL ROADWAYS, PER ZONING MAP / 10' PROPOSED

STREET REAR YARD (BYRON ST): 16' MIN. REQUIRED / 10' PROPOSED

INTERIOR SIDE YARD (>70' LOT WIDTH): 10' MIN. / 25'-6' PROPOSED

SMITH DEVELOPMENT


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ISSUES AND REVISIONS		
NO.	DATE	DESCRIPTION
	05.13.22	PLANNING RESUBMITTAL #1
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	12.21.23	PLANNING RESUBMITTAL #6
	02.07.24	PLANNING RESUBMITTAL #7

PROJECT NUMBER
21003

SHEET TITLE
**OVERALL NEIGHBORHOOD
CONTEXT SITE PLAN**



SHEET NUMBER

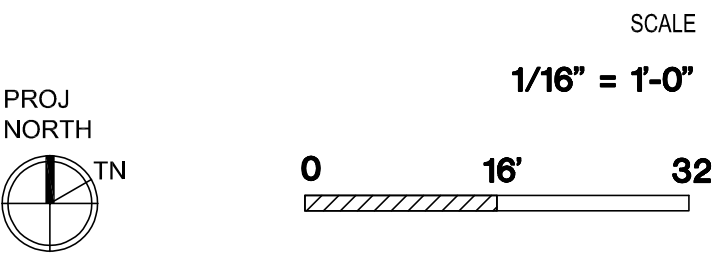A1.1C

SMITH DEVELOPMENT

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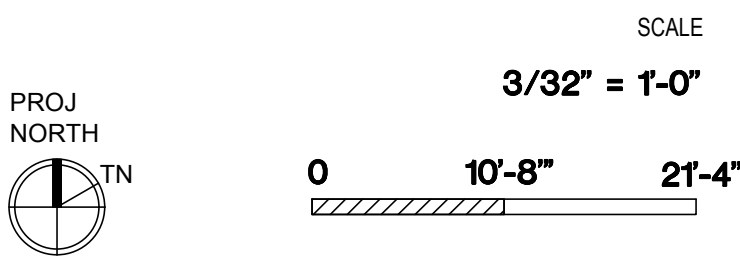


ARCHITECTS
KORTH SUNSERI HAGEY

ISSUES AND REVISIONS		
NO.	DATE	DESCRIPTION
	12.01.21	PLANNING SUBMITTAL
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	11.02.22	PLANNING RESUBMITTAL #3
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	12.21.23	PLANNING RESUBMITTAL #6
	02.07.24	PLANNING RESUBMITTAL #7

PROJECT NUMBER
21003

SHEET TITLE
**PROPOSED PLAN
BELOW GRADE PARKING LEVEL P2**




SHEET NUMBER

A2.P2

LEGEND

- ENTRY PUBLIC / ACCESSIBLE ENTRY (MAIN)
- ACCESS PUBLIC / ACCESSIBLE ACCESS (TO PARKING, AMENITIES, ETC.)
- ACCESSIBLE PATH OF TRAVEL SLOPE (ALONG PATH) 5% MAX CROSS SLOPE 2% MAX
- BIKE PATH OF TRAVEL
- 1-HR RATED WALL, SEE A0.2A - C FOR MORE INFORMATION
- 2-HR RATED WALL, SEE A0.2A - C FOR MORE INFORMATION
- 3-HR RATED WALL, SEE A0.2A - C FOR MORE INFORMATION

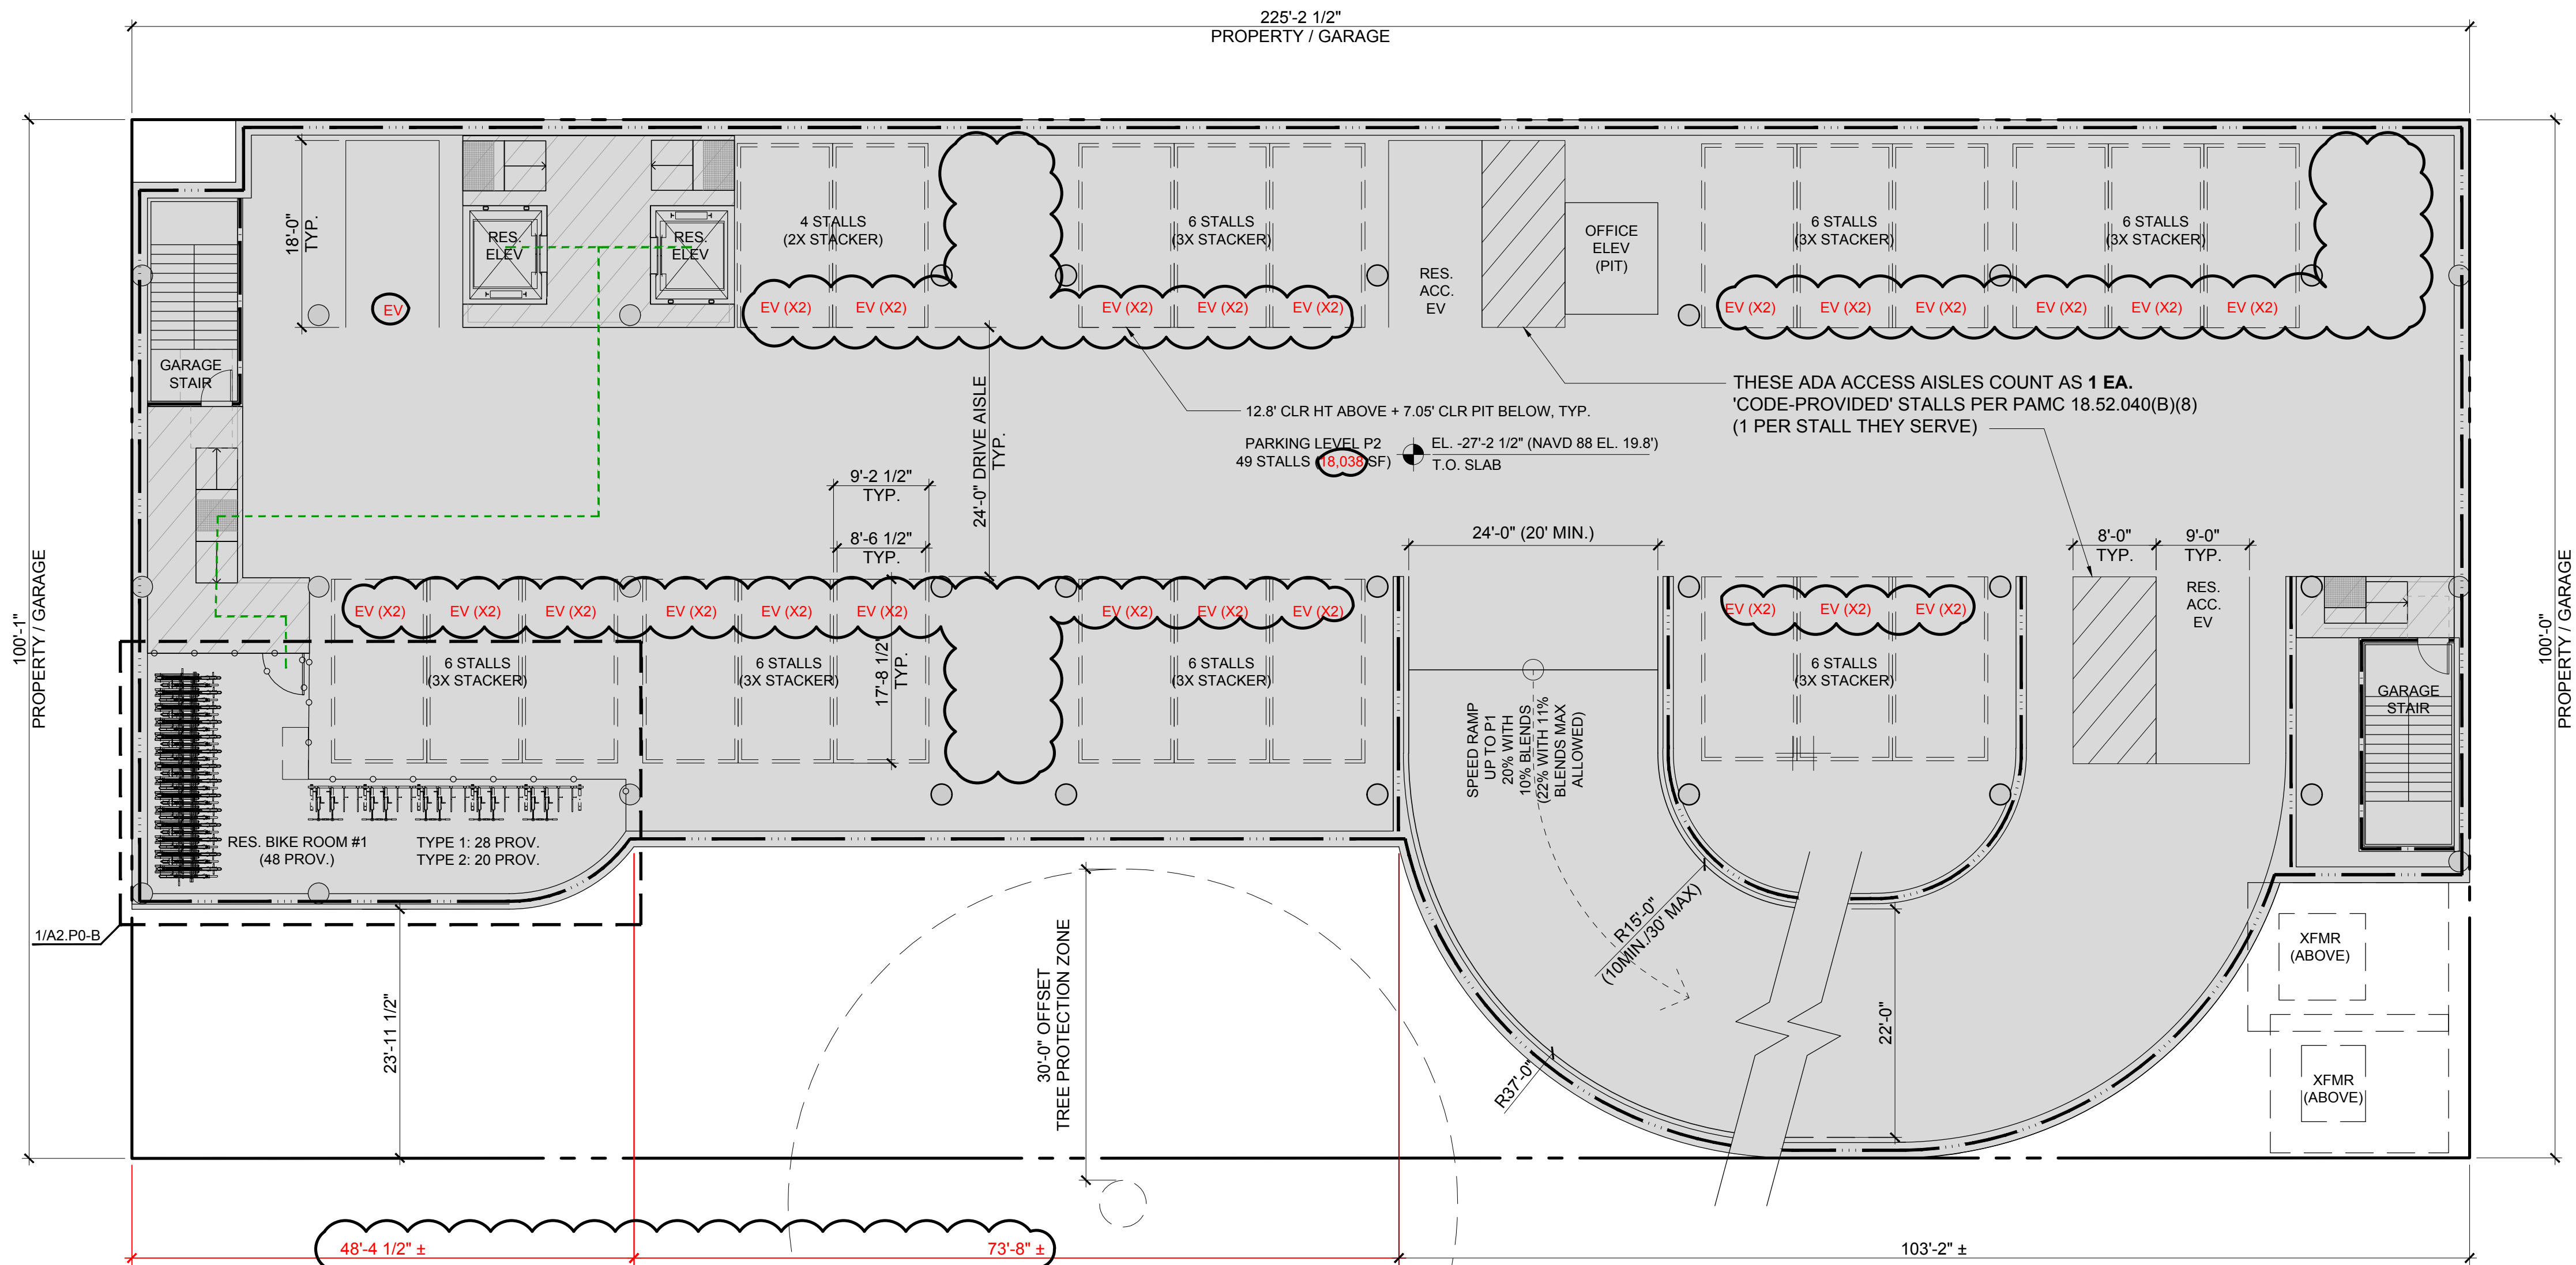

RESIDENTIAL ACCESSIBILITY
PORTIONS OF PARKING (P2 LEVEL PRIMARILY & RESIDENTIAL AREAS OF P1), FIRST FLOOR RESIDENTIAL AREA & FLOORS 2-4 AS WELL AS ROOF TERRACE TO COMPLY WITH CBC CHAPTER 11A, TYP. AN ACCESSIBLE ROUTE IS PROVIDED AT ALL LEVELS (P2 - ROOF) FOR BOTH INTERIOR & EXTERIOR COMMON-USE RESIDENTIAL AREAS, WITH CHANGES IN LEVEL NOT EXCEEDING 1/4" OR BEING PROVIDED WITH A SLOPED WALK NOT EXCEEDING 5%, A RAMP NOT EXCEEDING 8.33%, OR ELEVATOR(S) PER CBC 1111A. PARKING FACILITIES WILL COMPLY WITH CBC 1109A.

INTERIOR ACCESSIBLE ROUTES EXCEEDING 200 FT. SHALL COMPLY WITH CBC 1138A.1.2 / FIGURE 11A-1L.



ALL UNITS, INCLUDING PRIVATE OUTDOOR BALCONIES / TERRACES WILL BE EITHER ACCESSIBLE OR ADAPTABLE INCLUDING KITCHEN AND AT LEAST ONE BATHROOM, PER CBC 11A. THIS INCLUDES DOORS, PATH OF TRAVEL, APPLIANCE / FIXTURE CLEARANCES AS WELL AS ANY OTHER LIFE-SAFETY REQUIREMENTS.

P2 RESIDENTIAL (49 STALLS PROVIDED / 51 TOTAL PER CODE), 49 RESIDENTIAL + 2 ADA AISLE (NOT INCL. 3 ON P1 LEVEL)
49 RESIDENTIAL STALLS (ALL TO BE EVSE INSTALLED OR EVSE OUTLET READY)
* 23 STACKER LIFTS (46 STALLS), 12.8' CLR HT + 7.05' CLR PIT
* 2 RES. ACCESSIBLE EVSE STALLS WITH 8' LOADING
* 1 RESIDENTIAL (EVSE OUTLET READY) STD. STALL

2 CODE PROVIDED STALLS (ADA ACCESS AISLES)

RESIDENTIAL PARKING REQUIREMENTS (FOR REF), PER CBC 11A:
2 ACCESSIBLE STALLS REQ. (2% OF TOTAL UNITS OR STALLS, WHICHEVER IS GREATER)
* 1 STD ADA (9' X 18') + 1 VAN ADA (12' X 18'), WITH 5' ACCESS AISLE, @ P1 LEVEL
49 EV CHARGING STALLS (1 EVSE-READY OUTLET OR EVSE INSTALLED / UNIT PER PAMC 16.14.420), INCLUDING 3 WITH 8' LOADING (1 / 25 STALLS PER CGC 4.106.4.2.2), 2 @ P2 LEVEL + 1 @ P1 LEVEL

TOTAL RESIDENTIAL STALLS PROPOSED: 54 (50 ASSIGNED + 2 UNASSIGNED ADA + 2 CODE PROVIDED) STALLS INCLUDING 3 STALLS AT P1 LEVEL

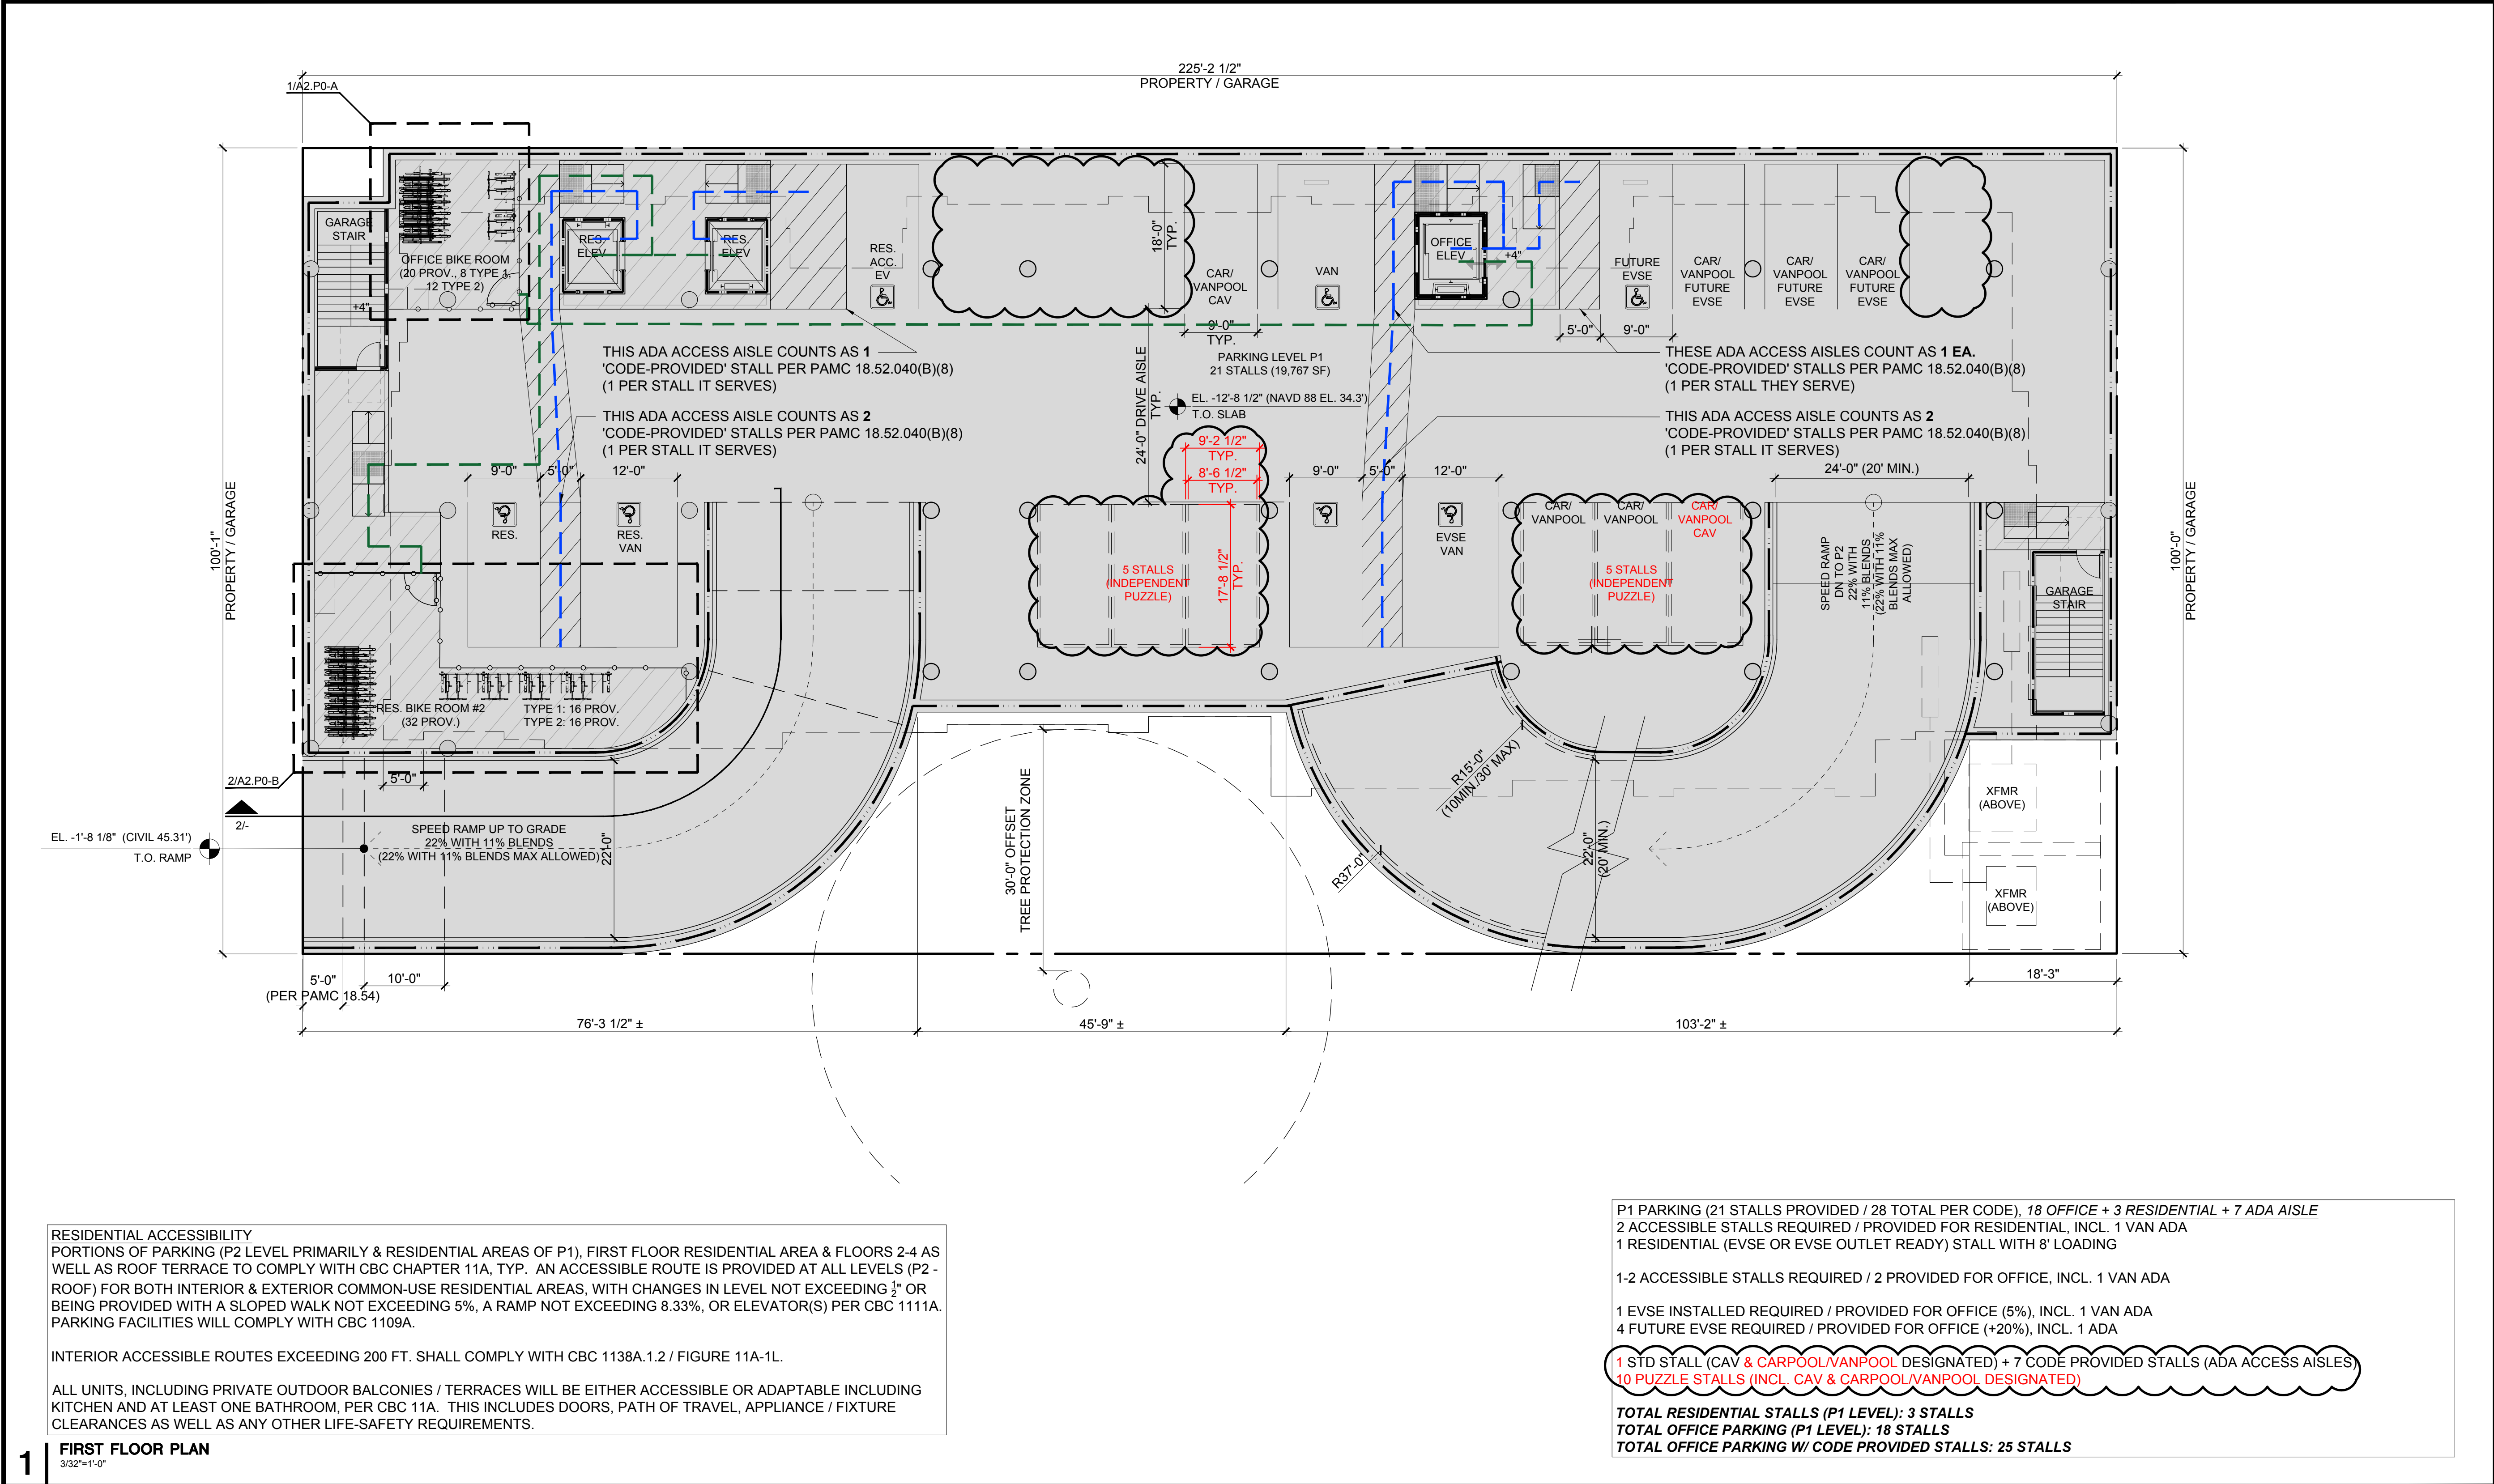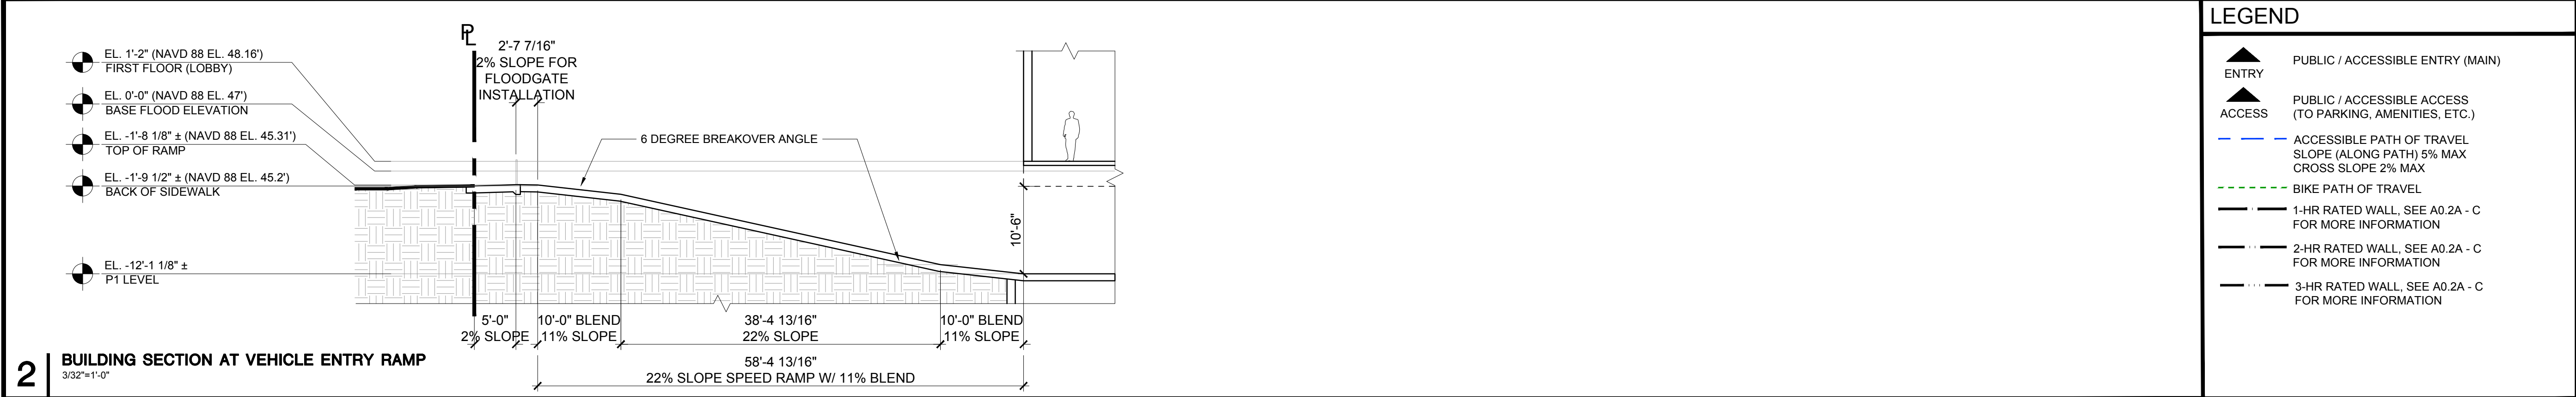

SMITH DEVELOPMENT

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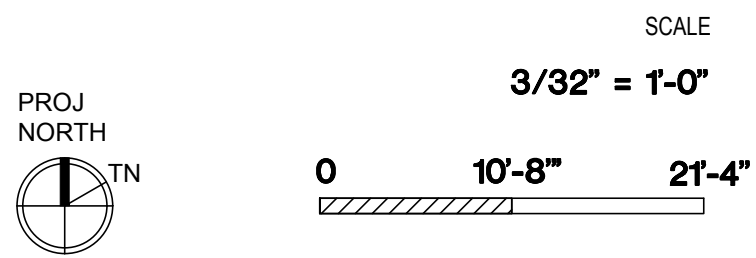


ARCHITECTS
KORTH SUNSERI HAGEY

ISSUES AND REVISIONS		
NO.	DATE	DESCRIPTION
12.01.21		PLANNING SUBMITTAL
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12.21.23		PLANNING RESUBMITTAL #6
02.07.24		PLANNING RESUBMITTAL #7

PROJECT NUMBER
21003

SHEET TITLE
PROPOSED PLAN
BELOW GRADE PARKING LEVEL P1



SHEET NUMBER

A2.P1

UNIVERSITY AVE

UNIVERSITY AVENUE
(75' WIDE ROW)

LEGEND

- 1-HR RATED WALL, SEE A0.2A - C
FOR MORE INFORMATION
- 2-HR RATED WALL, SEE A0.2A - C
FOR MORE INFORMATION

SMITH DEVELOPMENT

660 UNIVERSITY
PALO ALTO, CA 94301



ARCHITECTS
KORTH SUNSERI HAGEY

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12.21.23		PLANNING RESUBMITTAL #6
02.07.24		PLANNING RESUBMITTAL #7

PROJECT NUMBER
21003

SHEET TITLE
PROPOSED PLAN
FIRST FLOOR

SCALE
3/32" = 1'-0"



0 10'-8" 21'-4"

SHEET NUMBER

A2.1

TC 45.6

TC 45.5

TC 45.4

TC 45.3

TC 45.2

TC 45.1

TC 45.3

TC 45.2

TC 45.1

TC 31.7

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TC 31.4

TC 31.3

TC 31.2

TC 31.1

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TC 30.8

TC 30.7

TC 30.6

TC 30.5

TC 30.4

TC 30.3

TC 30.2

TC 30.1

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TC 29.9

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TC 29.7

TC 29.6

TC 29.5

TC 29.4

TC 24.6

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TC 23.7

TC 23.6

TC 23.5

TC 23.4

TC 23.3

TC 23.2

TC 23.1

TC 23.0

TC 22.9

TC 22.8

TC 22.7

TC 22.6

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TC 22.4

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TC 22.1

TC 22.0

TC 21.9

TC 21.8

TC 21.7

TC 21.6

TC 21.5

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TC 20.9

TC 20.8

TC 20.7

TC 20.6

TC 20.5

TC 20.4

TC 20.3

TC 20.2

TC 20.1

TC 20.0

TC 19.9

TC 19.8

TC 19.7

TC 19.6

TC 19.5

TC 19.4

TC 19.3

TC 19.2

TC 19.1

TC 19.0

TC 18.9

TC 18.8

TC 18.7

TC 18.6

TC 18.5

TC 18.4

TC 18.3


TC 18.2

TC 18.1

TC 18.0

TC 17.9

</

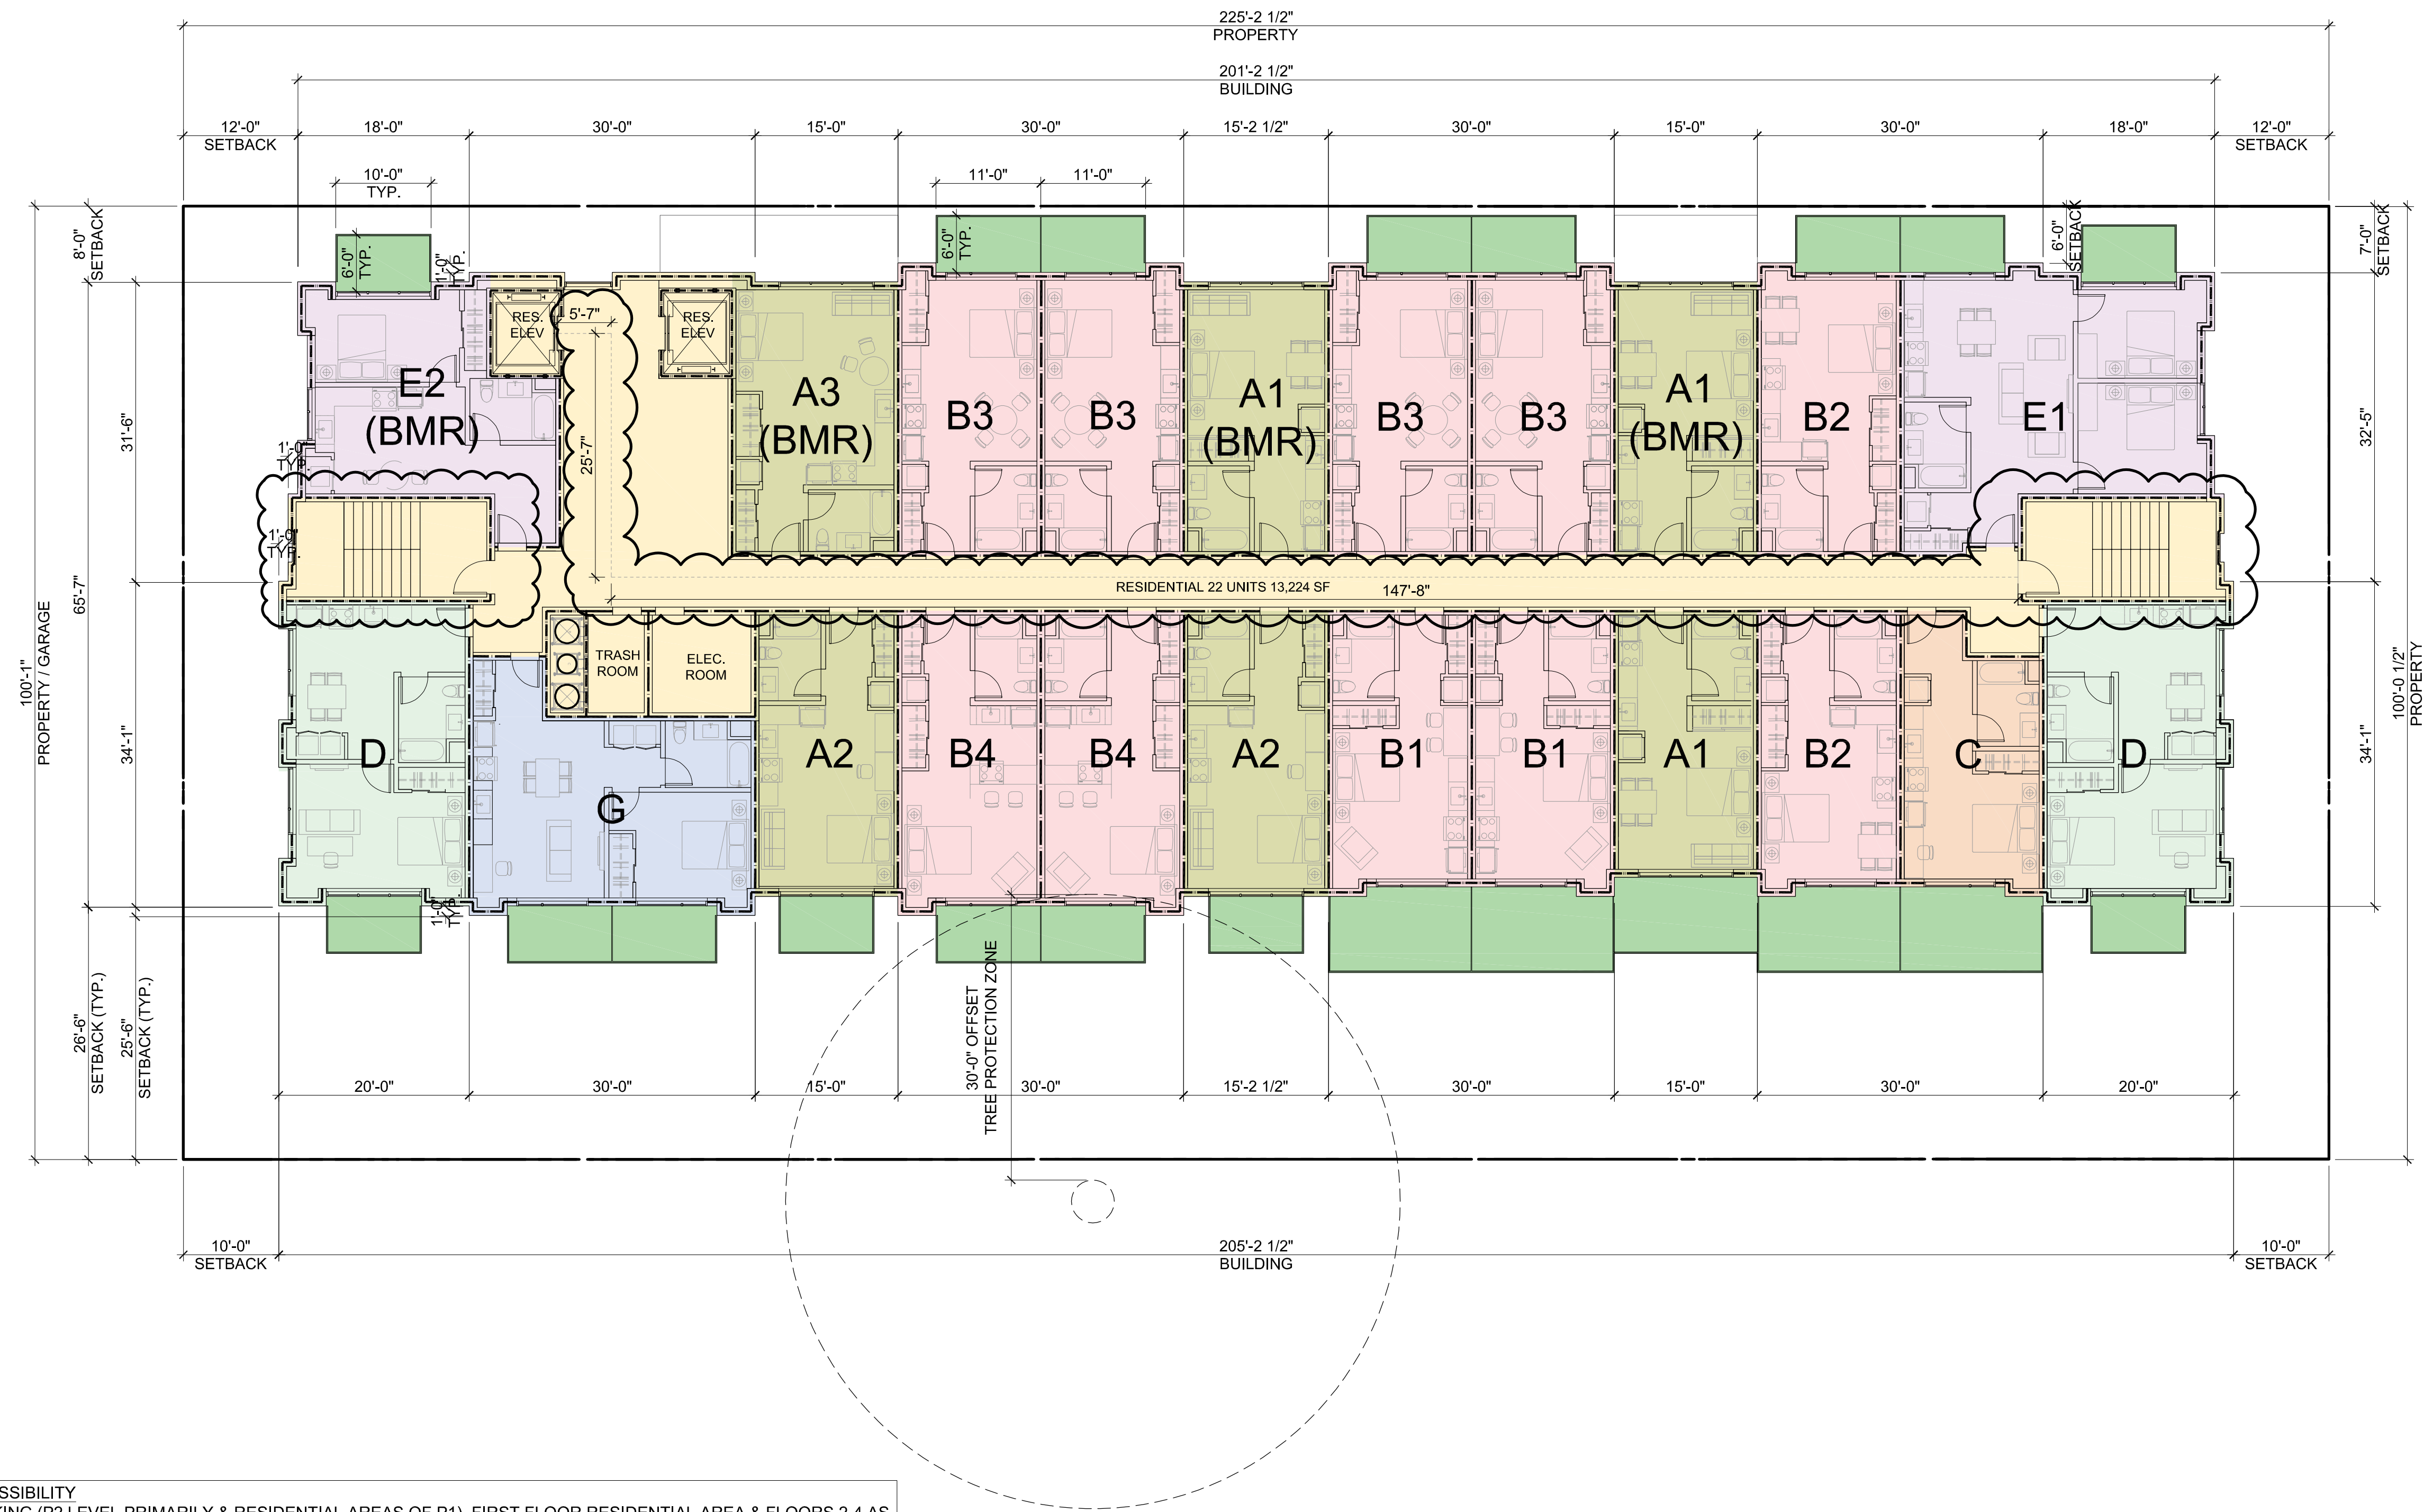

LEGEND	
	1-HR RATED WALL, SEE A0.2A - C FOR MORE INFORMATION
	2-HR RATED WALL, SEE A0.2A - C FOR MORE INFORMATION

RESIDENTIAL ACCESSIBILITY
PORTIONS OF PARKING (P2 LEVEL PRIMARILY & RESIDENTIAL AREAS OF P1), FIRST FLOOR RESIDENTIAL AREA & FLOORS 2-4 AS WELL AS ROOF TERRACE TO COMPLY WITH CBC CHAPTER 11A, TYP. AN ACCESSIBLE ROUTE IS PROVIDED AT ALL LEVELS (P2 - ROOF) FOR BOTH INTERIOR & EXTERIOR COMMON-USE RESIDENTIAL AREAS, WITH CHANGES IN LEVEL NOT EXCEEDING $\frac{1}{4}$ " OR BEING PROVIDED WITH A SLOPED WALK NOT EXCEEDING 5%, A RAMP NOT EXCEEDING 8.33%, OR ELEVATOR(S) PER CBC 1111A. PARKING FACILITIES WILL COMPLY WITH CBC 1109A.

INTERIOR ACCESSIBLE ROUTES EXCEEDING 200 FT. SHALL COMPLY WITH CBC 1138A.1.2 / FIGURE 11A-1L.

ALL UNITS, INCLUDING PRIVATE OUTDOOR BALCONIES / TERRACES WILL BE EITHER ACCESSIBLE OR ADAPTABLE INCLUDING KITCHEN AND AT LEAST ONE BATHROOM, PER CBC 11A. THIS INCLUDES DOORS, PATH OF TRAVEL, APPLIANCE / FIXTURE CLEARANCES AS WELL AS ANY OTHER LIFE-SAFETY REQUIREMENTS.

SMITH DEVELOPMENT

660 UNIVERSITY
PALO ALTO, CA 94301



ISSUES AND REVISIONS		
NO.	DATE	DESCRIPTION
	12.01.21	PLANNING SUBMITTAL
	05.13.22	PLANNING RESUBMITTAL #1
	08.15.22	PLANNING RESUBMITTAL #2
	11.02.22	PLANNING RESUBMITTAL #3
	08.28.23	PLANNING RESUBMITTAL #4
	10.31.23	PLANNING RESUBMITTAL #5
	12.21.23	PLANNING RESUBMITTAL #6
	02.07.24	PLANNING RESUBMITTAL #7

PROJECT NUMBER
21003


SHEET TITLE
**PROPOSED PLAN
SECOND FLOOR**

SCALE
3/32" = 1'-0"

PROJ NORTH

SHEET NUMBER

A2.2A

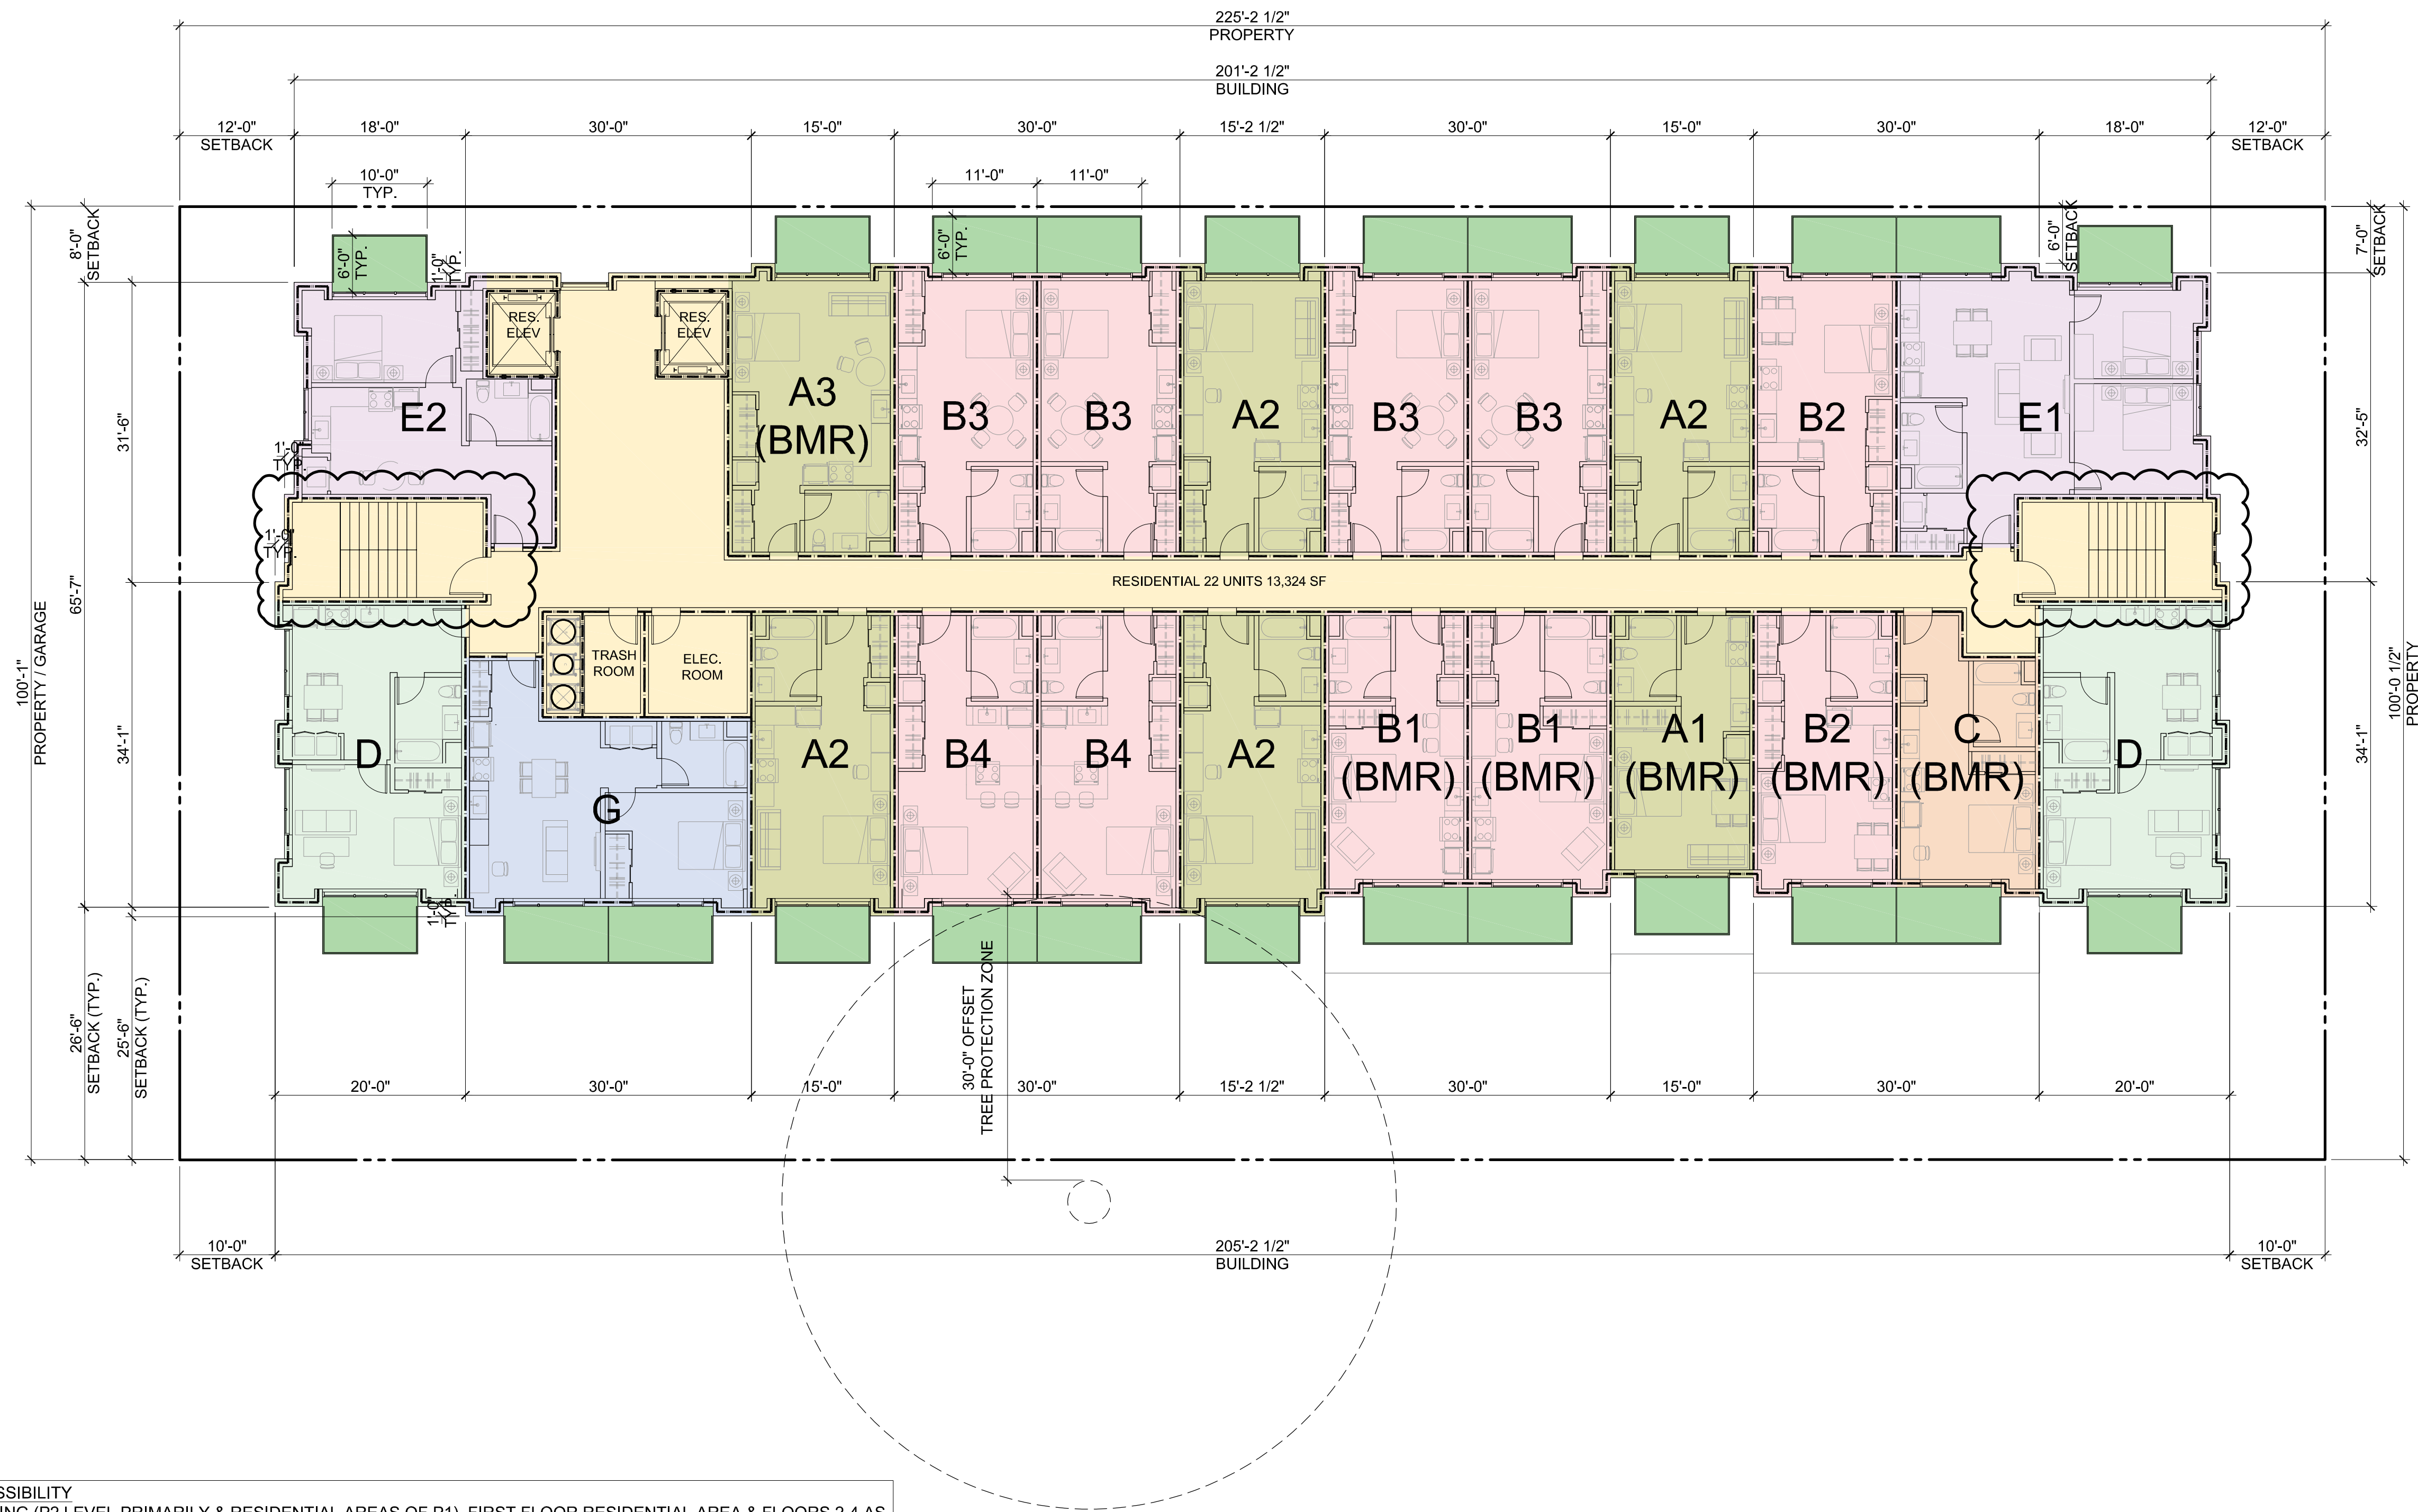

RESIDENTIAL ACCESSIBILITY
PORTIONS OF PARKING (P2 LEVEL PRIMARILY & RESIDENTIAL AREAS OF P1), FIRST FLOOR RESIDENTIAL AREA & FLOORS 2-4 AS WELL AS ROOF TERRACE TO COMPLY WITH CBC CHAPTER 11A, TYP. AN ACCESSIBLE ROUTE IS PROVIDED AT ALL LEVELS (P2 - ROOF) FOR BOTH INTERIOR & EXTERIOR COMMON-USE RESIDENTIAL AREAS, WITH CHANGES IN LEVEL NOT EXCEEDING $\frac{1}{4}$ " OR BEING PROVIDED WITH A SLOPED WALK NOT EXCEEDING 5%, A RAMP NOT EXCEEDING 8.33%, OR ELEVATOR(S) PER CBC 1111A. PARKING FACILITIES WILL COMPLY WITH CBC 1109A.

INTERIOR ACCESSIBLE ROUTES EXCEEDING 200 FT. SHALL COMPLY WITH CBC 1138A.1.2 / FIGURE 11A-1L.

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LEGEND	
	1-HR RATED WALL, SEE A0.2A - C FOR MORE INFORMATION
	2-HR RATED WALL, SEE A0.2A - C FOR MORE INFORMATION

SMITH DEVELOPMENT

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PALO ALTO, CA 94301



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	10.31.23	PLANNING RESUBMITTAL #5
	12.21.23	PLANNING RESUBMITTAL #6
	02.07.24	PLANNING RESUBMITTAL #7

PROJECT NUMBER
21003

SHEET TITLE
**PROPOSED PLAN
THIRD FLOOR**

SCALE
3/32" = 1'-0"

PROJ NORTH

0 10'-8" 21'-4"

SHEET NUMBER

A2.2B



LEGEND	
	1-HR RATED WALL, SEE A0.2A - C FOR MORE INFORMATION
	2-HR RATED WALL, SEE A0.2A - C FOR MORE INFORMATION

RESIDENTIAL ACCESSIBILITY
PORTIONS OF PARKING (P2 LEVEL PRIMARILY & RESIDENTIAL AREAS OF P1), FIRST FLOOR RESIDENTIAL AREA & FLOORS 2-4 AS WELL AS ROOF TERRACE TO COMPLY WITH CBC CHAPTER 11A, TYP. AN ACCESSIBLE ROUTE IS PROVIDED AT ALL LEVELS (P2 - ROOF) FOR BOTH INTERIOR & EXTERIOR COMMON-USE RESIDENTIAL AREAS, WITH CHANGES IN LEVEL NOT EXCEEDING $\frac{1}{4}$ " OR BEING PROVIDED WITH A SLOPED WALK NOT EXCEEDING 5%, A RAMP NOT EXCEEDING 8.33%, OR ELEVATOR(S) PER CBC 1111A. PARKING FACILITIES WILL COMPLY WITH CBC 1109A.

INTERIOR ACCESSIBLE ROUTES EXCEEDING 200 FT. SHALL COMPLY WITH CBC 1138A.1.2 / FIGURE 11A-1L.

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SMITH DEVELOPMENT

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	02.07.24	PLANNING RESUBMITTAL #7

PROJECT NUMBER
21003

SHEET TITLE
**PROPOSED PLAN
FOURTH FLOOR**

PROJ
NORTH


SCALE
3/32" = 1'-0"

SHEET NUMBER

A2.3



ARCHITECTS
KORTH SUNSERI HAGEY

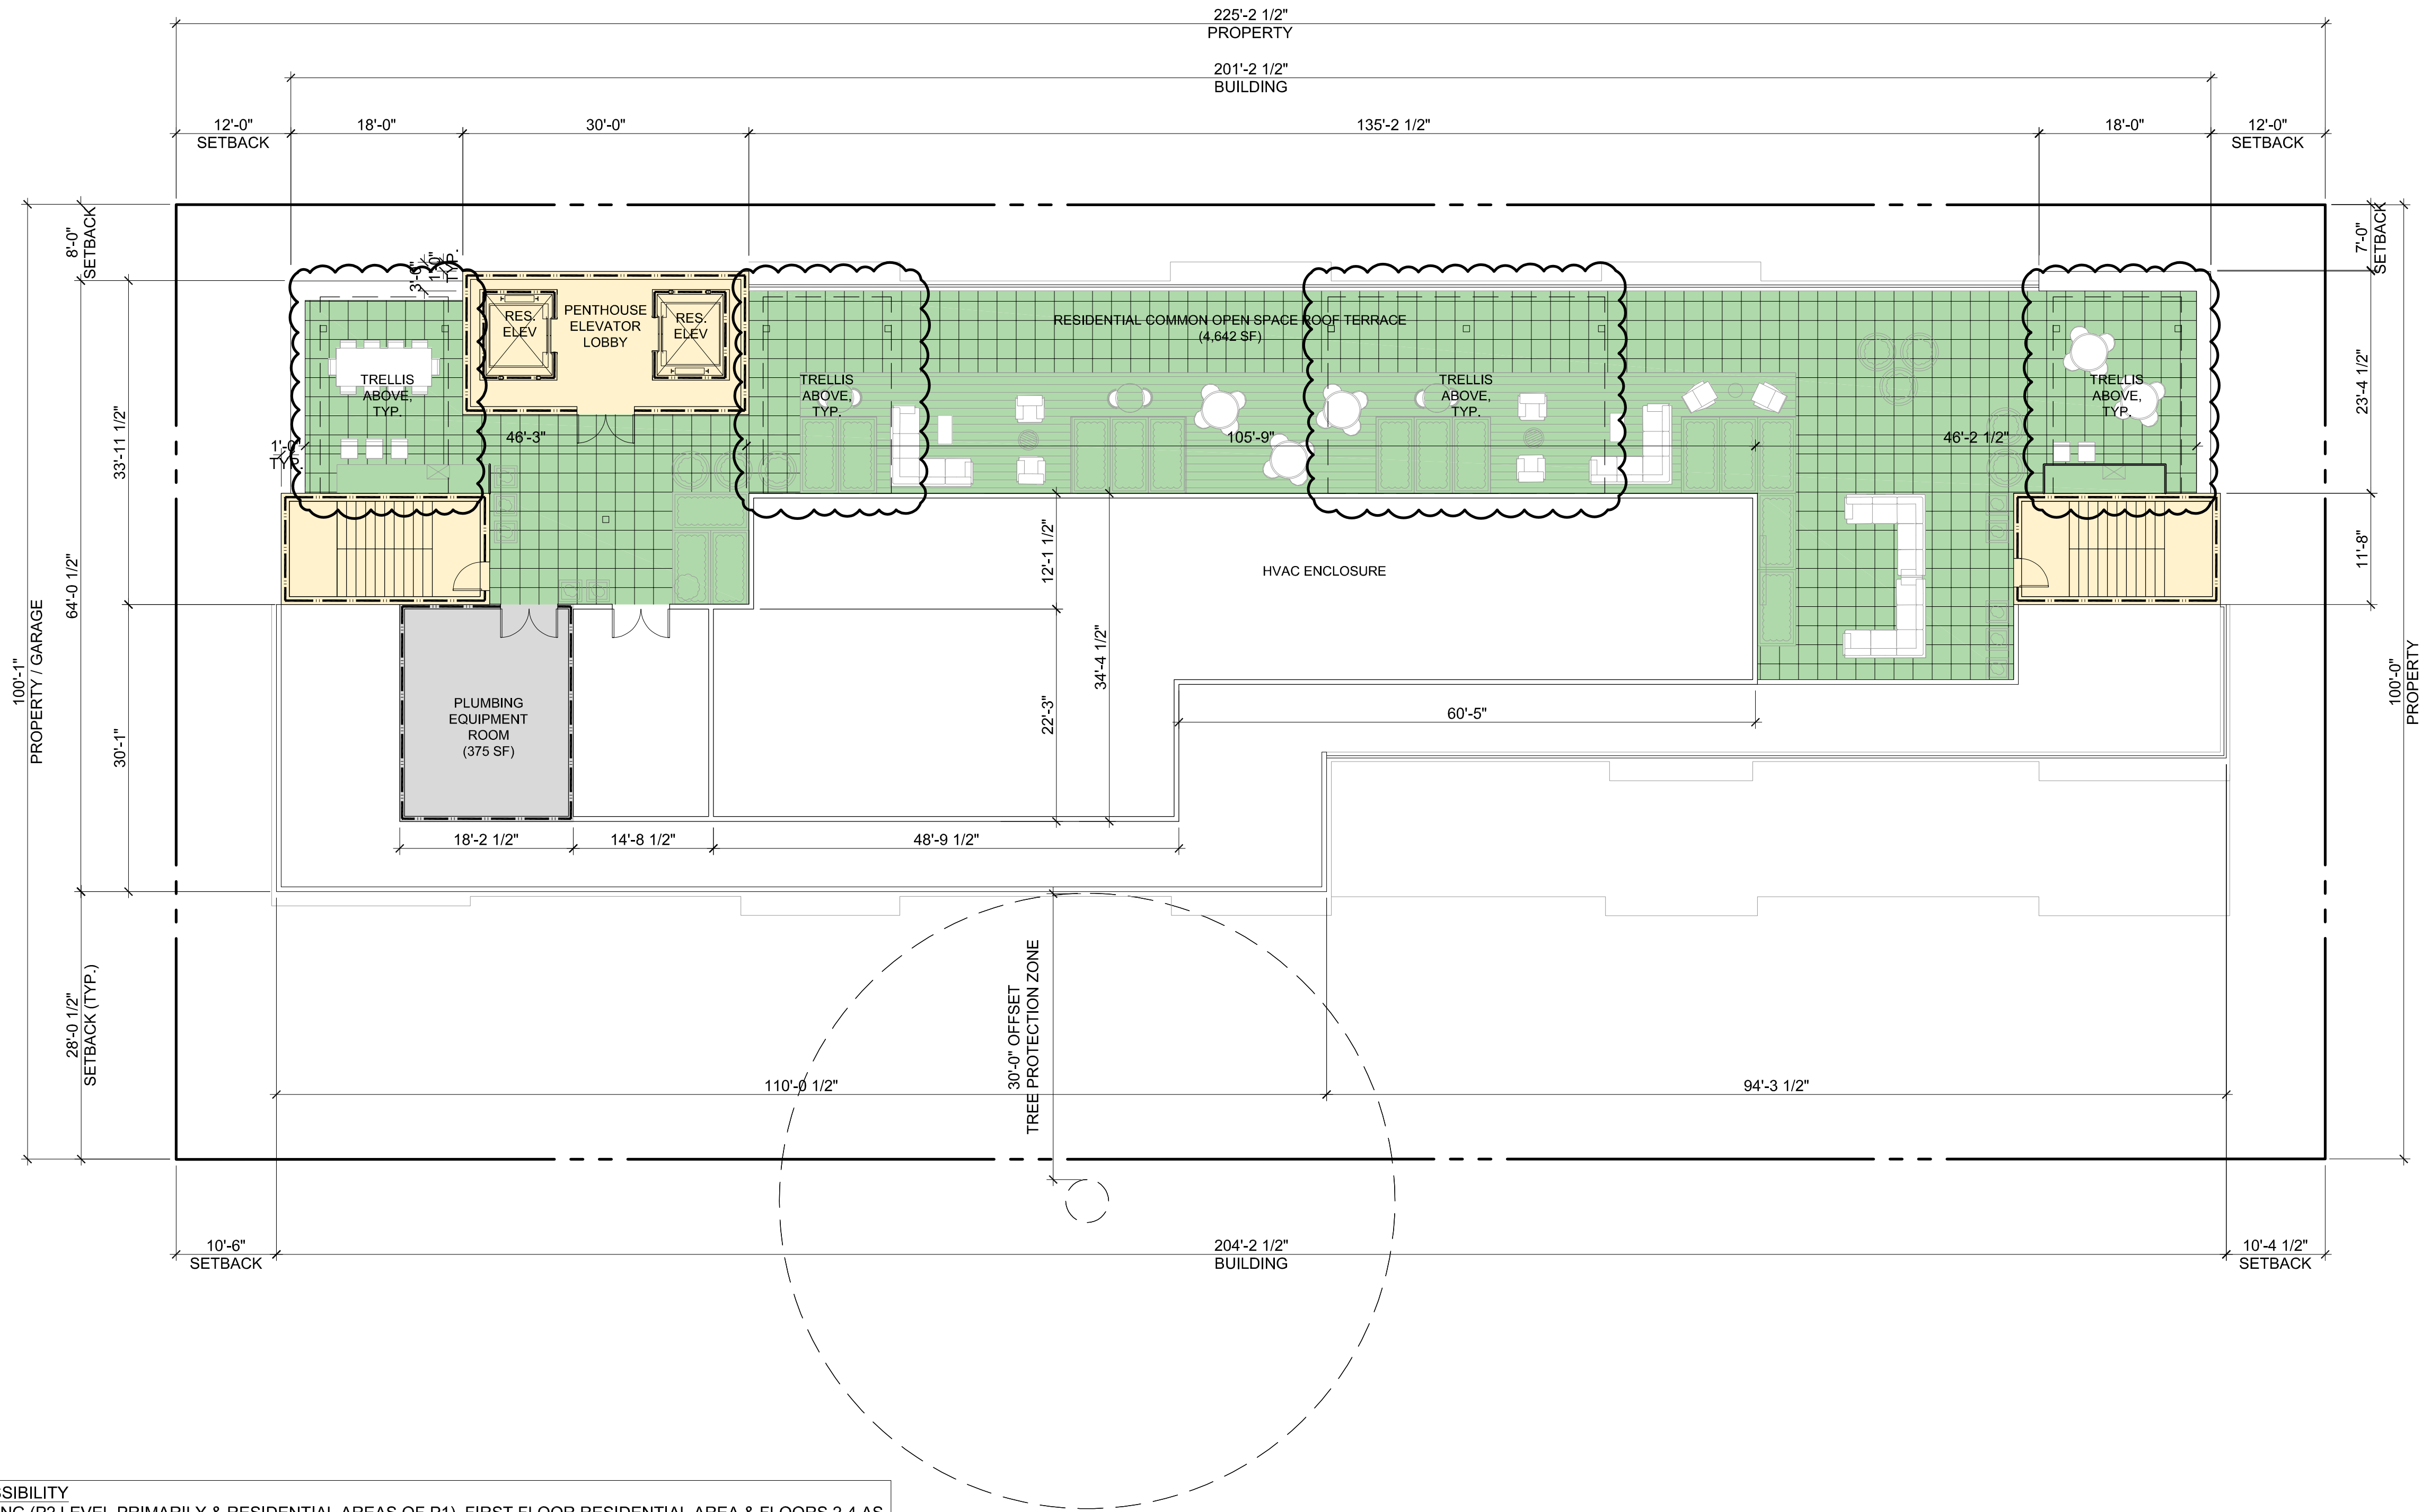

RESIDENTIAL ACCESSIBILITY
PORTIONS OF PARKING (P2 LEVEL PRIMARILY & RESIDENTIAL AREAS OF P1), FIRST FLOOR RESIDENTIAL AREA & FLOORS 2-4 AS WELL AS ROOF TERRACE TO COMPLY WITH CBC CHAPTER 11A, TYP. AN ACCESSIBLE ROUTE IS PROVIDED AT ALL LEVELS (P2 - ROOF) FOR BOTH INTERIOR & EXTERIOR COMMON-USE RESIDENTIAL AREAS, WITH CHANGES IN LEVEL NOT EXCEEDING 1/4" OR BEING PROVIDED WITH A SLOPED WALK NOT EXCEEDING 5%, A RAMP NOT EXCEEDING 8.33%, OR ELEVATOR(S) PER CBC 1111A. PARKING FACILITIES WILL COMPLY WITH CBC 1109A.


INTERIOR ACCESSIBLE ROUTES EXCEEDING 200 FT. SHALL COMPLY WITH CBC 1138A.1.2 / FIGURE 11A-1L.


ALL UNITS, INCLUDING PRIVATE OUTDOOR BALCONIES / TERRACES WILL BE EITHER ACCESSIBLE OR ADAPTABLE INCLUDING KITCHEN AND AT LEAST ONE BATHROOM, PER CBC 11A. THIS INCLUDES DOORS, PATH OF TRAVEL, APPLIANCE / FIXTURE CLEARANCES AS WELL AS ANY OTHER LIFE-SAFETY REQUIREMENTS.

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10.31.23		PLANNING RESUBMITTAL #5
12.21.23		PLANNING RESUBMITTAL #6
02.07.24		PLANNING RESUBMITTAL #7


PROJECT NUMBER
21003

SHEET TITLE
**PROPOSED PLAN
ROOF**

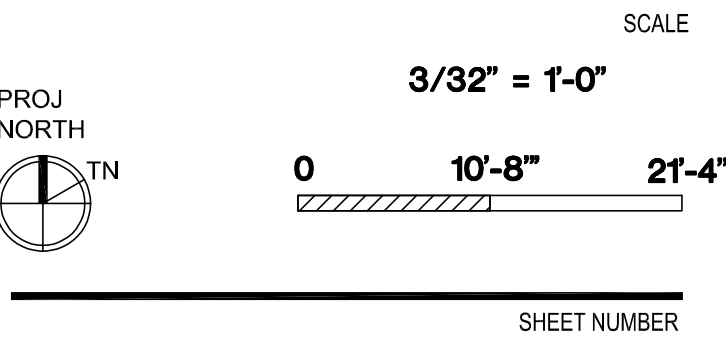


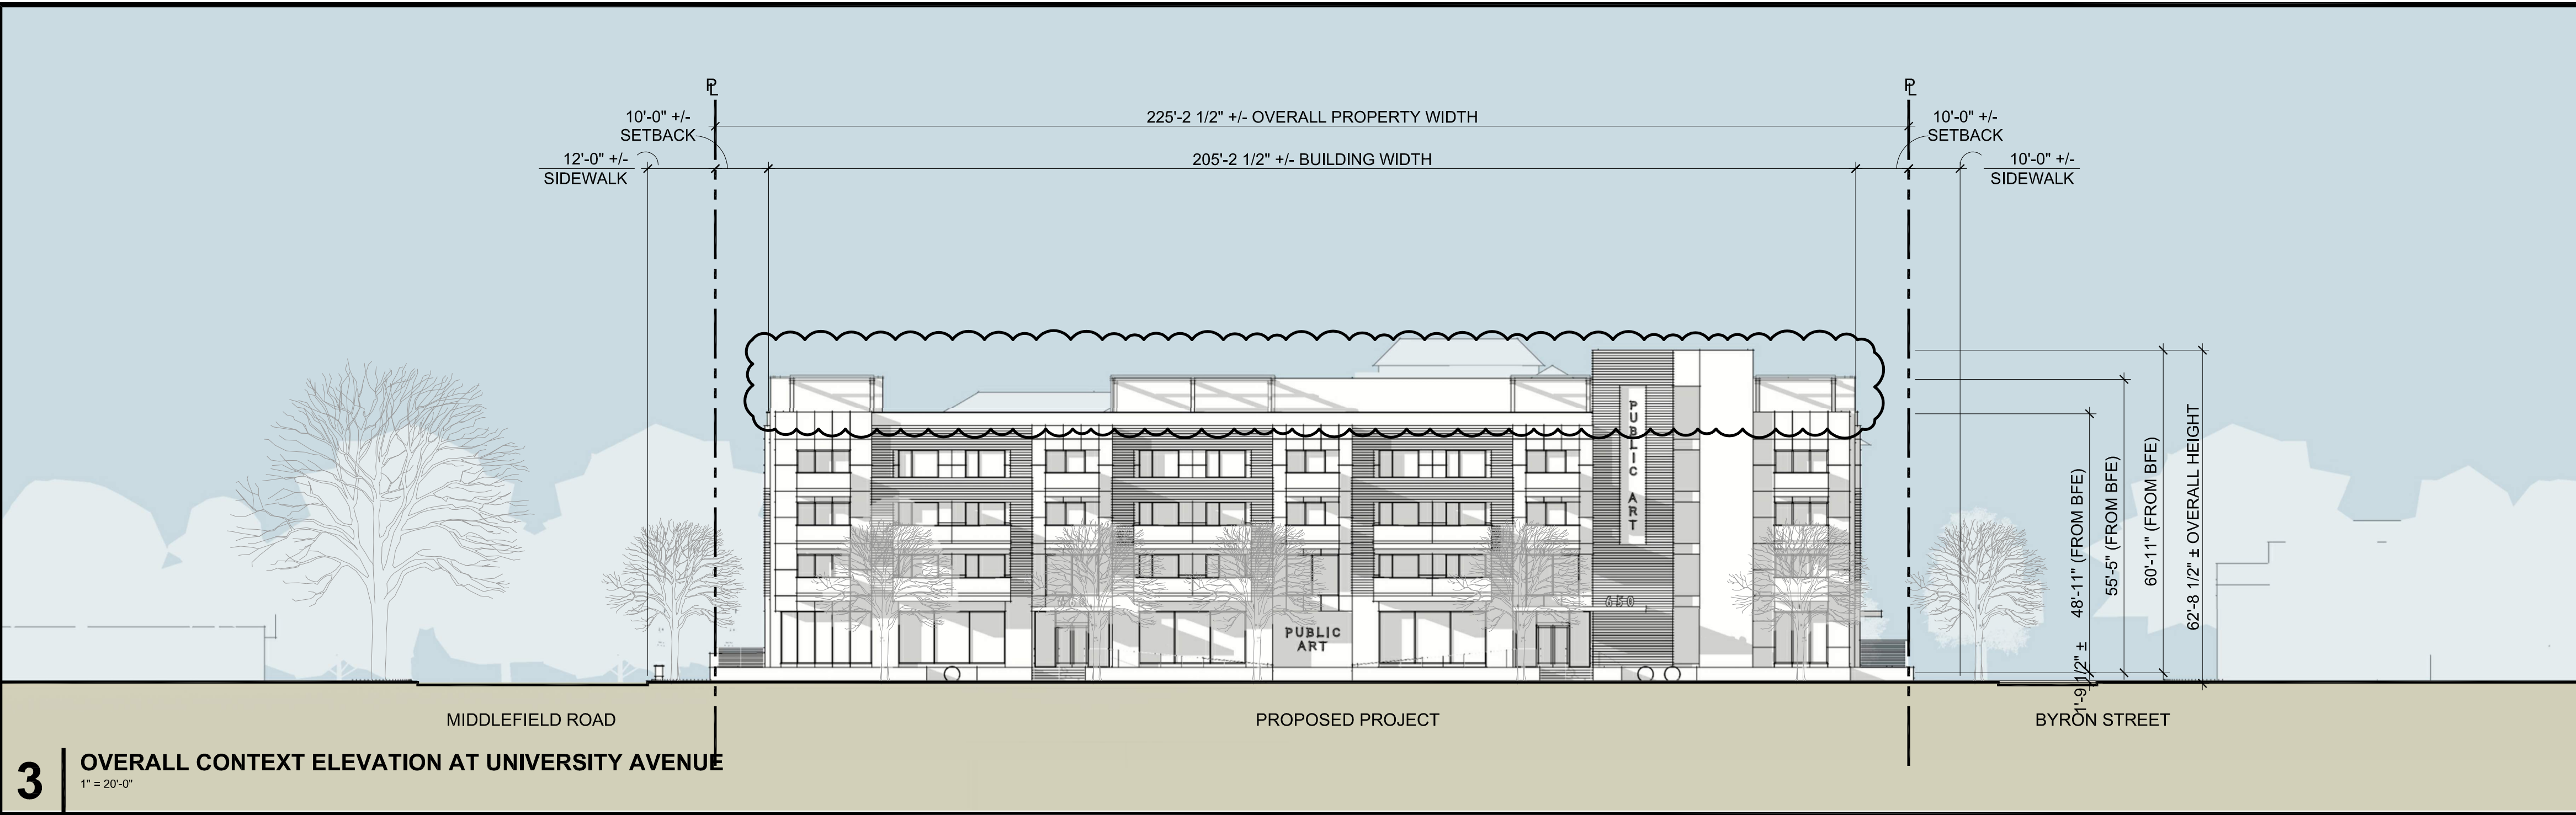

3 OVERALL CONTEXT ELEVATION AT UNIVERSITY AVENUE
1" = 20'-0"

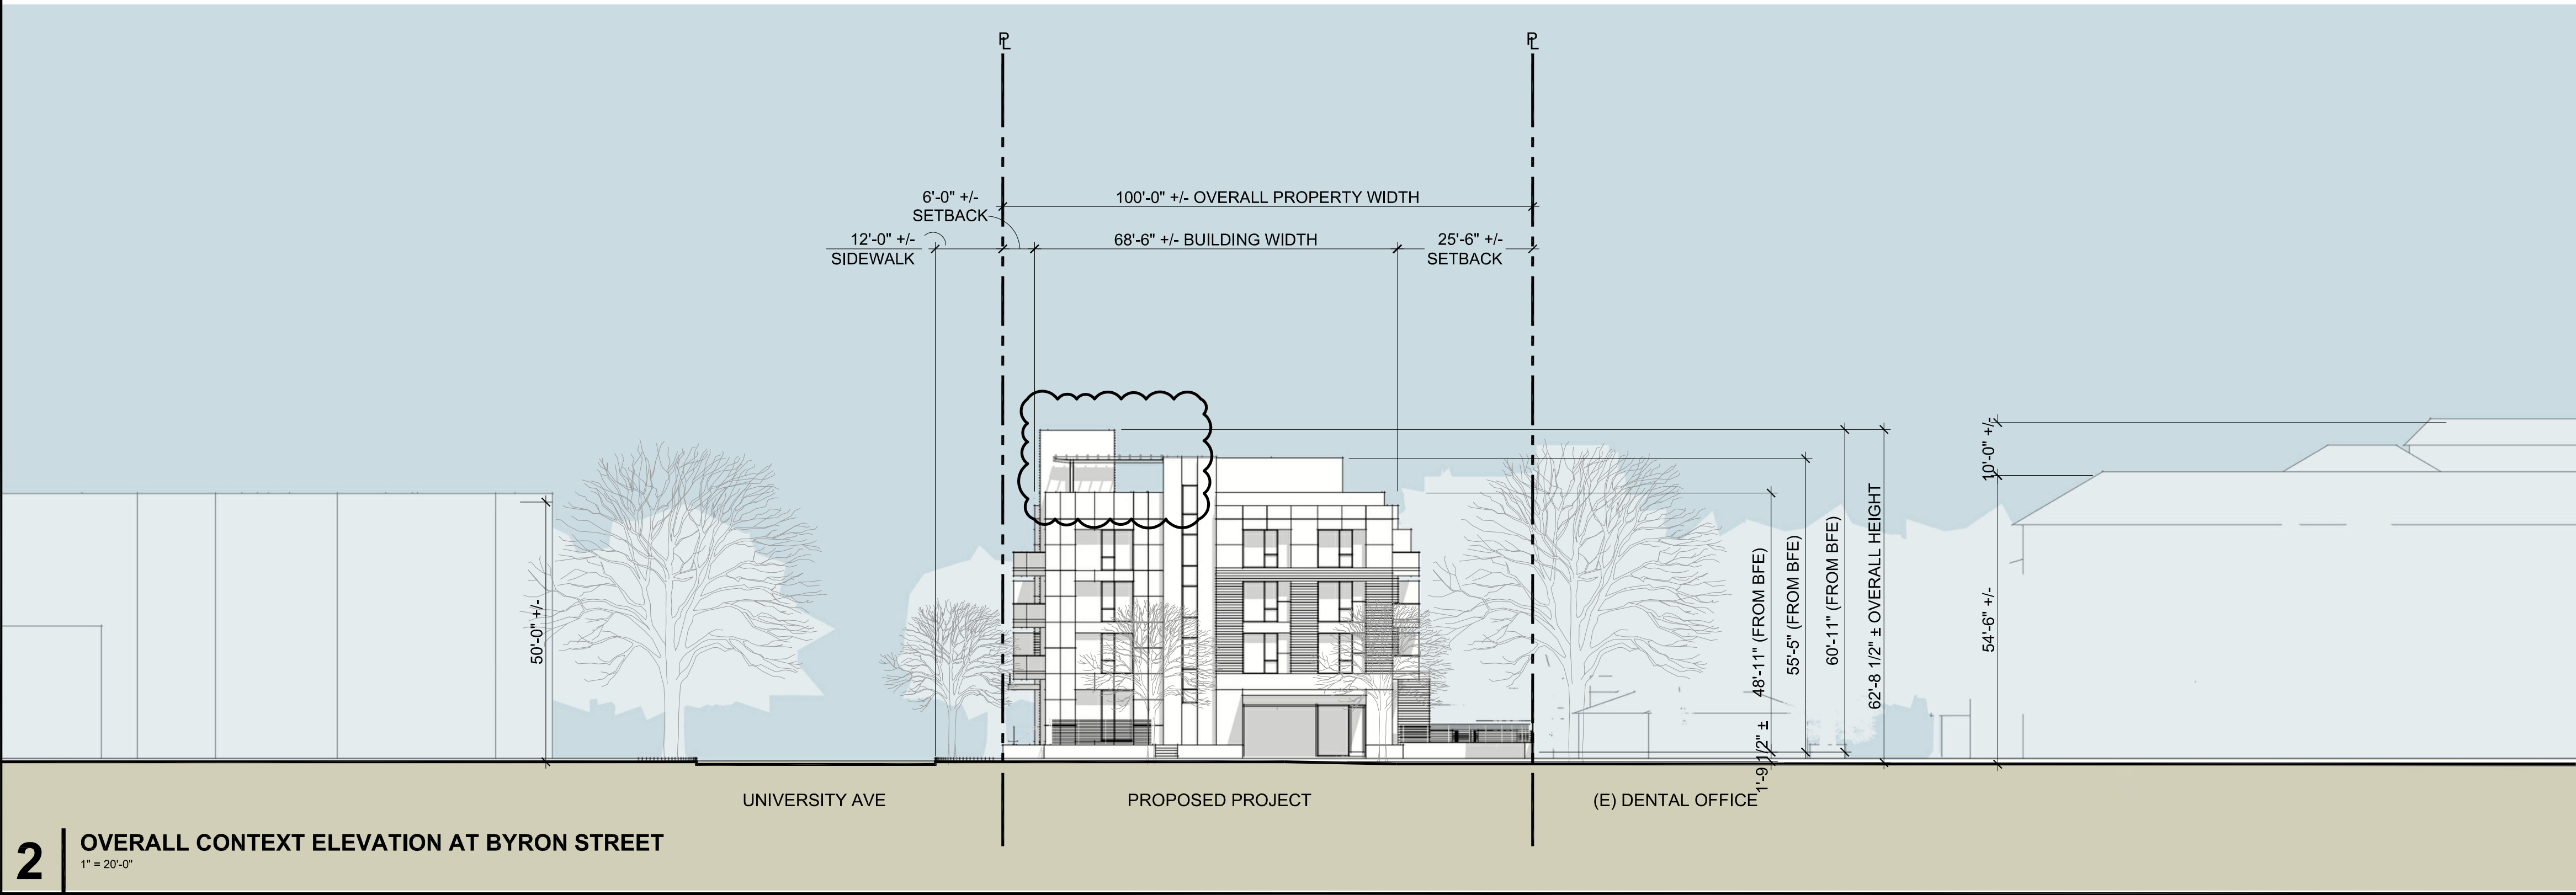

2 OVERALL CONTEXT ELEVATION AT BYRON STREET
1" = 20'-0"

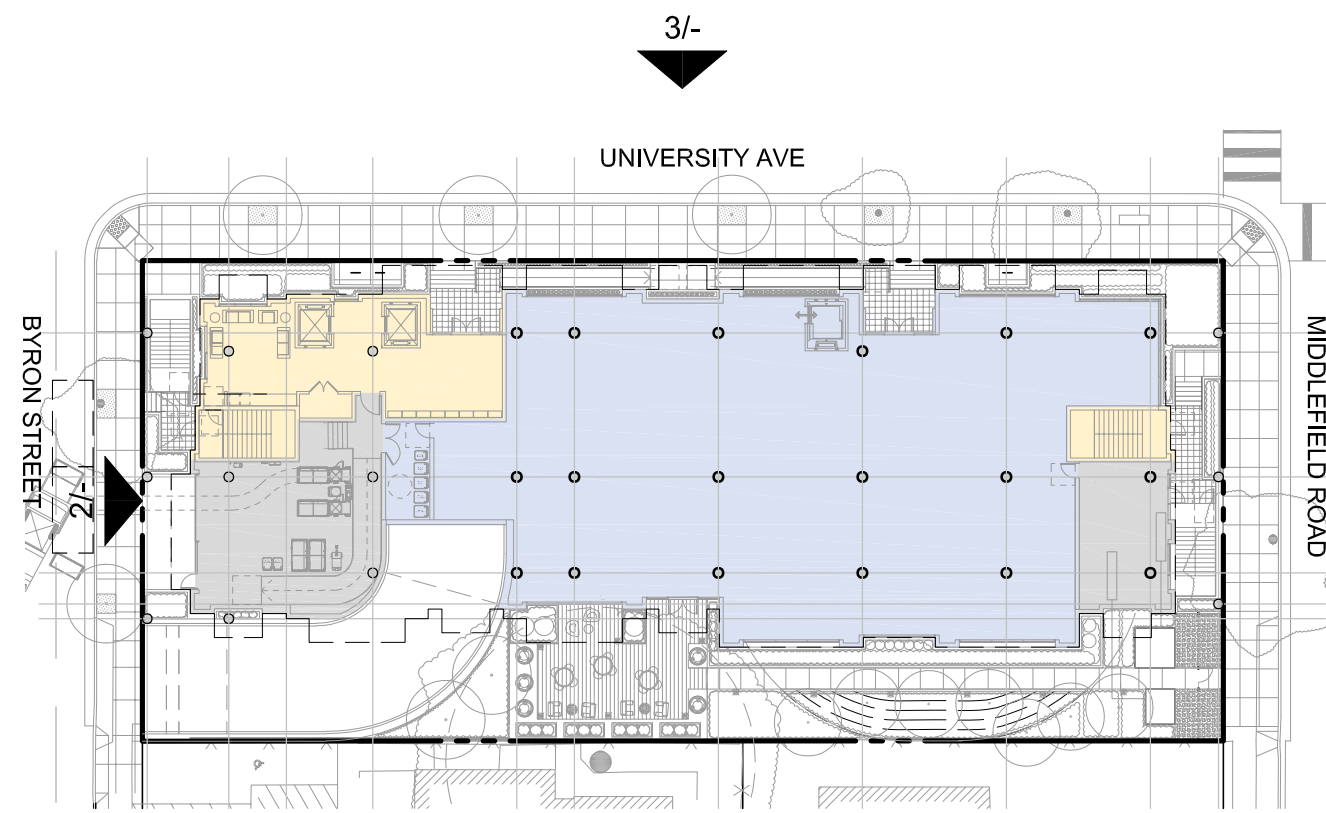

1 KEY PLAN - PROPOSED SITE
1/64" = 1'-0"

SMITH DEVELOPMENT

660 UNIVERSITY
PALO ALTO, CA 94301



ISSUES AND REVISIONS		
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10.31.23		PLANNING RESUBMITTAL #5
12.21.23		PLANNING RESUBMITTAL #6
02.07.24		PLANNING RESUBMITTAL #7

PROJECT NUMBER
21003

SHEET TITLE
PROPOSED STREET ELEVATIONS
NEIGHBORHOOD CONTEXT

SCALE
AS NOTED
PROJ. N
TRUE N
SHEET NUMBER

A3.0



ISSUES AND REVISIONS		
NO.	DATE	DESCRIPTION
	12.01.21	PLANNING SUBMITTAL
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	02.07.24	PLANNING RESUBMITTAL #7

PROJECT NUMBER
21003

SHEET TITLE
PROPOSED ELEVATIONS

SCALE
AS NOTED




SHEET NUMBER


A3.1A




3 WEST ELEVATION (BYRON STREET)
3/32" = 1'-0"

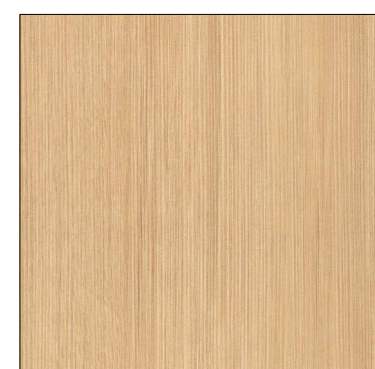


WOOD TEXTURE PANEL,
COLOR 'A'
SECOND, THIRD AND
FOURTH FLOOR FACADES, TYP.

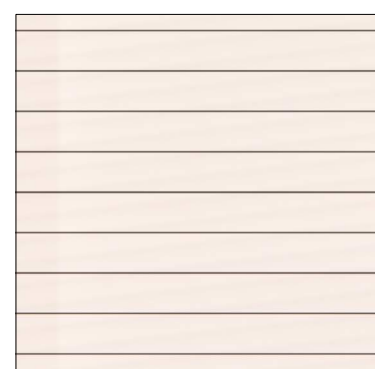


PAINTED HORIZONTAL
SIDING PANEL, COLOR 'B'
SECOND, THIRD AND
FOURTH FLOOR FACADES, TYP.

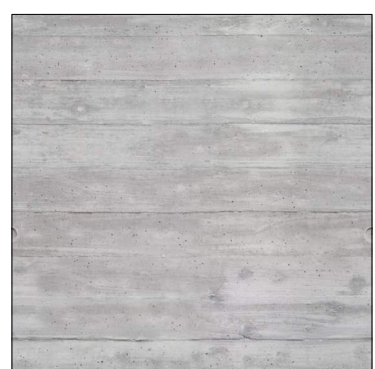

INTEGRAL COLOR
BOARD FORM PRECAST
COLOR 'C'
GROUND FLOOR FACADES, TYP.

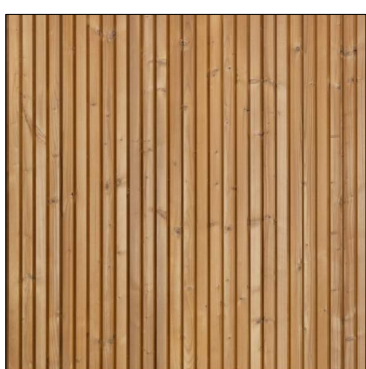


WOOD SLATS COLOR 'D'
ROOF MECH. SCREEN, TRELLIS
WOOD SLATS

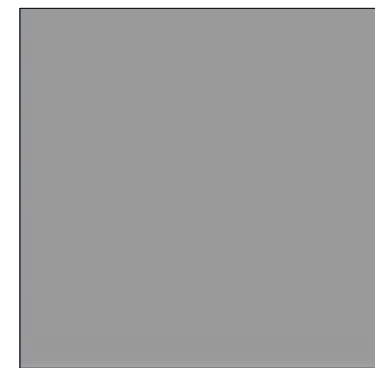


PAINTED METAL, COLOR 'E'
WINDOW MULLIONS, CANOPIES,
METAL PANELS AT SECOND, THIRD,
& FOURTH FLOOR FACADES, TYP.



PAINTED METAL, COLOR 'F'
ROOF MECH. SCREEN, ROOF
PARAPET, TRELLIS STRUCTURE,
METAL PANELS AT THIRD &
FOURTH FLOOR FACADES, TYP.

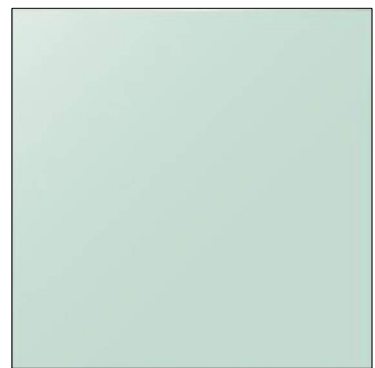


LOW-IRON VISION GLASS
CLEAR VISION GLASS, TYP.

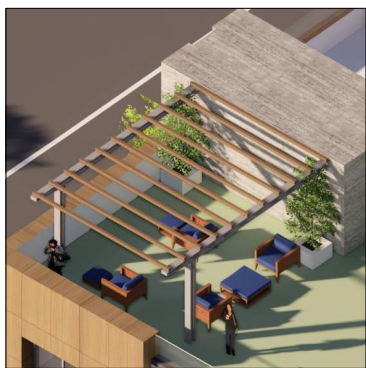

PAINTED TRELLIS STRUCTURE
WITH SLATS

2 MATERIAL SWATCHES
NO SCALE

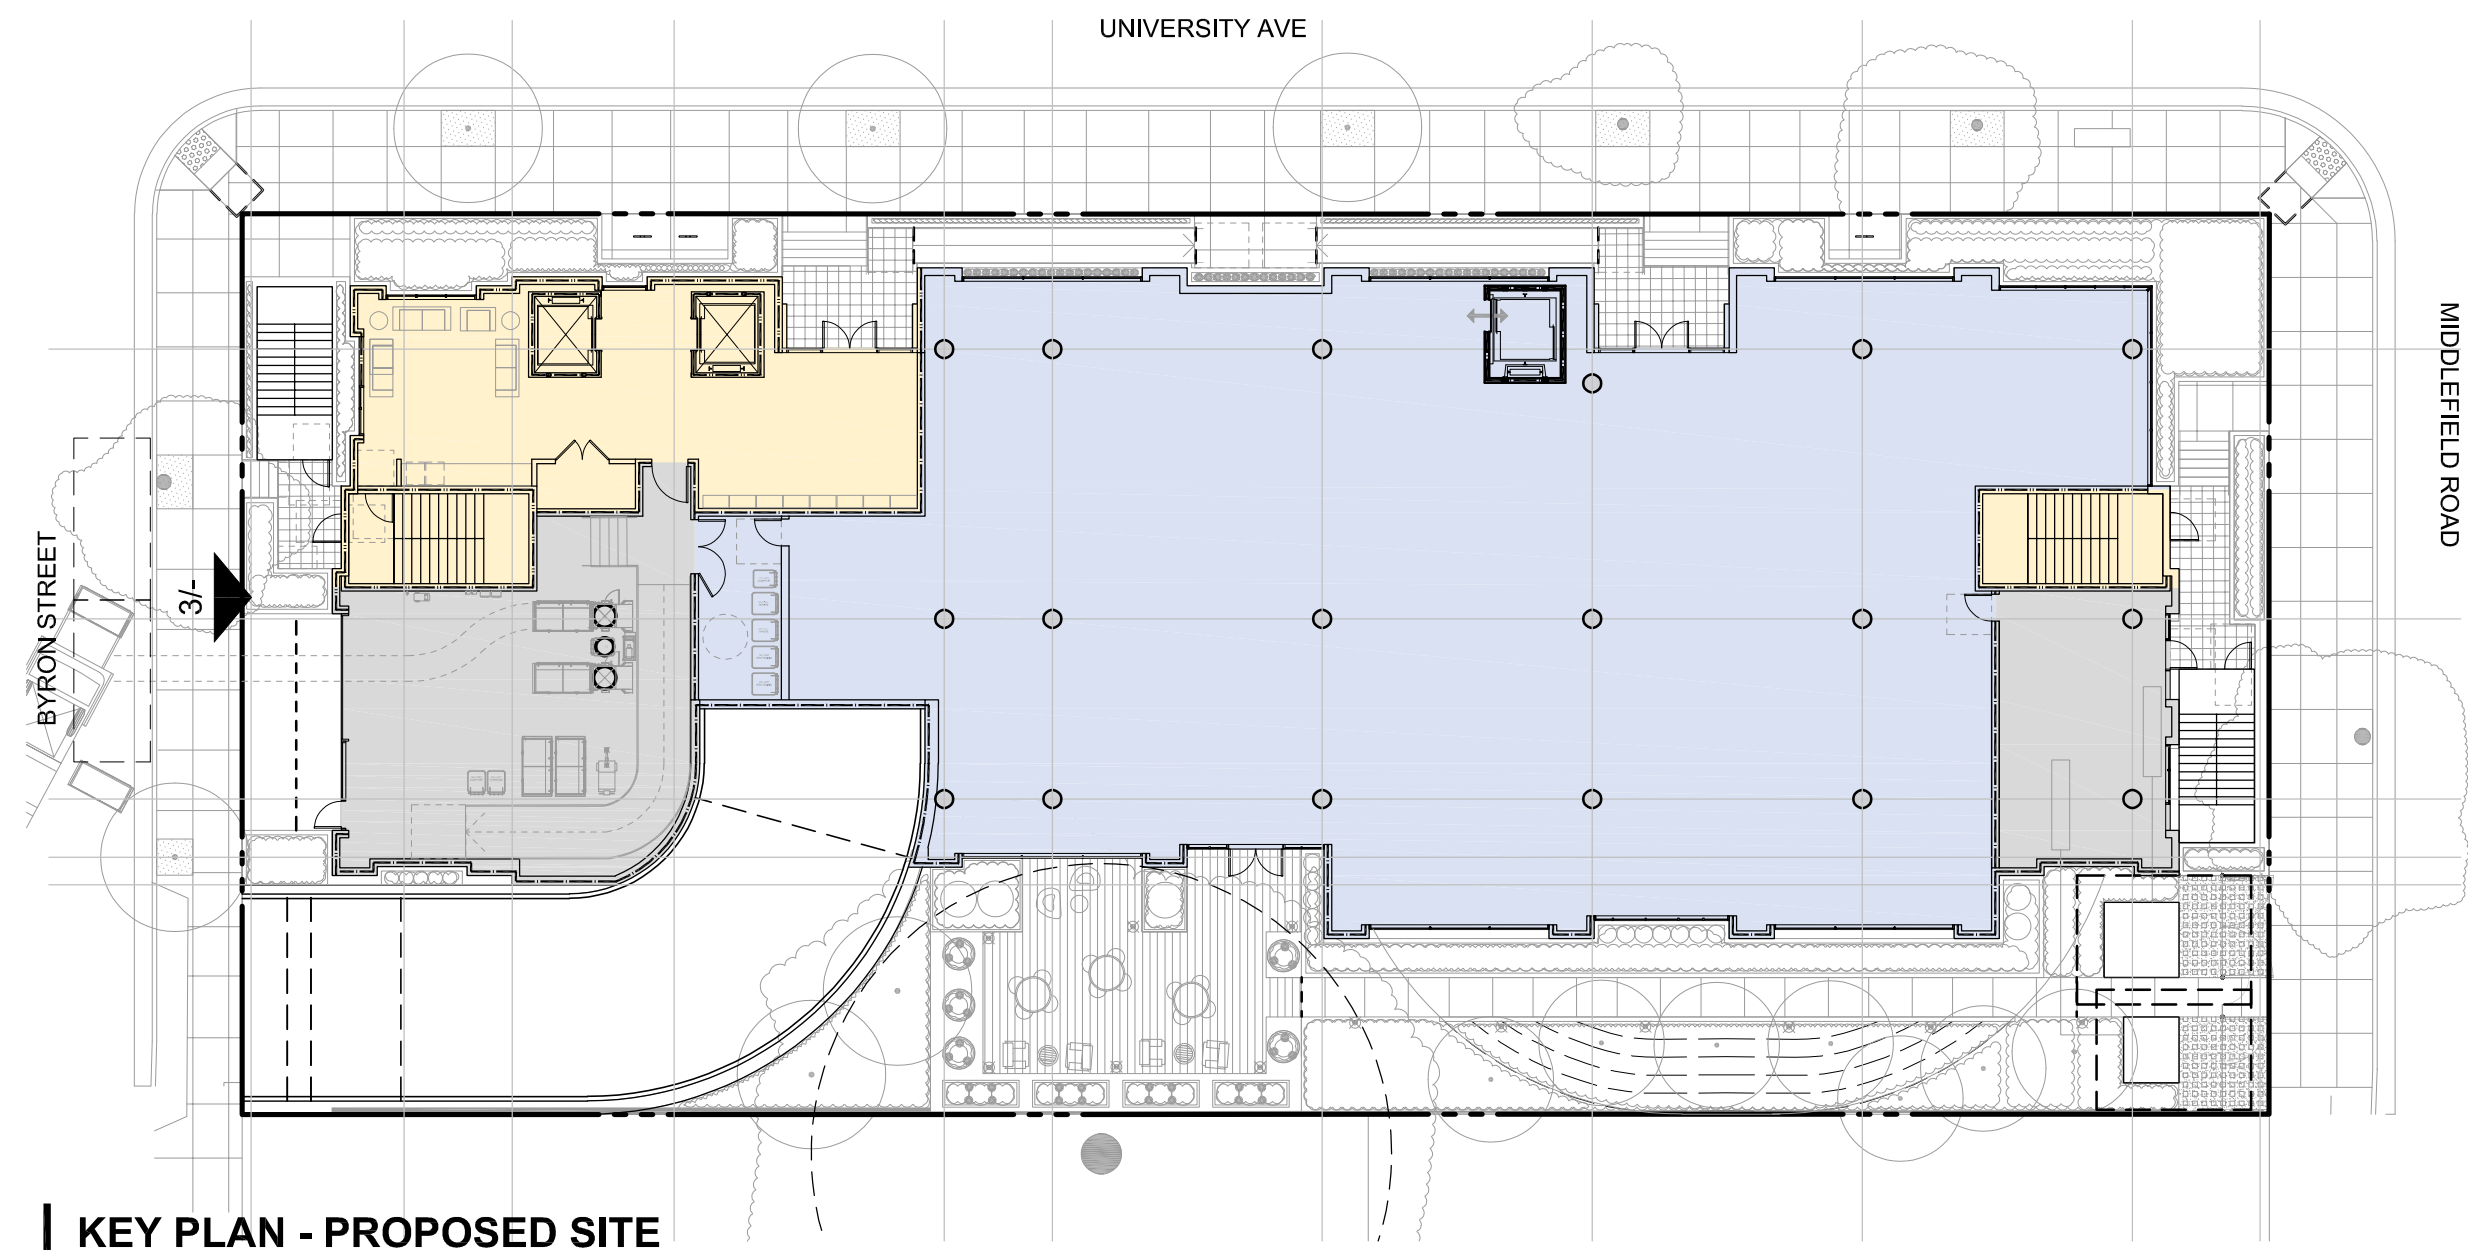

1 KEY PLAN - PROPOSED SITE
3/128" = 1'-0"



ISSUES AND REVISIONS		
NO.	DATE	DESCRIPTION
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	02.07.24	PLANNING RESUBMITTAL #7

PROJECT NUMBER
21003

SHEET TITLE
PROPOSED ELEVATIONS

SCALE
AS NOTED




SHEET NUMBER

A3.1B




3 EAST ELEVATION

3/32" = 1'-0"

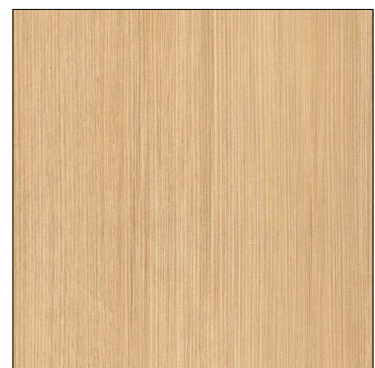

WOOD TEXTURE PANEL,
COLOR 'A'
SECOND, THIRD AND
FOURTH FLOOR FACADES, TYP.

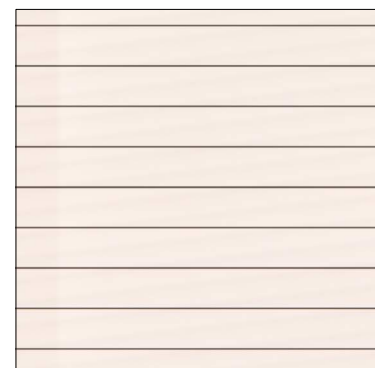


PAINTED HORIZONTAL
SIDING PANEL, COLOR 'B'
SECOND, THIRD AND
FOURTH FLOOR FACADES, TYP.



INTEGRAL COLOR
BOARD FORM PRECAST
COLOR 'C'
GROUND FLOOR FACADES, TYP.



WOOD SLATS COLOR 'D'
ROOF MECH. SCREEN, TRELLIS
WOOD SLATS

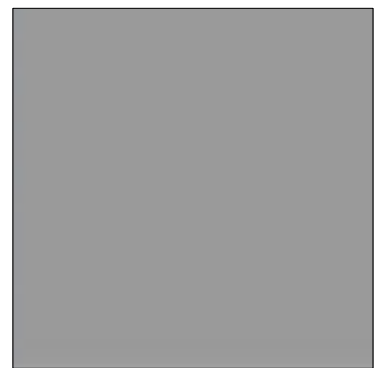


PAINTED METAL, COLOR 'E'
WINDOW MULLIONS, CANOPIES,
METAL PANELS AT SECOND, THIRD,
& FOURTH FLOOR FACADES, TYP.



PAINTED METAL, COLOR 'F'
ROOF MECH. SCREEN, ROOF
PARAPET, TRELLIS STRUCTURE,
METAL PANELS AT THIRD &
FOURTH FLOOR FACADES, TYP.




LOW-IRON VISION GLASS
CLEAR VISION GLASS, TYP.

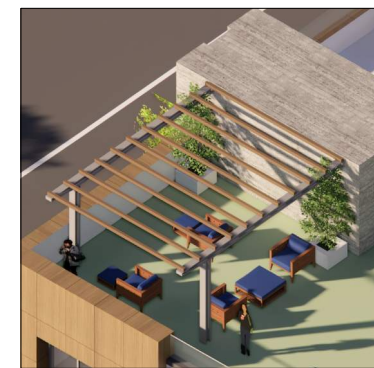

PAINTED TRELLIS STRUCTURE
WITH SLATS

2 MATERIAL SWATCHES

NO SCALE

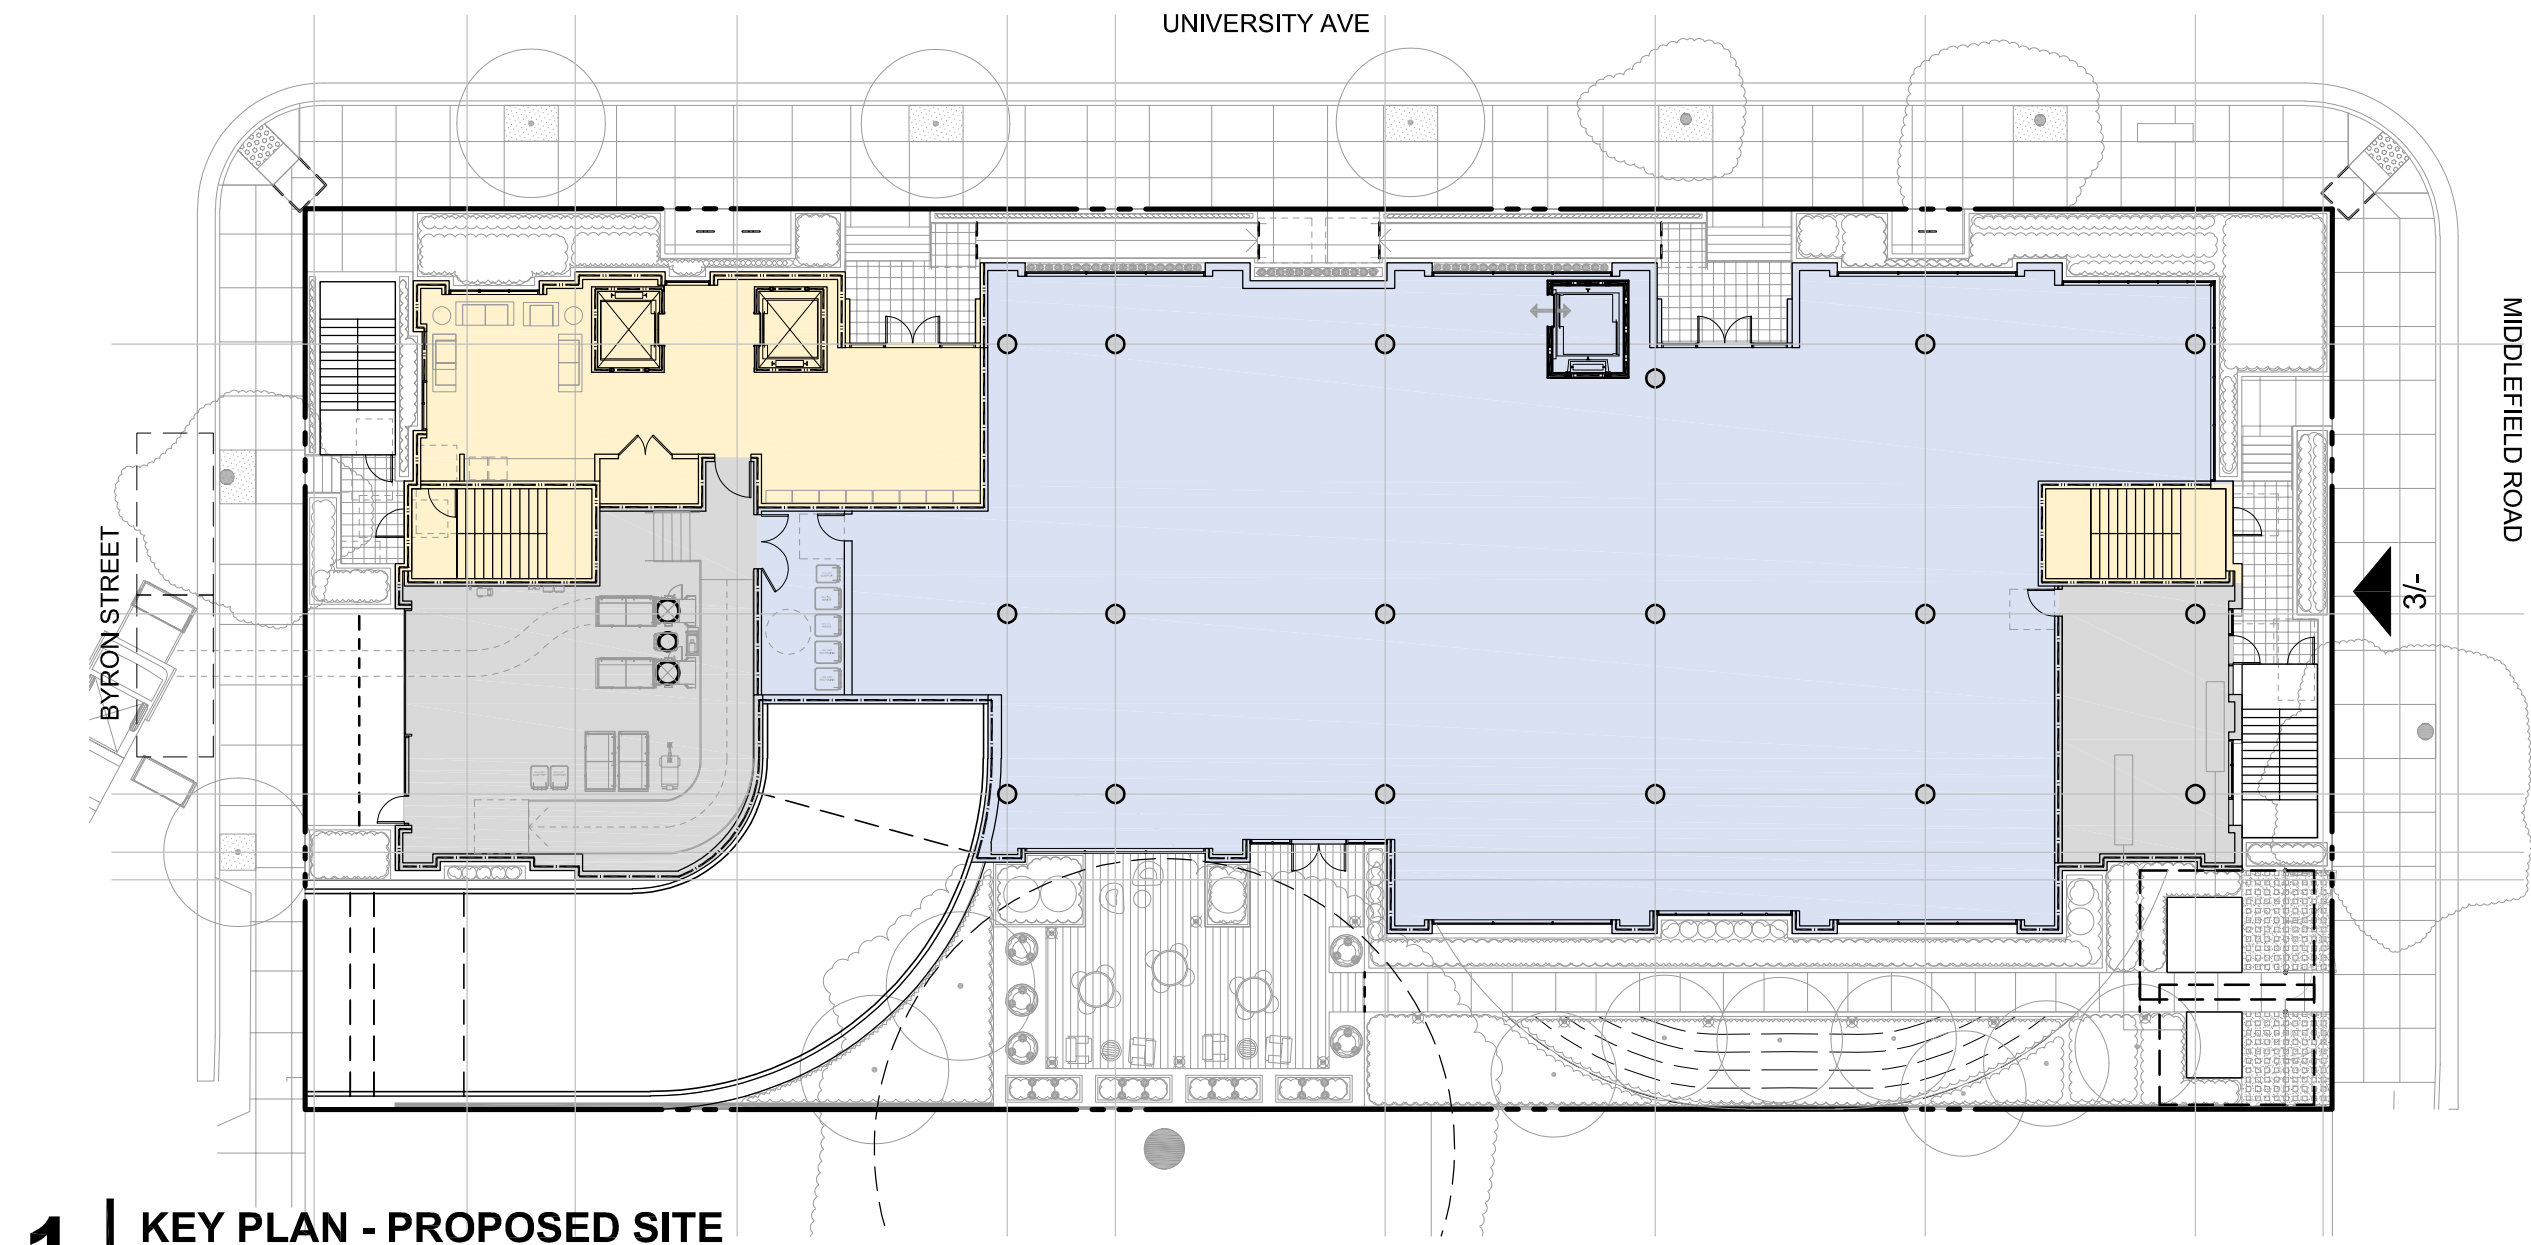

1 KEY PLAN - PROPOSED SITE

3/128" = 1'-0"



ARCHITECTS
KORTH SUNSERI HAGEY

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PROJECT NUMBER
21003

SHEET TITLE
PROPOSED ELEVATIONS

SCALE
AS NOTED




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A3.2A




3 SOUTH ELEVATION


3/32" = 1'-0"

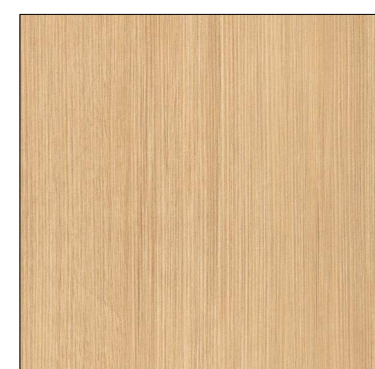

WOOD TEXTURE PANEL,
COLOR 'A'
SECOND, THIRD AND
FOURTH FLOOR FACADES, TYP.

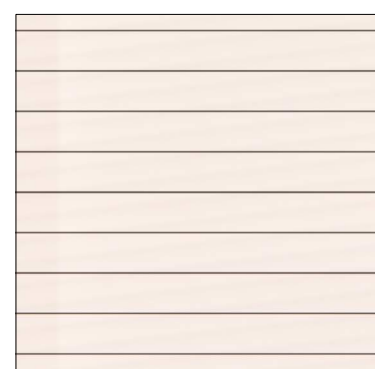


PAINTED HORIZONTAL
SIDING PANEL, COLOR 'B'
SECOND, THIRD AND
FOURTH FLOOR FACADES, TYP.

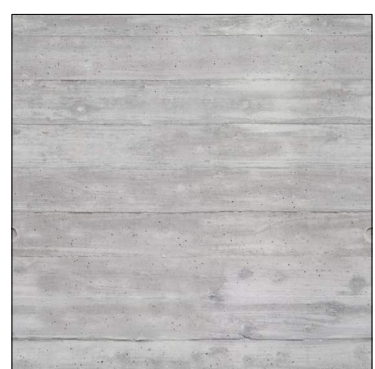

INTEGRAL COLOR
BOARD FORM PRECAST
COLOR 'C'
GROUND FLOOR FACADES, TYP.




WOOD SLATS COLOR 'D'
ROOF MECH. SCREEN, TRELLIS
WOOD SLATS

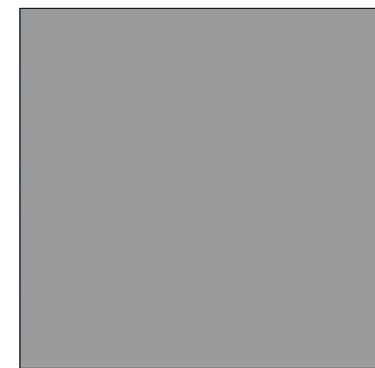


PAINTED METAL, COLOR 'E'
WINDOW MULLIONS, CANOPIES,
METAL PANELS AT SECOND, THIRD,
& FOURTH FLOOR FACADES, TYP.



PAINTED METAL, COLOR 'F'
ROOF MECH. SCREEN, ROOF
PARAPET, TRELLIS STRUCTURE,
METAL PANELS AT THIRD &
FOURTH FLOOR FACADES, TYP.

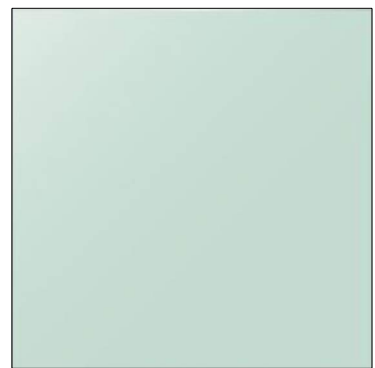


LOW-IRON VISION GLASS
CLEAR VISION GLASS, TYP.

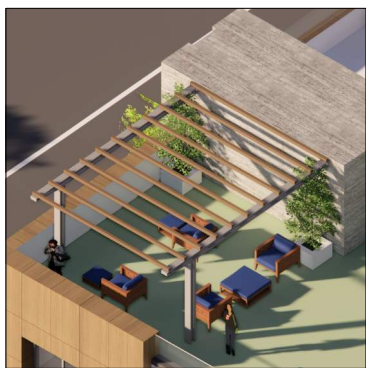

PAINTED TRELLIS STRUCTURE
WITH SLATS

2 MATERIAL SWATCHES

NO SCALE

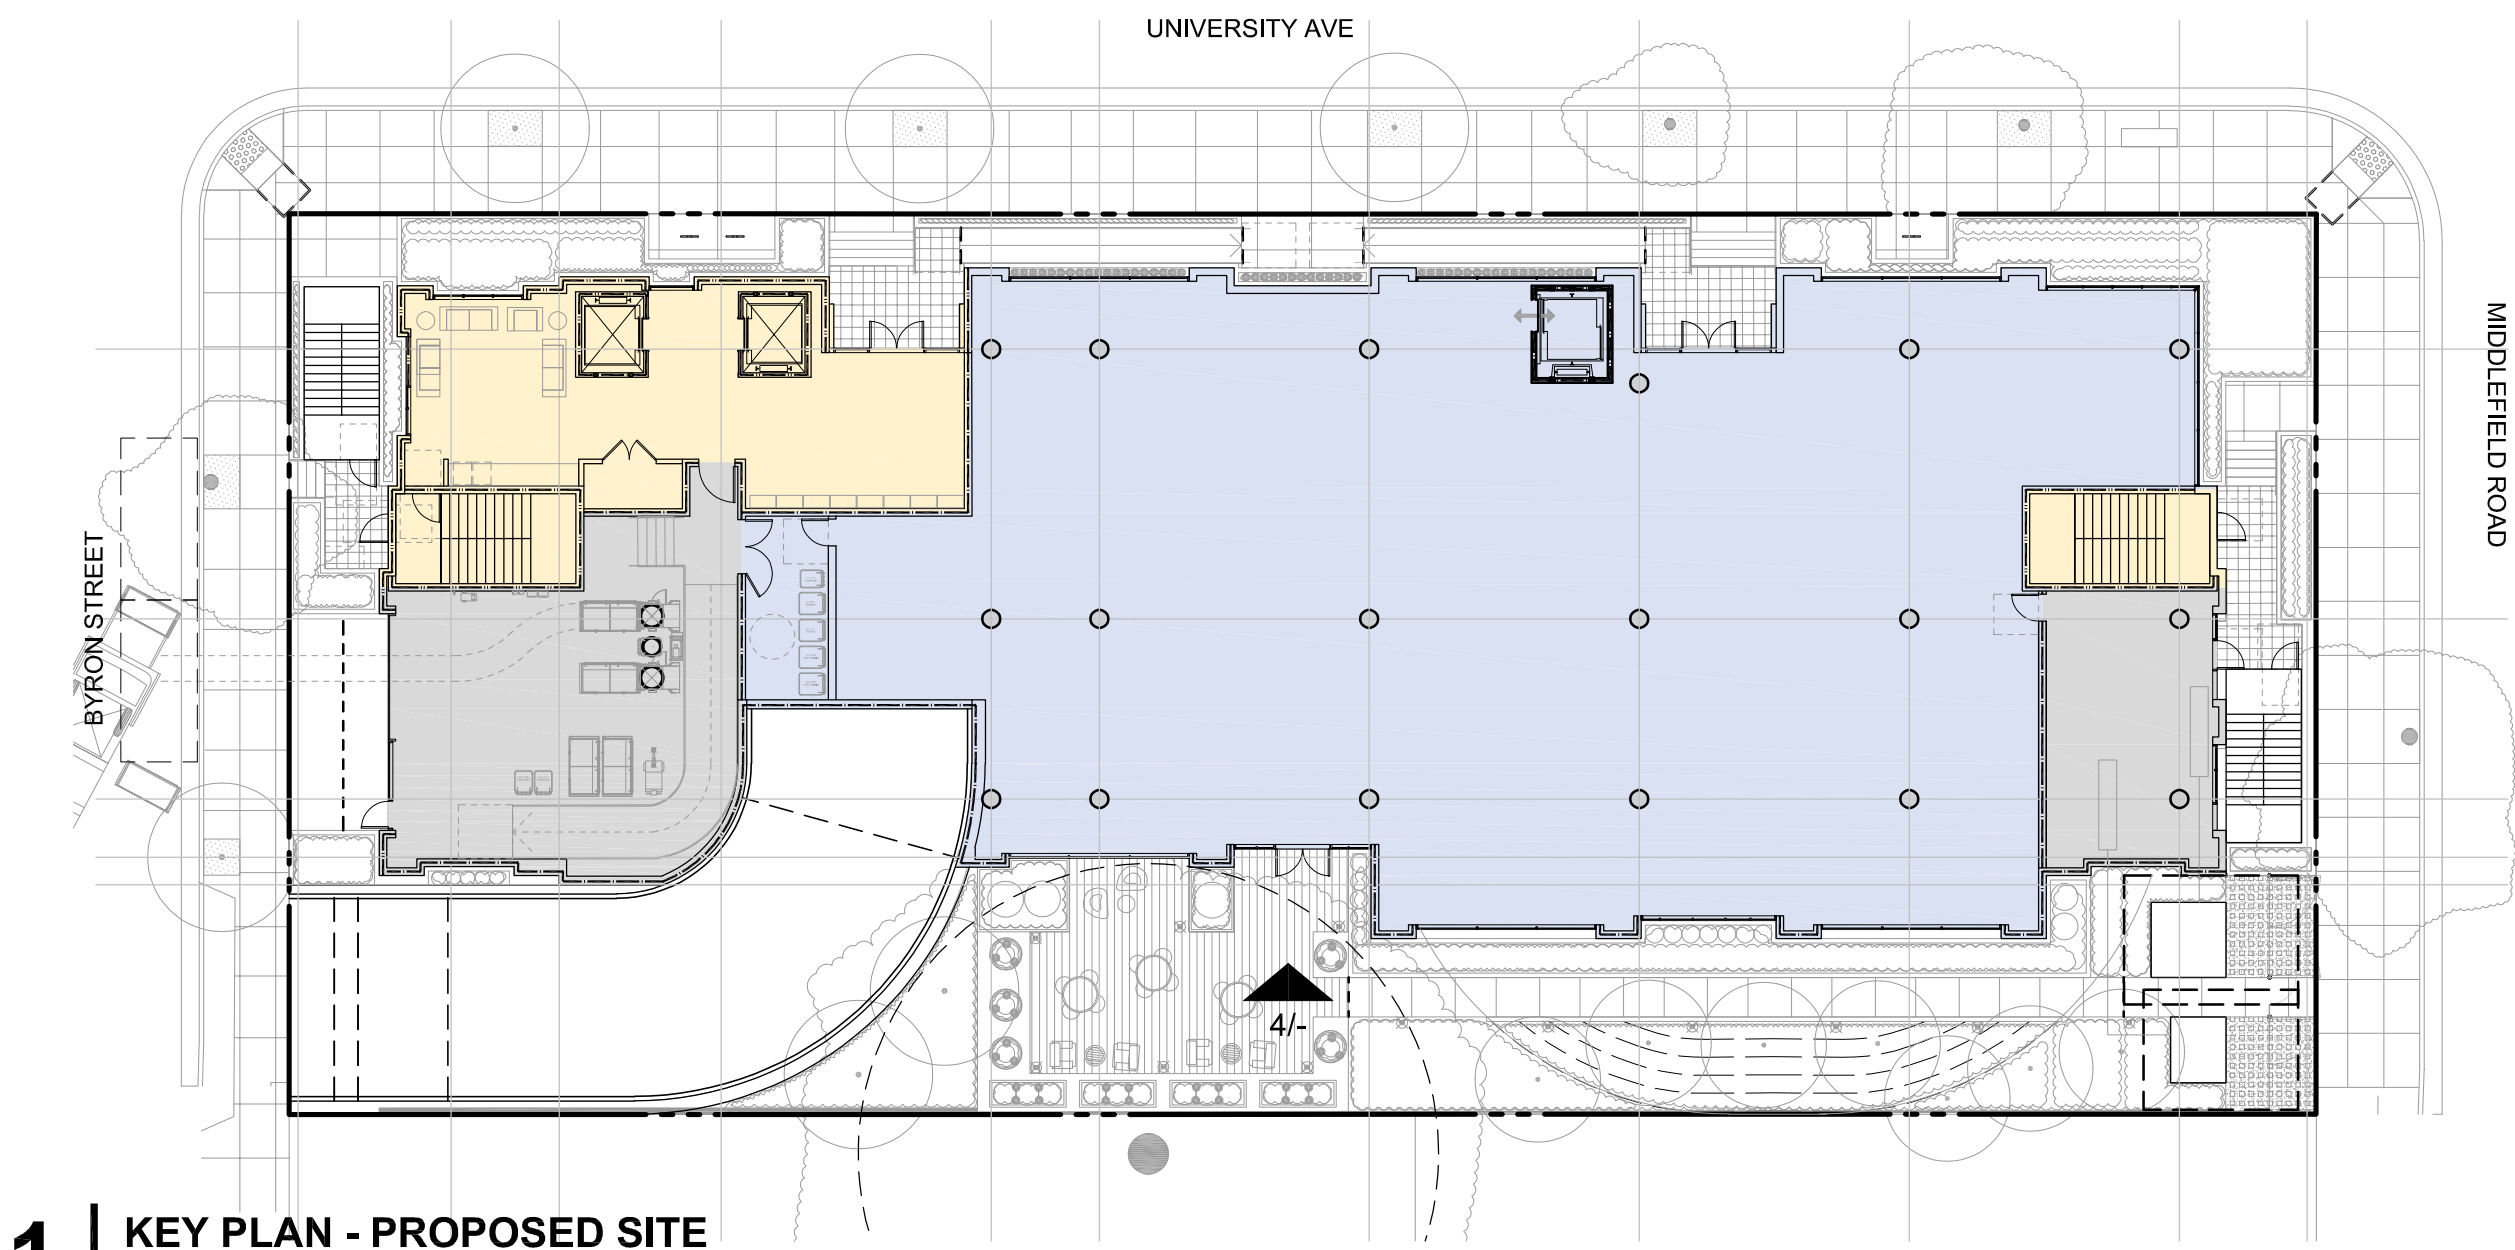

1 KEY PLAN - PROPOSED SITE

3/128" = 1'-0"



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SHEET TITLE
PROPOSED ELEVATIONS

SCALE
AS NOTED




SHEET NUMBER

A3.2B




3 NORTH ELEVATION (UNIVERSITY AVE)

3/32" = 1'-0"

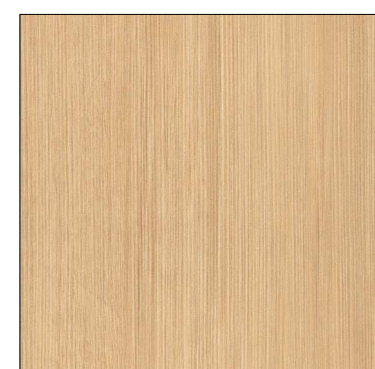

WOOD TEXTURE PANEL,
COLOR 'A'
SECOND, THIRD AND
FOURTH FLOOR FACADES, TYP.

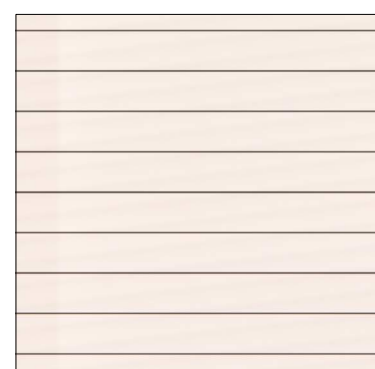


PAINTED HORIZONTAL
SIDING PANEL, COLOR 'B'
SECOND, THIRD AND
FOURTH FLOOR FACADES, TYP.




INTEGRAL COLOR
BOARD FORM PRECAST
COLOR 'C'
GROUND FLOOR FACADES, TYP.




WOOD SLATS COLOR 'D'
ROOF MECH. SCREEN, TRELLIS
WOOD SLATS

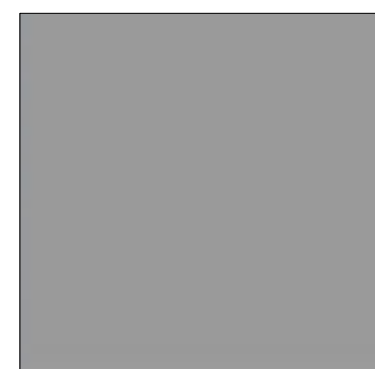


PAINTED METAL, COLOR 'E'
WINDOW MULLIONS, CANOPIES,
METAL PANELS AT SECOND, THIRD,
& FOURTH FLOOR FACADES, TYP.

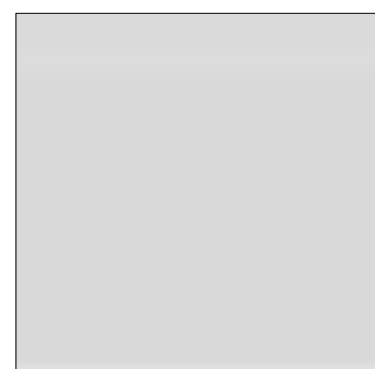

PAINTED METAL, COLOR 'F'
ROOF MECH. SCREEN, ROOF
PARAPET, TRELLIS STRUCTURE,
METAL PANELS AT THIRD &
FOURTH FLOOR FACADES, TYP.

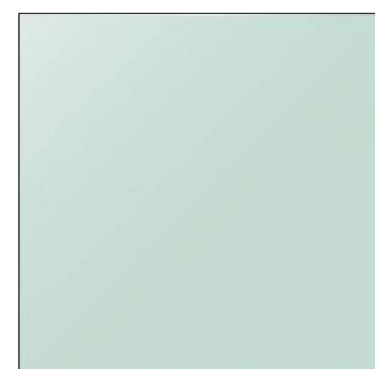


LOW-IRON VISION GLASS
CLEAR VISION GLASS, TYP.

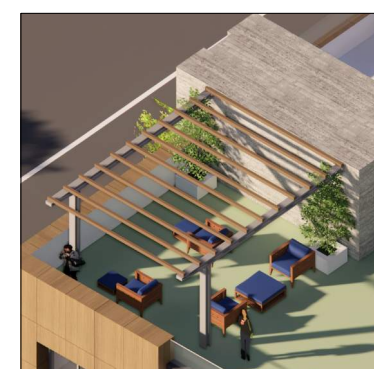

PAINTED TRELLIS STRUCTURE
WITH SLATS


2 MATERIAL SWATCHES

NO SCALE

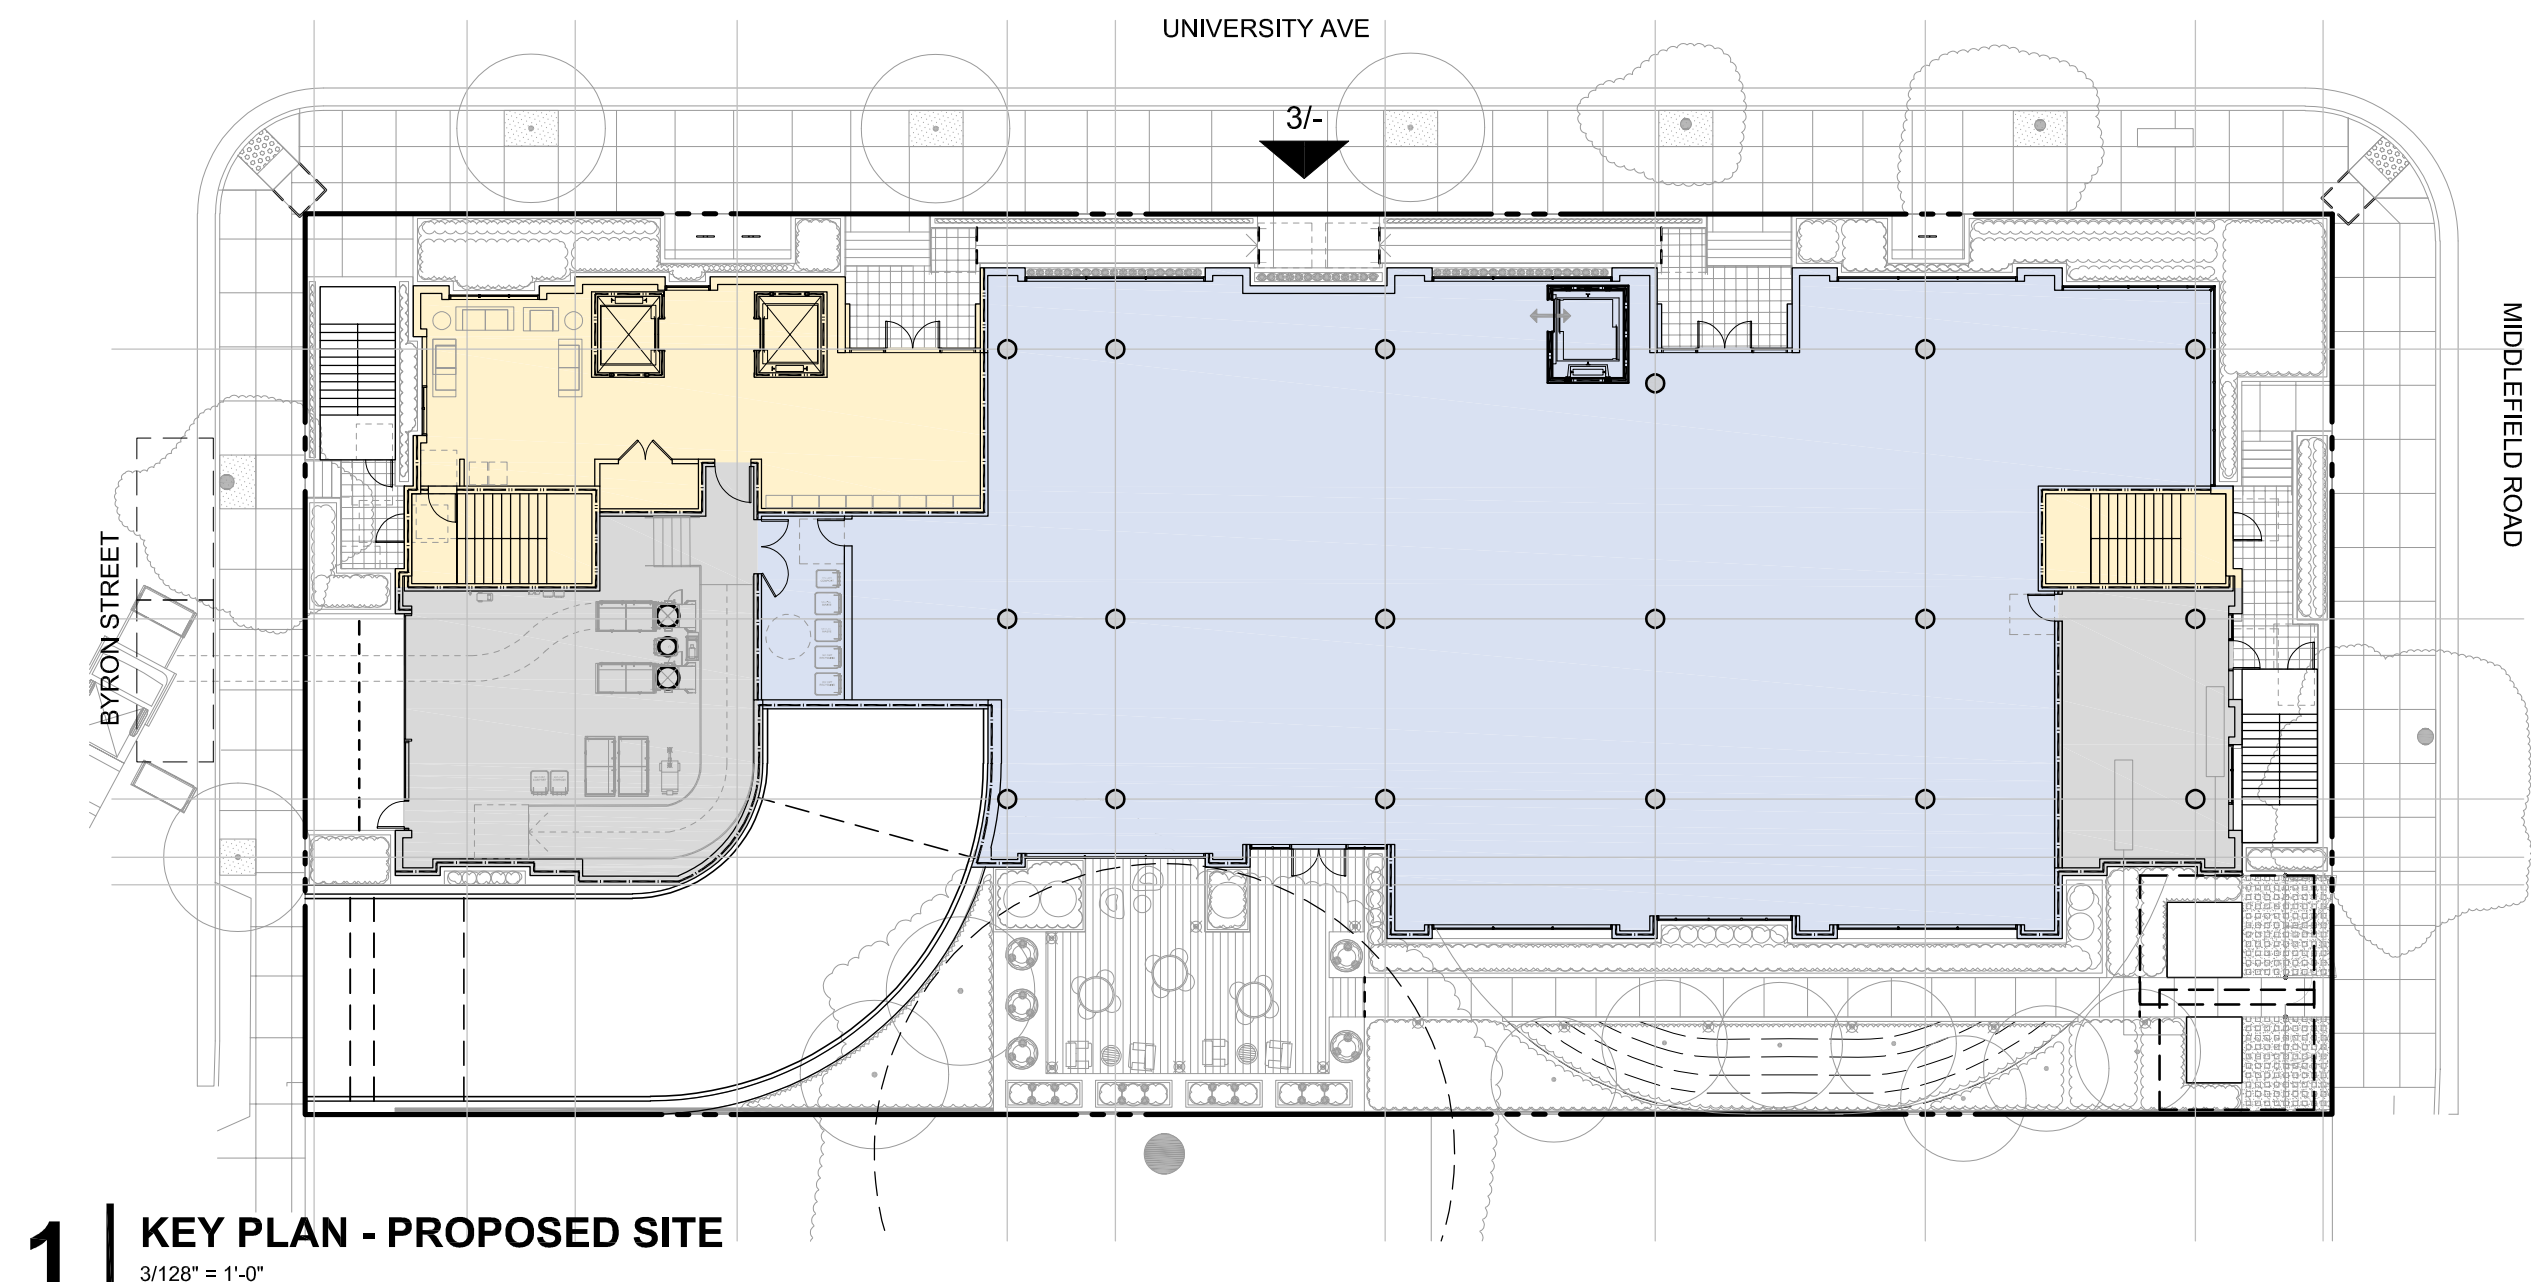


1 KEY PLAN - PROPOSED SITE


3/128" = 1'-0"

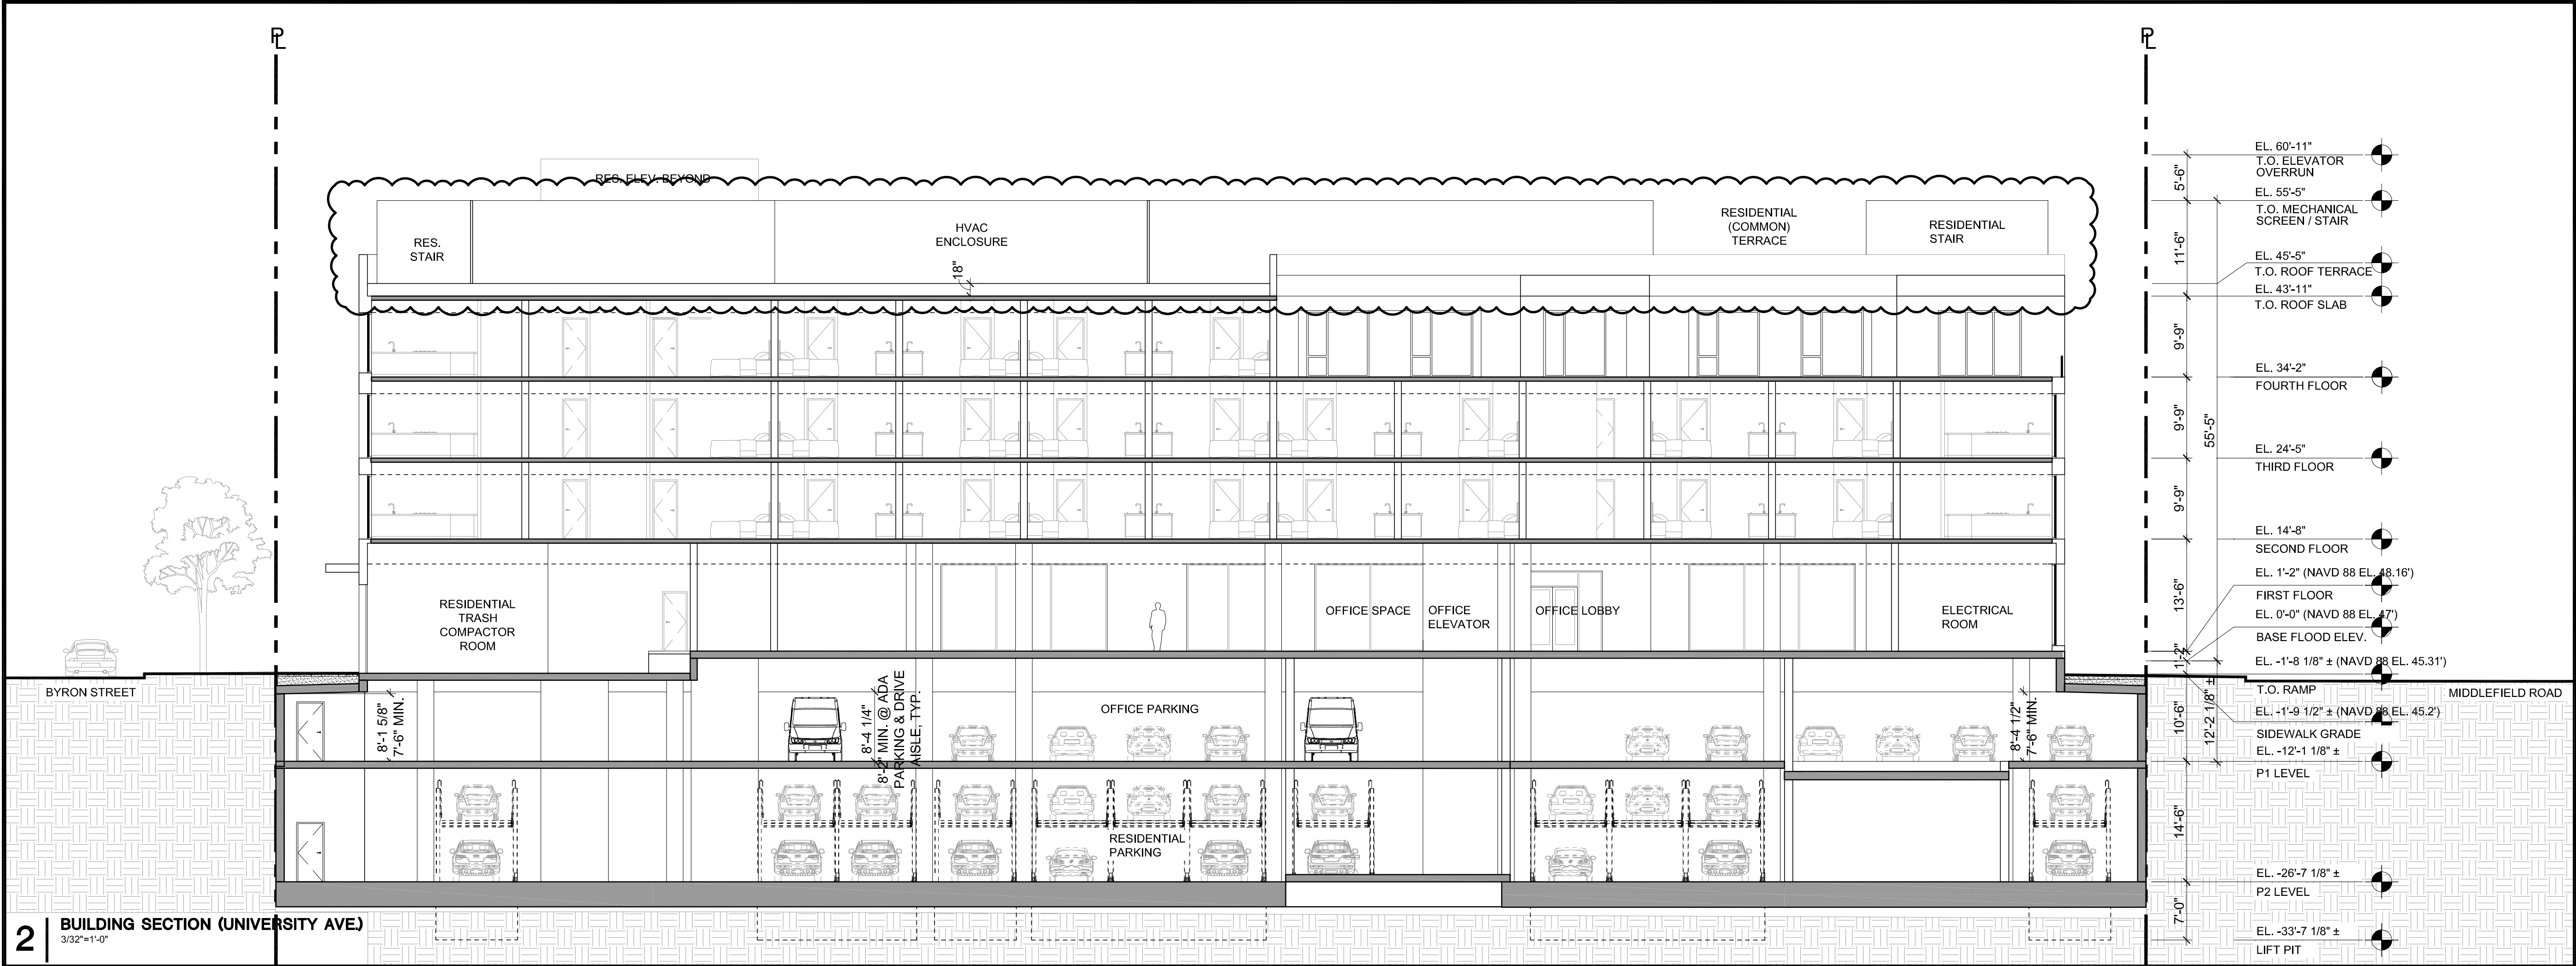

2 BUILDING SECTION (UNIVERSITY AVE.)
3/32"=1'-0"

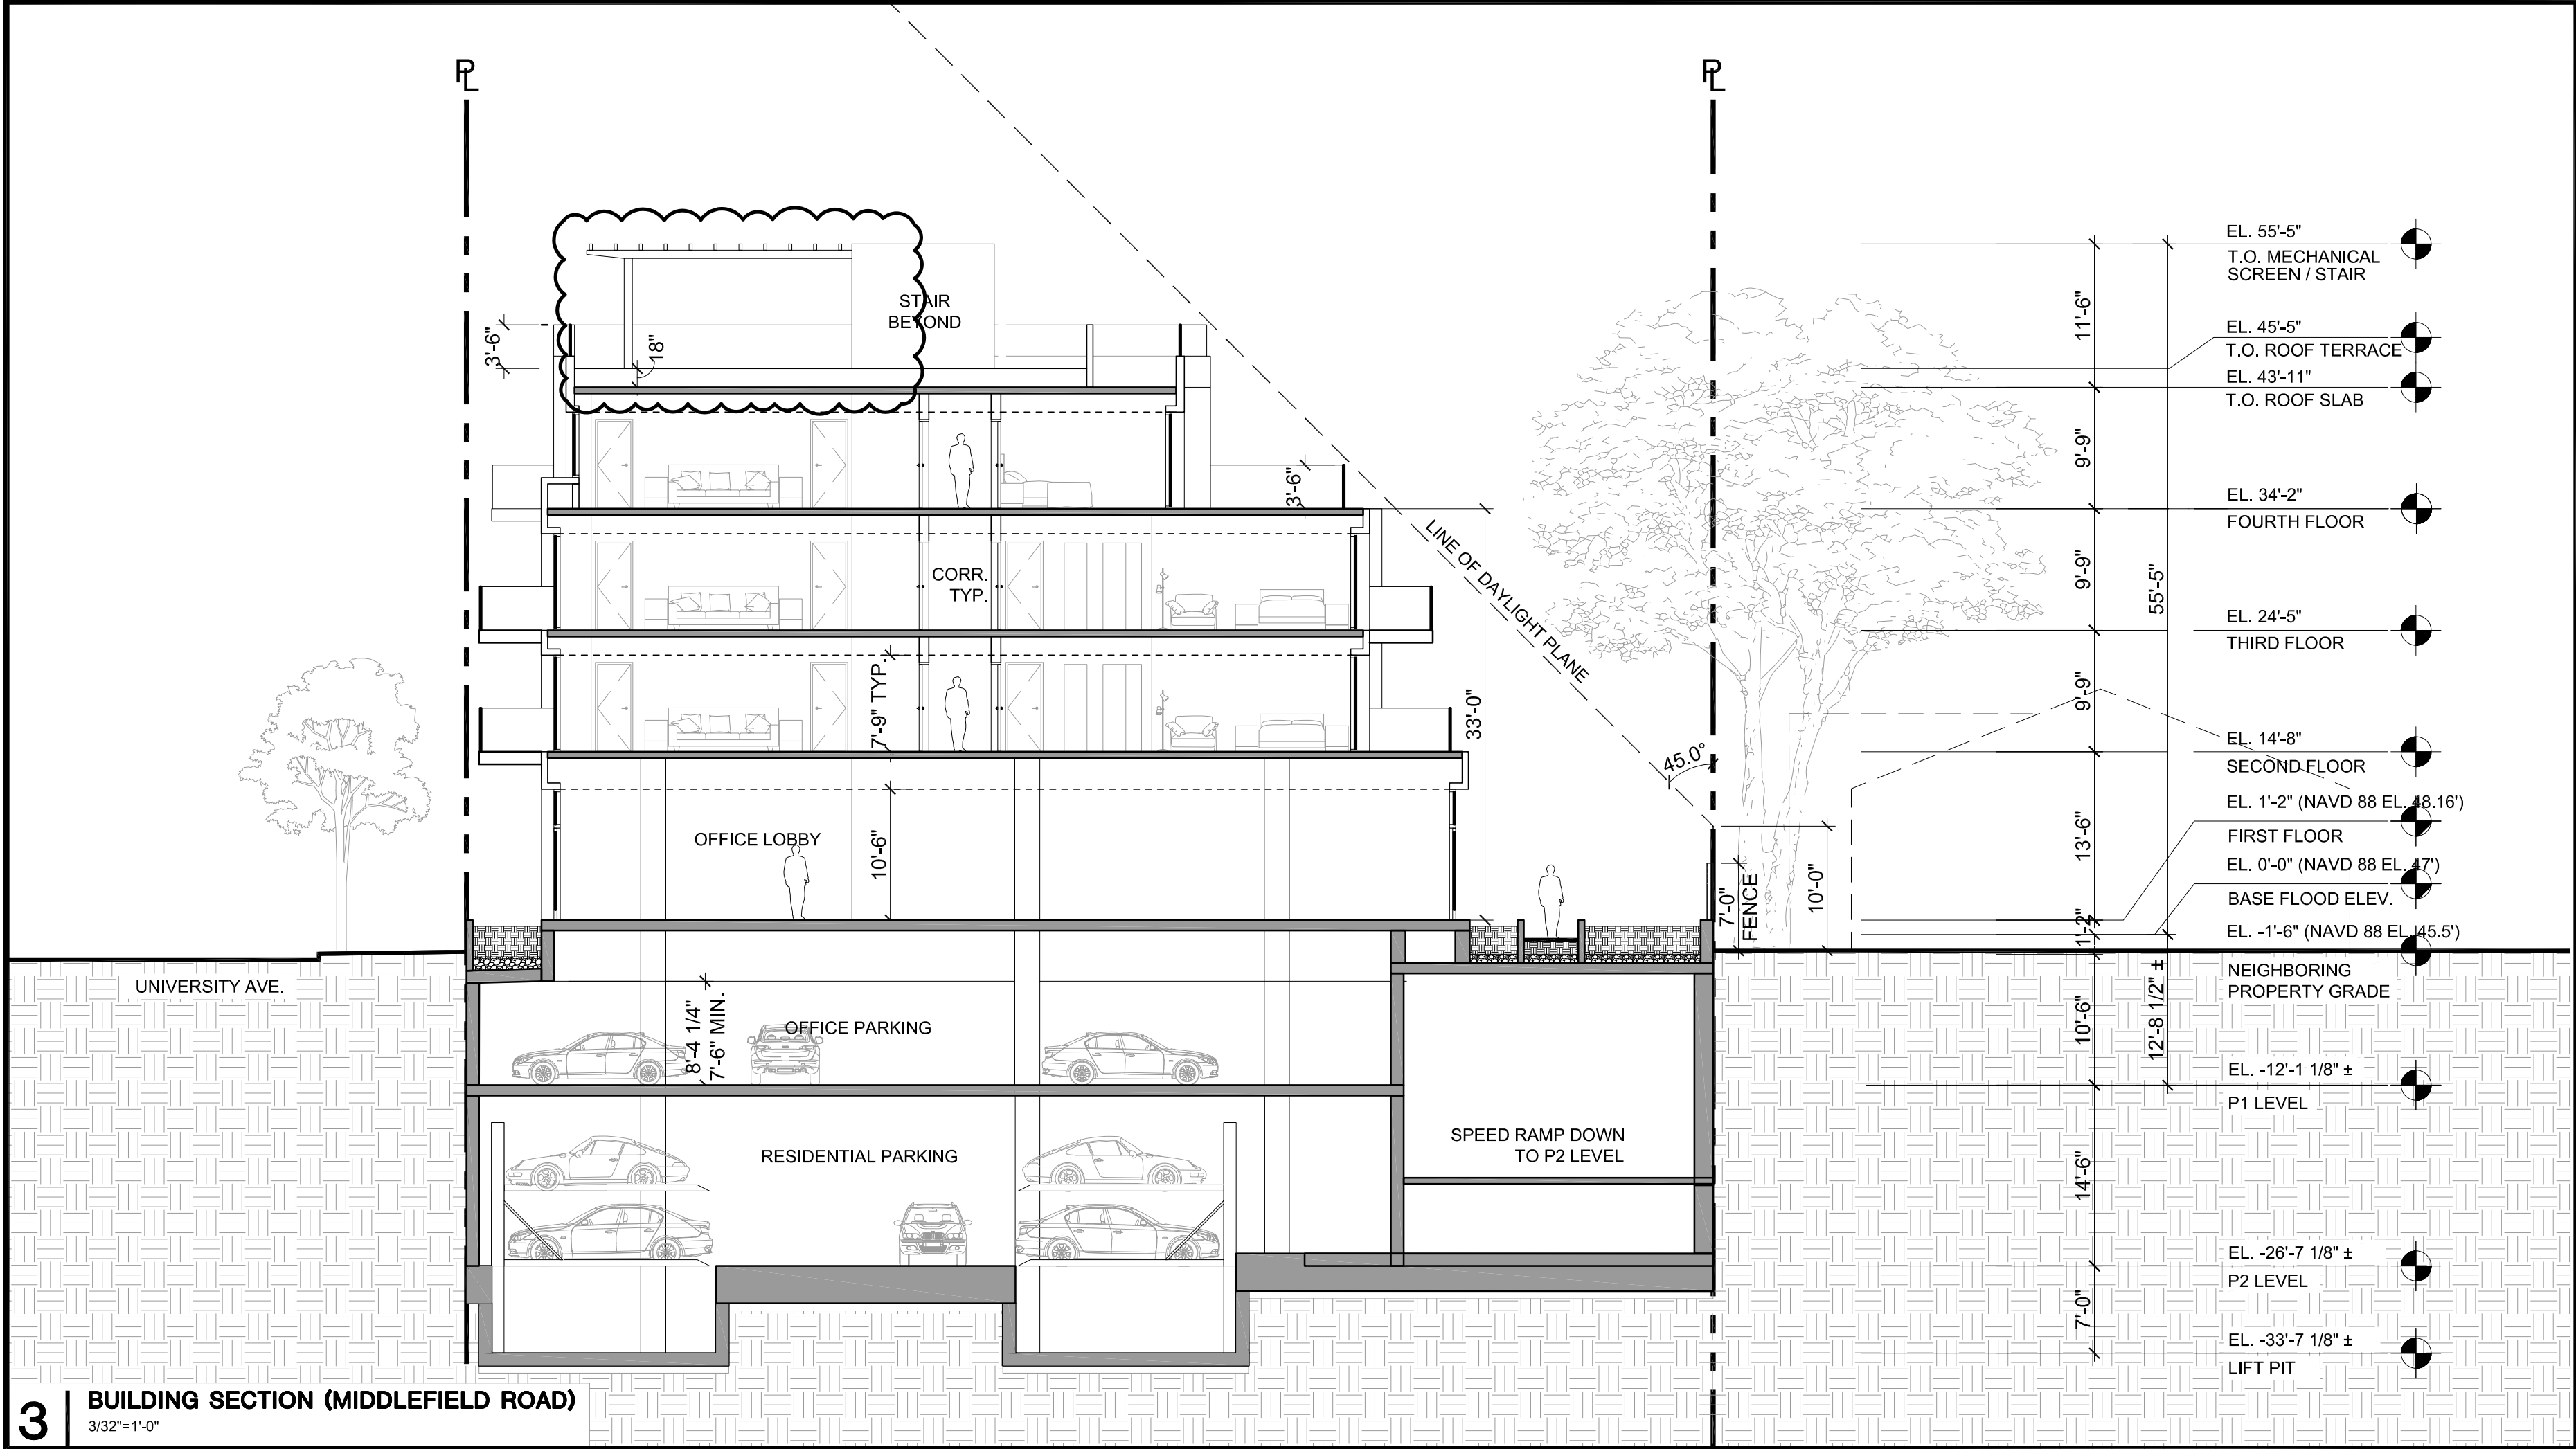

3 BUILDING SECTION (MIDDLEFIELD ROAD)
3/32"=1'-0"

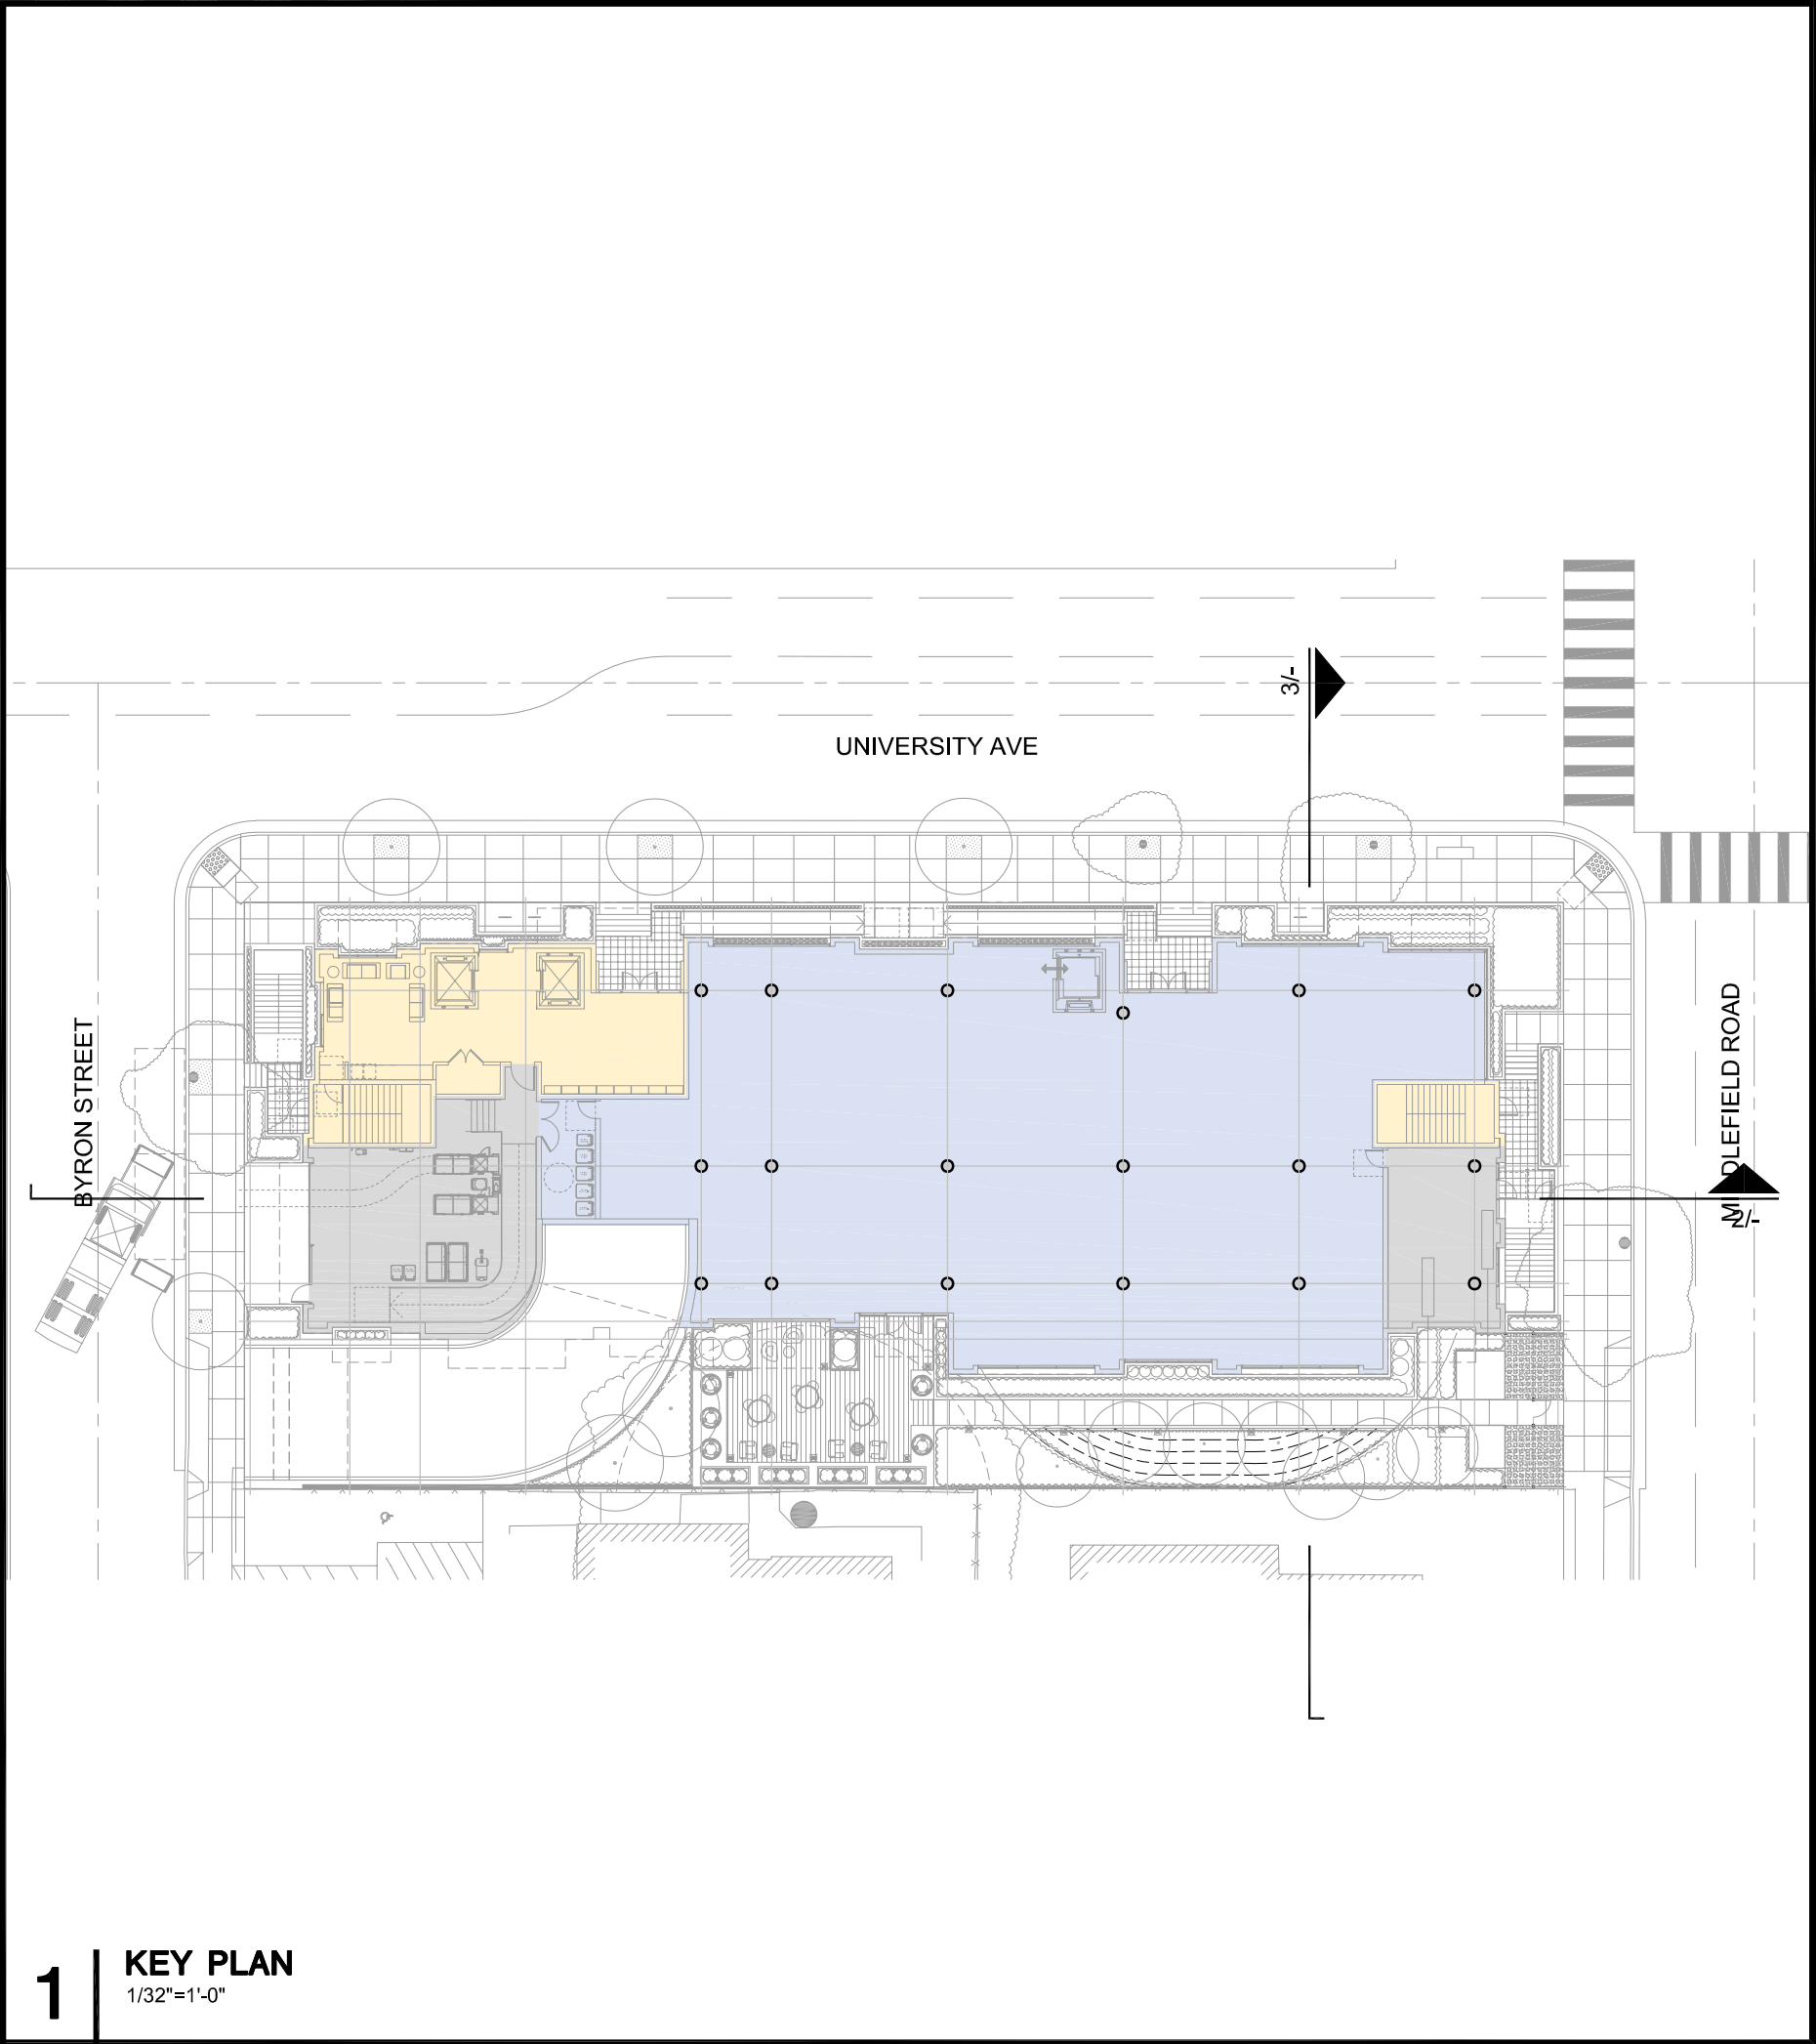

1 KEY PLAN
1/32"=1'-0"

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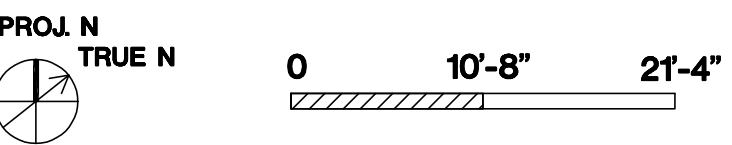
ARCHITECTS
KORTH SUNSERI HAGEY

ISSUES AND REVISIONS		
NO.	DATE	DESCRIPTION
12.01.22		PLANNING SUBMITTAL
05.13.22		PLANNING RESUBMITTAL #1
08.15.22		PLANNING RESUBMITTAL #2
08.28.23		PLANNING RESUBMITTAL #4
10.31.23		PLANNING RESUBMITTAL #5
12.20.23		PLANNING RESUBMITTAL #6
02.07.24		PLANNING RESUBMITTAL #7

PROJECT NUMBER
21003


SHEET TITLE
BUILDING SECTIONS

SCALE
3/32" = 1'-0"



SHEET NUMBER


A3.3

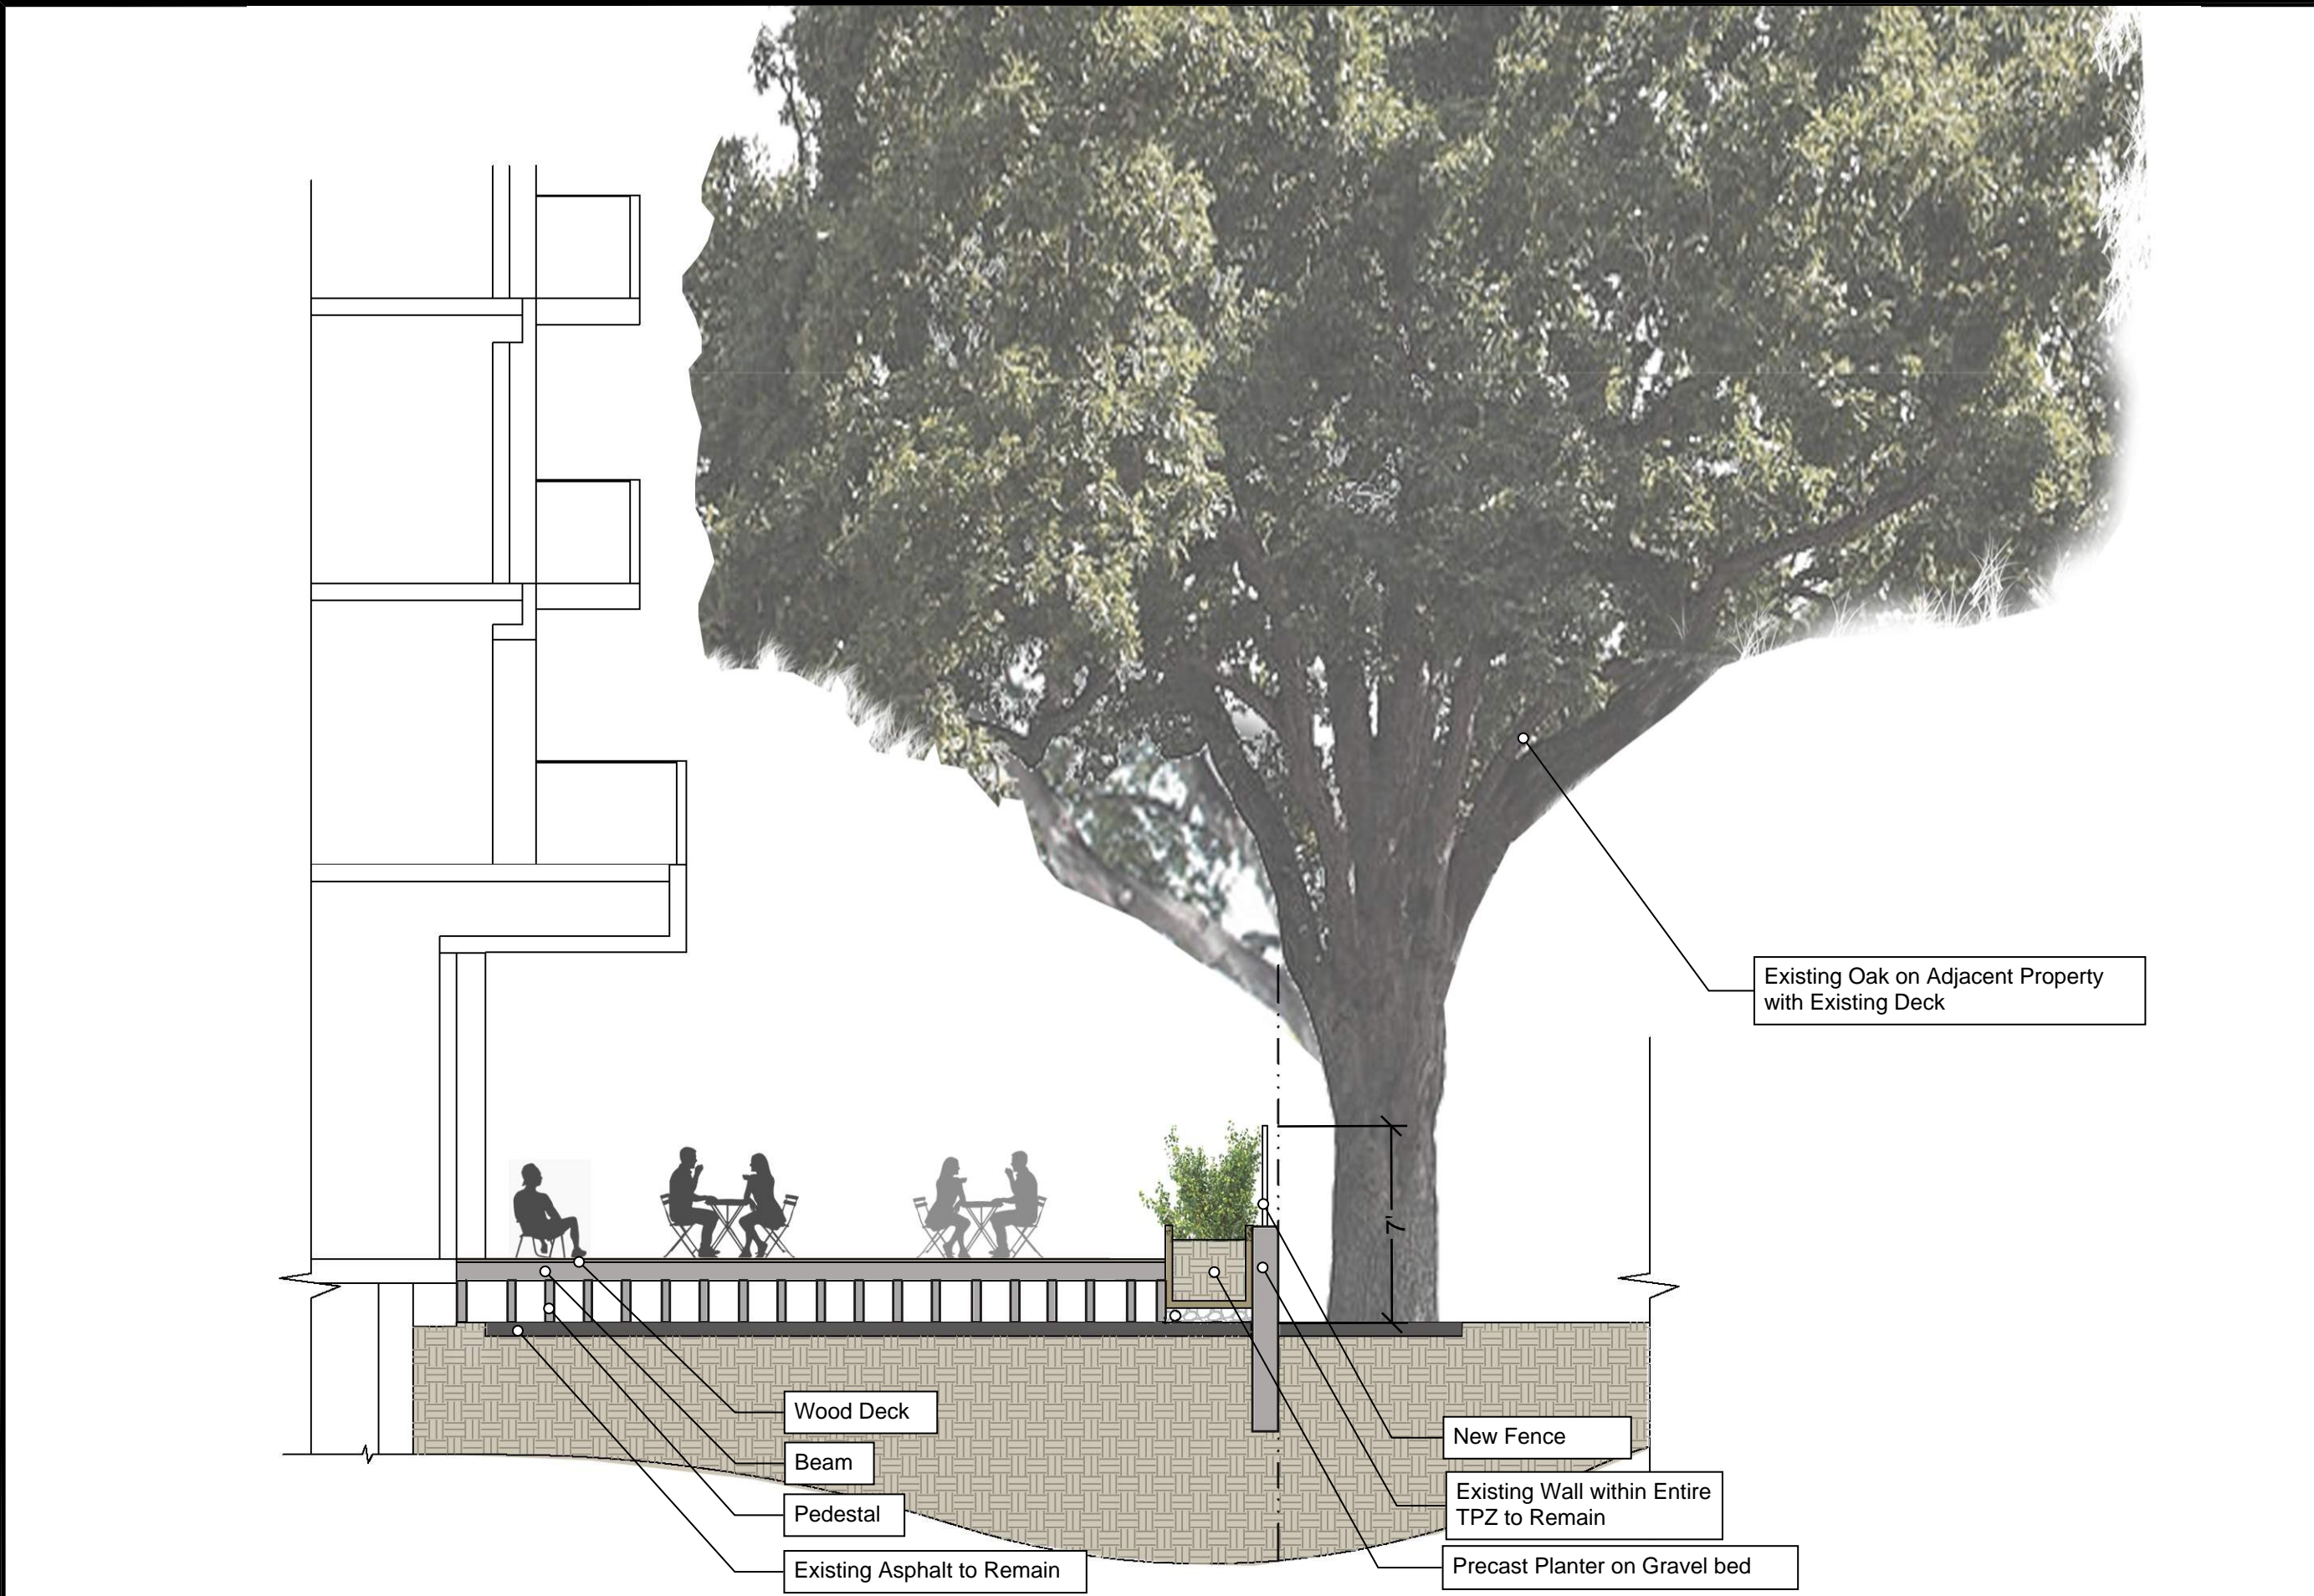

5 ENLARGED LANDSCAPE SECTION AT WOOD DECK
N.T.S




3 VIEW OF OAK TREE LOOKING TOWARDS MIDDLEFIELD ROAD
N.T.S

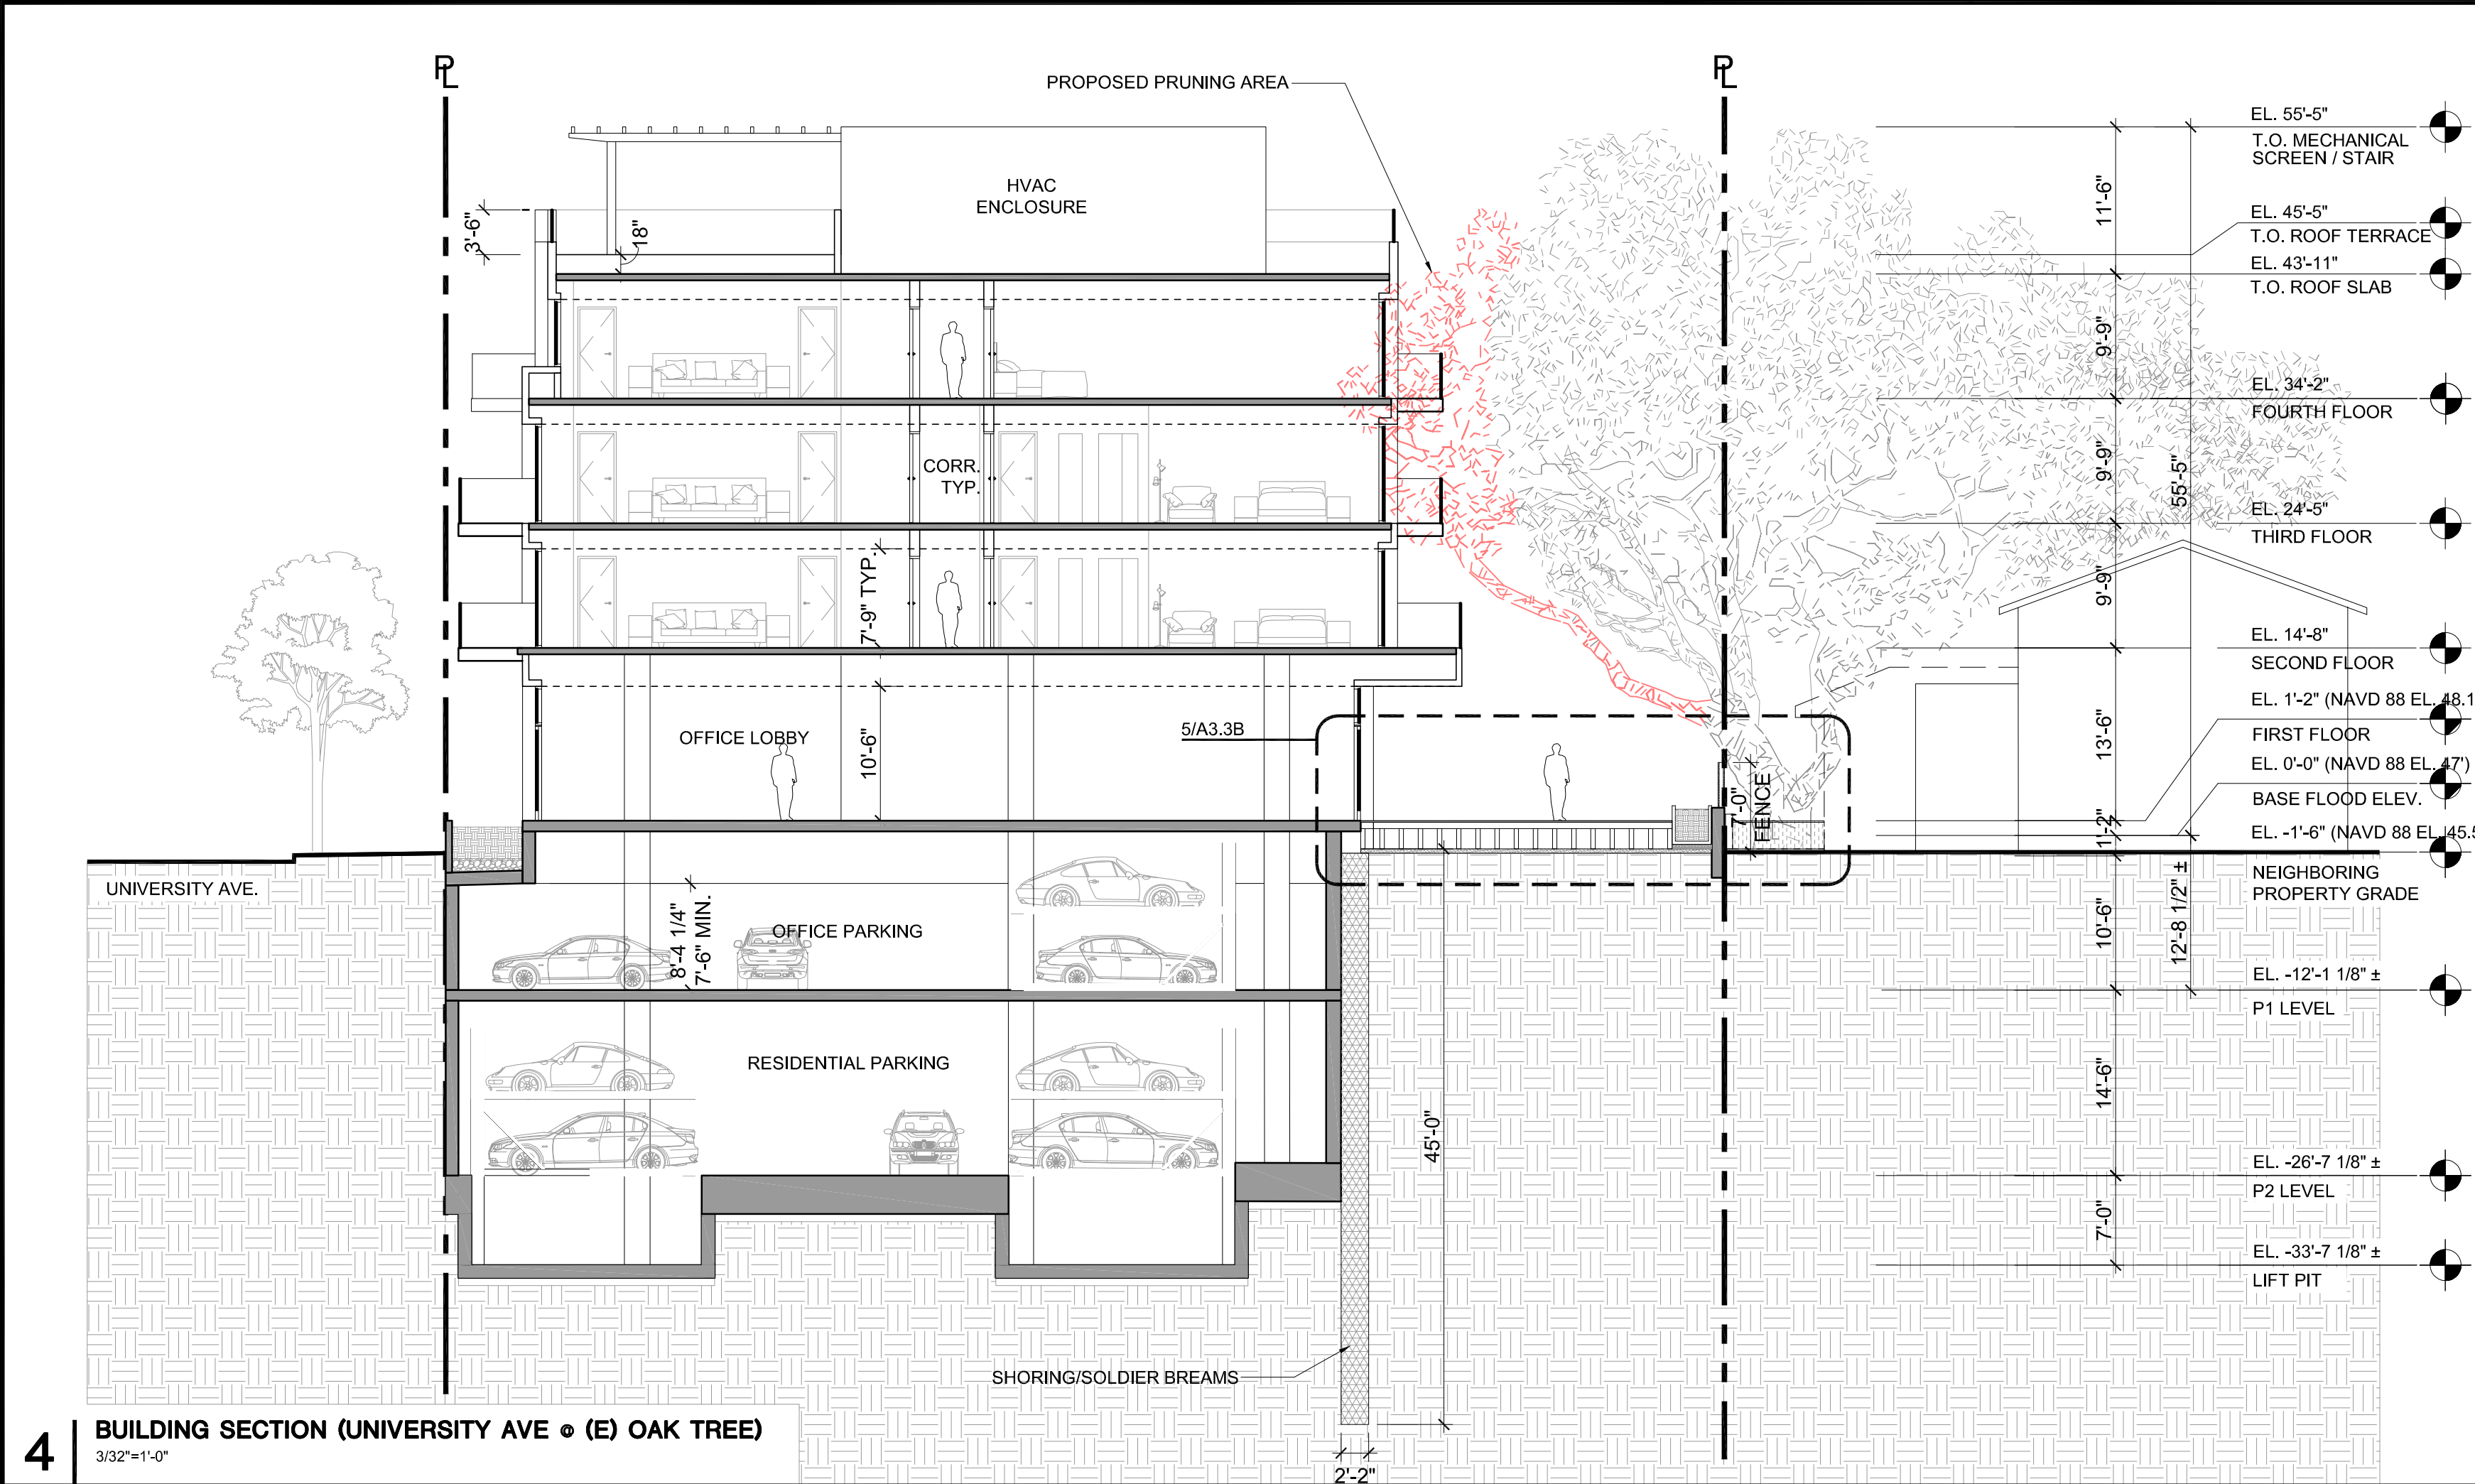

4 BUILDING SECTION (UNIVERSITY AVE @ (E) OAK TREE)
3/32"=1'-0"



2 TREE GROWTH OVER 2.5 YEARS
N.T.S

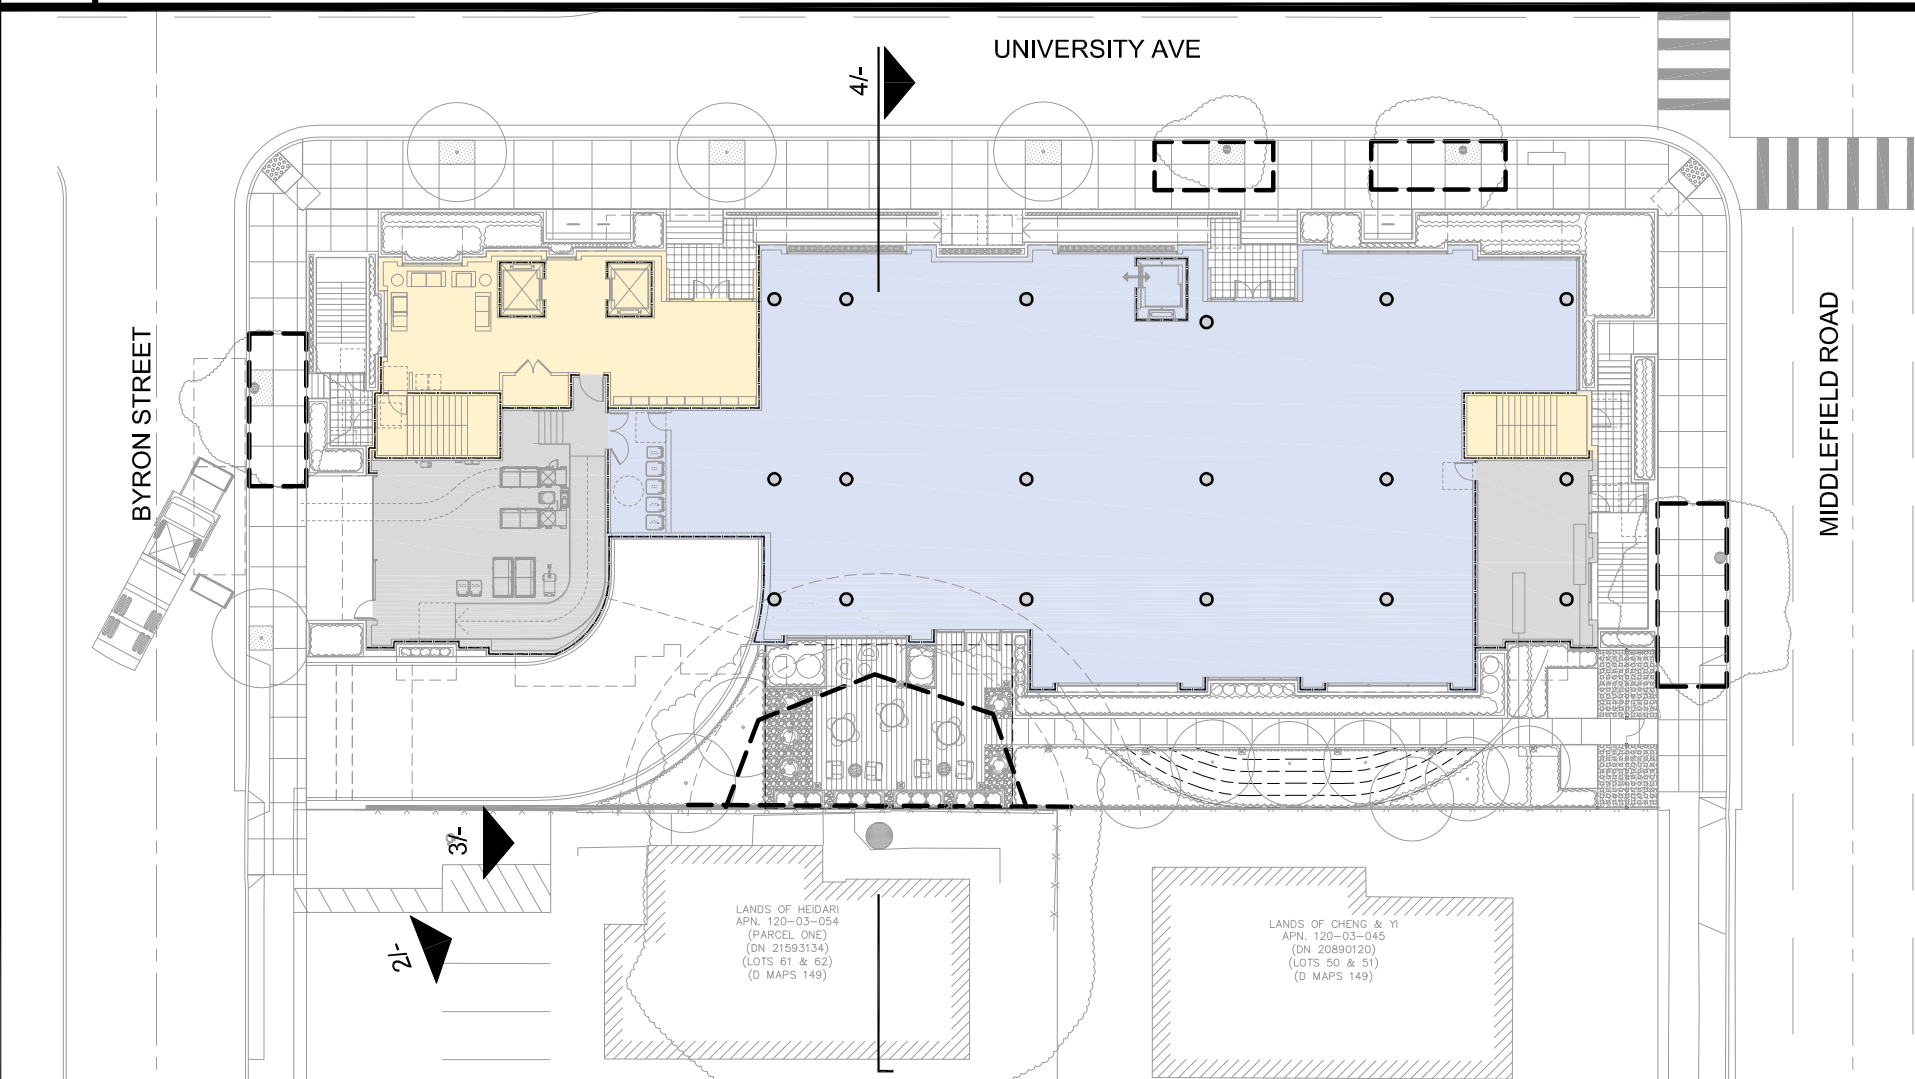

1 KEY PLAN
1/32"=1'-0"

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ISSUES AND REVISIONS		
NO.	DATE	DESCRIPTION
	02.07.24	PLANNING RESUBMITTAL #7

PROJECT NUMBER
21003

SHEET TITLE
BUILDING SECTION @ (E) OAK TREE

SCALE
AS NOTED



SHEET NUMBER

A3.3B

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ISSUES AND REVISIONS		
NO.	DATE	DESCRIPTION
12.01.21		PLANNING SUBMITTAL
05.13.22		PLANNING RESUBMITTAL #1
08.15.22		PLANNING RESUBMITTAL #2
11.02.22		PLANNING RESUBMITTAL #3
08.28.23		PLANNING RESUBMITTAL #4
10.31.23		PLANNING RESUBMITTAL #5
12.21.23		PLANNING RESUBMITTAL #6
02.07.24		PLANNING RESUBMITTAL #7

PROJECT NUMBER
21003

SHEET TITLE
ENLARGED ELEVATION


SCALE

1/4" = 1'-0"


0 4' 8'

SHEET NUMBER


A4.0A

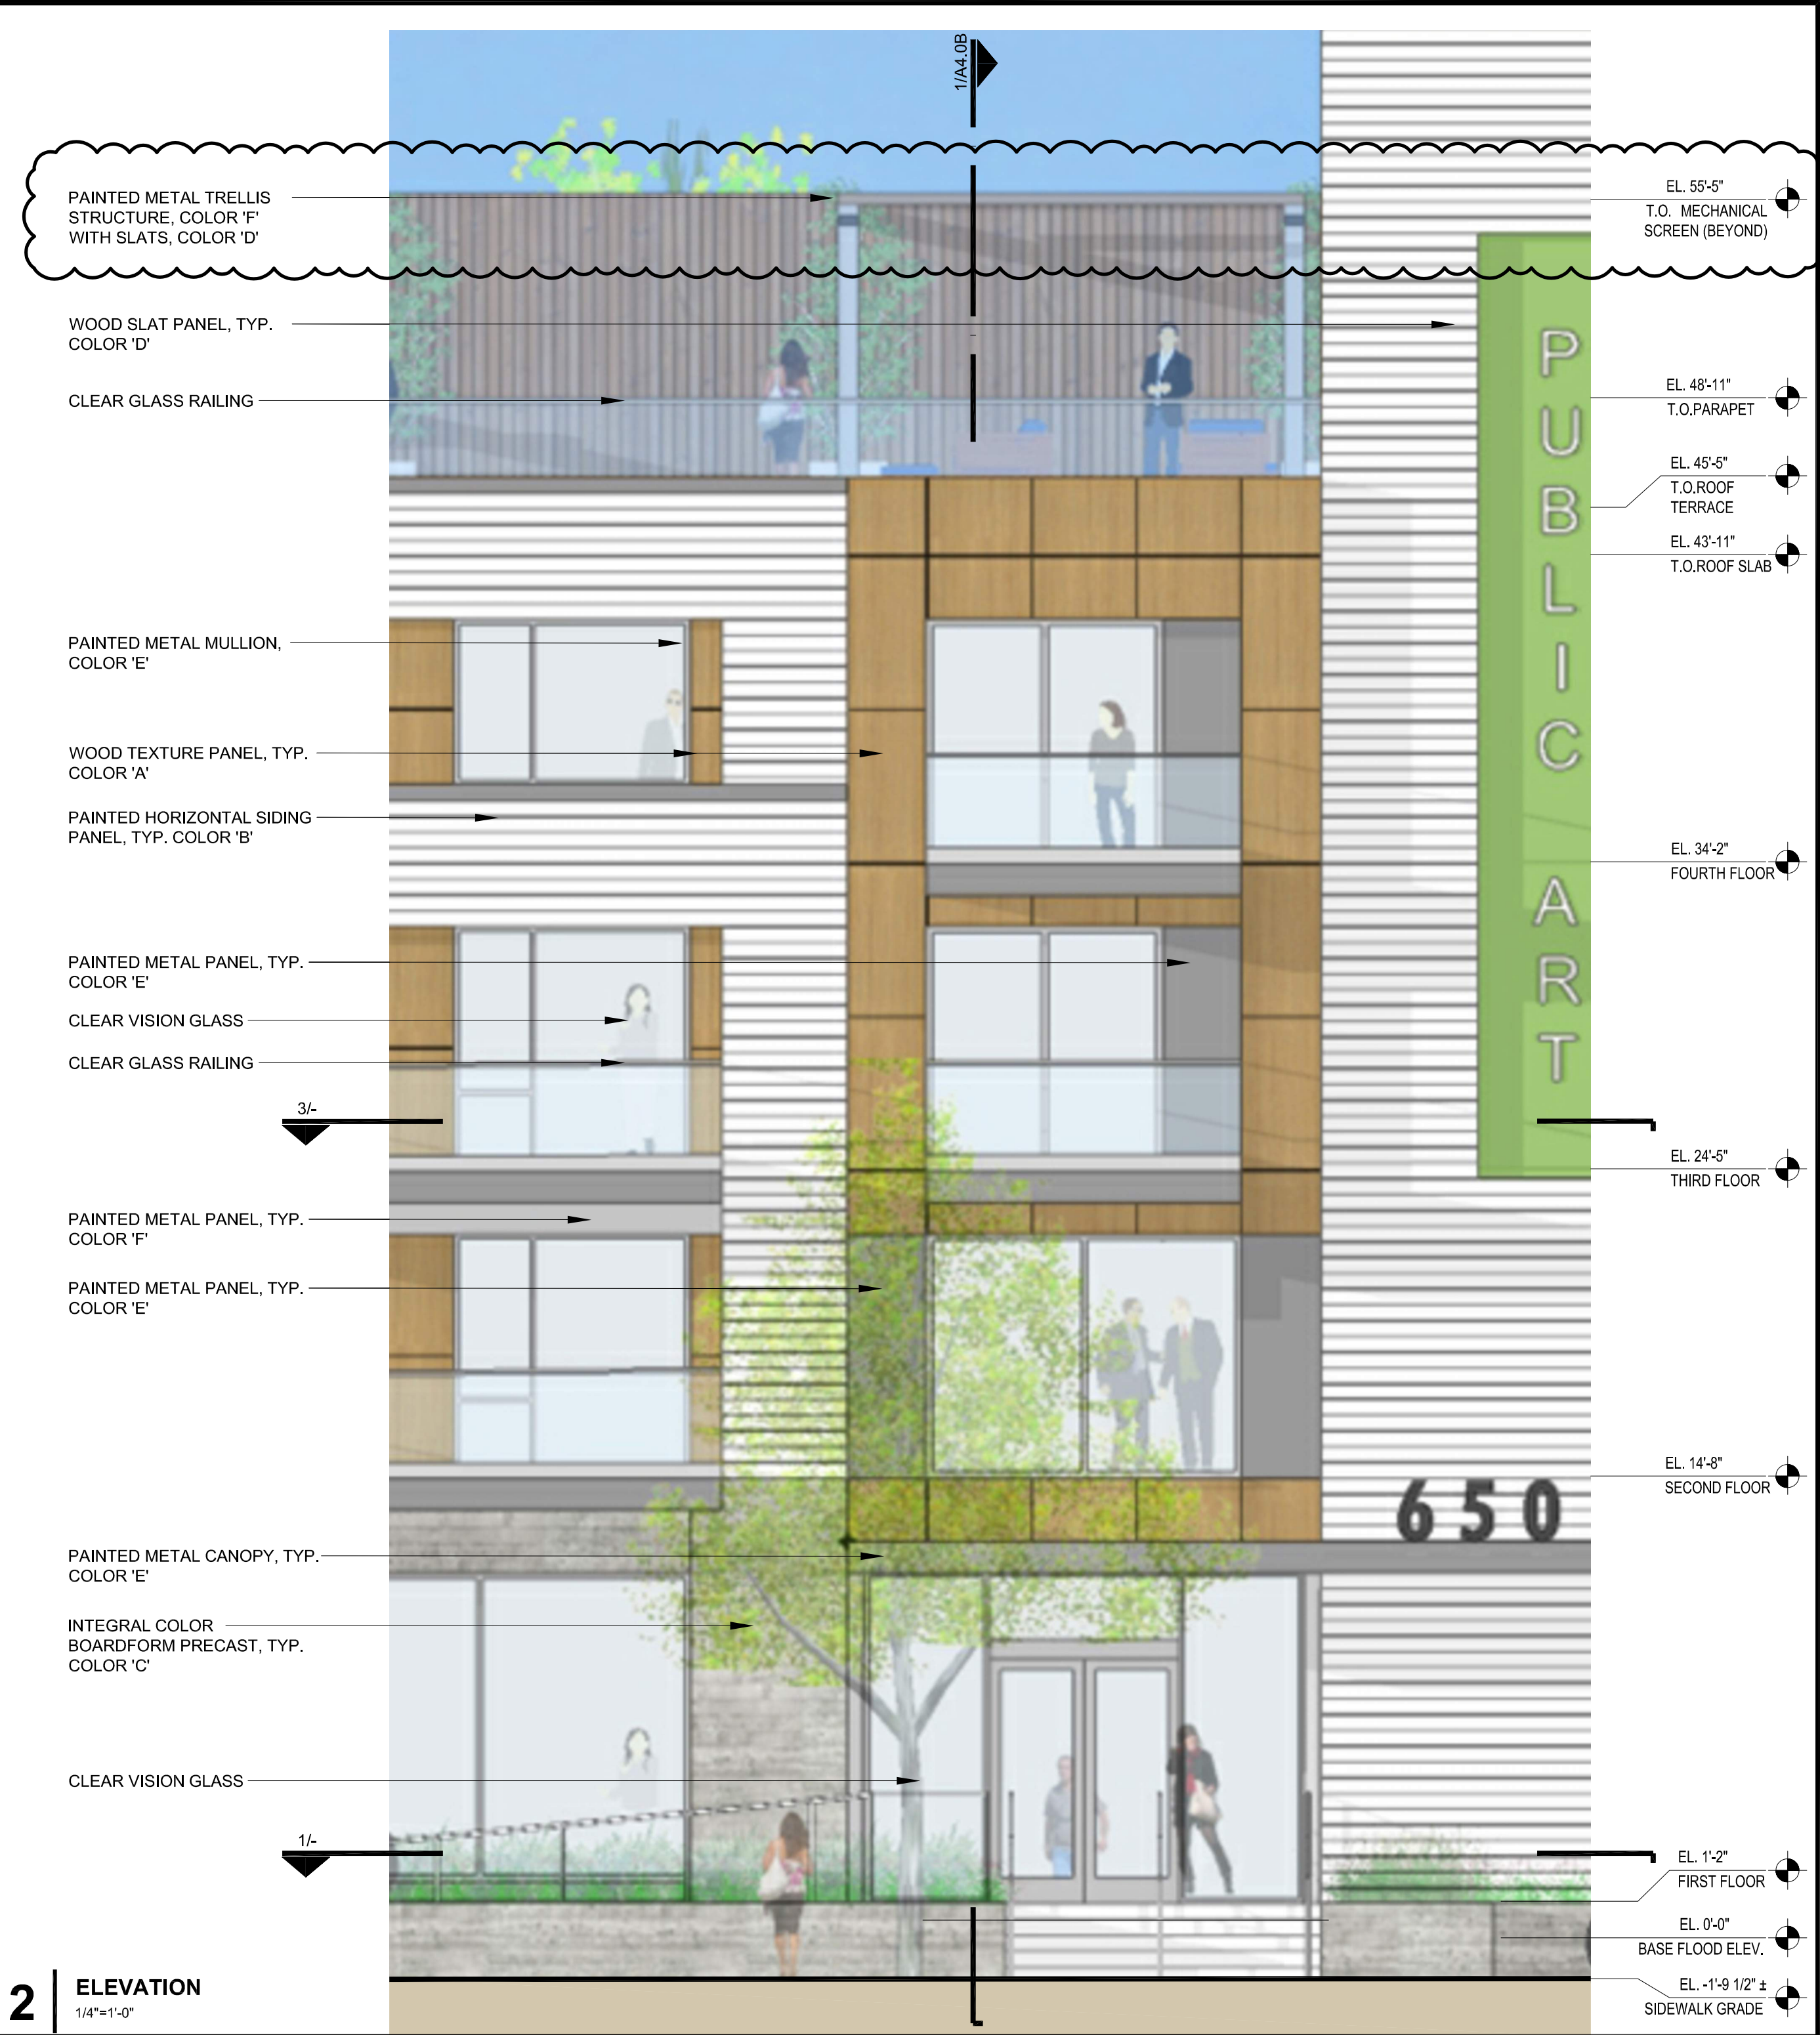


2 ELEVATION
1/4"=1'-0"

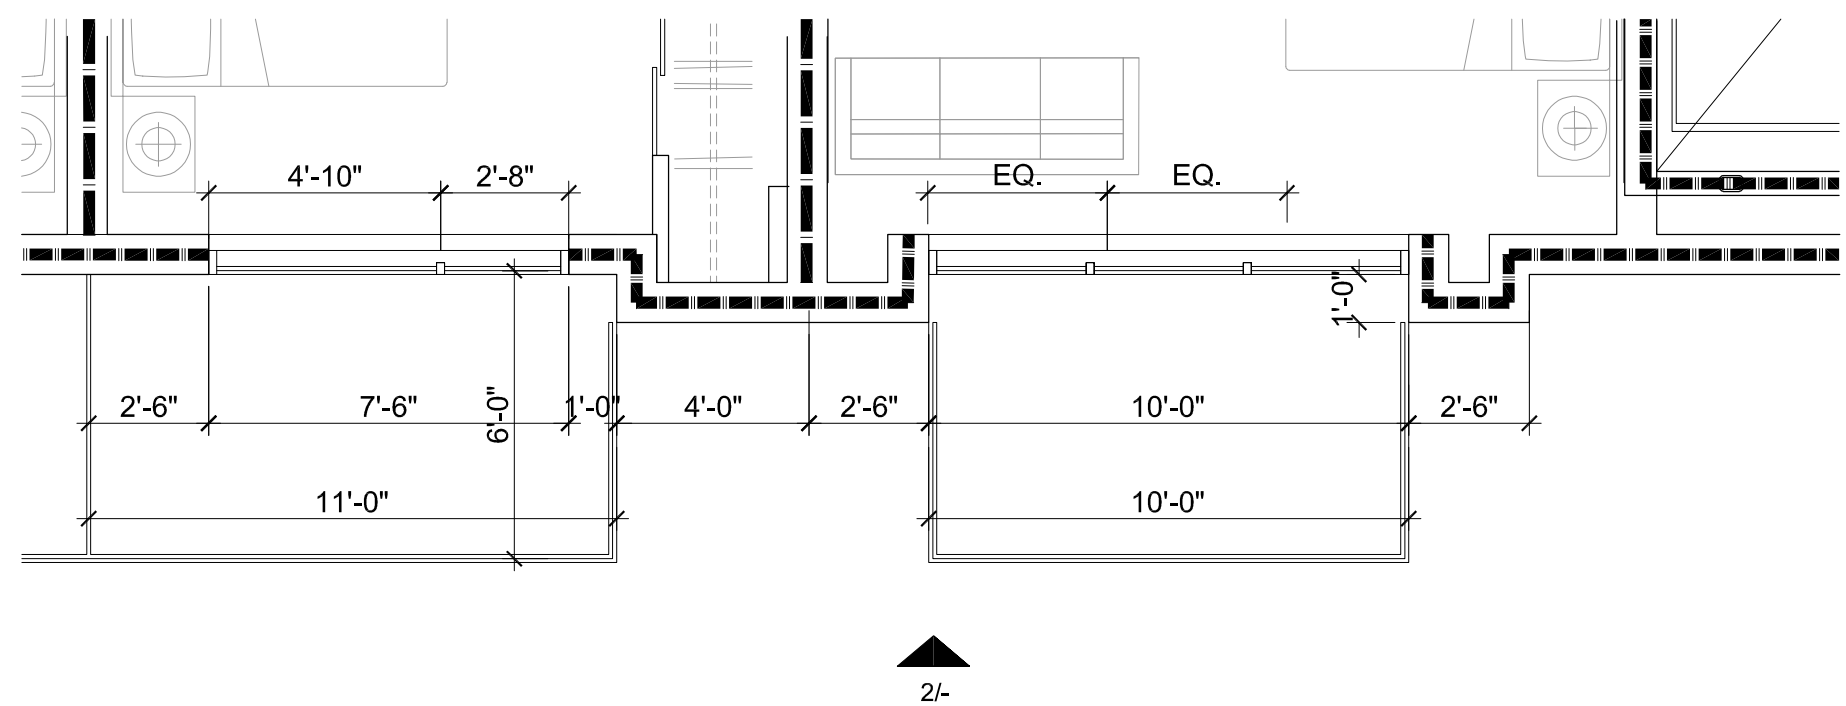

3 THIRD FLOOR PLAN
1/4"=1'-0"

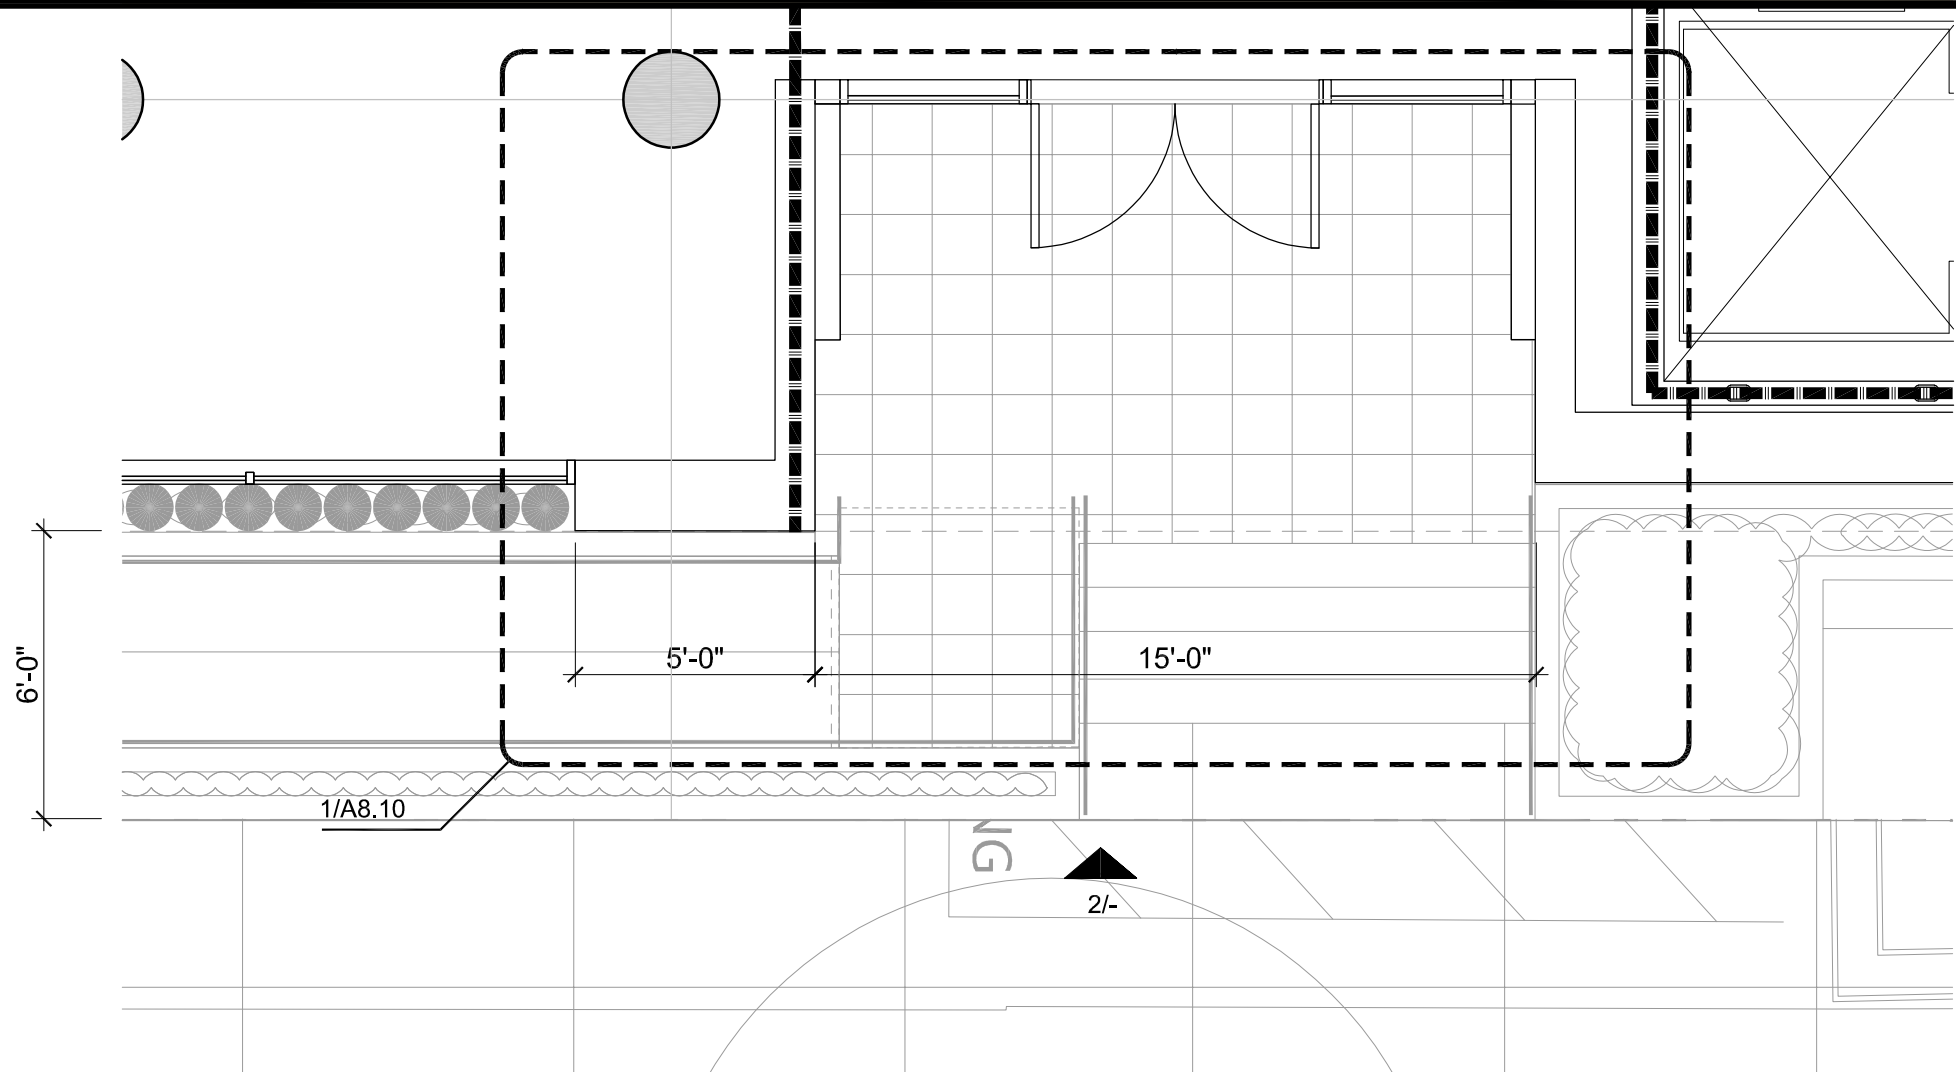

1 FIRST FLOOR PLAN
1/4"=1'-0"

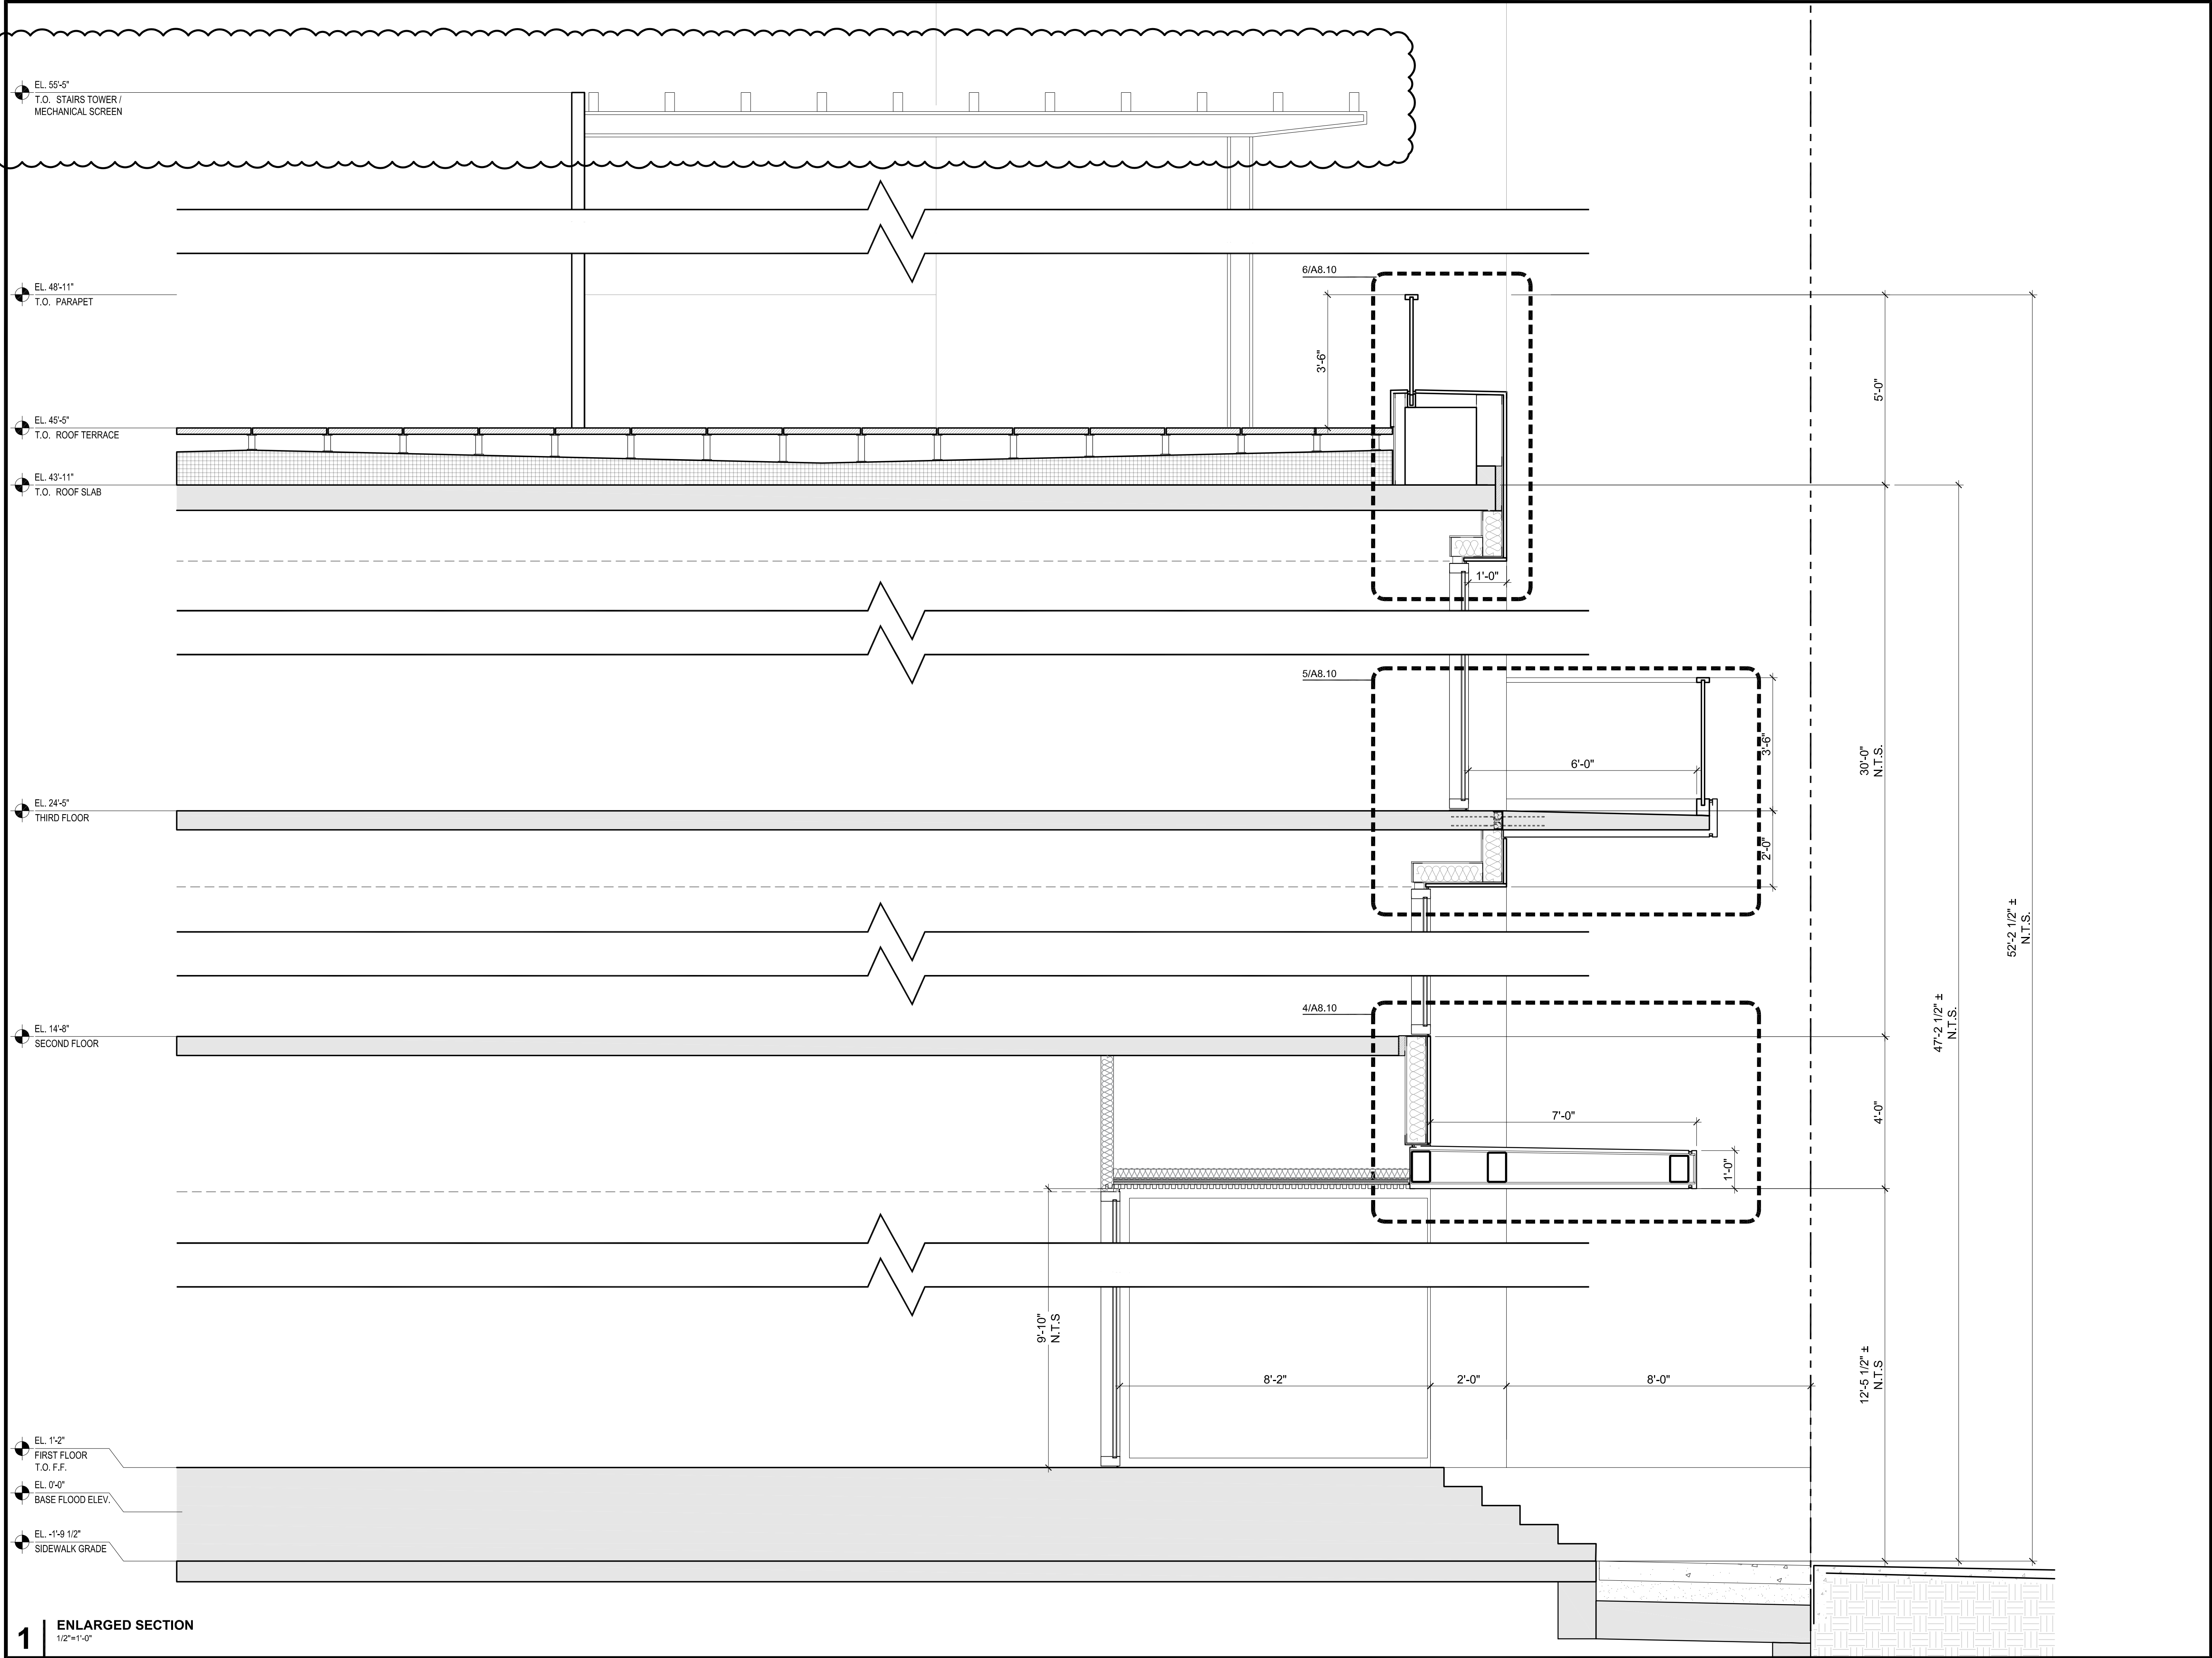

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ARCHITECTS
KORTH SUNSERI HAGEY

ISSUES AND REVISIONS		
NO.	DATE	DESCRIPTION
	08.28.23	PLANNING RESUBMITTAL #4
	10.31.23	PLANNING RESUBMITTAL #5
	12.21.23	PLANNING RESUBMITTAL #6
	02.07.24	PLANNING RESUBMITTAL #7

PROJECT NUMBER
21003

SHEET TITLE
ENLARGED SECTION

SCALE
1/4" = 1'-0"



SHEET NUMBER

A4.0B

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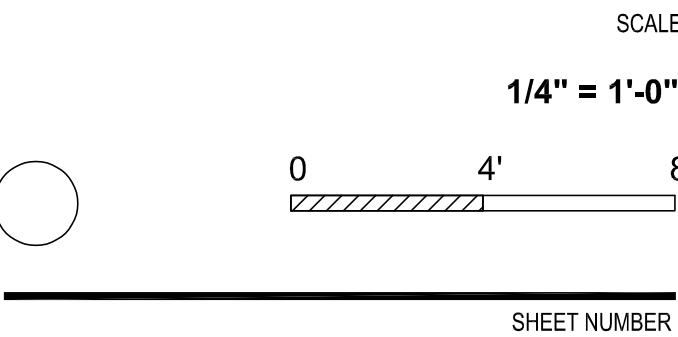


ARCHITECTS
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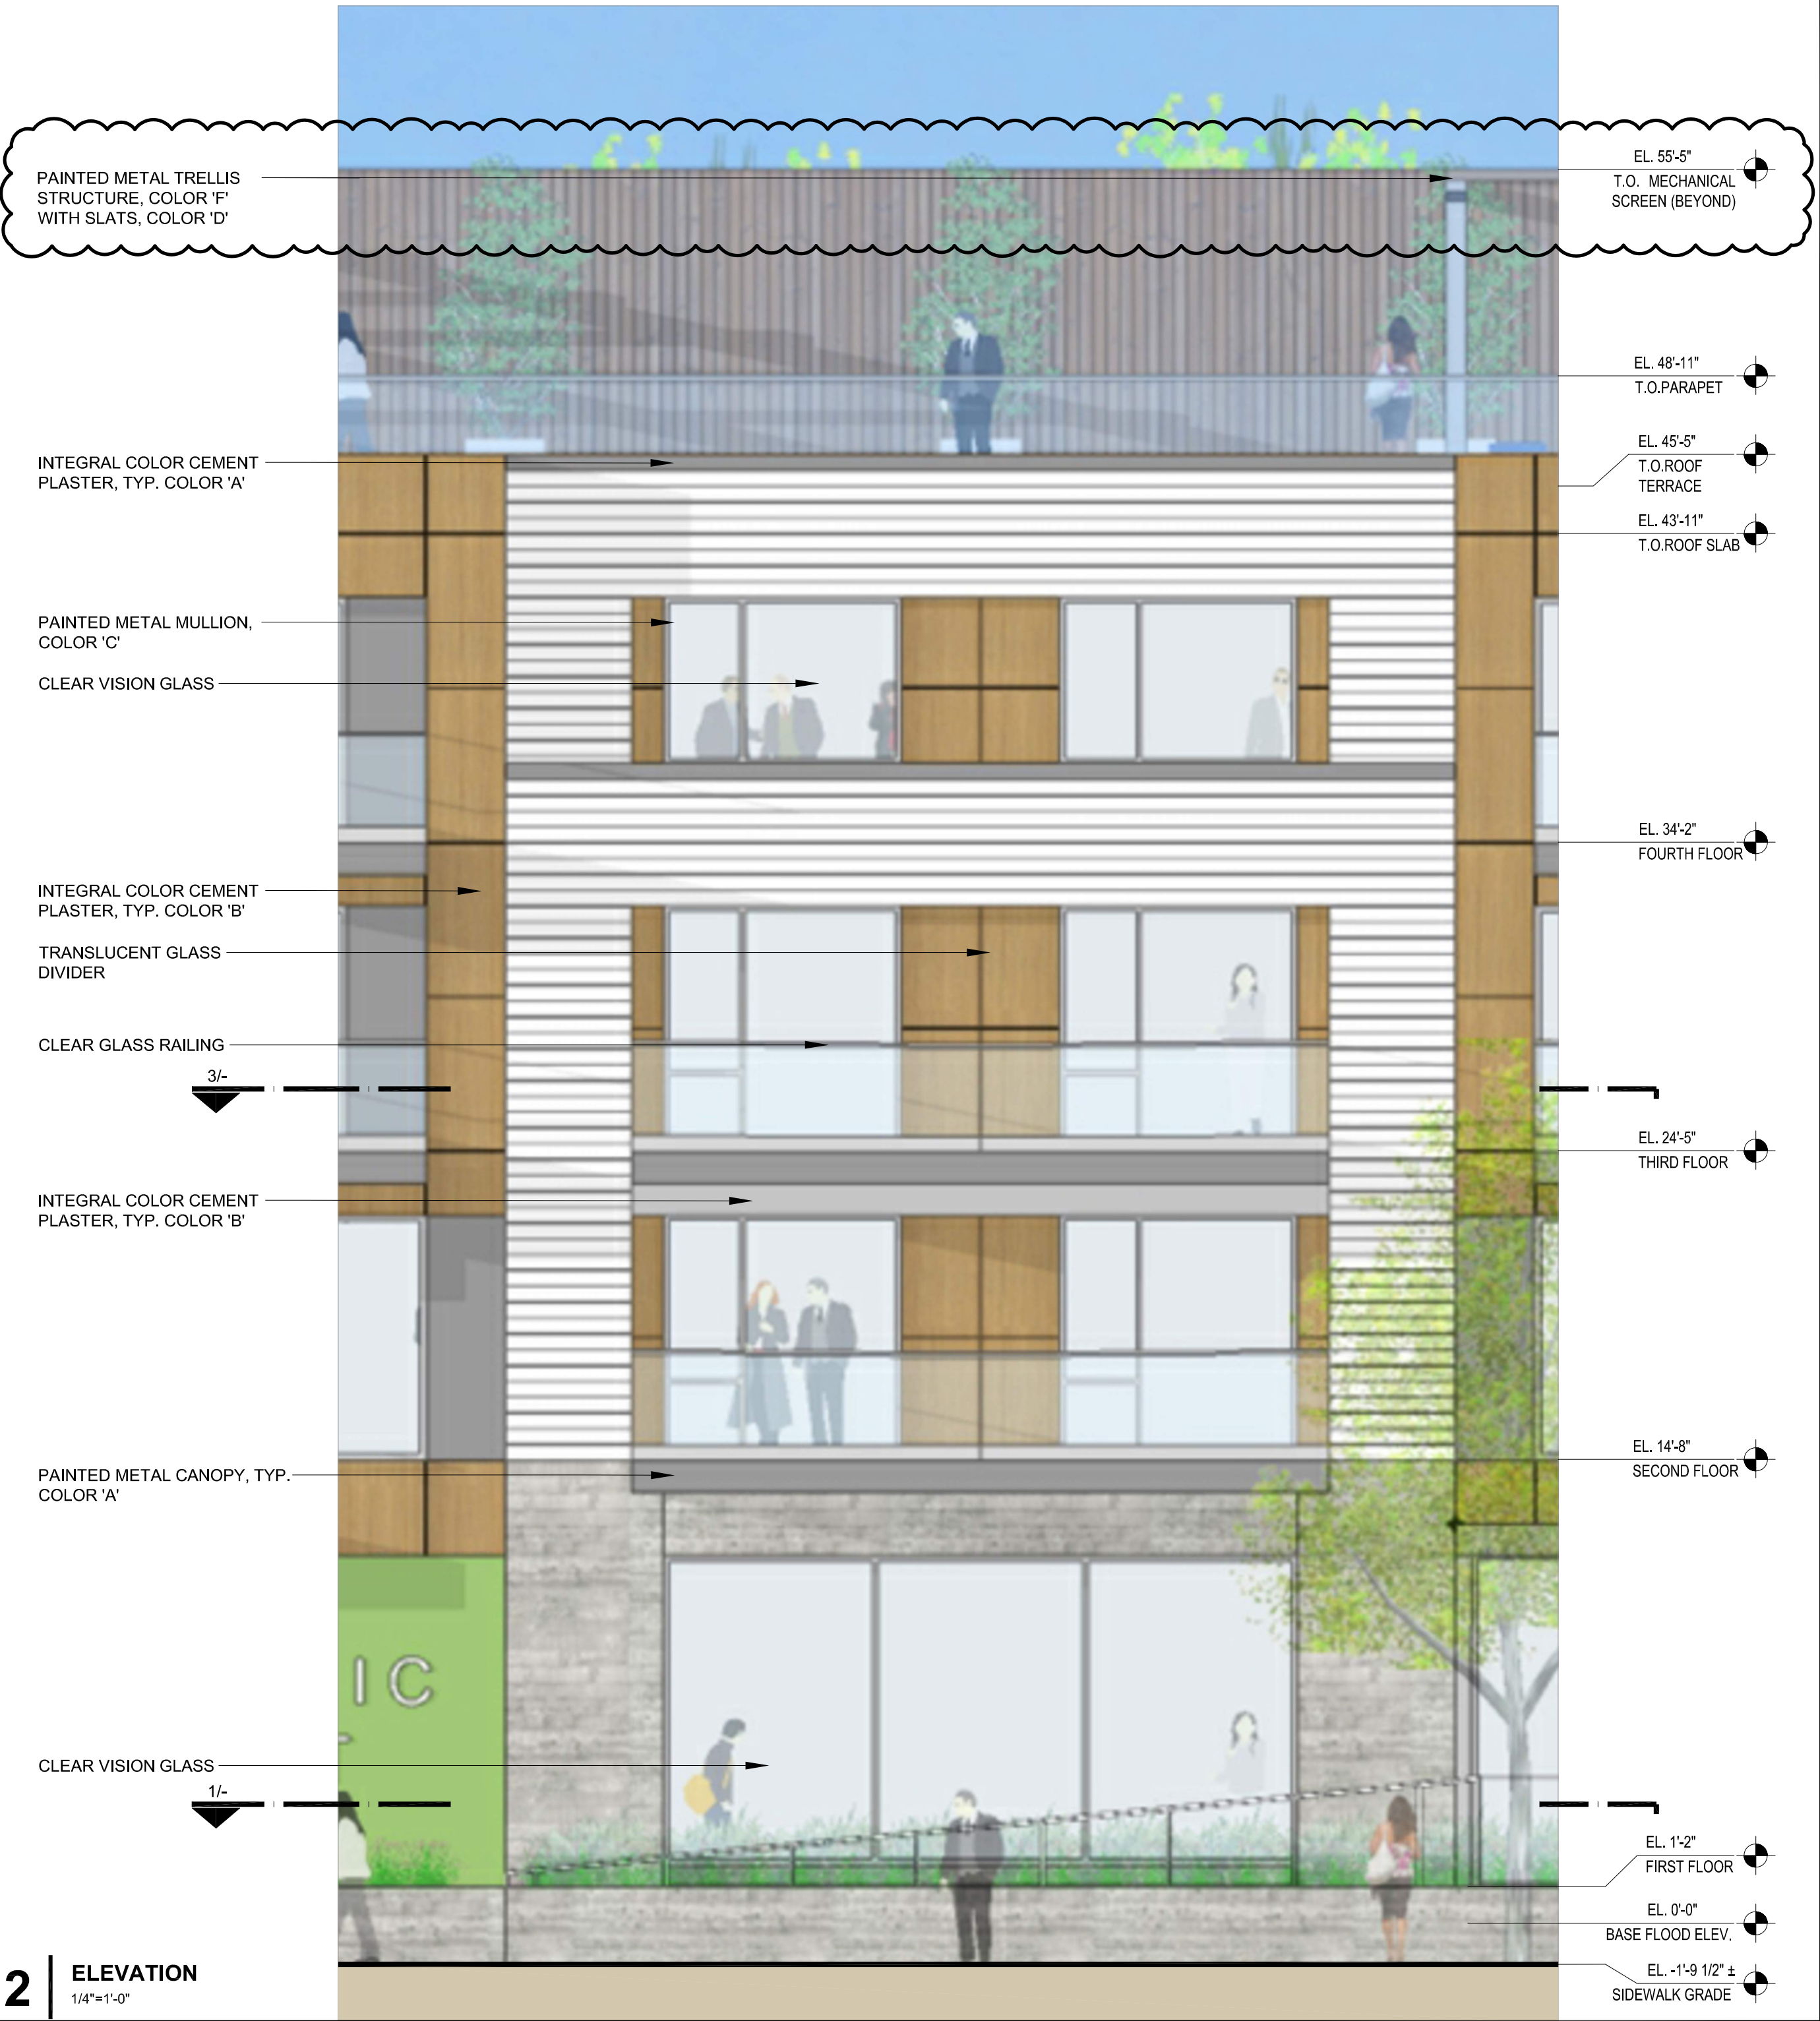
ISSUES AND REVISIONS		
NO.	DATE	DESCRIPTION
12.01.21		PLANNING SUBMITTAL
05.13.22		PLANNING RESUBMITTAL #1
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12.21.23		PLANNING RESUBMITTAL #6
02.07.24		PLANNING RESUBMITTAL #7

PROJECT NUMBER
21003


SHEET TITLE
ENLARGED ELEVATIONS




A4.1A



2 ELEVATION
1/4"=1'-0"

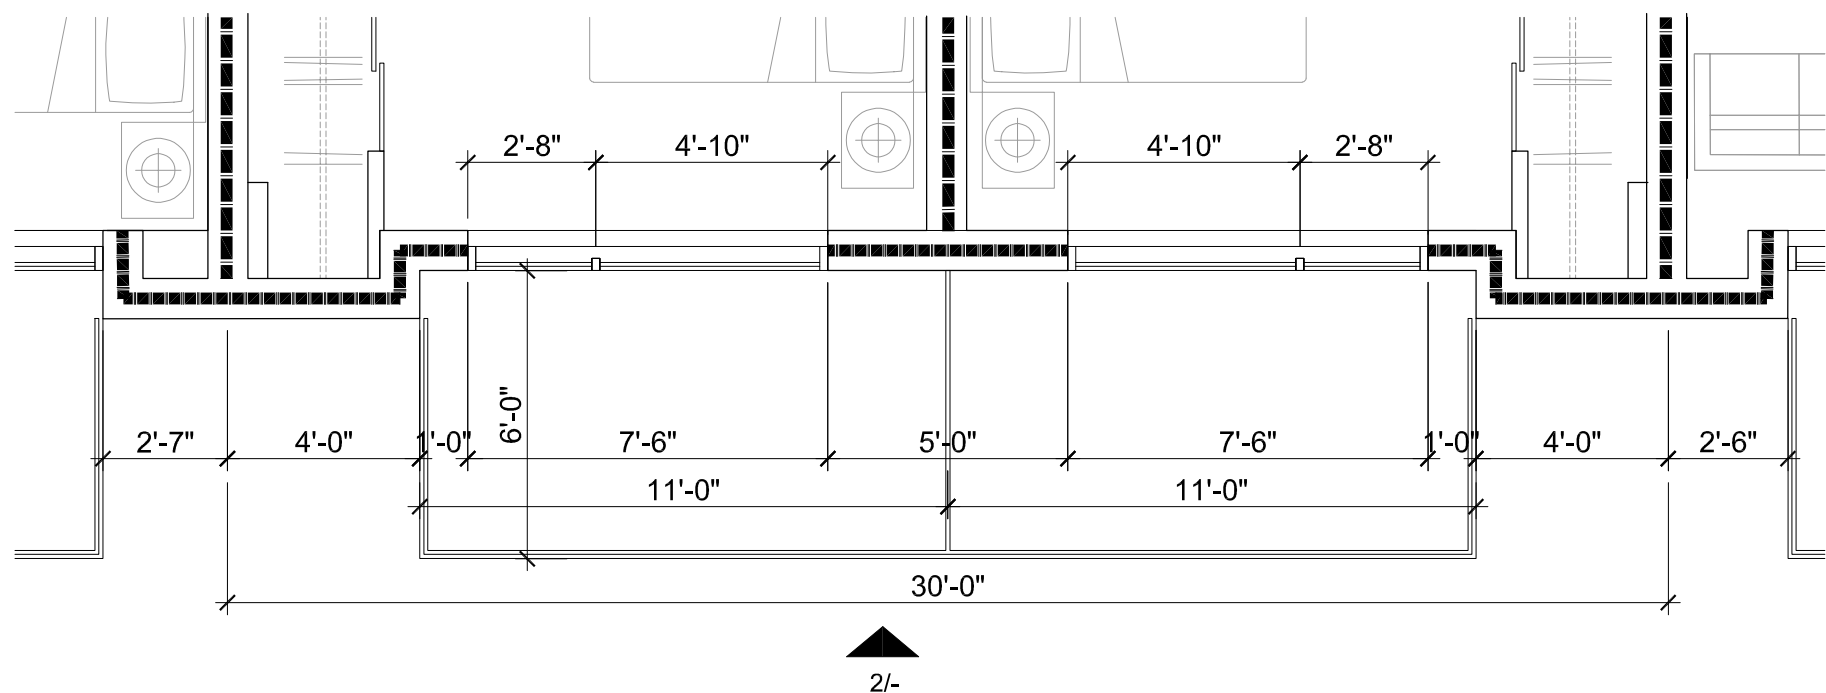


3 THIRD FLOOR PLAN
1/4"=1'-0"

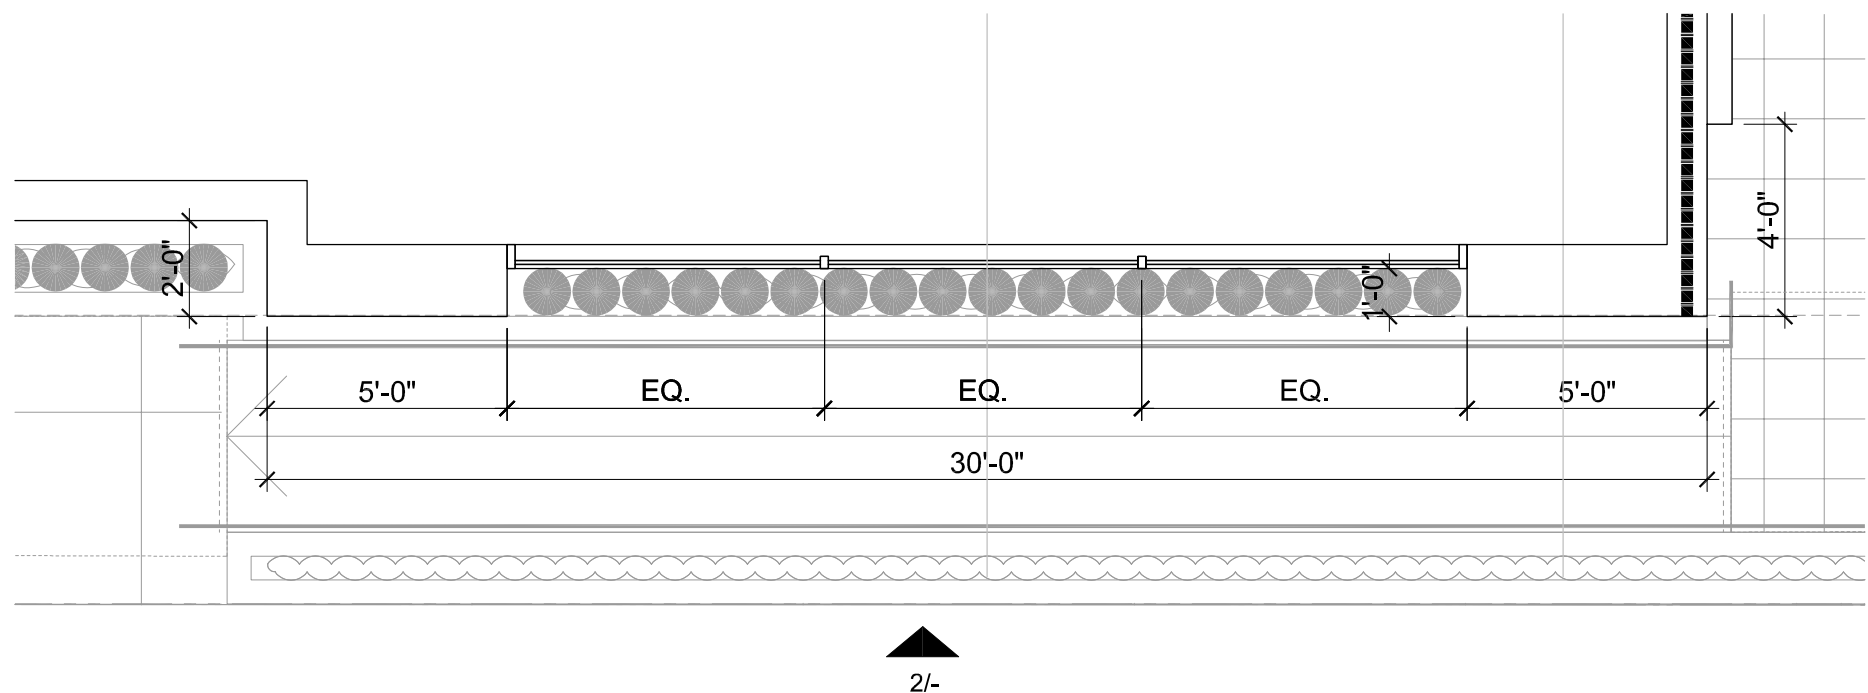

1 FIRST FLOOR PLAN
1/4"=1'-0"




ARCHITECTS
KORTH SUNSERI HAGEY

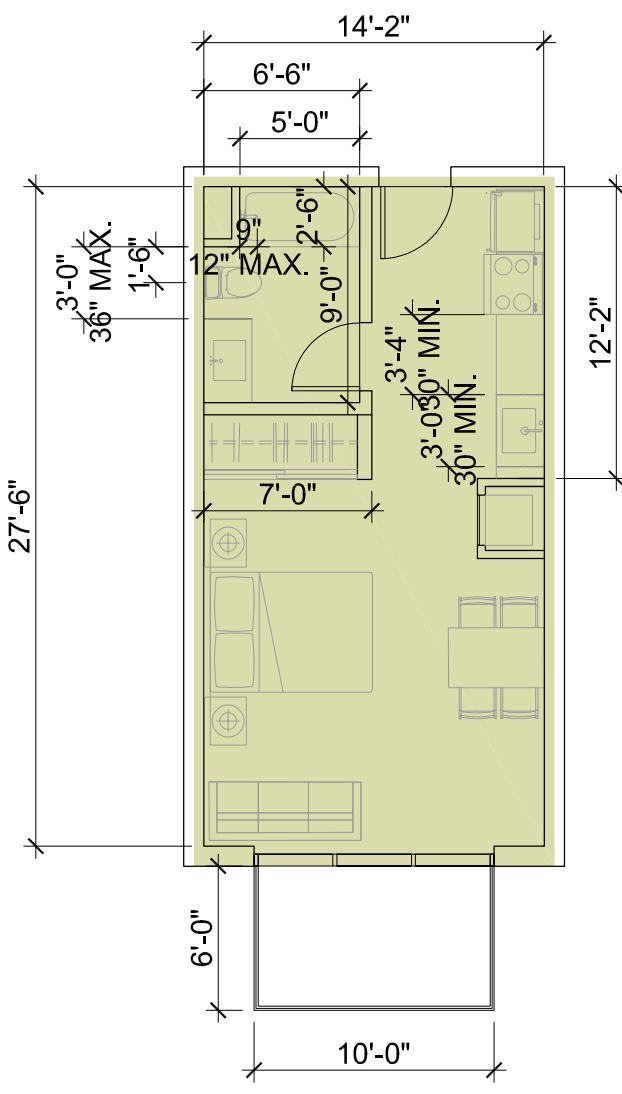


UNIT TYPE A1_STUDIO_432 SF
TERRACE _60 SF
STUDIO

6 UNIT TYPE A1

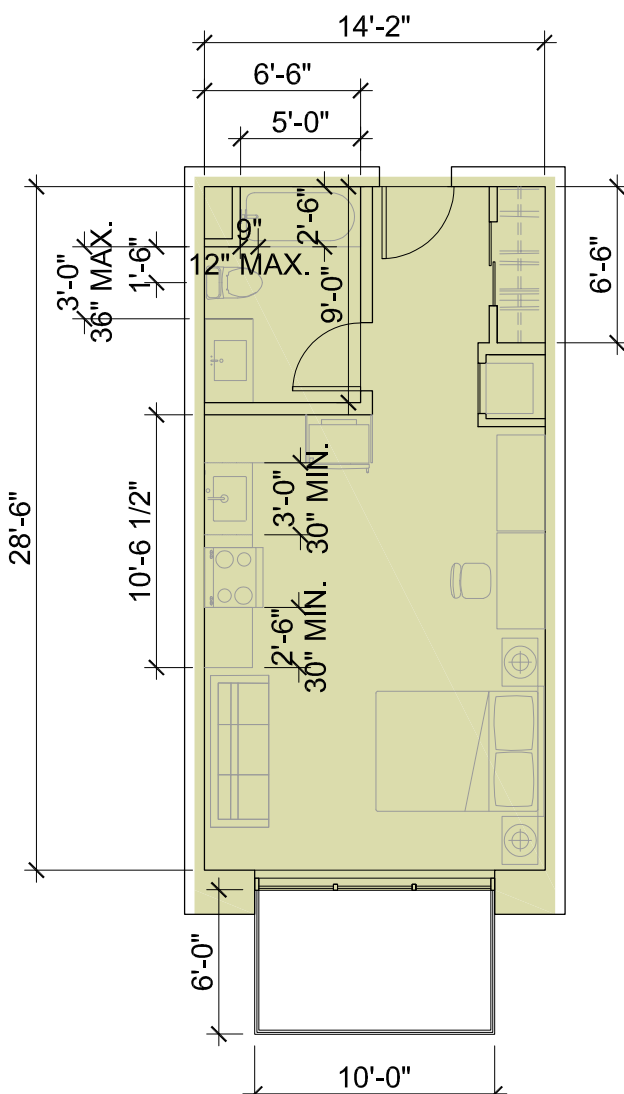


UNIT TYPE A2_STUDIO_452 SF
TERRACE _60 SF
STUDIO

6 UNIT TYPE A2

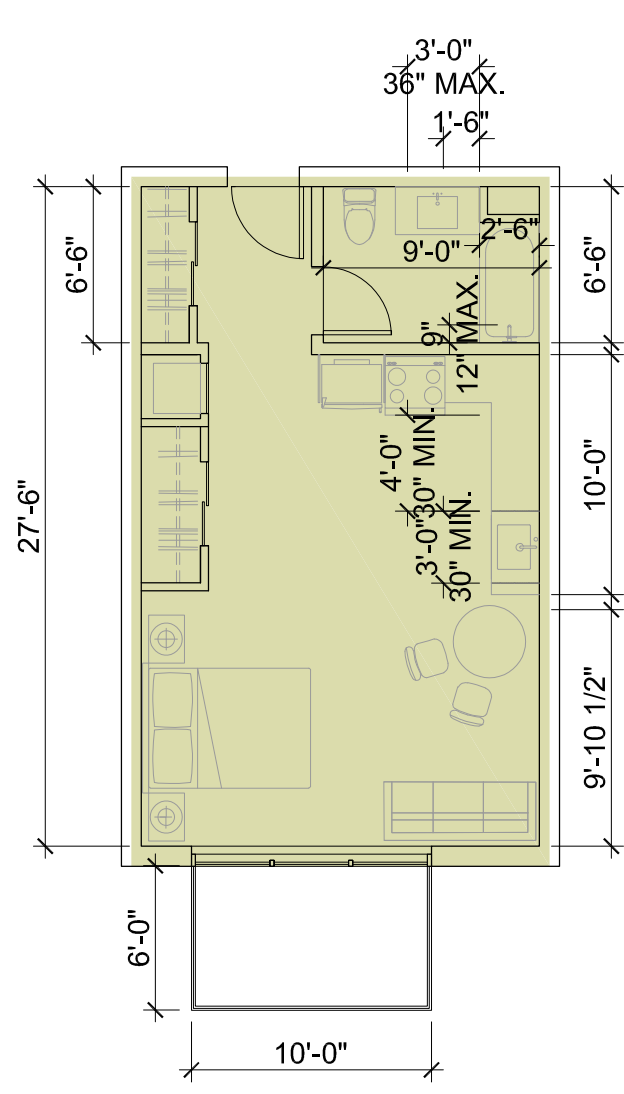


UNIT TYPE A3_1 BEDROOM_500 SF
TERRACE _60 SF
STUDIO

3 UNIT TYPE A3

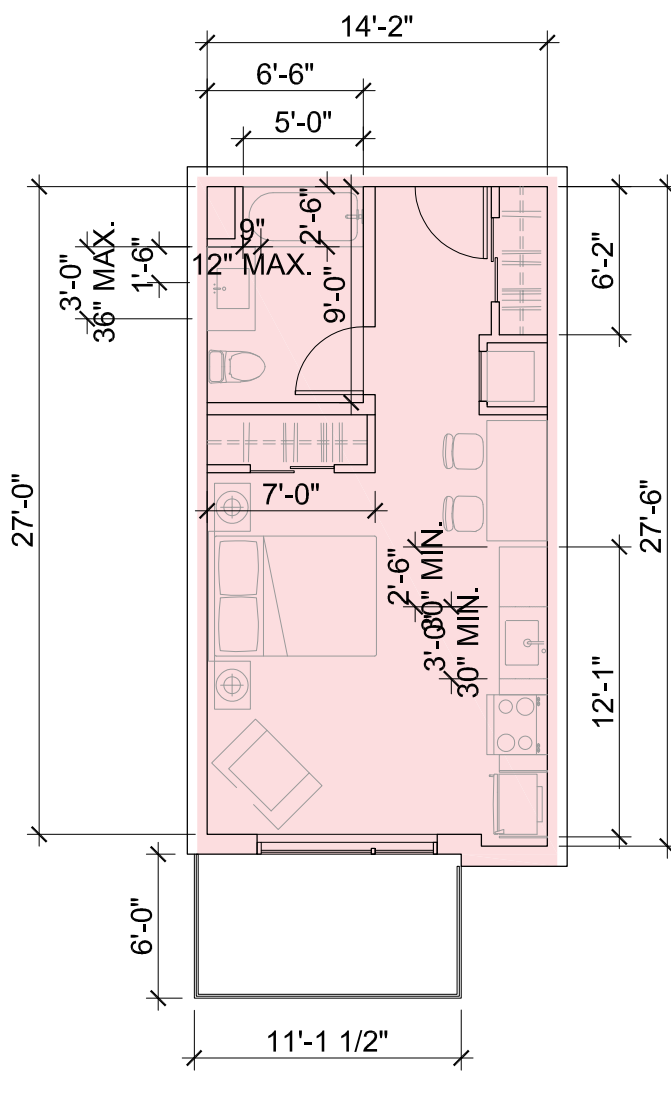


UNIT TYPE B1_STUDIO_425 SF
TERRACE _66 SF
STUDIO

8 UNIT TYPE B1

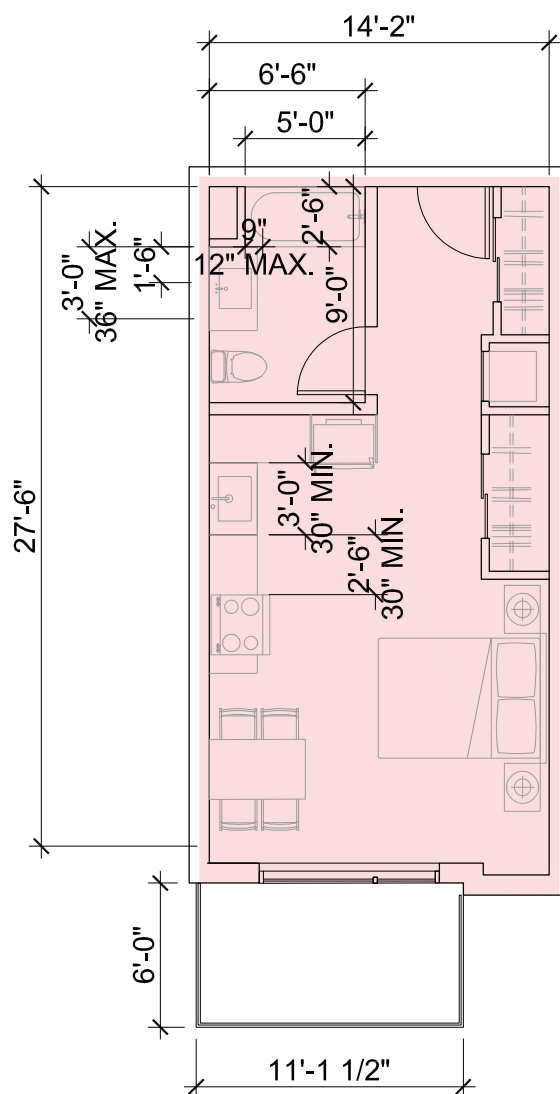


UNIT TYPE B2_STUDIO_443 SF
TERRACE _66 SF
STUDIO

5 UNIT TYPE B2

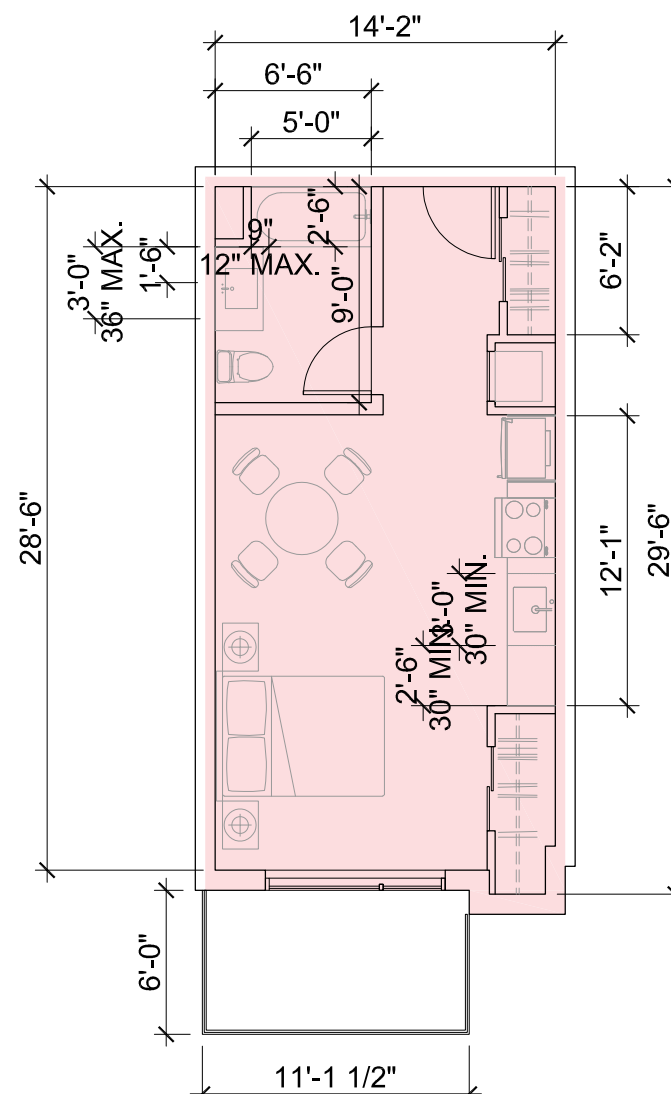


UNIT TYPE B3_STUDIO_450 SF
TERRACE _66 SF
STUDIO

10 UNIT TYPE B3

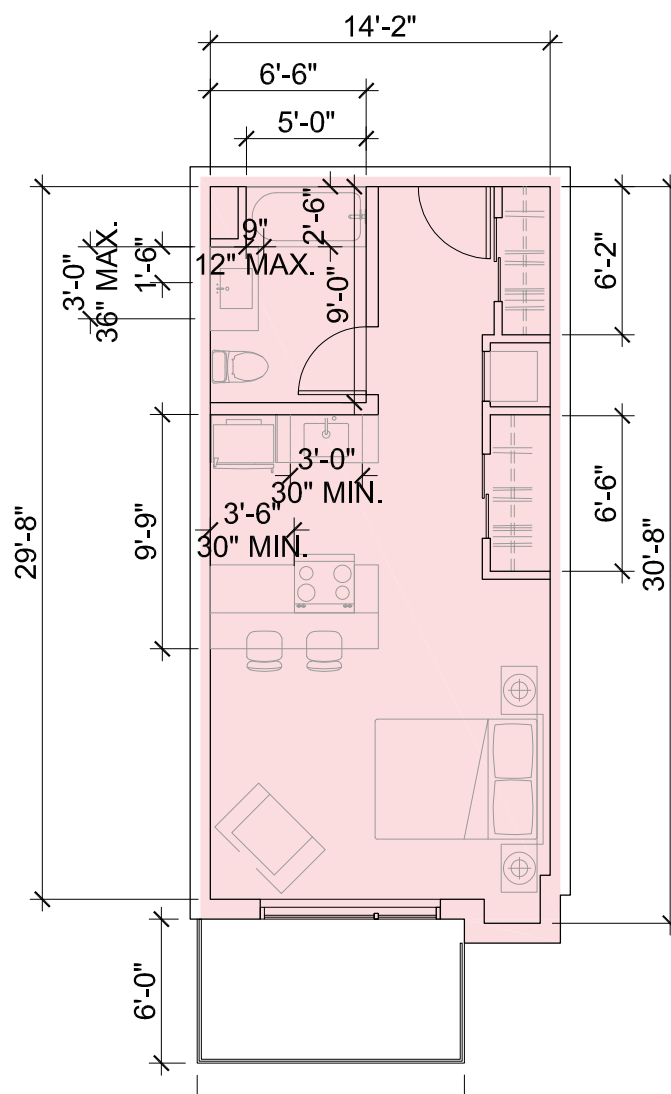


UNIT TYPE B4_STUDIO_468 SF
TERRACE _66 SF
STUDIO

6 UNIT TYPE B4

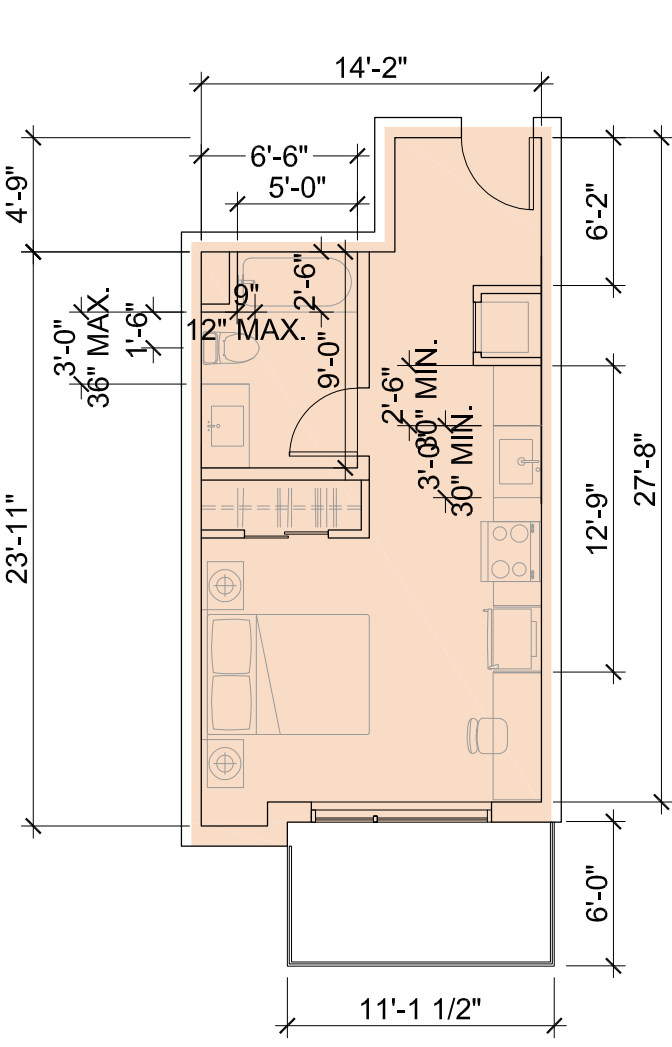


UNIT TYPE C_STUDIO_400 SF
TERRACE _66 SF
STUDIO

2 UNIT TYPE C

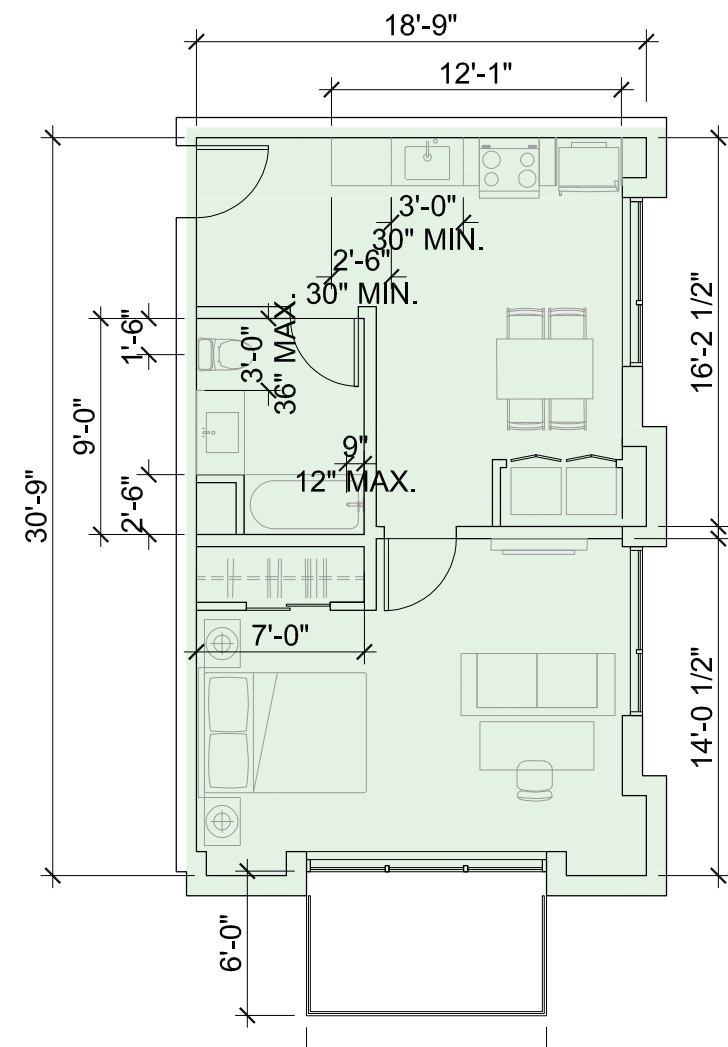


UNIT TYPE D_1 BEDROOM_611 SF
TERRACE _60 SF
1 BEDROOM

5 UNIT TYPE D

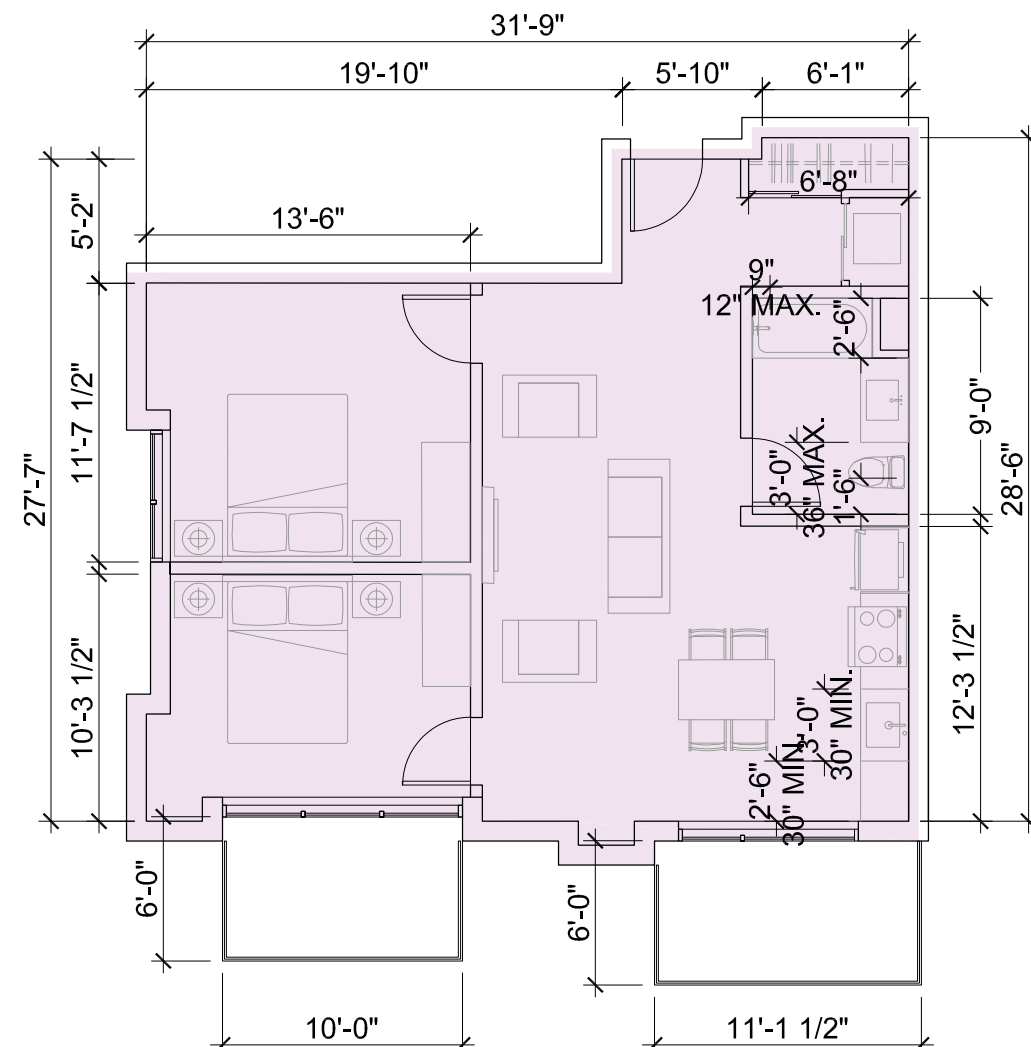


UNIT TYPE E1_2 BEDROOM_836 SF
TERRACE 1_60 SF
TERRACE 2_66 SF
2 BEDROOM

3 UNIT TYPE E1

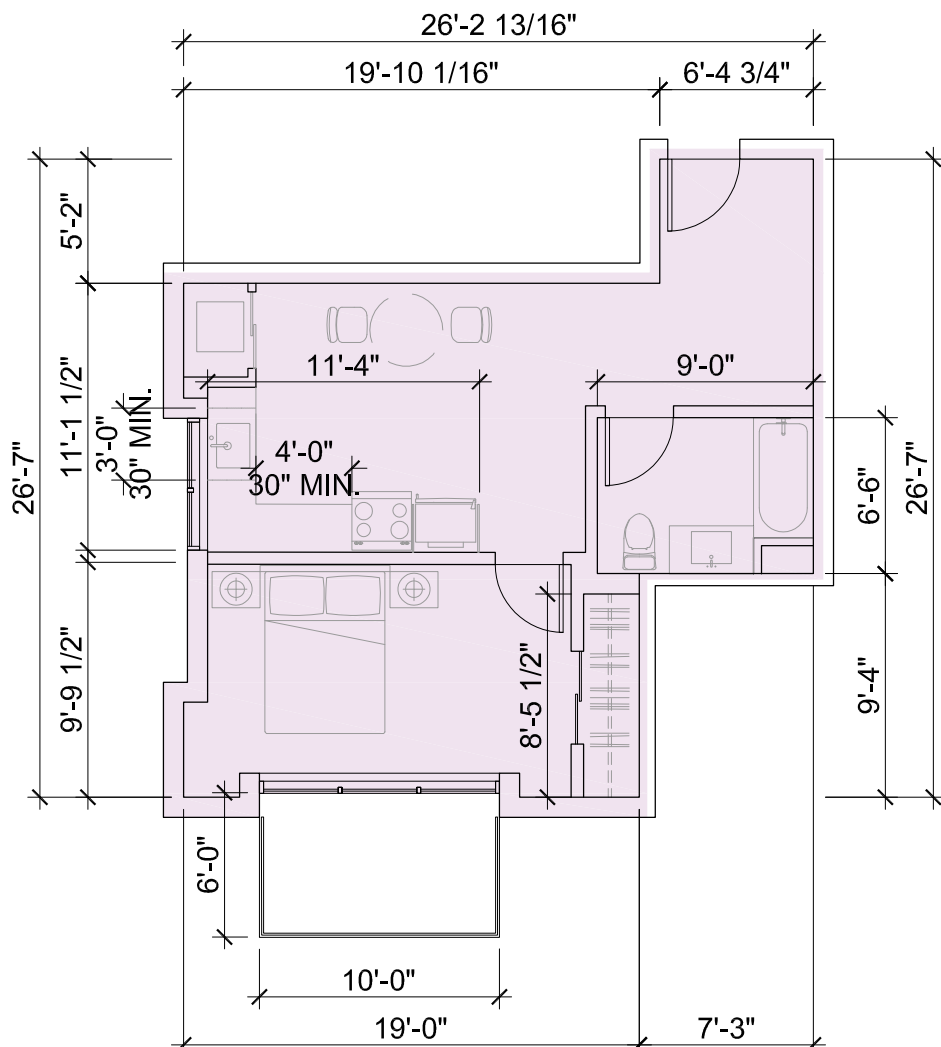


UNIT TYPE E2_1 BEDROOM_567 SF
TERRACE _60 SF
1 BEDROOM

3 UNIT TYPE E2

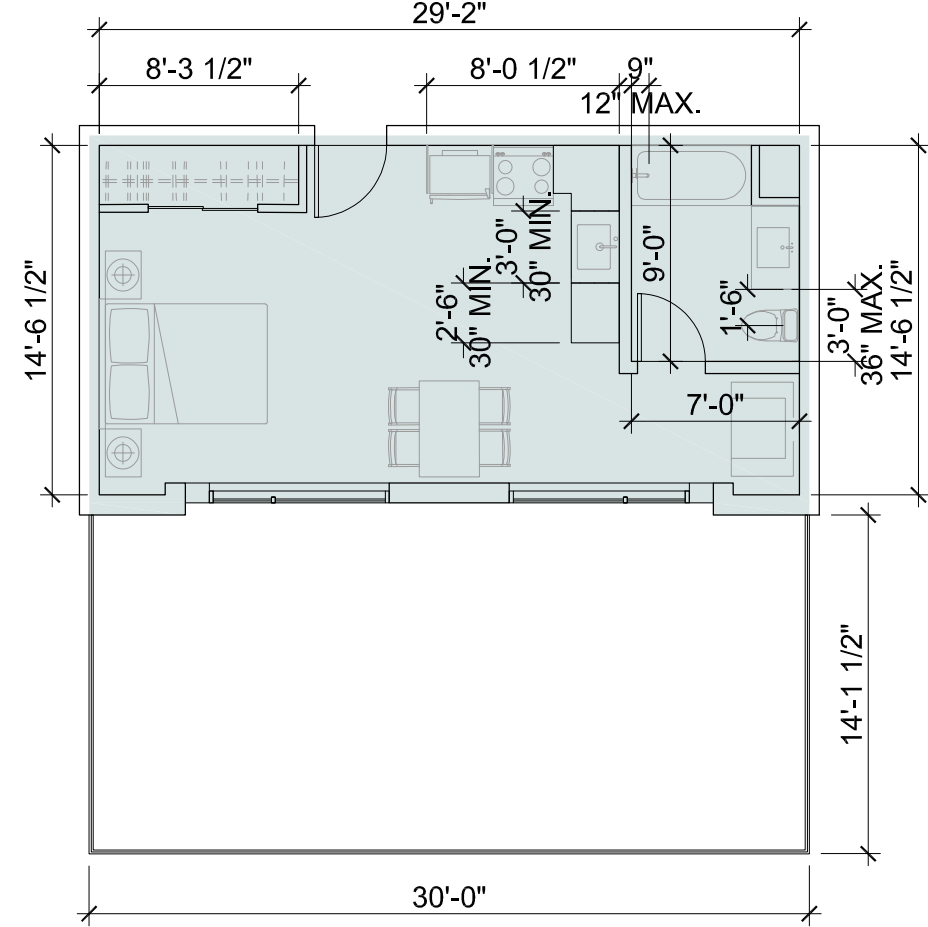


UNIT TYPE F1_STUDIO_463 SF
TERRACE _435 SF
STUDIO

2 UNIT TYPE F1

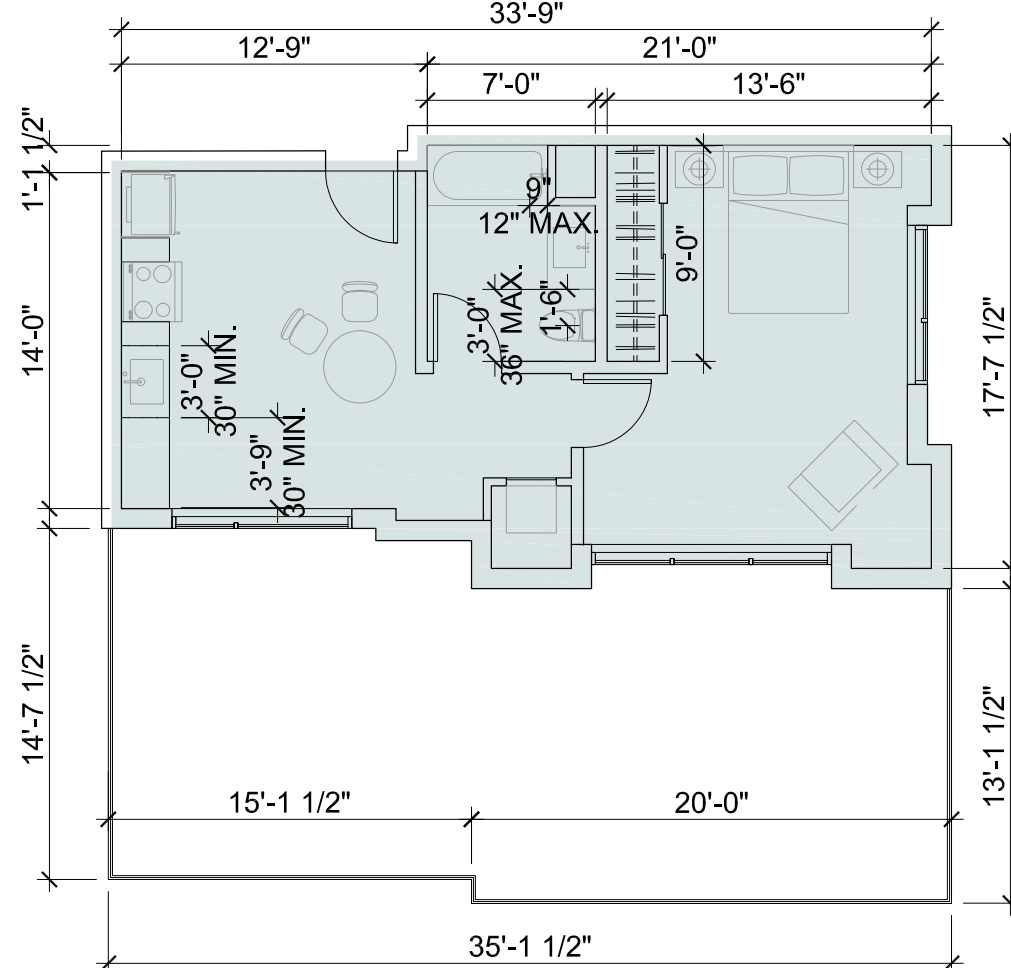

UNIT TYPE F2_1 BEDROOM_593 SF
TERRACE _492 SF
1 BEDROOM

1 UNIT TYPE F2

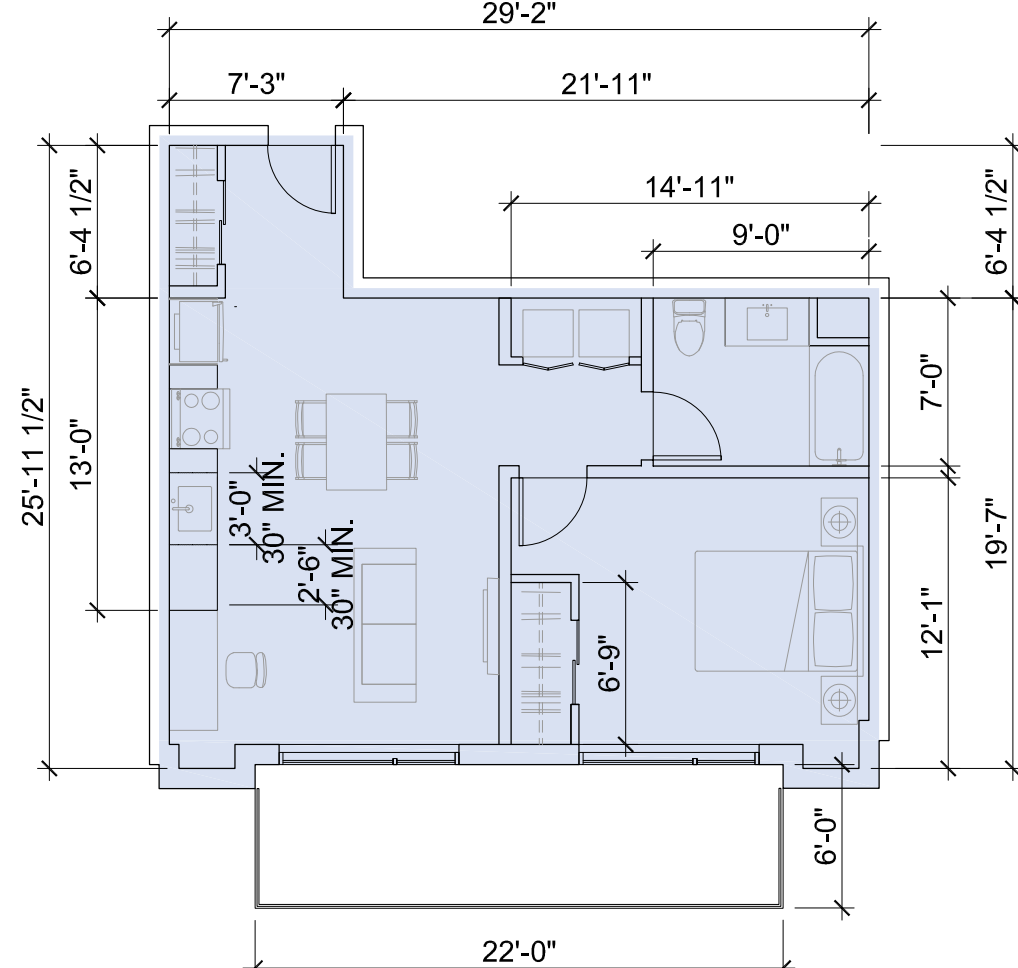

UNIT TYPE G1_1 BEDROOM_655 SF
TERRACE _132 SF
1 BEDROOM

3 UNIT TYPE G

NOTES:
SEE OVERALL PLANS (SHEETS A2.2A - A2.3) FOR ACTUAL BALCONY CONFIGURATION
INCLUDED ON THIS SHEET ARE TYPICAL CONDITIONS ONLY
NOT ALL UNITS ARE PROVIDED WITH A BALCONY


ISSUES AND REVISIONS

NO.	DATE	DESCRIPTION
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	12.21.23	PLANNING RESUBMITTAL #6
	02.07.24	PLANNING RESUBMITTAL #7

PROJECT NUMBER
21003






SHEET TITLE
PROPOSED UNIT PLANS

SCALE
1/8" = 1'-0"

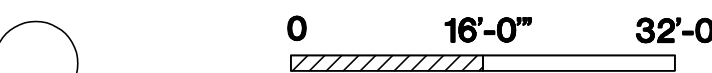

SHEET NUMBER

A5.1

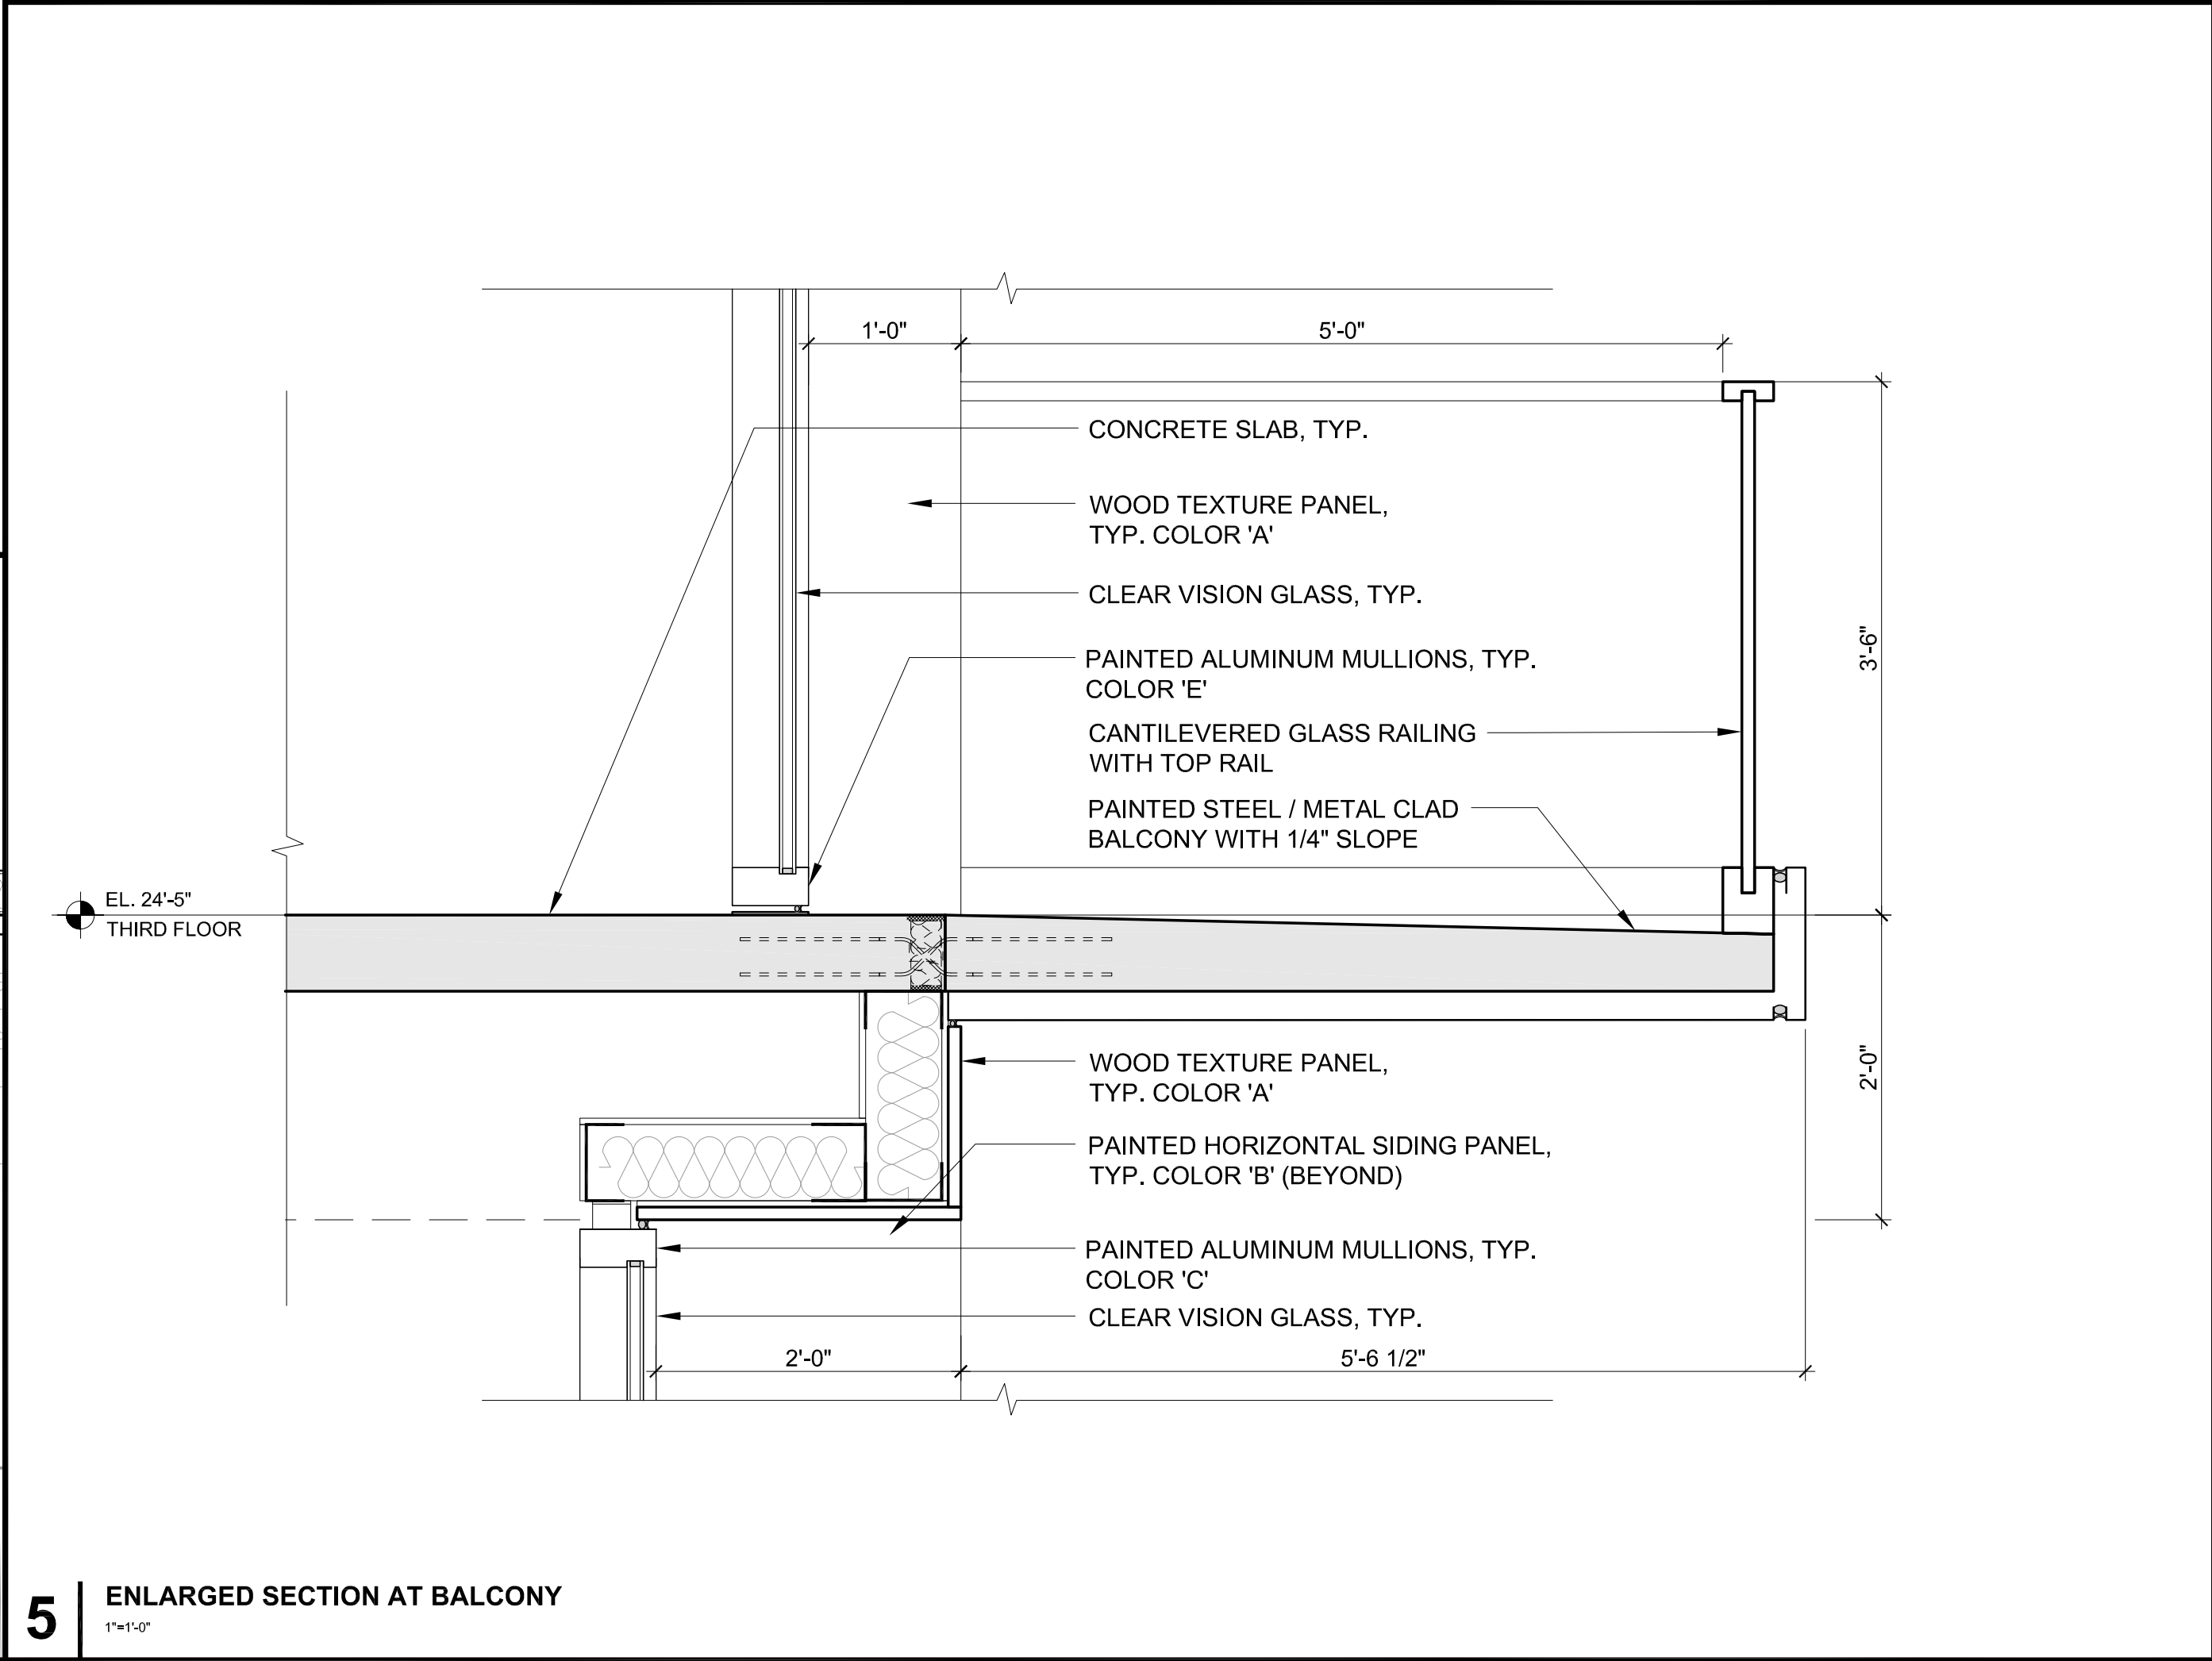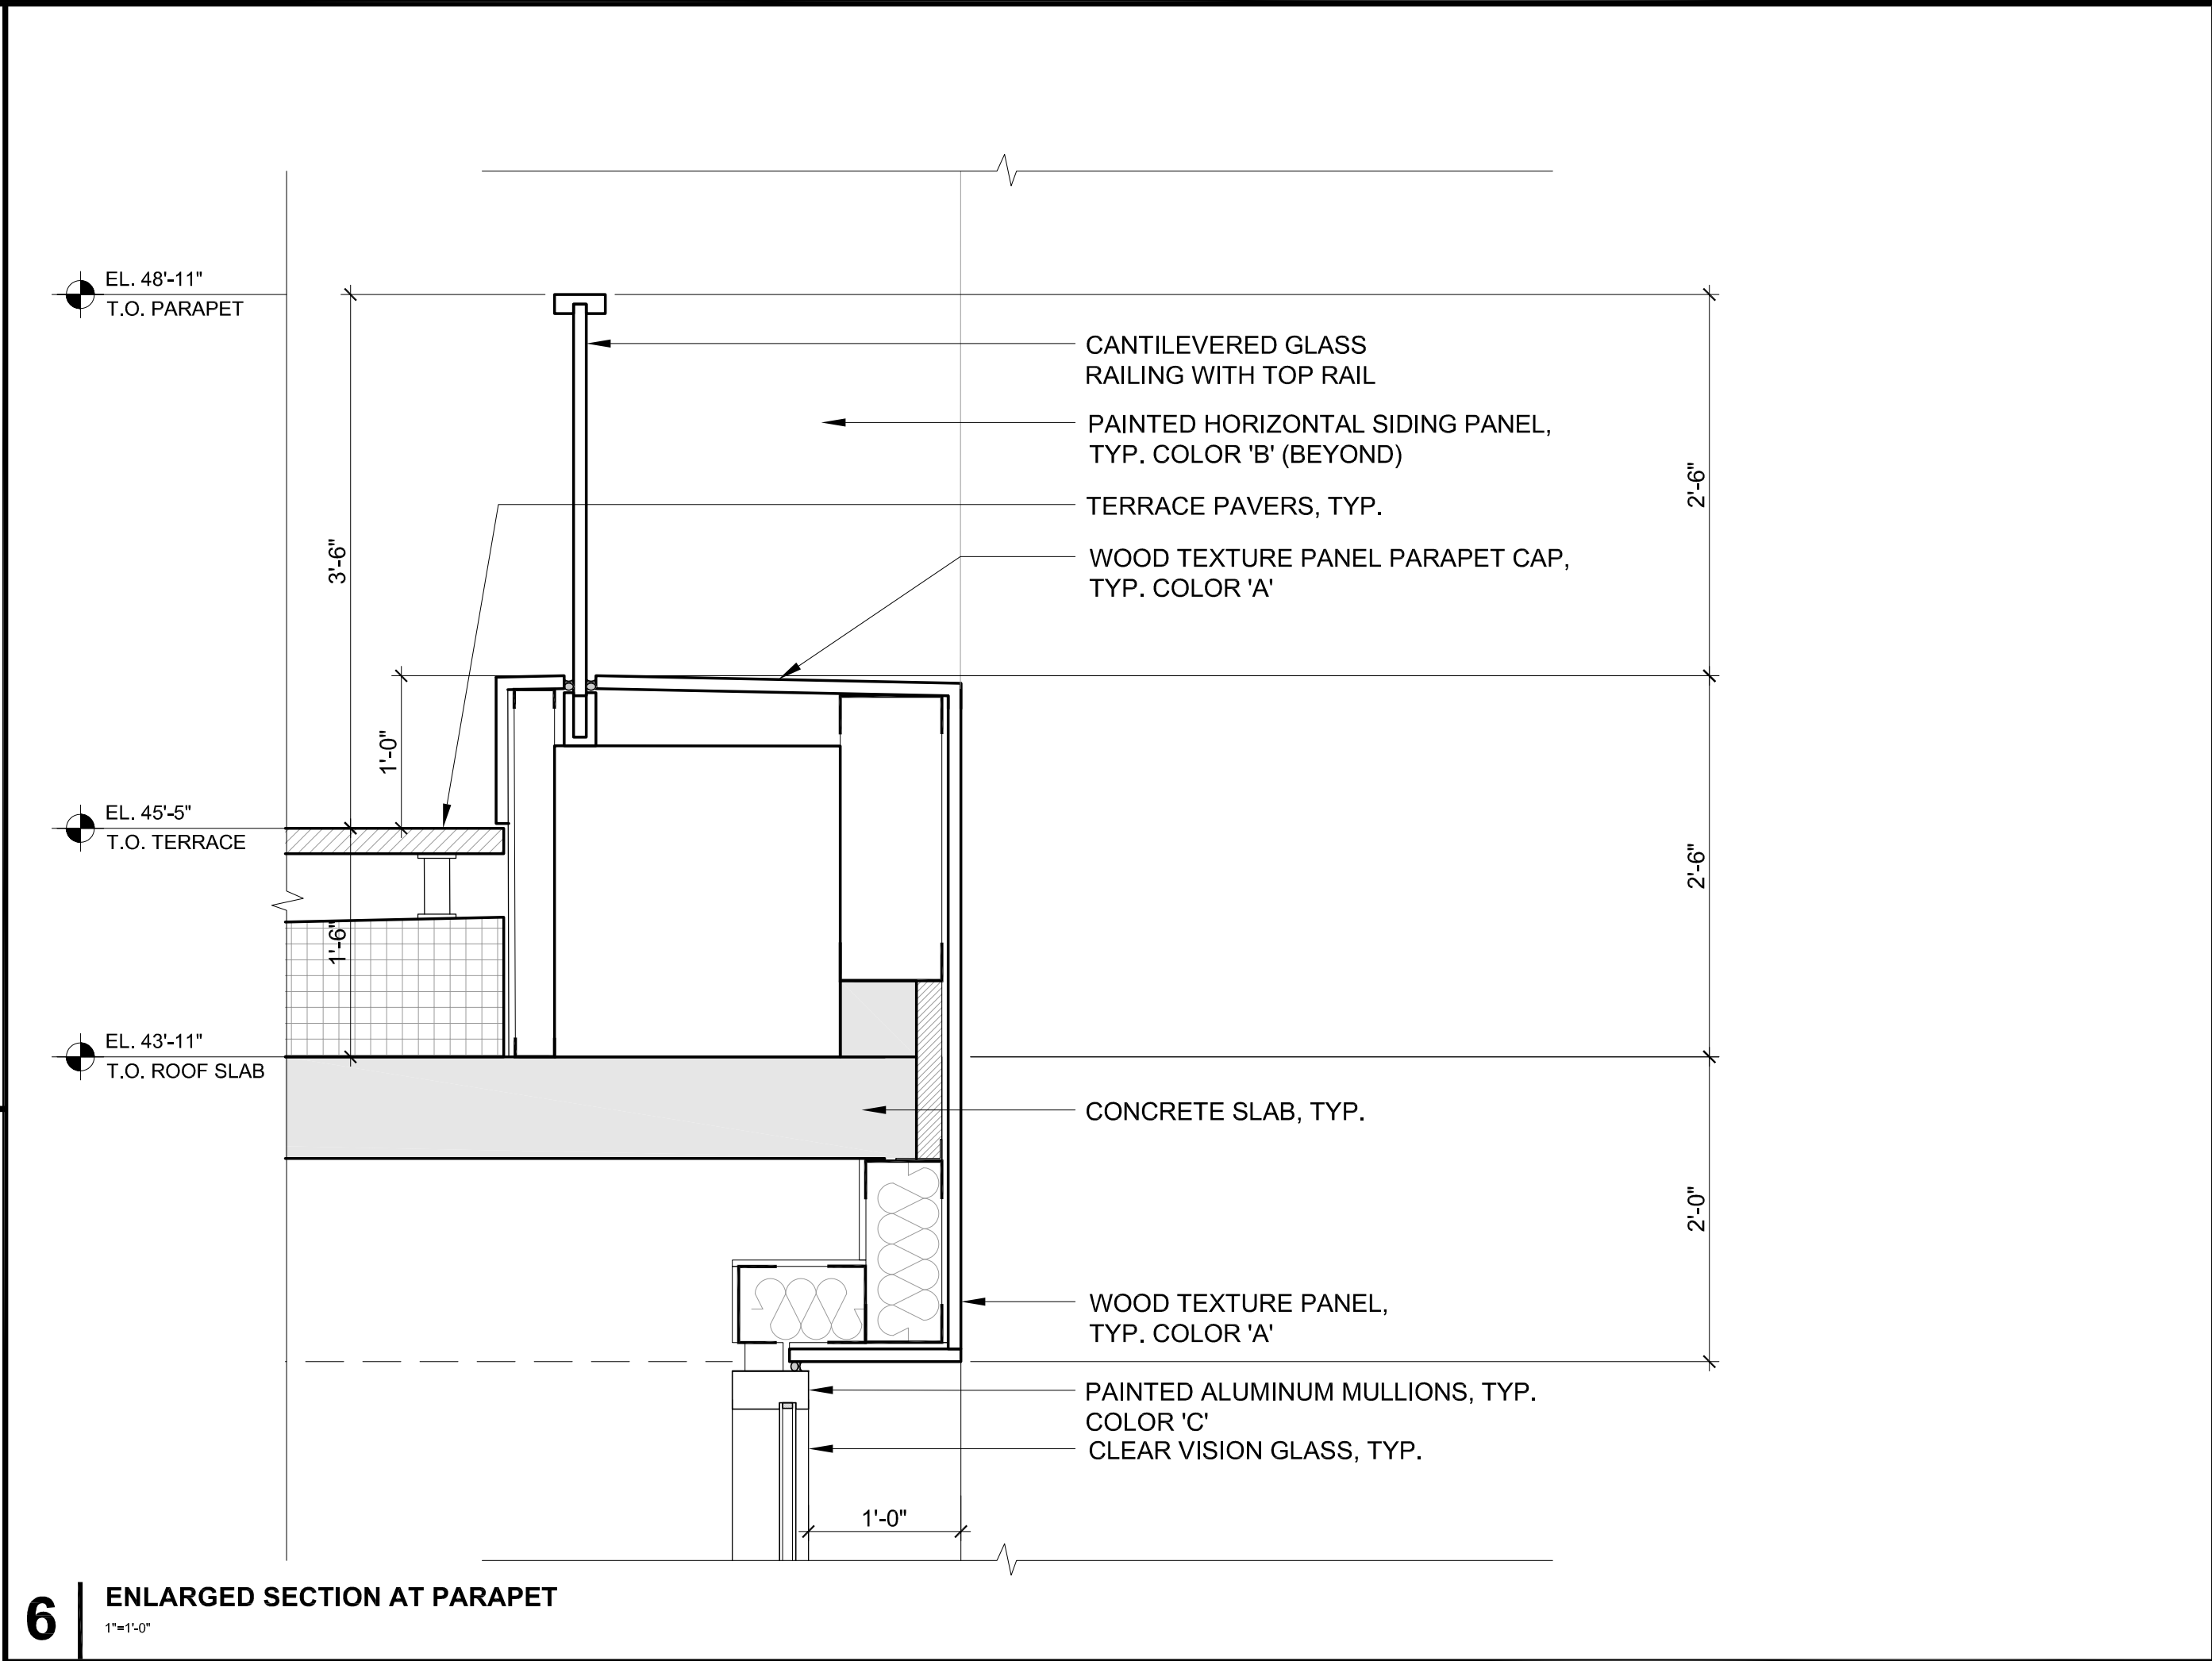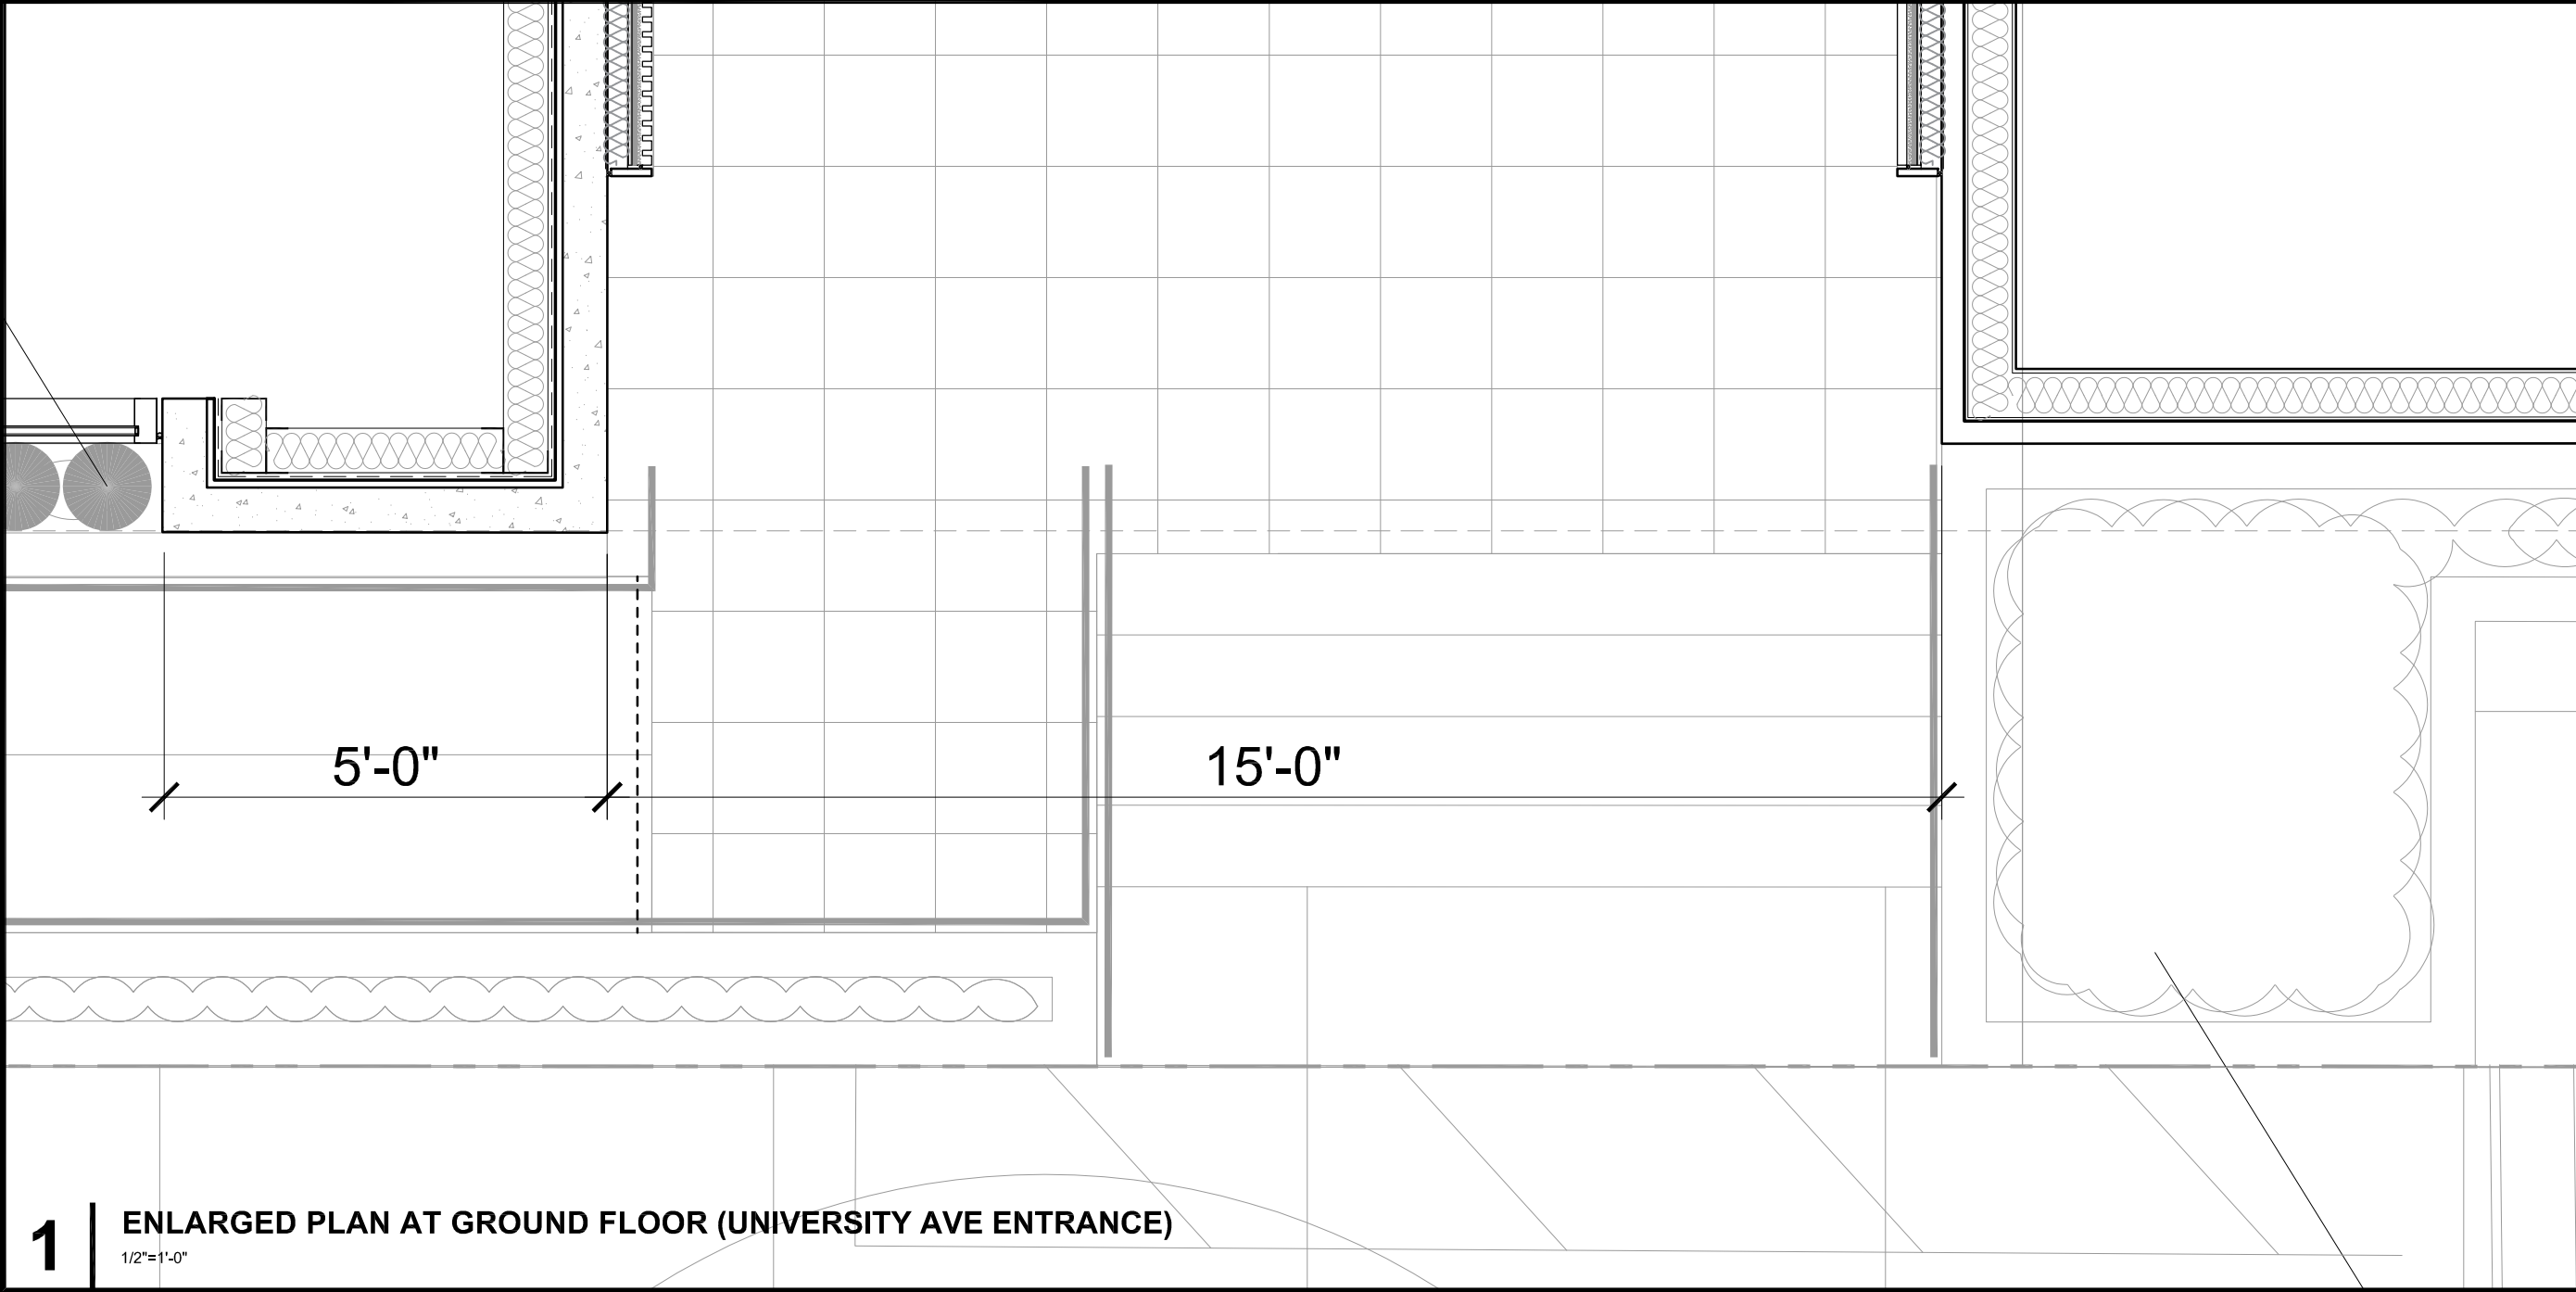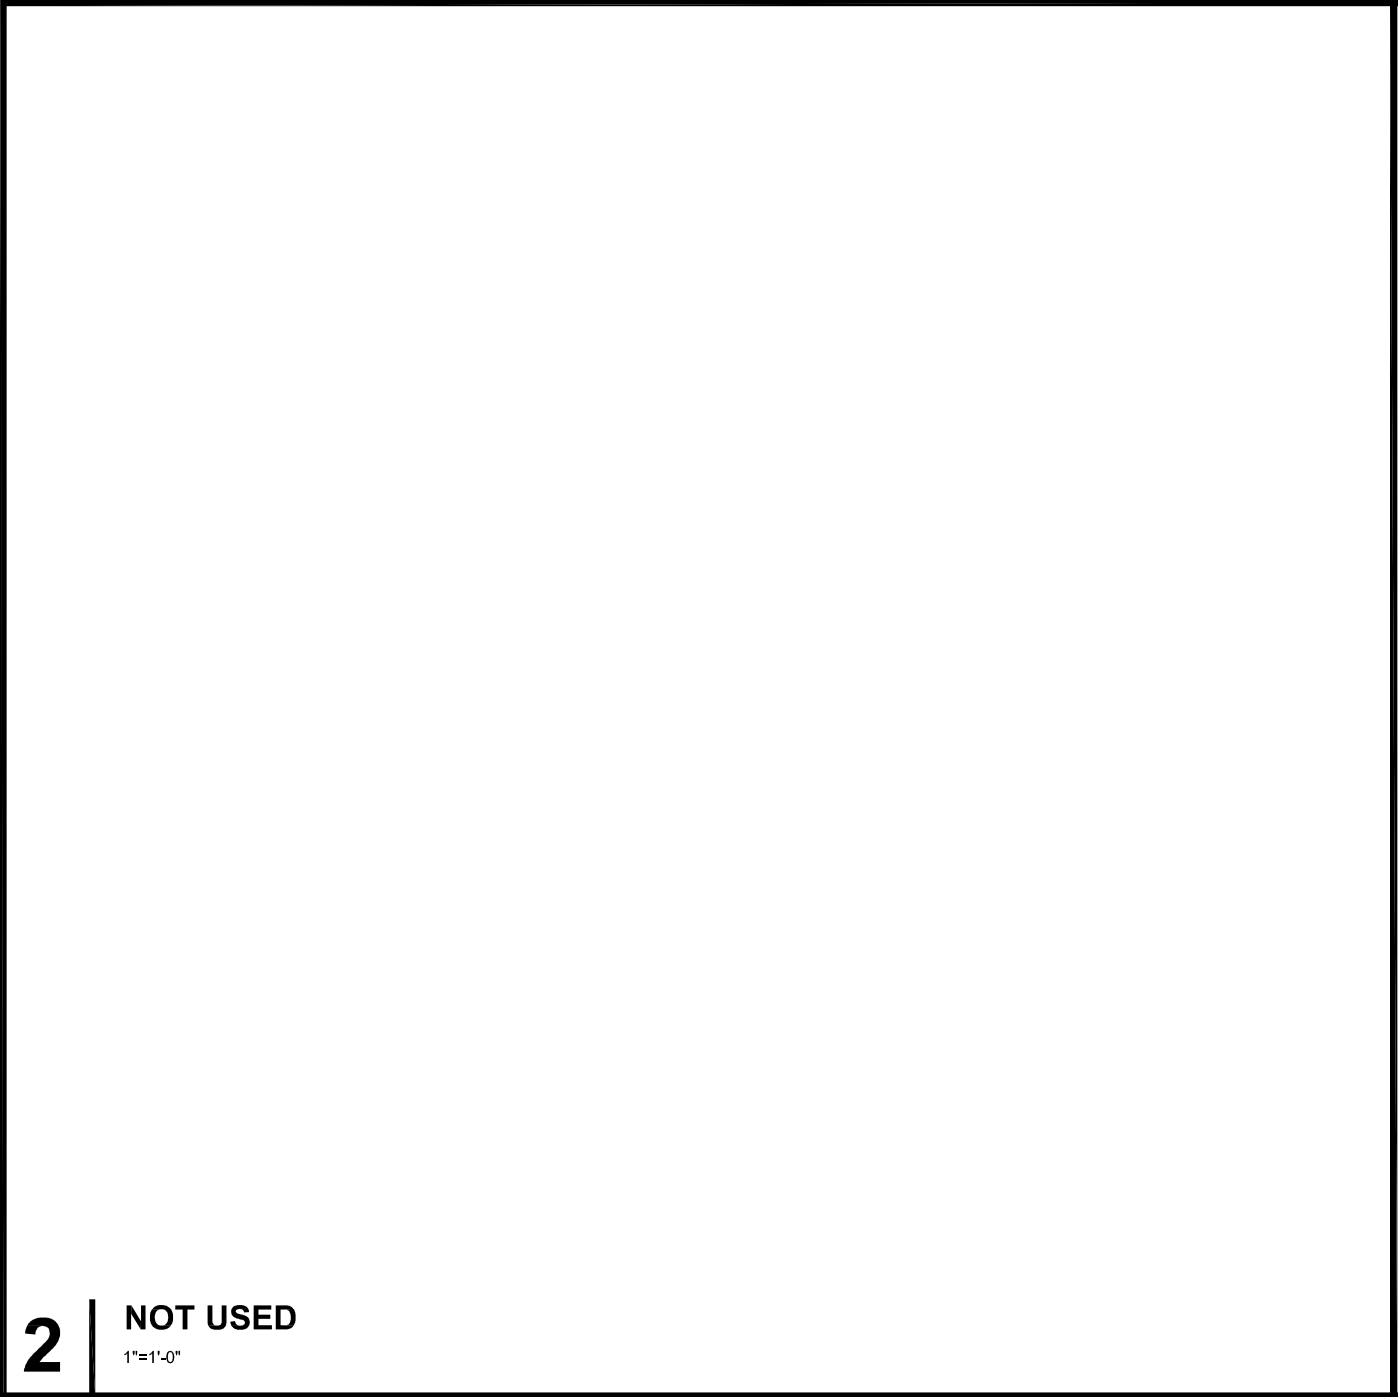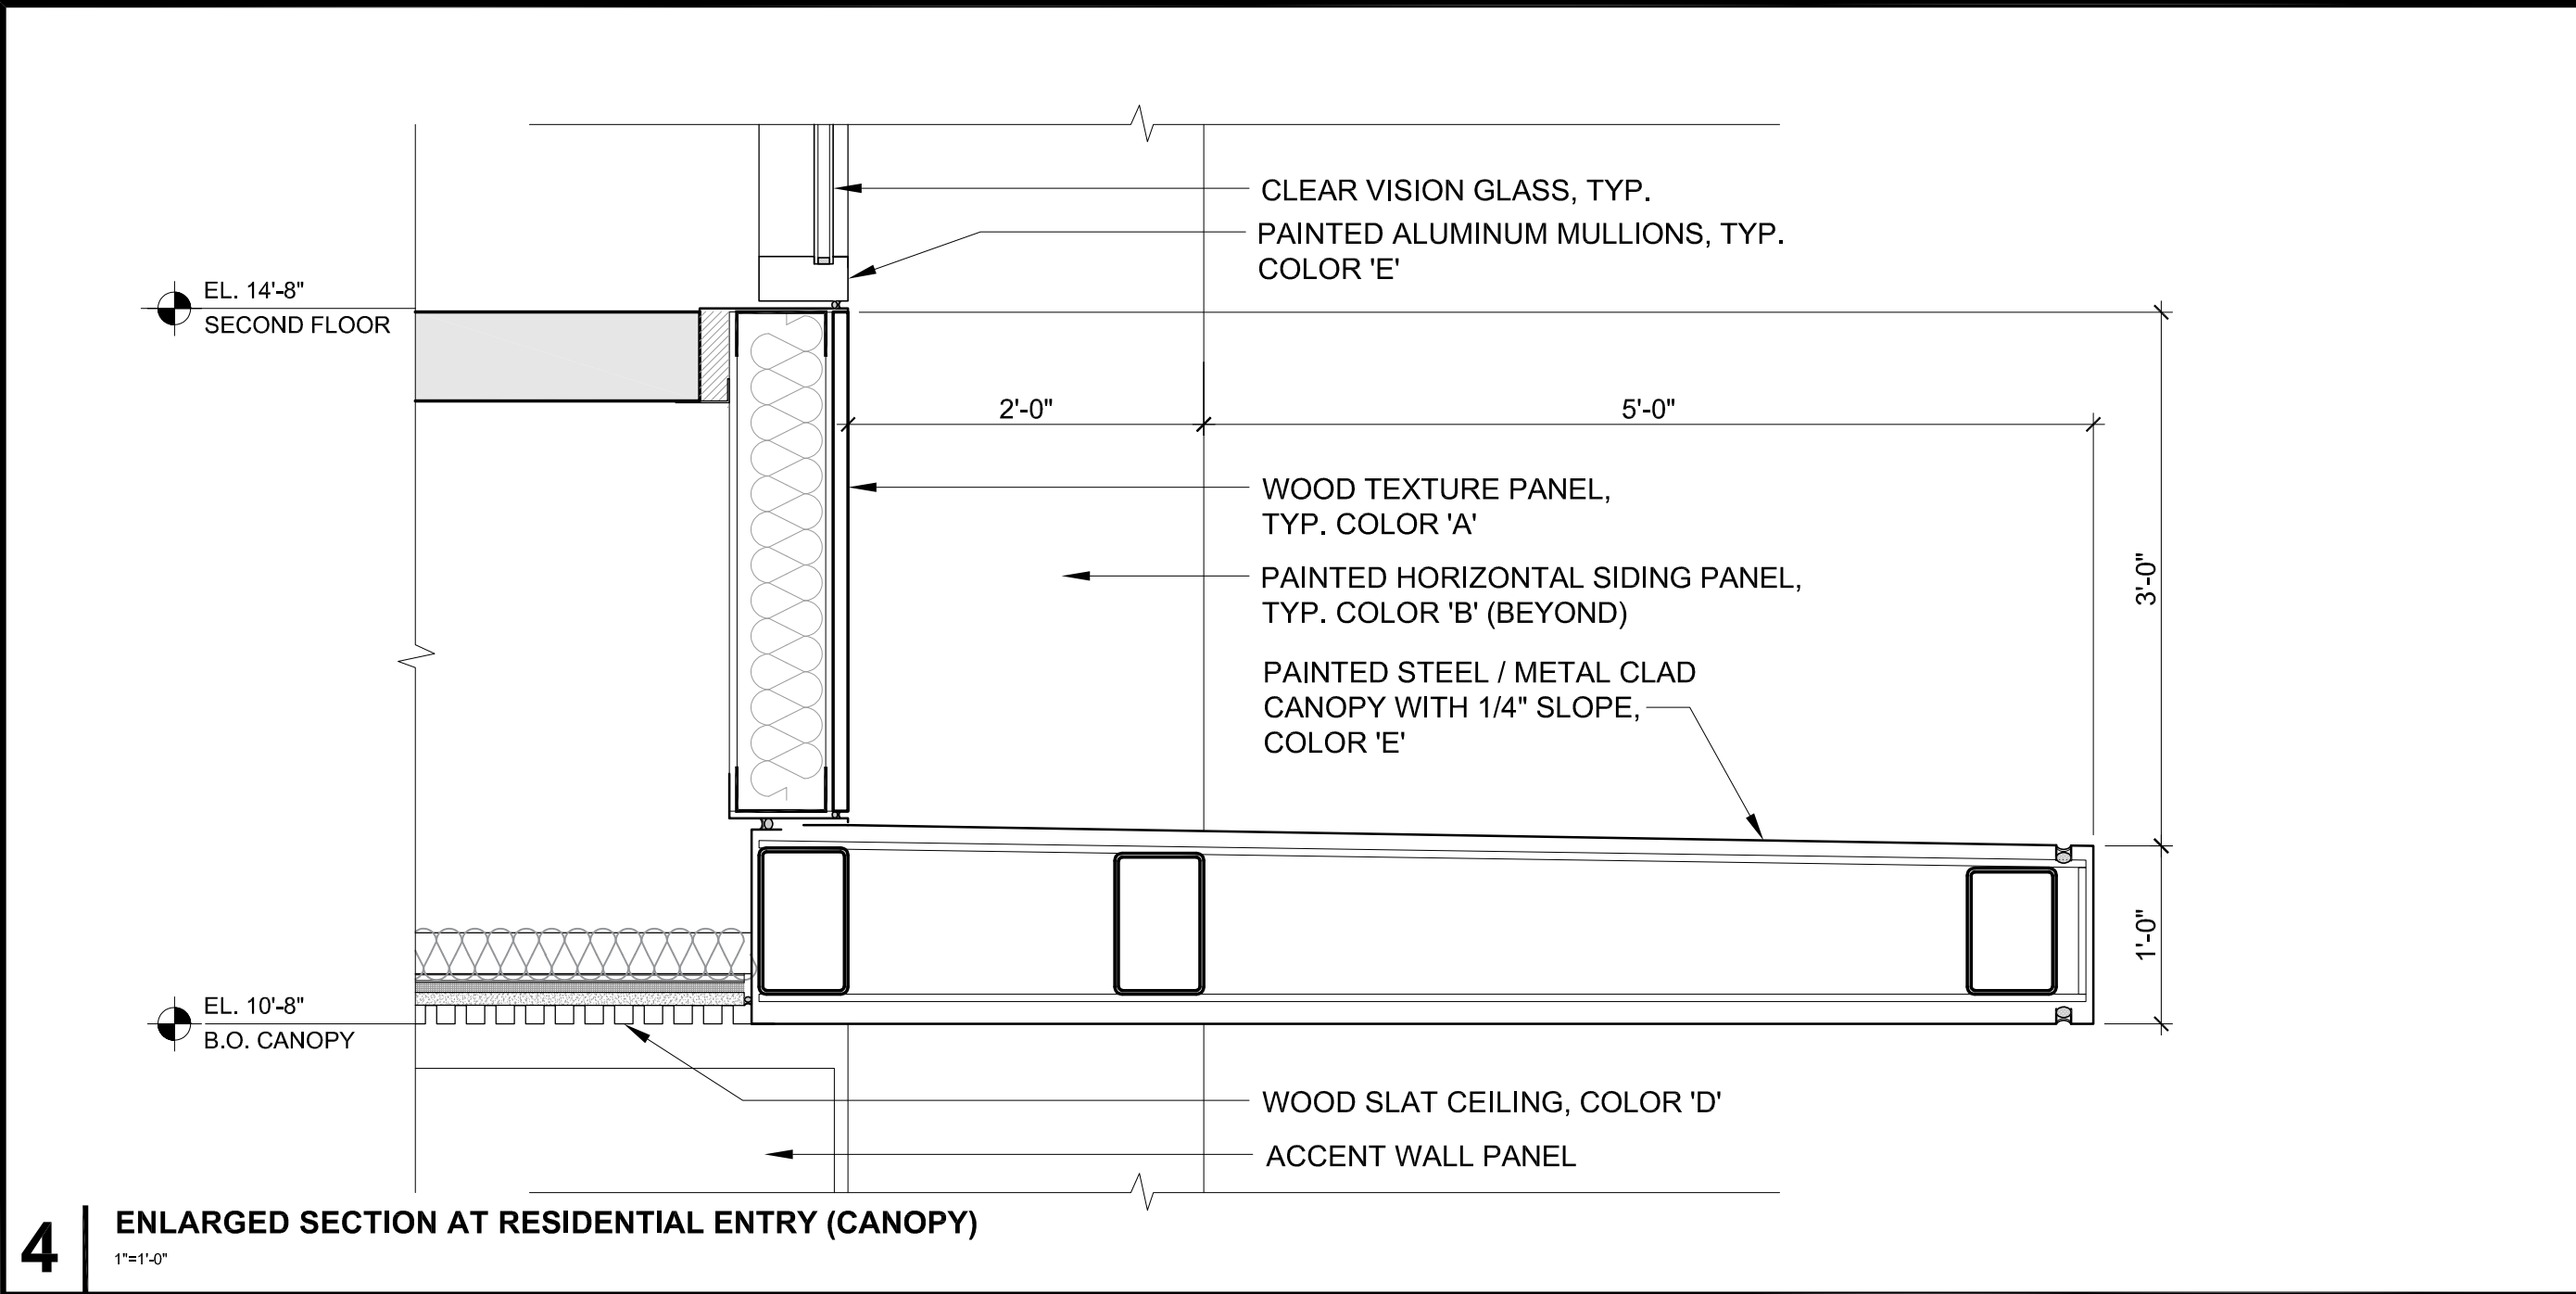

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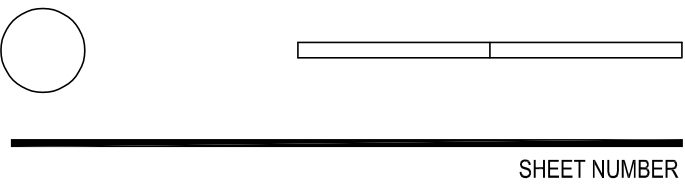


ISSUES AND REVISIONS		
NO.	DATE	DESCRIPTION
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10.31.23		PLANNING RESUBMITTAL #5
12.20.23		PLANNING RESUBMITTAL #6
02.07.24		PLANNING RESUBMITTAL #7

PROJECT NUMBER
21003

SHEET TITLE
ENLARGED DETAILS

SCALE
AS NOTED



SHEET NUMBER

A8.10