

DISH WIRELESS SITE ID: SFSFO00398A

DISH WIRELESS SITE ADDRESS:

724 ARASTRADERO RD

PALO ALTO, CA 94304

INSTALLATION OF TELECOMMUNICATION SITE

IF USING 11"X17" PLOT, DRAWINGS WILL BE HALF SCALE APPLICABLE CODES

CONSTRUCTION DRAWING

ALL WORK AND MATERIALS SHALL BE PERFORMED AND INSTALLED IN ACCORDANCE WITH THE CURRENT EDITIONS OF THE FOLLOWING CODES AS ADOPTED BY THE LOCAL GOVERNING AUTHORITIES.

- CALIFORNIA ADMINISTRATIVE CODE (INCL TITLE 24 & 25)
- 2019 CALIFORNIA BUILDING CODE
- CITY/COUNTY ORDINANCES
- BUILDING OFFICIALS & CODE ADMINISTRATORS (BOCA) 2019 MECHANICAL CALIFORNIA CODE
- ANSI/EIA-222-F LIFE SAFETY CODE NFPA-101 2019 CALIFORNIA PLUMBING CODE
- 2019 CALIFORNIA ELECTRICAL CODE LOCAL BUILDING CODE

GENERAL NOTES

THE FACILITY IS UNMANNED AND NOT FOR HUMAN HABITATION. HANDICAPPED ACCESS REQUIREMENTS ARE NOT REQUIRED IN ACCORDANCE WITH THE 2019 CALIFORNIA BUILDING CODE. A TECHNICIAN WILL VISIT THE SITE AS REQUIRED FOR ROUTINE MAINTENANCE. THE PROJECT WILL NOT RESULT IN ANY SIGNIFICANT DISTURBANCE OR EFFECT ON DRAINAGE, NO SANITARY SEWER SERVICE, POTABLE WATER, OR TRASH DISPOSAL IS REQUIRED AND NO COMMERCIAL SIGNAGE IS

SITE INFORMATION

PROPERTY OWNER

SASAKI GO SR TRUSTEE & ET AL & SASAKI KAY K TRUSTEE PO BOX 536 LOS ALTOS, CA 94023

DISH WIRELESS 5701 S SANTA FE DR LITTLETOWN, CO 80120

LATITUDE: 37.401083° LONGITUDE -122.131833*

NAD-83 LAT/LONG TYPE:

GROUND ELEVATION: ±90' AMSL

ZONING JURISDICTION CITY OF PALO ALTO

CURRENT ZONING: RM40 - HIGH DENSITY MULTIPLE FAMILY RESIDENCE DISTRICT

137-29-017 ASSESSOR'S PARCEL NO.

UNMANNED TELECOMMUNICATIONS FACILITY PROPOSED USE:

TYPE OF CONSTRUCTION: TYPE V

OCCUPANCY GROUP: R-2 ±164 S.F. FOUIPMENT LEASE AREA (SE):

PROJECT TEAM

5701 S SANTA FE DR LITTLETOWN, CO 80120

SITE ACQUISITION: QUALTEK WIRELESS 1200 DEL PASO RD, STE 150 SACRAMENTO CA 95843 EMAIL: NCA_DISH@QUALTEKWIRELESS.COM

EMAIL: JROBERSON@QUALTEKWIRELESS.COM

CONSTRUCTION MANAGER:
QUALTEK WIRELESS
1200 DEL PASO RD, STE 150
SACRAMENTO, CA 95843
CONTACT: JOSHUA ROBERSON
PH: (949) 505-4225-6433

DISH WIRELESS 5701 S SANTA FE DR LITTLETOWN, CO 80120 CONTACT: POOJA SHAH

1387 CALLE AVANZADO SAN CLEMENTE, CA 92673 CONTACT: MICHAEL MONTELLO

PH: (949) 391-6824

SITE PHOTO

DRIVING DIRECTIONS

DIRECTIONS FROM SAN FRANCISCO INTERNATIONAL AIRPORT:

- HEAD SOUTH
 KEEP LEFT, FOLLOW SIGNS FOR US-101 S/SAN JOSE AND MERGE
 ONTO US-101 S
 TAKE EXIT 400C TO MERGE ONTO SAN ANTONIO RD
 MERGE ONTO SAN ANTONIO RD
 TURN RIGHT ONTO E CHARLESTON RD
 CONTINUE ONTO ARASTRADERO RD
 CONTINUE STRAIGHT TO STAY ON ARASTRADERO RD

VICINITY MAP

99

9

- 8. TURN RIGHT 9. DESTINATION WILL BE ON THE RIGHT

PROJECT DESCRIPTION

THIS IS NOT AN ALL INCLUSIVE LIST. CONTRACTOR SHALL UTILIZE SPECIFIED EQUIPMENT PART OR ENGINEER APPROVED EQUIVALENT. CONTRACTOR SHALL VERIFY ALL NEEDED EQUIPMENT TO PROVIDE A FUNCTIONAL SITE.

THE PROJECT GENERALLY CONSISTS OF THE FOLLOWING:

SECTOR SCOPE OF WORK:

- INSTALL (1) NEW ANTENNA MOUNT
 INSTALL (3) NEW PANEL ANTENNAS (1 PER SECTOR)
 INSTALL (3) FUTURE PANEL ANTENNAS (1 PER SECTOR)
- INSTALL (3) NEW DUAL STANDOFF ARM MOUNTS (1 PER SECTOR)
 INSTALL (6) NEW RRUS (2 PER SECTOR)
- INSTALL (6) FUTURE RRUS (2 PER SECTOR)
 INSTALL (1) NEW SURGE SUPPRESSION DEVICE
 INSTALL (1) NEW HYBRID CABLE (±60')
 INSTALL PROPOSED JUMPERS

- OUTDOOR SCOPE OF WORK
- INSTALL (1) NEW CABINET
 INSTALL (1) NEW NEMA 3 TELCO-FIBER BOX
 INSTALL (1) NEW GPS ANTENNA
- INSTALL (3) NEW 2" FIBER CONDUITS

REFERENCE RFDS REVISION 1, DATED 02/08/2022

DRAWING INDEX

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| | (T-2) A | RF-EME COMPLIANCE REPORT | | |
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| | (A-1) A | OVERALL AND ENLARGED SITE PLAN | | |
| | (A-2) (A | ANTENNA LAYOUT AND SCHEDULE | | |
| | (A-3) A | EQUIPMENT LAYOUT | | |
| | (A-4) <u>(A</u> | SOUTHWEST ELEVATION | | |
| | (A-5) <u>(A</u> | NORTHWEST ELEVATION | | |
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| | A-6 | EQUIPMENT DETAILS | | |
| | (A-7) <u>A</u> | EQUIPMENT DETAILS | | |
| | A-8 | EQUIPMENT DETAILS | | |
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| | E-1 | ELECTRICAL PLAN AND NOTES | | |
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| | E-3 ELECTRICAL ONE-LINE & PANEL SCHEDULE | | | |
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| | G-1 | GROUNDING PLANS AND NOTES | | |
| | G-2 | GROUNDING DETAILS | | |
| | G-3 | GROUNDING DETAILS | | |
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| 7 | RF-2 | PLUMBING DIAGRAM | | |
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| 2 | GN-1 | LEGEND AND ABBREVIATIONS | | |
| 3 | GN-2 | GENERAL NOTES | | |
| | GN-3 | GENERAL NOTES | | |
| | GN-4 | GENERAL NOTES | | |
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APPROVALS

HE FOLLOWING PARTIES HEREBY APPROVE AND ACCEPT THESE DOCUMENTS & AUTHORIZE THE SUBCONTRACTOR O PROCEED WITH THE CONSTRUCTION DESCRIBED HEREIN, ALL DOCUMENTS ARE SUBJECT TO REVIEW BY TH LOCAL BUILDING DEPARTMENT & MAY IMPOSE CHANGES OR MODIFICATIONS.

| DISH WIRELESS RF ENGINEER: | DATE: | |
|----------------------------|-----------|--|
| DISH WIRELESS OPERATIONS: | DATE: | |
| SITE ACQUISITION: | DATE: | |
| CONSTRUCTION MANAGER: | DATE: | |
| PROPERTY OWNER: | DATE: | |
| ZONING: | DATE: | |
| PROJECT MANAGER: | DATE: | |

DO NOT SCALE DRAWINGS

EXISTING DIMENSIONS & FIELD CONDITIONS ON THE JOB SITE & SHALL IMMEDIATELY NOTIFY THE ENGINEER IN WRITING OF ANY DISCREPANCIES BEFORE PROCEEDING WITH THE WORK OR BE RESPONSIBLE FOR SAME.



USA NORTH

Know what's below. Call before you dig.

Call Two Working Days Before You Dig 811 / 800-227-2600 usanorth.org



5701 S SANTA FE DR



1200 DEL PASO RD STE 150



DRAWN BY: CHECKED BY: MM

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| REV | DATE | DESCRIPTION |



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Loyall A. Wharton, P.E. Professional Engineer License: #C50547 Expiration Date: 06-30-2023

SFSFO00398A 724 ARASTRADERO RD PALO ALTO, CA 94304 **ROOFTOP**

SHEET TITLE


TITLE SHEET

SHEET NUMBER

T-1

RF-EME Compliance Report EBI Project No. 6222006788

Site No. SFSFO00398A 724 Arastradero Rd, Palo Alto, California

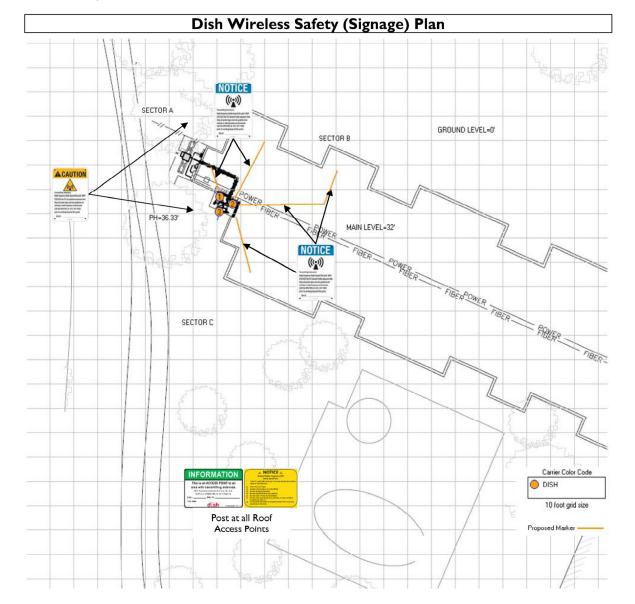

RF-EME Compliance Report EBI Project No. 6222006788 Site No. SFSFO00398A 724 Arastradero Rd, Palo Alto, California

| <u>Final</u> <u>Compliance</u> <u>Configuration</u> | A REPORT DE LA CONTRACTOR DEL CONTRACTOR DE LA CONTRACTOR DE LA CONTRACTOR DE LA CONTRACTOR | NOTICE ((a)) Some and a set of the set of | CAUTION | WARNING WARNING WARNING | INFORMATION This is an access point to an area with frantaming patients. In the patients with the part of a part of the area of the patients when the part of the area of the patients with the patients and the patients are a submember. | DA | RRIERMARKER |
|---|--|---|---------|---------------------------|---|-----|--------------------|
| | GUIDELINES | NOTICE | CAUTION | WARNING | NOC INFO | DA | 50 M C 100 C 100 C |
| Access Point(s) | 1+ | 0 | 0 | 0 | 1+ | | N/A |
| Alpha | 0 | 2 | 1+ | 0 | 0 | 11' | 11' |
| Beta | 0 | 10 | 0 | 0 | 0 | 79° | 27' & 16'x36' |
| | | • | 1+ | ^ | ^ | 24' | 24' |

| Sign | Posting Instructions | Required Signage / Mitigation |
|--|--|---|
| INFORMATION This is an ACCESS POINT to an ever with transmitting reference, the control of the | NOC Information Information signs are used to provide contact information for any questions or concerns for personnel accessing the site. | Securely post at the main rooftop access door and every point of access to the site in a manner conspicuous to all individuals entering thereon as indicated in the signage plan. |
| A NOTICE AS SERVICE AS | Guidelines Informational sign used to notify workers that there are active antennas installed and provide guidelines for working in RF environments. | Securely post at the main rooftop access door and every point of access to the site in a manner conspicuous to all individuals entering thereon as indicated in the signage plan. |
| NOTICE ((co)) taming this base is an of statement of the base is stat | Notice Used to notify individuals they are entering an area where the power density emitted from transmitting antennas may exceed the FCC's MPE limit for the general public or occupational exposures. | Securely post every 8 feet on the painted barriers on the main roof level in front of the Dish Wireless antennas. |
| To CAUTION To be a served of the served of | Caution Used to notify individuals that they are entering a hot spot where either the general public or occupational FCC's MPE limit is or could be exceeded. | Securely post at the trees adjacent to the Dish Wireless antennas where there are areas that exceed the FCC standards for general public and occupational exposure. |
| Towering amount Sub-American followers for Sub-American Sub-American followers followers Sub-American fo | Warning Used to notify individuals that they are entering a hot zone where the occupational FCC's MPE limit has been exceeded by 10x. | Signage not required. |





1200 DEL PASO RD, STE 150 SACRAMENTO, CA 95843



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CHECKED BY: MM

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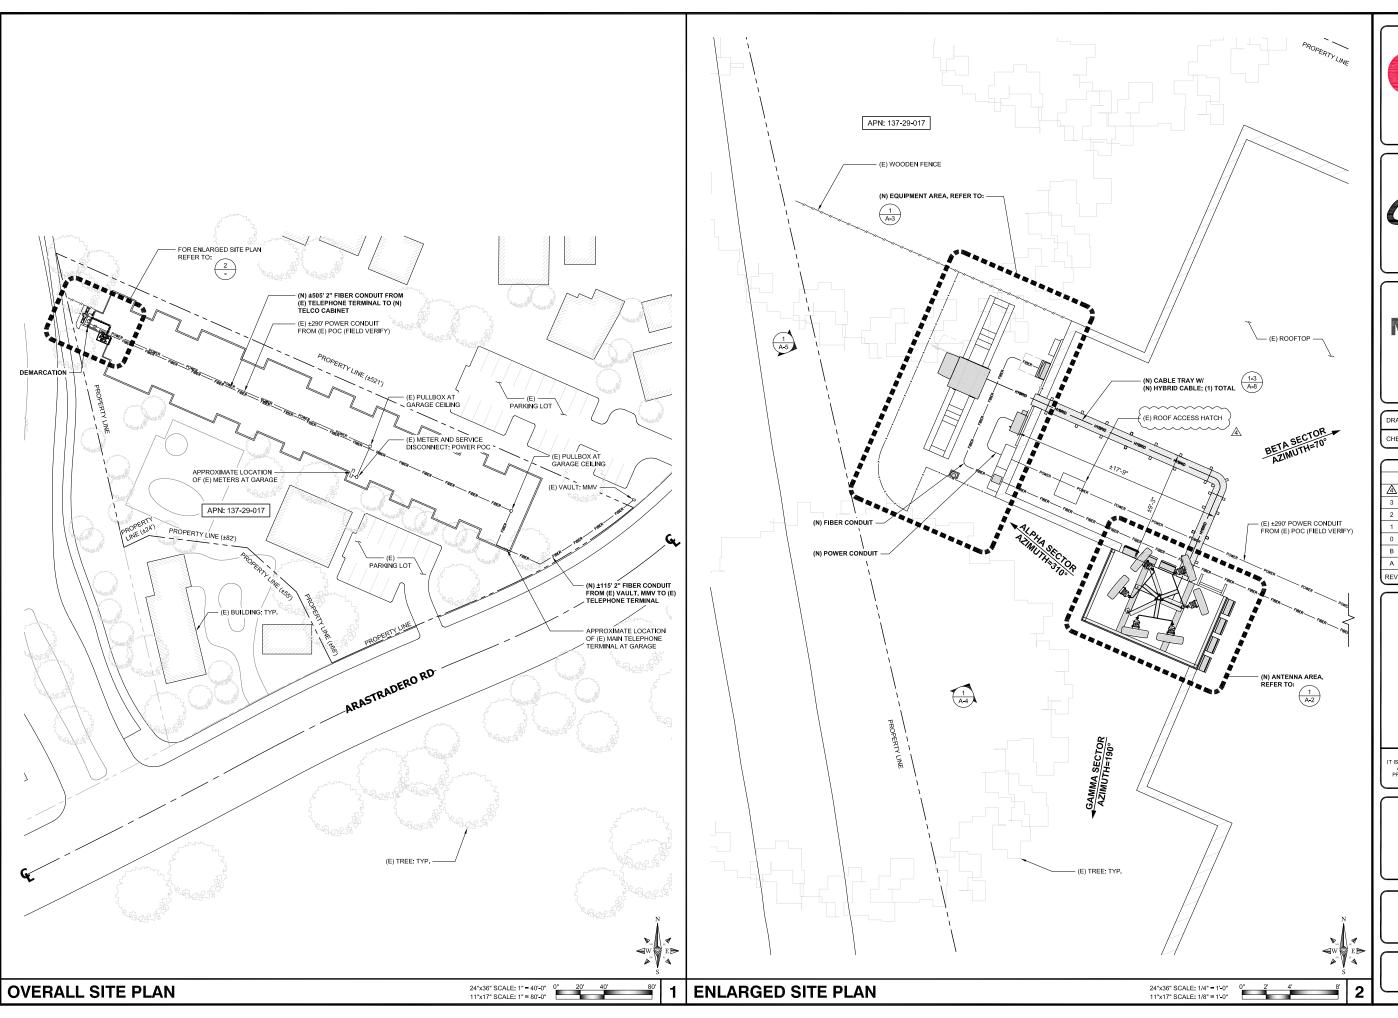
> SFSFO00398A 724 ARASTRADERO RD PALO ALTO, CA 94304 ROOFTOP

SHEET TITLE

RF-EME

COMPLIANCE REPORT

T-2







QUALIEK

1200 DEL PASO RD, STE 150 SACRAMENTO, CA 95843



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SHEET TITLE
OVERALL AND
ENLARGED SITE PLAN

SHEET NUMBER

| | | ANTENNA | | | | | | TRANSMISSION CABLE |
|---------|----------|----------------------|--------------------------------|------------|---------------|-------------|---------------|---------------------------|
| SECTOR | POSITION | EXISTING OR PROPOSED | MANUFACTURER — MODEL NUMBER | TECHNOLOGY | SIZE (HxW) | AZIMUTH | RAD CENTER | FEED LINE TYPE AND LENGTH |
| AI PHA | A1 | PROPOSED | CELLMAX CX12044x | 5G | 72.4" × 26.7" | 310* | 42'-0" | |
| ALPHA | A2 | FUTURE | CELLMAX CX12044x | TBD | 72.4" × 26.7" | 310* | 42'-0" | |
| DETA | B1 | PROPOSED | CELLMAX CX12044x | 5G | 72.4" × 26.7" | 70 ° | 42'-0" | (1) HIGH-CAPACITY HYBRID |
| BETA | B2 | FUTURE | CELLMAX CX12044x | TBD | 72.4" × 26.7" | 70° | 42'-0" | CABLE (±60' LONG) |
| GAMMA - | C1 | PROPOSED | CELLMAX CX12044x | 5G | 72.4" × 26.7" | 190' | 42'-0" | |
| | C2 | FUTURE | CELLMAX CX12044x | TBD | 72.4" × 26.7" | 190' | 42'-0" | |

| | | RRH | | NOTES |
|--------|----------|--------------------------------|------------|-----------------|
| SECTOR | POSITION | MANUFACTURER — MODEL NUMBER | TECHNOLOGY | 1. CC |
| ALPHA | A1/A2 | FUJITSU TA08025-B604 | N71 | FIN FO |
| ALPHA | A1/A2 | FUJITSU TA08025-B605 | N70/N66 | 2. AN |
| BETA | B1/B2 | FUJITSU TA08025-B604 | N71 | EQ AL |
| | B1/B2 | FUJITSU TA08025-B605 | N70/N66 | MU RE |
| GAMMA | C1/C2 | FUJITSU TA08025-B604 | N71 | WIT DE AN |
| | C1/C2 | FUJITSU TA08025-B605 | N70/N66 | / " |

CONTRACTOR TO REFER TO FINAL CONSTRUCTION RFDS FOR ALL RF DETAILS.

2. ANTENNA AND RRH MODELS MAY CHANGE DUE TO EQUIPMENT AVAILABILITY.

EQUIPMENT AVAILABILITY
ALL EQUIPMENT CHANGES
MUST BE APPROVED AND
REMAIN IN COMPLIANCE
WITH THE PROPOSED
DESIGN AND STRUCTURAL
ANALYSES.

- 1. M SQUARED WIRELESS ACCEPTS NO LIABILITY FOR THE STRUCTURAL CAPACITY OF THE STRUCTURE, MOUNTS, ANTENNAS, CABLES OR ANY OTHER APPURTENANCE ON THE TOWER. THE CONTRACTOR AND SUBCONTRACTOR SHALL COORDINATE WITH AND COMPLY WITH THE PROVISIONS OF THE STRUCTURAL ANALYSIS PREPARED FOR THIS SITE AND PROJECT PRIOR TO THE INSTALLATION OF ANTENNAS AND CABLE ON THE TSTRUCTURE. IMMEDIATELY REPORT ANY DISCREPANCIES BETWEEN THE CONSTRUCTION DRAWINGS AND THE STRUCTURAL ANALYSIS TO DISH WIRELESS.
- REFER TO THE STRUCTURAL ANALYSIS AND/OR STRUCTURAL LETTER FOR THE APPROVAL OF ALL MODIFICATIONS TO AND ADDING EQUIPMENT OF NEW TOWER APPURTENANCES.
- REFER TO ADDITIONAL DRAWINGS SPECIFIC TO STRUCTURE REINFORCEMENT FOR THIS SITE SHOULD THERE BE A REQUIREMENT FOR ANY STRUCTURE
 REINFORCEMENT.
 REFER TO STRUCTURAL ANALYSIS FOR COAXIAL AND OTHER CABLE SUPPORT AND

- REFER TO STRUCTURAL ANALYSIS FOR COAXIAL AND OTHER CABLE SUPPORT AND CONFIGURATION DETAIL.

 REFER TO STRUCTURAL ANALYSIS FOR ALL CARRIERS APPURTENANCES AS THEY MAY NOT BE SHOWN IN ELEVATION DETAIL.

 PRIOR TO ORDERING ANTENNAS VERIFY CORRECT MODEL NUMBER WITH LATEST RFDS AND NOTIFY ENGINEER OF RECORD IMMEDIATELY IF DISCREPANCY IS FOUND.



5701 S SANTA FE DR LITTLETON, CO 80120



1200 DEL PASO RD, STE 150 SACRAMENTO, CA 95843



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> SFSFO00398A 724 ARASTRADERO RD PALO ALTO, CA 94304 ROOFTOP

> > SHEET TITLE

ANTENNA LAYOUT AND SCHEDULE

SHEET NUMBER

A-2


NOTES:

- CONTRACTOR IS TO REFER TO DISH WIRELESS'S MOST CURRENT RADIO FREQUENCY DATA SHEET (RFDS) PRIOR TO CONSTRUCTION.
- CABLE LENGTHS WERE DETERMINED BASED ON VISUAL INSPECTION DURING SITE-WALK. CONTRACTOR TO VERIFY ACTUAL LENGTH DURING PRE-CONSTRUCTION WALK.

NOTES TO CONTRACTOR:

- ANTENNA AZIMUTHS ARE ESTIMATED AND ARE TO BE VERIFIED BY RF.
- ANTENINA BY OTHERS NOT SHOWN FOR CLARITY.
 PRIOR TO ORDERING ANTENNAS VERIFY CORRECT MODEL NUMBER
 WITH LATEST REDS AND NOTIFY ENGINEER OF RECORD IMMEDIATELY IF DISCREPANCY IS FOUND.


ANTENNA & EQUIPMENT SCHEDULE

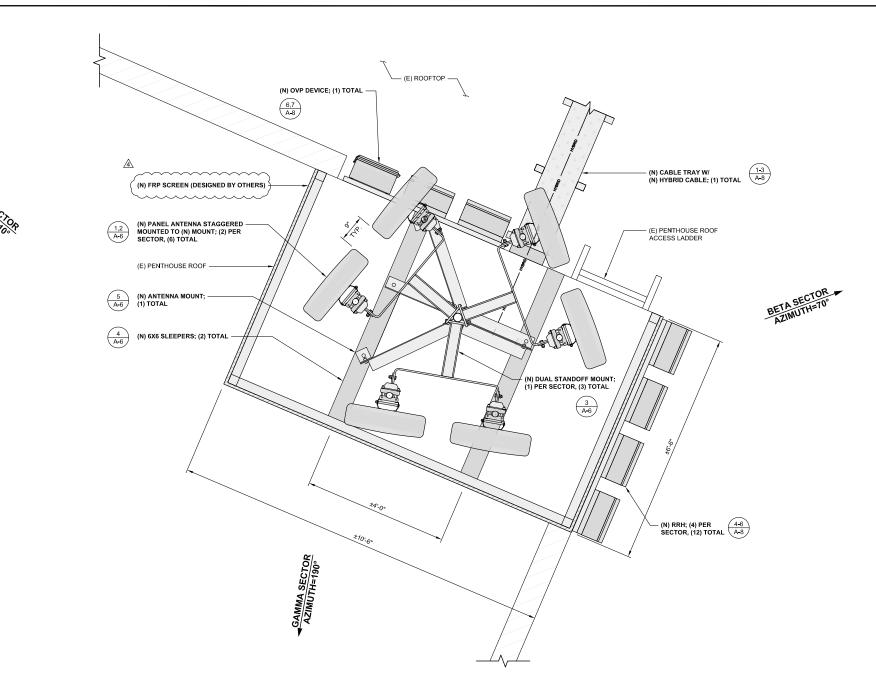



NOTES:

ROOFTOP NOT SHOWN FOR CLARITY.
 ANTENNAS NOT SHOWN FOR CLARITY.

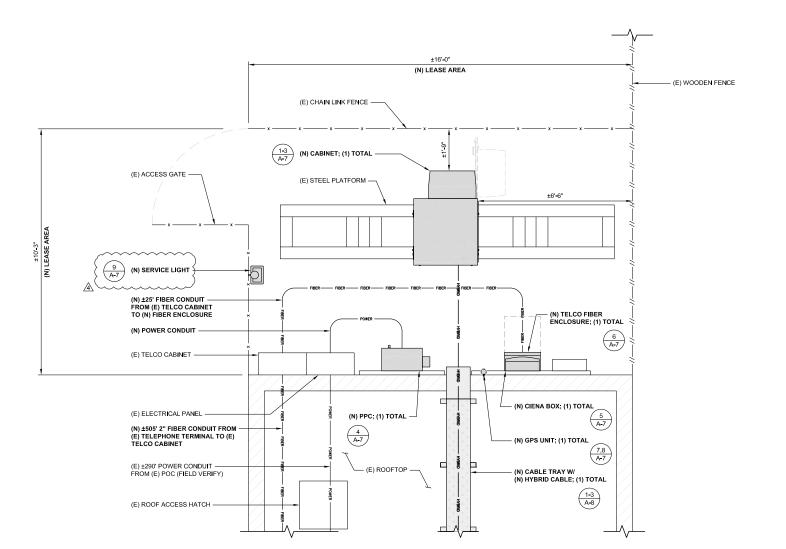



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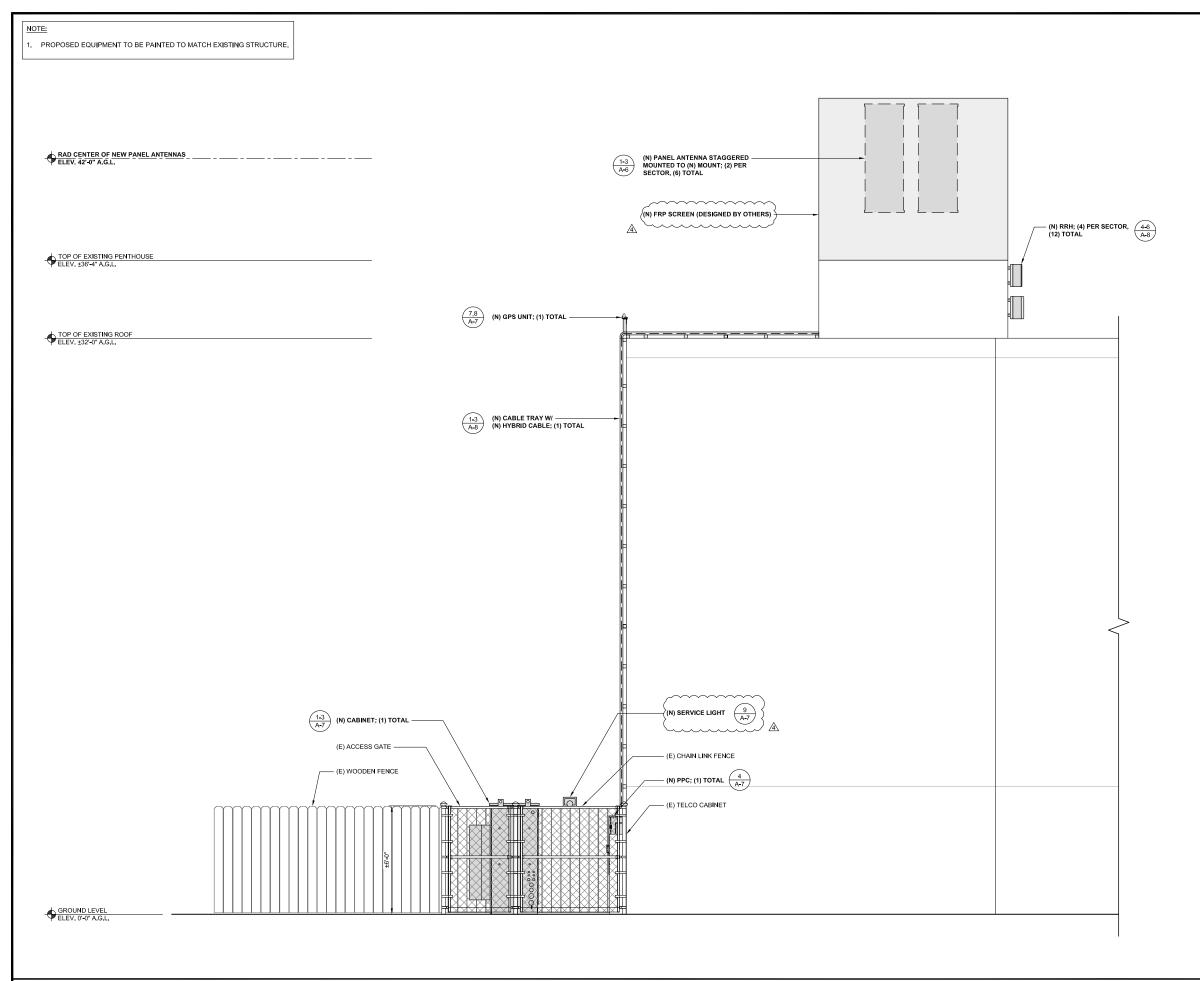
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EQUIPMENT LAYOUT

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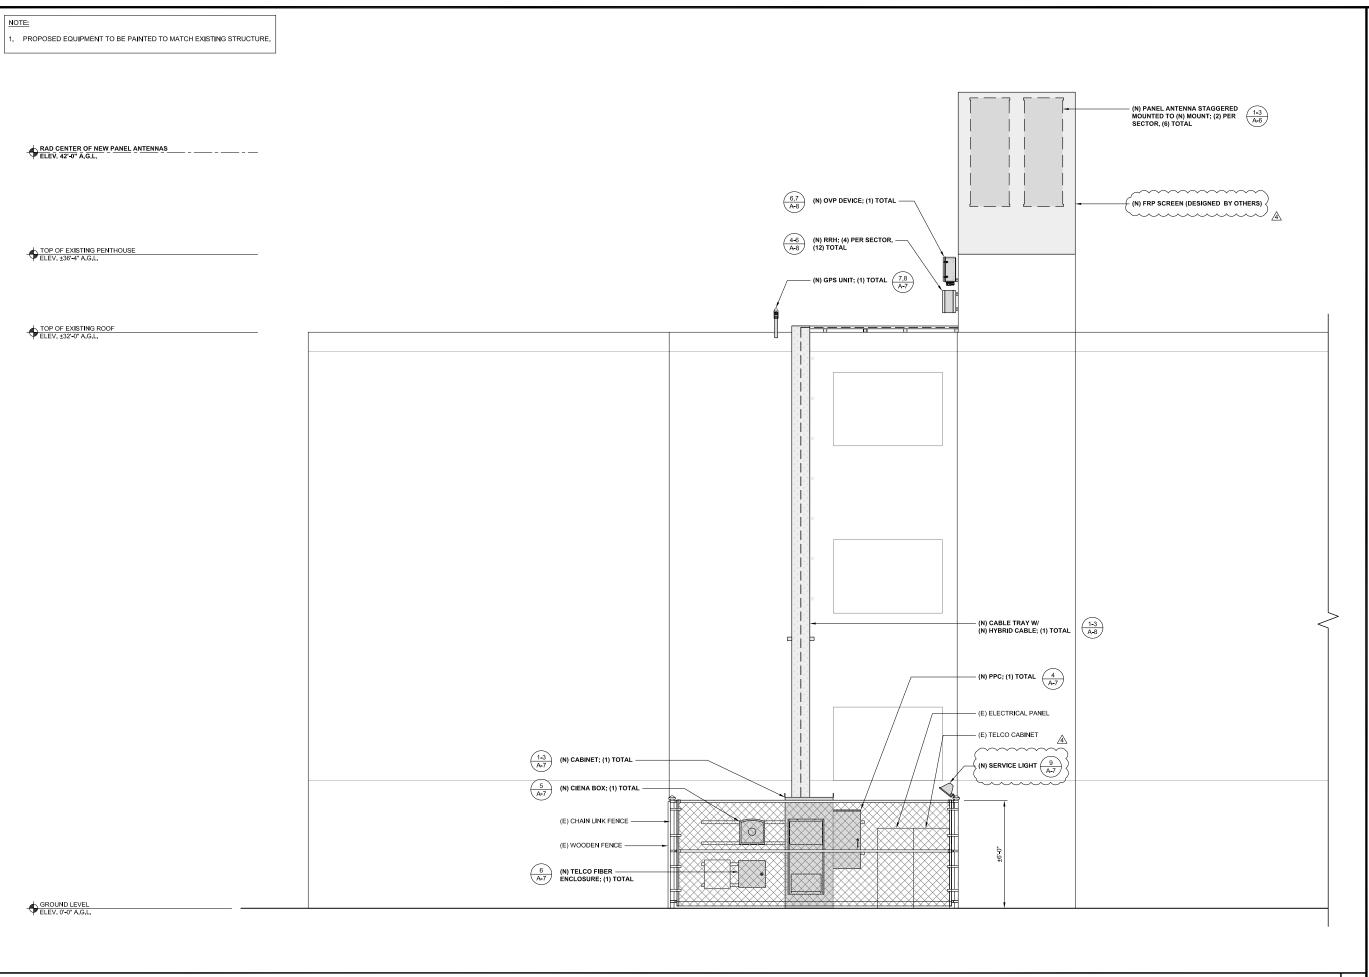
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SHEET TITLE

SOUTHWEST ELEVATIONS

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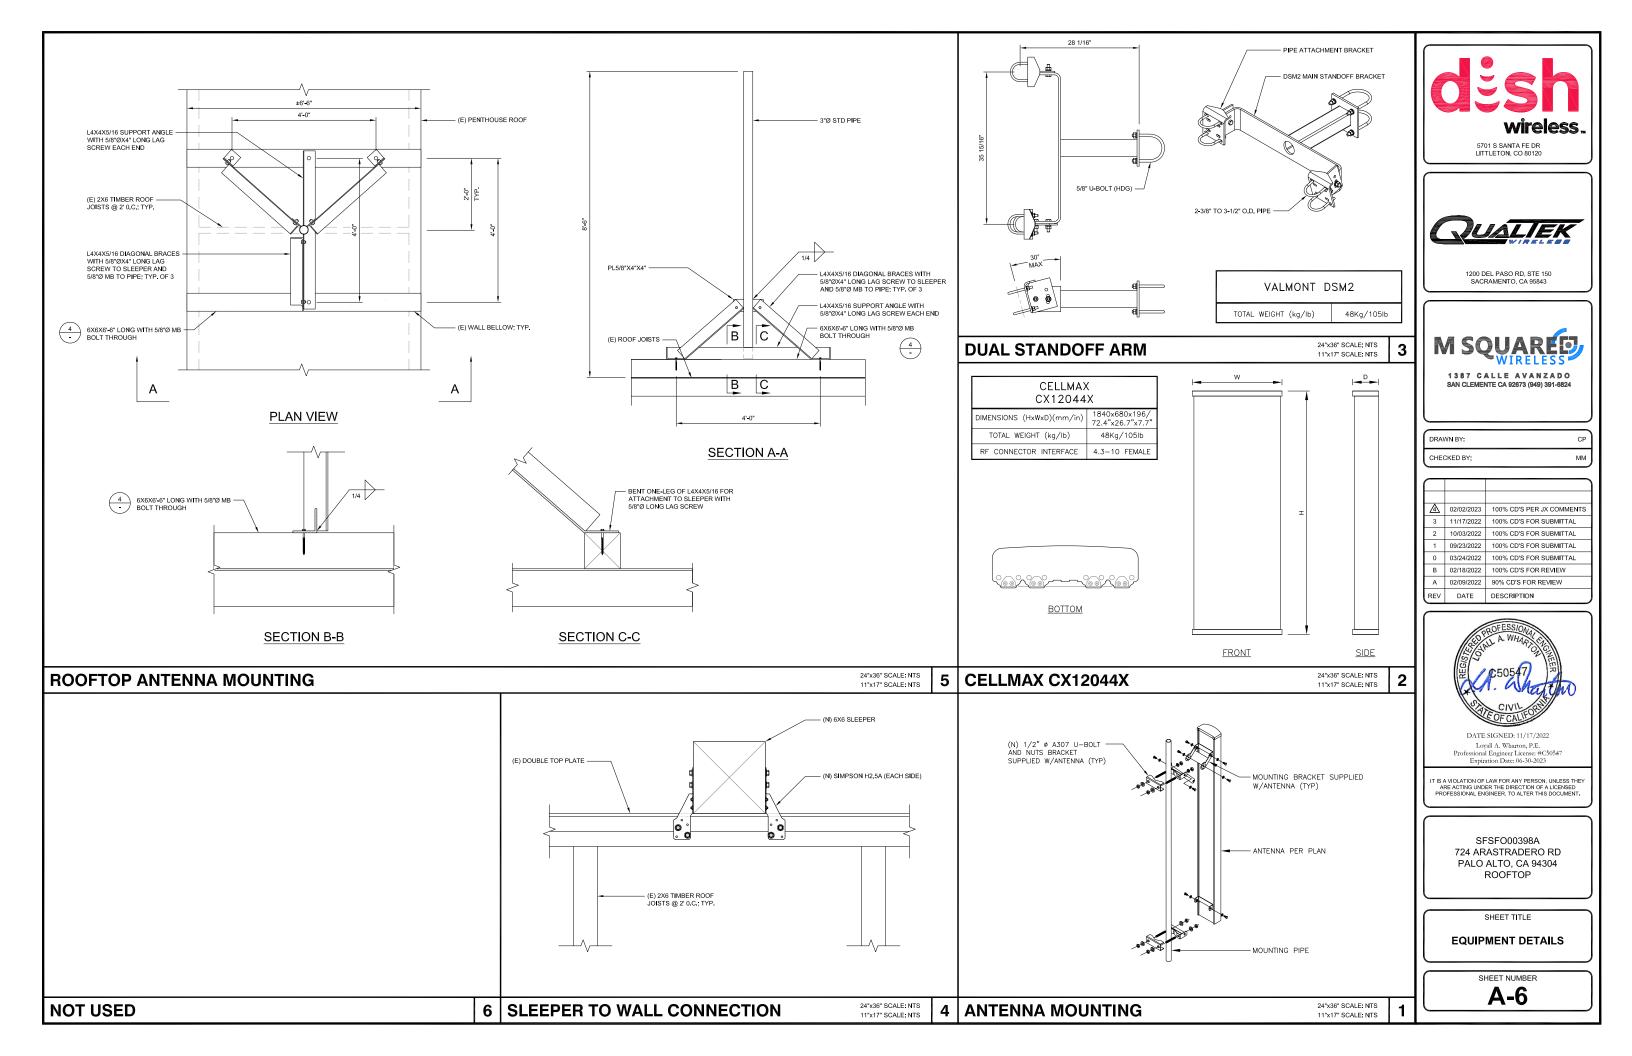
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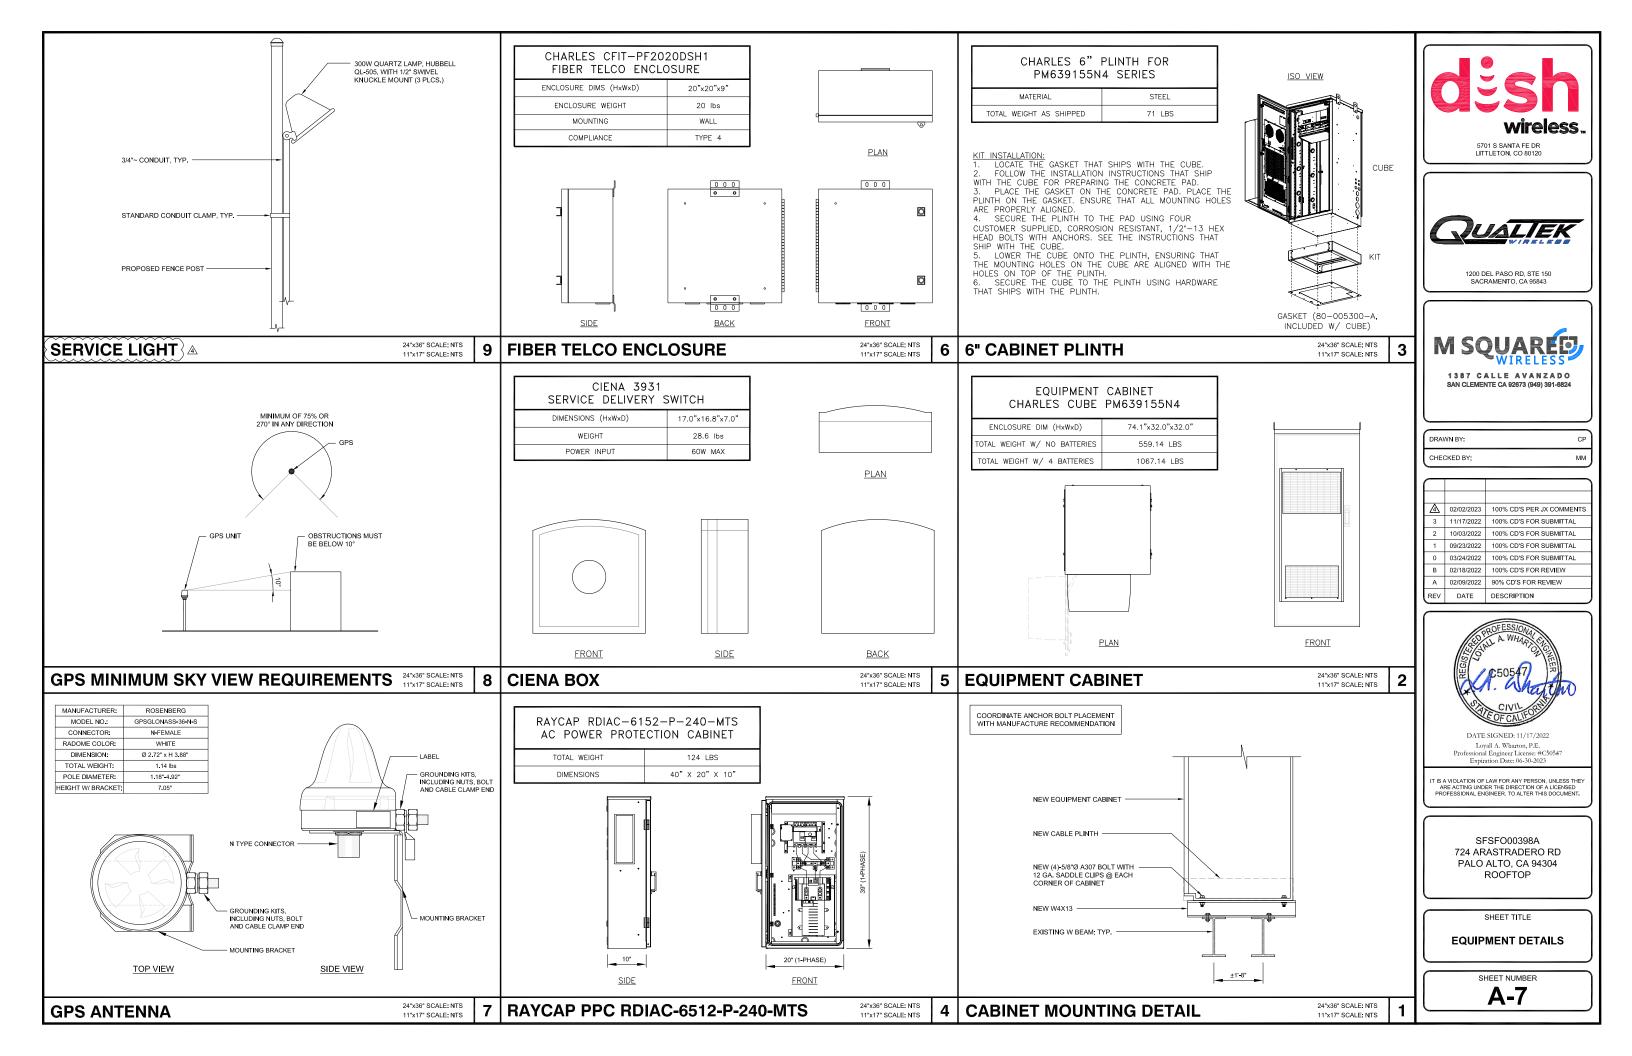
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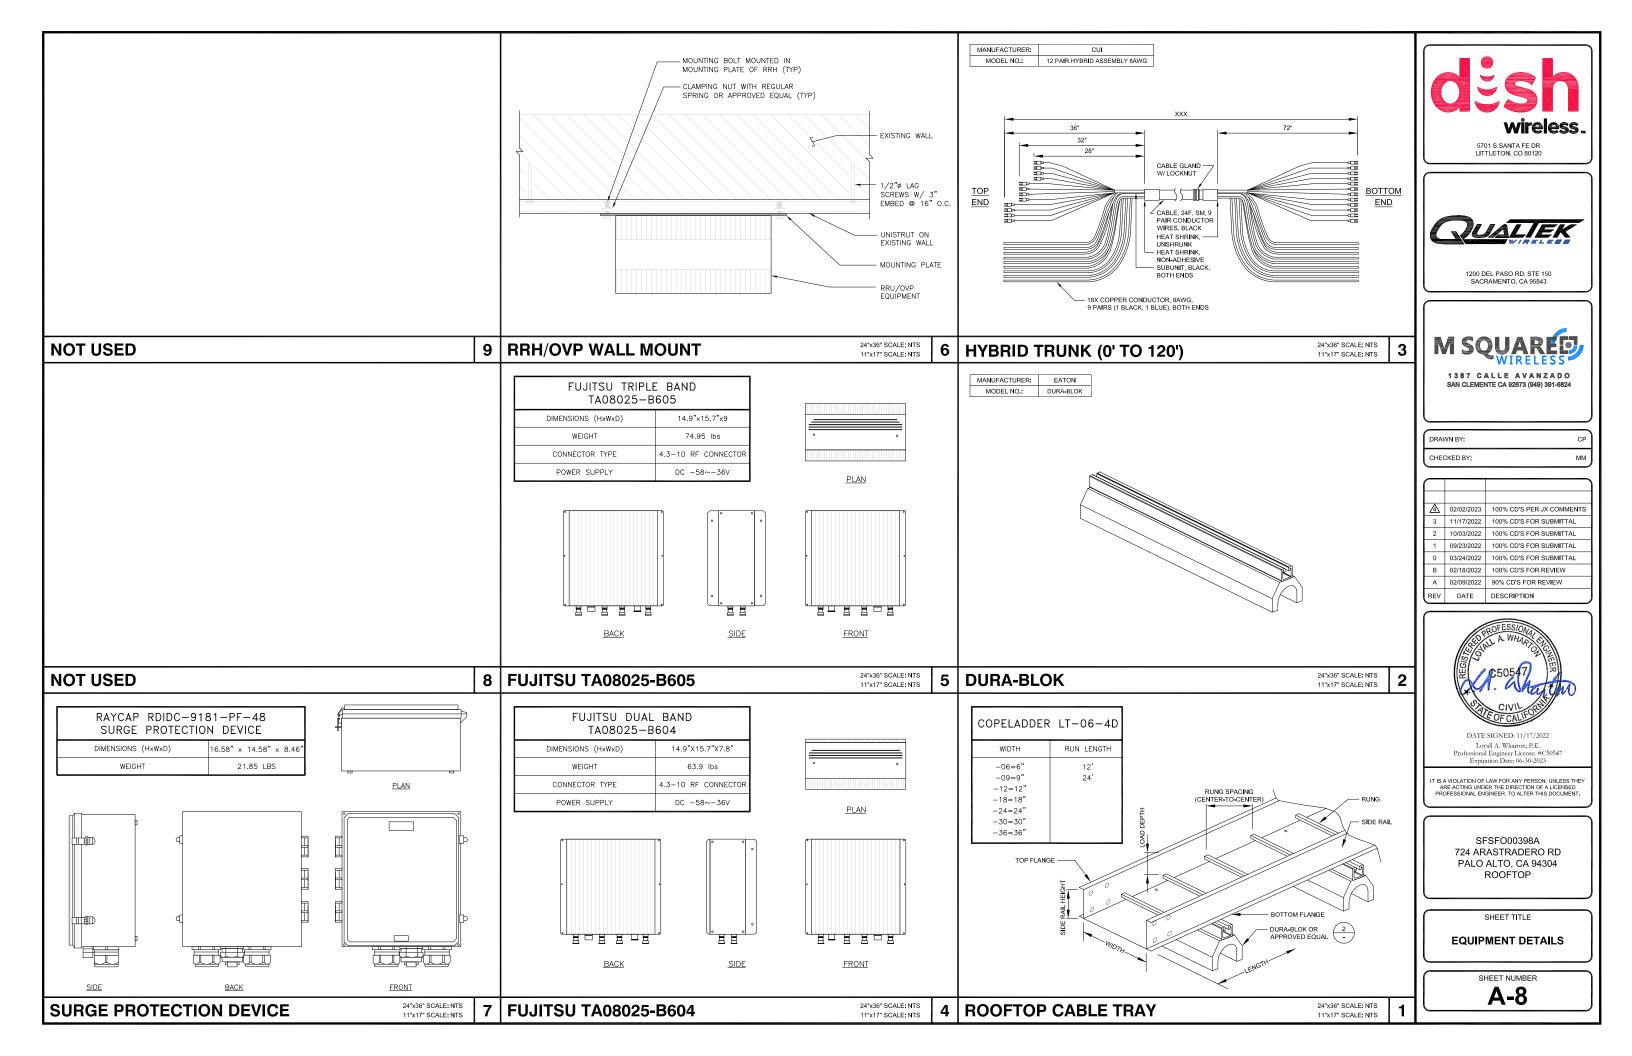
SHEET TITLE

NORTHWEST ELEVATIONS

SHEET NUMBER







- CONTRACTOR SHALL FIELD VERIFY ALL PROPOSED UNDERGROUND UTILITY CONDUIT ROUTE
- ANTENNAS AND MOUNTS OMITTED FOR CLARITY

DC POWER WIRING SHALL BE COLOR CODED AT EACH END FOR IDENTIFYING +24V AND -48 CONDUCTORS. RED MARKINGS SHALL IDENTIFY +24V AND BLUE MARKINGS SHALL IDENTIFY -48V.

- CONTRACTOR SHALL INSPECT THE EXISTING CONDITIONS PRIOR TO SUBMITTING A BID. ANY QUESTIONS ARISING DURING THE BID PERIOD IN REGARDS TO THE CONSTRUCTOR'S 1. CONDITION OF COUNTRY OF WORK, OR ANY OTHER THE MECHANICAL EQUIPMENT TO AVOID LOCATION CONFLICTS. VERIFY WITH THE MECHANICAL EQUIPMENT CONTRACTOR AND SHALL BE COORDINATED WITH THE PROJECT MANAGER FOR CLARIFICATION, NOT AFTER THE CONTRACT HAS BEEN AWARDED.

 2. ALL ELECTRICAL WORK SHALL BE DONE IN ACCORDANCE WITH CURRENT NATIONAL ELECTRICAL CODES AND ALL STATE AND LOCAL CODES, LAWS, AND ORDINANCES. PROVIDE ALL COMPONENTS AND WIRING SIZED AS REQUIRED TO MEET NEC STANDARDS.

 3. LOCATION OF EQUIPMENT, CONDUIT AND DEVICES SHOWN ON THE DRAWINGS ARE APPROXIMATE AND SHALL BE COORDINATED WITH FIELD CONDITIONS PRIOR TO CONSTRUCTION.

 4. CONDUIT ROUGHIN SHALL BE COORDINATED WITH THE MECHANICAL EQUIPMENT TO AVOID LOCATION CONFLICTS. VERIFY WITH THE MECHANICAL EQUIPMENT CONTRACTOR AND COMPLY AS REQUIRED.

- CONTRACTOR SHALL PROVIDE ALL BREAKERS CONDUITS AND CIRCUITS AS REQUIRED FOR A COMPLETE SYSTEM
- 5. CONTRACTOR SHALL PROVIDE PULL BOXES AND DIRCUITS AS REQUIRED BY THE NEC ARTICLE 314.

 7. CONTRACTOR SHALL PROVIDE PULL BOXES AND JUNCTION BOXES AS REQUIRED BY THE NEC ARTICLE 314.

 7. CONTRACTOR SHALL PROVIDE ALL STRAIN RELIEF AND CABLE ASSEMBLES. INSTALLATION SHALL BE IN ACCORDANCE WIT MANUFACTURER'S SPECIFICATIONS AND RECOMMENDATIONS.


 8. ALL DISCONNECTS AND CONTROLLING DEVICES SHALL BE PROVIDED WITH ENGRAVED PHENOLIC NAMEPLATES INDICATING EQUIPMENT CONTROLLED, BRANCH CIRCUITS INSTALLED ON, AND PANEL FIELD LOCATIONS FED FROM.


 9. INSTALL AND EQUIPMENT GROUNDING CONDUCTOR IN ALL CONDUITS PER THE SPECIFICATIONS AND NEC 250. THE EQUIPMENT GROUNDING CONDUCTORS SHALL BE BONDED AT ALL WARRENDEST AND ADVICE AND FOUNDING CONDUCTORS SHALL BE BONDED AT ALL
- JUNCTION BOXES, PULL BOXES, AND ALL DISCONNECT SWITCHES, AND EQUIPMENT CABINETS.
- 10. ALL NEW MATERIAL SHALL HAVE A U.L. LABEL.

 11. PANEL SCHEDULE LOADING AND CIRCUIT ARRANGEMENTS REFLECT POST-CONSTRUCTION EQUIPMENT.

 12. CONTRACTOR SHALL BE RESPONSIBLE FOR AS-BUILT PANEL SCHEDULE AND SITE DRAWINGS.

 13. ALL TRENCHES IN COMPOUND TO BE HAND DUG.

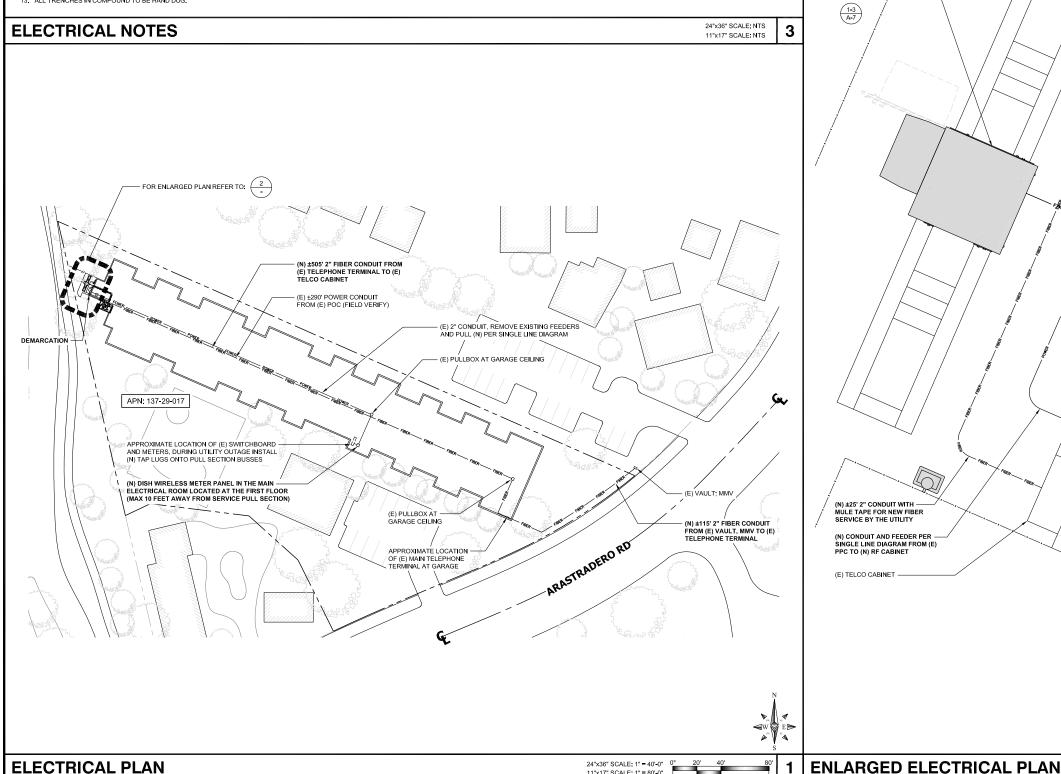

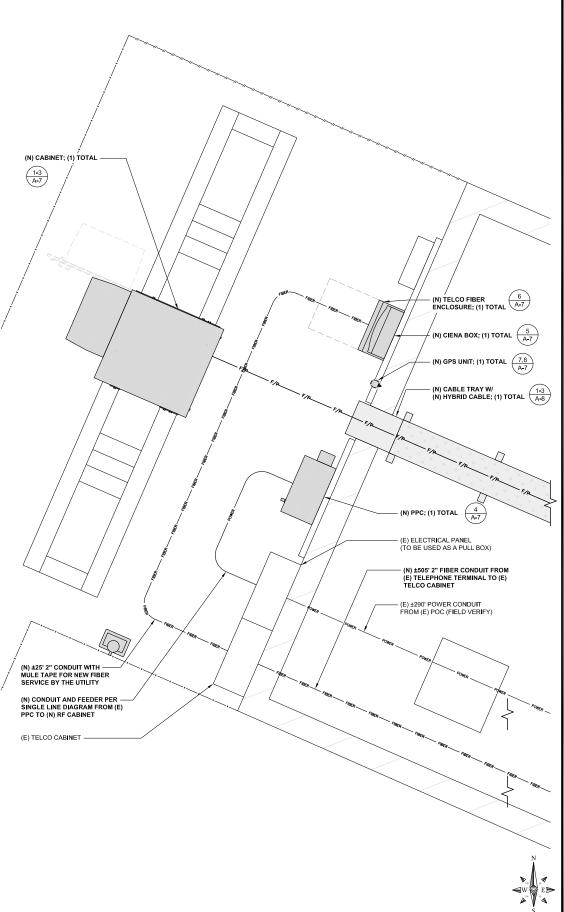

11"x17" SCALE: 3/8" = 1'-0"



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1200 DEL PASO RD, STE 150 SACRAMENTO, CA 95843



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| - | 3 | 11/17/2022 | 100% CD'S FOR SUBMITTAL |
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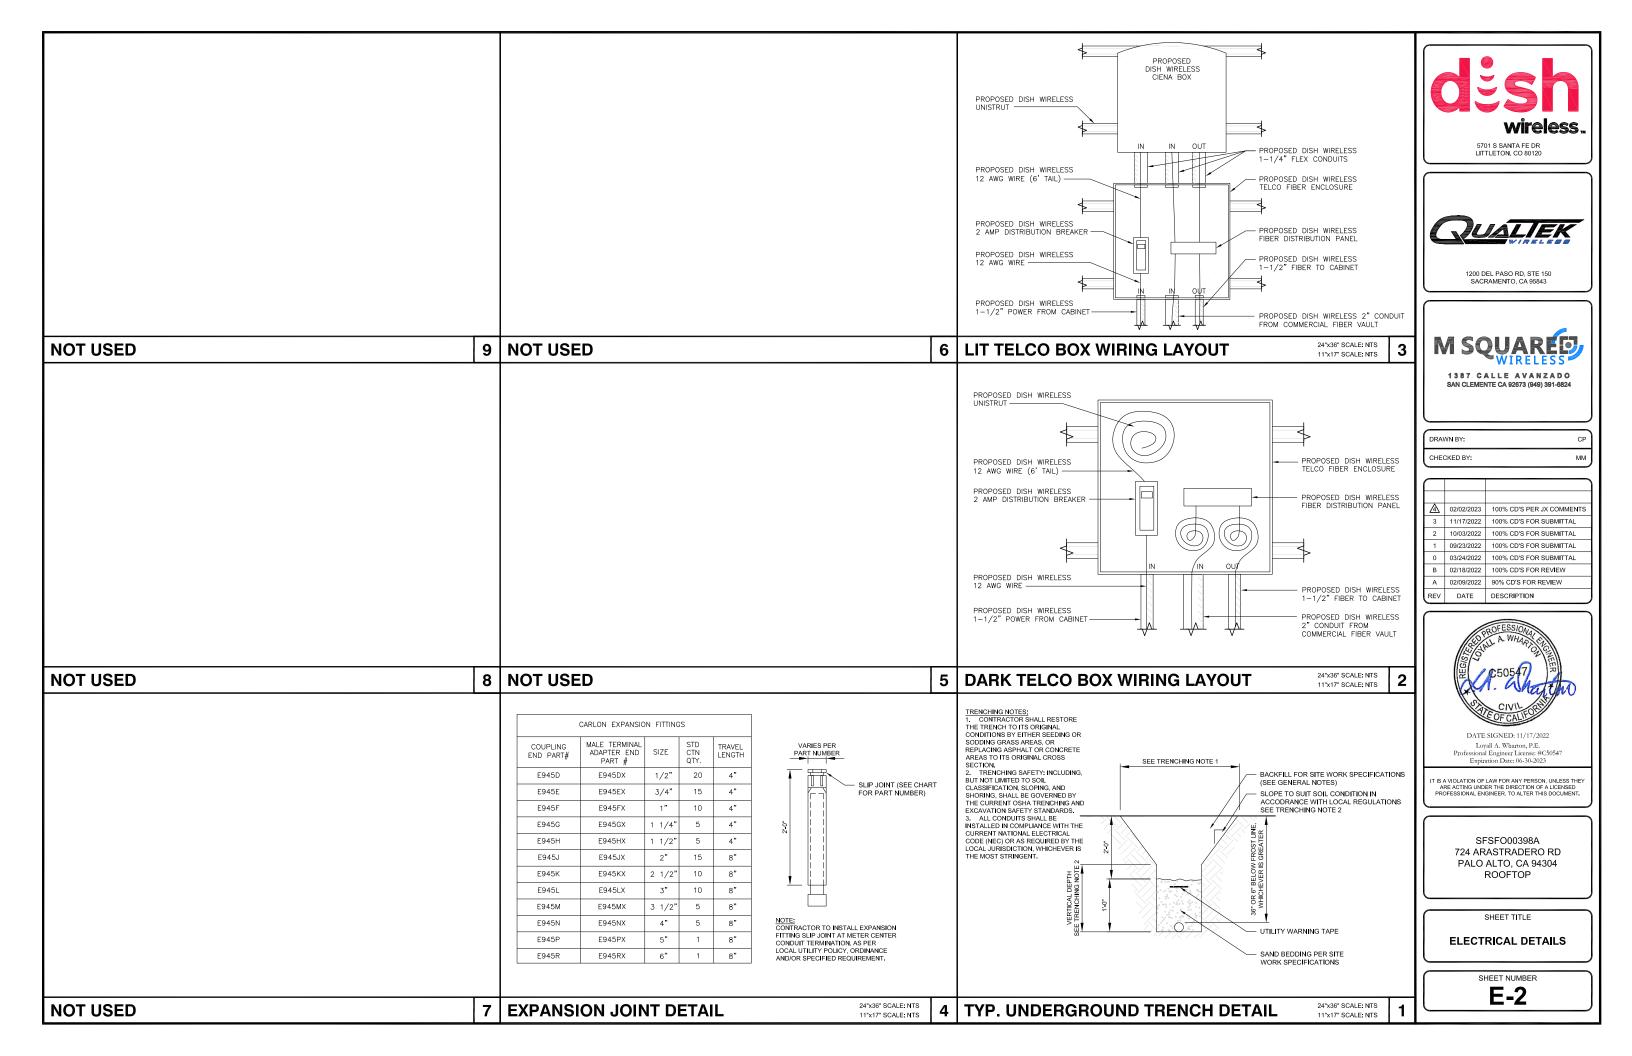
> SFSFO00398A 724 ARASTRADERO RD PALO ALTO, CA 94304 **ROOFTOP**


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ELECTRICAL PLAN AND NOTES

SHEET NUMBER

E-1



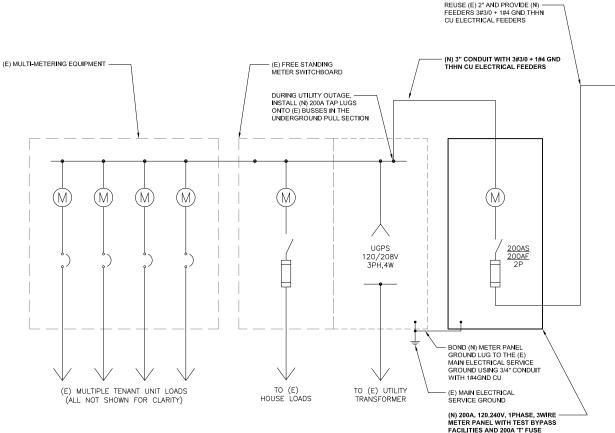

PROPOSED POWER PROTECTIVE CHARLES NETWORK CABINET CABINET 120/240V, 1 PH, SERVICE RATED, OVERALL UL LISTED POWER UTILITY SERVICE ENTRANCE 120/240 VAC 1PH CENTER, N3R, 65K/10K AIC MAIN BREAKER WITH
INTERLOCKED GENERATOR
FEED, 200A 65K AIC BACKUP GENERATOR CAMLOCK (2) PROPOSED 0.75" EMT CONDUIT GEN PLUG DEVICE 100KA SAD/MOV GFCI 01 02 30A PROPOSED 2 #10, 1 #10 CU GND. FOR RECTIFIER 1 15A 03 04 30A

15A 05 06

SPACE 07 08 20A

SPACE 09 10

SPACE 11 12

SPACE 13 14 30A

SPACE 15 16 30A

SPACE 17 18

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SPACE SPACE SPACE SPACE FOR RECTIFIER 2 FOR RECTIFIER 3 FOR RECTIFIER 4 (1) PROPOSED 0.5" EMT CONDUIT PROPOSED 2 #10, 1 #10 CU GND. FOR CONVENIENCE OUTLET

NOTE:
BRANCH CIRCUIT WIRING SUPPLYING RECTIFIERS ARE TO BE RATED UL015, 105C, 600V AND PVC INSTALLED, IN THE SIZES SHOWN
IN THE ONE—LINE DIAGRAM. CONTRACTOR MAY SUBSTITUTE UL1015 WIRE FOR THWN—2 FOR CONVENIENCE OUTLET BRANCH CIRCUIT.

THE ENGINEER OF RECORD HAS PERFORMED ALL REQUIRED SHORT CIRCUIT CALCULATIONS AND THE AIC RATINGS FOR EACH DEVICE IS ADEQUATE TO PROTECT THE EQUIPMENT AND THE ELECTRICAL SYSTEM.

THE ENGINEER OF RECORD HAS PERFORMED ALL REQUIRED VOLTAGE DROP CALCULATIONS AND ALL BRANCH CIRCUIT AND FEEDERS COMPLY WITH THE NEC (LISTED ON T-1) ARTICLE 210.19(A)(1) FPN NO. 4.

THE (2) CONDUITS WITH (4) CURRENT CARRYING CONDUCTORS EACH, SHALL APPLY THE ADJUSTMENT FACTOR OF 80% PER 2014/17 NEC TABLE 310.15(B)(α) OR 2020 NEC TABLE 310.15(C)(1) FOR UL1015 WIRE.

> #12 FOR 15A-20A/1P BREAKER: 0.8 x 30A = 24.0A #10 FOR 25A-30A/2P BREAKER: 0.8 X 40A = 32.0A #8 FOR 35A-40A/2P BREAKER: 0.8 X 55A = 44.0A #6 FOR 45A-60A/2P BREAKER: 0.8 X 75A = 60.0A

CONDUIT SIZING: AT 40% FILL PER NEC CHAPTER 9, TABLE A, ARTICLE 358.

0.5" CONDUIT - 0.122 SQ. IN AREA

0.75" CONDUIT - 0.213 SQ. IN AREA

2.0" CONDUIT - 1.316 SQ. IN AREA

3.0" CONDUIT - 2.907 SQ. IN AREA CABINET CONVENIENCE OUTLET CONDUCTORS (1 CONDUIT): USING THWN-2 CU.

> #10 - 0.0211 SQ. IN X 2 = 0.0422 SQ. IN #10 - 0.0211 SQ. IN X 1 = 0.0211 SQ. IN <GROUND = 0.0633 SQ. IN

0.5" EMT CONDUIT IS ADEQUATE TO HANDLE THE TOTAL OF (3) WIRES, INCLUDING GROUND WIRE, AS INDICATED ABOVE.

RECTIFIER CONDUCTORS (1 CONDUIT): USING UL1015, CU.

#10 - 0.0266 SQ. IN X 4 = 0.1064 SQ. IN #10 - 0.0082 SQ. IN X 1 = 0.0082 SQ. IN <BARE GROUND = 0.1146 SQ. IN

0.75" EMT CONDUIT IS ADEQUATE TO HANDLE THE TOTAL OF (5) WIRES, INCLUDING

PPC FEED CONDUCTORS (1 CONDUIT): USING THWN, CU.

3/0 - 0.2679 SQ. IN X 3 = 0.8037 SQ. IN #6 - 0.0507 SQ. IN X 1 = 0.0507 SQ. IN <GROUND

= 0.8544 SQ. IN

3.0" SCH 40 PVC CONDUIT IS ADEQUATE TO HANDLE THE TOTAL OF (4) WIRES, INCLUDING GROUND WIRE, AS INDICATED ABOVE.

| LOAD SERVED | VOLT AMPS (WATTS) | | | скт | | | CKT TRIP | VOLT AMPS (WATTS) | | LOAD SERVED | | |
|-----------------------|----------------------|-----|-------|-----|--------|-----|------------------------|----------------------|--------|-------------|-------|-----------------|
| | L1 | L2 |]] | | | | | | | L1 | L2 | |
| PPC GFCI OUTLET | 180 | | 15A | 1 | \geq | Α | $\perp \uparrow \perp$ | 2 | 30A | 2880 | | ABB/GE INFINITY |
| CHARLES GFCI OUTLET | | 180 | 15A | 3 | 7 | В | \vdash | 4 | JUA | | 2880 | RECTIFIER 1 |
| -SPACE- | | | | 5 | 7 | Α | \overline{L} | 6 | 30A | 2880 | | ABB/GE INFINITY |
| -SPACE- | | | | 7 | Σ | В | $\overline{\lambda}$ | 9 | JUA | | 2880 | RECTIFIER 2 |
| -SPACE- | | | | 9 | Σ | Α | | 11 | 30A | 2880 | | ABB/GE INFINITY |
| -SPACE- | | | | 11 | 7 | В | \perp | 13 | JUA | | 2880 | RECTIFIER 3 |
| -SPACE- | | | | 13 | Σ | Α | 1 | 15 | 30A | 2880 | | ABB/GE INFINITY |
| -SPACE- | | | | 15 | 7 | В | $\overline{\lambda}$ | 17 | 30A | | 2880 | RECTIFIER 4 |
| -SPACE- | | | | 17 | 7 | Α | \sim | 19 | | | | -SPACE- |
| -SPACE- | | | | 19 | Σ | В | 7 | 21 | | | | -SPACE- |
| -SPACE- | | | | 21 | 7 | Α | \sim | 23 | | | | -SPACE- |
| -SPACE- | | | | 23 | 7 | В | 7 | 25 | | | | -SPACE- |
| VOLTAGE AMPS | 180 | 180 | | | | | | | | 11520 | 11520 | |
| 200A MCB, 1ø, 24 SPA | | | 11 | | | L2 | | | | 111020 | 11020 | |
| MB RATING: 65,000 AIC | | | 11700 |) | 1 | 170 | 0 | VOLTAGE AMPS | | | | |
| | | | 98 | _ | i i | 98 | | AMI | | | | |
| | | | | 9 | 8 | | | MAX AMPS | | | | |
| | | | | | 1.9 | | | | × 125% | | | |

BREAKERS REQUIRED

(4) 30A, 2P BREAKER - SQUARE D P/N:Q0230 (2) 15A, 1P BREAKER - SQUARE D P/N:Q0115

PULLOUTS BUSMANN TYPE JJN



LITTLETON, CO 80120

1200 DEL PASO RD, STE 150 SACRAMENTO, CA 95843



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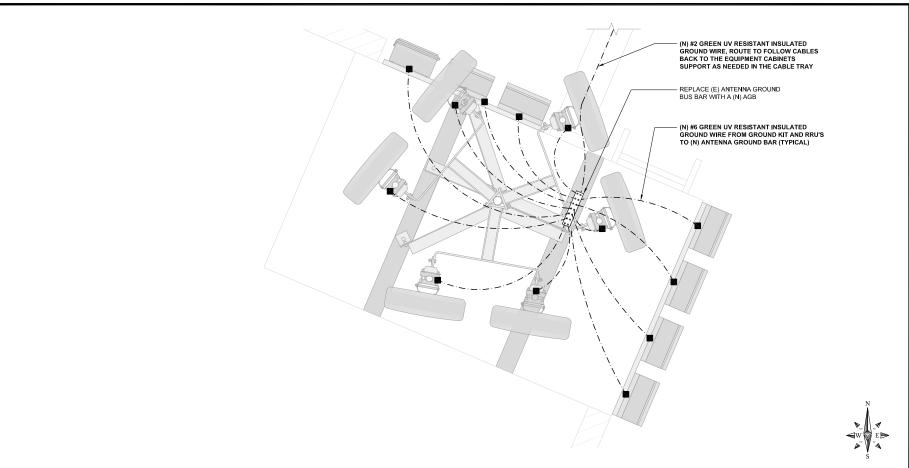
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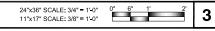
ELECTRICAL ONE-LINE & PANEL SCHEDULE


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E-3



ANTENNA GROUNDING PLAN



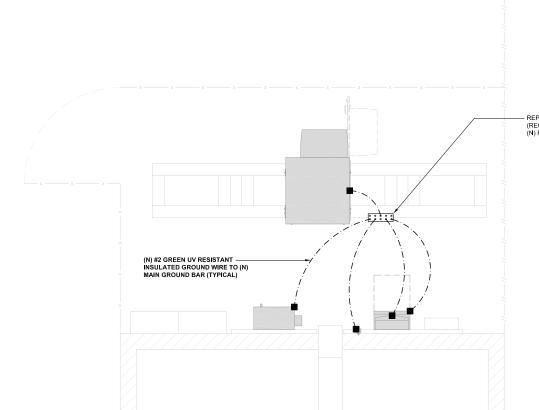

REPLACE (E) MAIN GROUND BUS BAR WITH (N) MGB (RECONNECT DOWNLEAD TO (E) GROUND RING AND (N) PPC AND TELCO CABINETS AS NEEDED) EXOTHERMIC CONNECTION

GROUND BUS BAR

GROUND ROD

MECHANICAL CONNECTION

INSPECTION SLEEVE

---- #2 AWG STRANDED & INSULATED

TEST GROUND ROD WITH

_ · _ · _ · _ #2 AWG SOLID COPPER TINNED

GROUNDING LEGEND

- 1. GROUNDING IS SHOWN DIAGRAMMATICALLY ONLY.
- 2. CONTRACTOR SHALL GROUND ALL EQUIPMENT AS A COMPLETE SYSTEM. GROUNDING SHALL BE IN COMPLIANCE WITH NEC SECTION 250 AND DISH WIRELESS GROUNDING AND BONDING REQUIREMENTS AND
- 3. ALL GROUND CONDUCTORS SHALL BE COPPER; NO ALUMINUM CONDUCTORS SHALL BE USED.
- 4. NO EXOTHERMIC WELDING ON ROOFTOP

GROUNDING ROOFTOP KEY NOTES

- EXTERIOR GROUND RING: #2 AWG SOLID COPPER, BURIED AT A DEPTH OF AT LEAST 30 INCHES BELOW GRADE, OR 6 INCHES BELOW THE FROST LINE AND APPROXIMATELY 24 INCHES FROM THE EXTERIOR WALL OR FOOTING.
- TOWER GROUND RING: THE GROUND RING SYSTEM SHALL BE INSTALLED AROUND AN ANTENNA TOWER'S LEGS, AND/OR GUY ANCHORS. WHERE SEPARATE SYSTEMS HAVE BEEN PROVIDED FOR THE TOWER AND THE BUILDING, AT LEAST TWO BONDS SHALL BE MADE BETWEEN THE TOWER RING GROUND SYSTEM AND THE BUILDING RING GROUND SYSTEM USING MINIMUM #2 AWG SOLID COPPER CONDUCTORS.
- © INTERIOR GROUND RING: #2 AWG STRANDED GREEN INSULATED COPPER CONDUCTOR EXTENDED AROUND THE PERIMETER OF THE EQUIPMENT AREA. ALL NON-TELECOMMUNICATIONS RELATED METALLIC OBJECTS FOUND WITHIN A SITE SHALL BE GROUNDED TO THE INTERIOR GROUND RING WITH #6 AWG STRANDED GREEN INSULATED CONDUCTOR.
- (D) BOND TO INTERIOR GROUND RING: #2 AWG SOLID TINNED COPPER WIRE PRIMARY BONDS SHALL BE PROVIDED AT LEAST AT FOUR POINTS ON THE INTERIOR GROUND RING, LOCATED AT THE CORNERS OF THE BUILDING.
- GROUND ROD; UL LISTED COPPER CLAD STEEL. MINIMUM 1/2" DIAMETER BY EIGHT FEET LONG. GROUND RODS SHALL BE INSTALLED WITH INSPECTION SLEEVES, GROUND RODS SHALL BE DRIVEN TO THE DEPTH OF GROUND (E) RING CONDUCTOR.
- F CELL REFERENCE GROUND BAR: POINT OF GROUND REFERENCE FOR ALL COMMUNICATIONS EQUIPMENT FRAMES. ALL BONDS ARE MADE WITH #2 AWG UNLESS NOTED OTHERWISE STRANDED GREEN INSULATED COPPER CONDUCTORS. BOND TO GROUND RING WITH (2) #2 SOLID TINNED COPPER CONDUCTORS.
- HATCH PLATE GROUND BAR: BOND TO THE INTERIOR GROUND RING WITH TWO #2 AWG STRANDED GREEN G HATCH PLATE GROUND BAR: BOND TO THE INTERIOR GROUND KING WITH TWO #2 AVIG STRANDED GREEN INSULATED COPPER CONDUCTORS, WHEN A HATCH-PLATE AND A CELL REFERENCE GROUND BAR ARE BOTH PRESENT, THE CRGB MUST BE CONNECTED TO THE HATCH-PLATE AND TO FACE INTERIOR GROUND RING USING (2) TWO #2 AWG STRANDED GREEN INSULATED COPPER CONDUCTORS EACH.
- (H) EXTERIOR CABLE ENTRY PORT GROUND BARS: LOCATED AT THE ENTRANCE TO THE CELL SITE BUILDING. BOND TO GROUND RING WITH A #2 AWG SOLID TINNED COPPER CONDUCTORS WITH AN EXOTHERMIC WELD AND INSPECTION SLEEVE.
- $\begin{tabular}{ll} \hline \end{tabular} $\underline{\end{tabular}}$ $\underline{\end{tabular}}$$ $\underline{\end{tabular}}$$ $\underline{\end{tabular}}$$ $\underline{\end{tabular}}$$ $\underline{\end{tabular}}$$ $\underline{\end{tabular}}$$ $\underline{\end{tabular}}$$ $\underline{\end{tabular}}$ $\underline{\end{tabular}}$ $\underline{\end{tabular}}$$ $\underline{\end{tabular}}$$$\underline{\end{tabular}}$$$\underline{\end{tabular}}$$$\underline{\end{tabular}}$$$\underline{\end{tabular}}$$$\underline{\end{tabular}}$$$\underline{\end{tabular}}$$\underline{\$
- FRAME BONDING: THE BONDING POINT FOR TELECOM EQUIPMENT FRAMES SHALL BE THE GROUND BUS THAT IS NOT ISOLATED FROM THE EQUIPMENTS METAL FRAMEWORK. BOND THE FRAME GROUND TO THE "1" SECTION K OF THE CELL REFERENCE GROUND BAR OR SUPPLEMENTARY CONDUCTOR. (SHEET G3 DETAIL1)
- M FENCE AND GATE GROUNDING: METAL FENCES WITHIN 7 FEET OF THE EXTERIOR GROUND RING OR OBJECTS BONDED TO THE EXTERIOR GROUND RING SHALL BE BONDED TO THE GROUND RING WITH A #2 AWG SOLID TINNED COPPER CONDUCTOR AT AN INTERVAL NOT EXCEEDING 25 FEET. BONDS SHALL BE MADE AT EACH GATE POST AND ACROSS GATE OPENINGS.
- EXTERIOR UNIT BONDS: METALLIC OBJECTS, EXTERNAL TO OR MOUNTED TO THE BUILDING, SHALL BE BONDED TO THE EXTERIOR GROUND RING. USING #2 TINNED SOLID COPPER WIRE
- (P) ICE BRIDGE SUPPORTS; EACH ICE BRIDGE LEG SHALL BE BONDED TO THE GROUND RING WITH #2 AWG BARE TINNED COPPER CONDUCTOR. PROVIDE EXOTHERMIC WELDS AT BOTH THE ICE BRIDGE LEG AND BURIED
- DURING ALL DC POWER SYSTEM CHANGES INCLUDING DC SYSTEM CHANGE OUTS, RECTIFIER REPLACEMENTS
 OR ADDITIONS, BREAKER DISTRIBUTION CHANGES PATTERN ASSISTED. OR ADDITIONS, BREAKER DISTRIBUTION CHANGES, BATTERY ADDITIONS, BATTERY REPLACEMENTS AND INSTALLATIONS OR CHANGES TO DC CONVERTER SYSTEMS IT SHALL BE REQUIRED THAT SERVICE CONTRACTORS VERIFY ALL DC POWER SYSTEMS ARE EQUIPPED WITH A MASTER DC SYSTEM RETURN GROUND CONDUCTOR FROM THE DC POWER SYSTEM COMMON RETURN BUS DIRECTLY CONNECTED TO THE CELL SITE REFERENCE GROUND BAR
- (R) TOWER TOP COLLECTOR BUSS BAR IS TO BE MECHANICALLY BONDED TO PROPOSED ANTENNA MOUNT.

REFER TO DISH WIRELESS GROUNDING NOTES.

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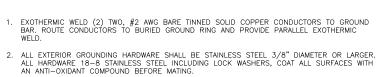
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GROUNDING PLANS AND NOTES

SHEET NUMBER

G-1





- 3. FOR GROUND BOND TO STEEL ONLY: COAT ALL SURFACES WITH AN ANTI-OXIDANT COMPOUND
- 4. DO NOT INSTALL CABLE GROUNDING KIT AT A BEND AND ALWAYS DIRECT GROUND CONDUCTOR
- 5. NUT & WASHER SHALL BE PLACED ON THE FRONT SIDE OF THE GROUND BAR AND BOLTED ON THE BACK SIDE.
- 6. ALL GROUNDING PARTS AND EQUIPMENT TO BE SUPPLIED AND INSTALLED BY CONTRACTOR

DOWN TO GROUNDING BUS

BASE CONNECTION

2 GROUND-

CABLE TRAY

SLEEPER

EXISTING BUILDING

INSTALLED IF REQUIRED

#2 STRANDED INSULATES COPPER

#6 STRANDED INSULATES

FROM CABLE (TYP) -


CHERRY INSULATOR


COPPER GROUNDING WIRE

GROUNDING WIRE TO MAIN BUS BAR (TYP)

TIN COATED SOLID

- 7. THE CONTRACTOR SHALL BE RESPONSIBLE FOR INSTALLING ADDITIONAL GROUND BAR AS
- 8. ENSURE THE WIRE INSULATION TERMINATION IS WITHIN 1/8" OF THE BARREL (NO SHINERS)

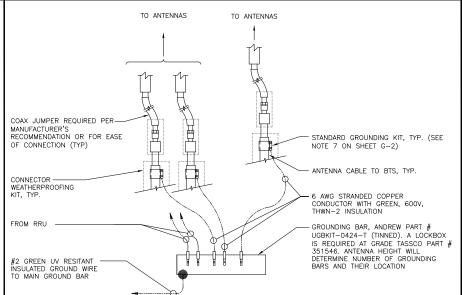

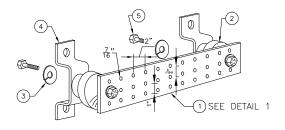

- 1. COPPER GROUND BAR, 1/4"X 4"X 20", NEWTON INSTRUMENT CO. CAT. NO. B-6142 OR EQUAL. HOLE CENTERS TO MATCH NEMA DOUBLE LUG CONFIGURATION. (ACTUAL GROUND BAR SIZE WILL VARY BASED ON NUMBER OF GROUND CONNECTIONS)
- 2. INSULATORS, NEWTON INSTRUMENT CAT. NO. 3061-4 OR EQUAL
- 3. 5/8" LOCKWASHERS, NEWTON INSTRUMENT CO. CAT. NO. 3015-8 OR EQUAL WALL MOUNTING BRACKET, NEWTON INSTRUMENT CO. CAT NO. A-6056 OR EQUAL
- 4. 5/8-11 X 1" HHCS BOLTS, NEWTON INSTRUMENT CO. CAT NO. 3012-1 OR EQUAL
- 5. INSULATORS SHALL BE ELIMINATED WHEN BONDING DIRECTLY TO TOWER/MONOPOLE STRUCTURE. CONNECTION TO TOWER/MONOPOLE STRUCTURE SHALL BE PER MANUFACTURERS RECOMMENDATIONS





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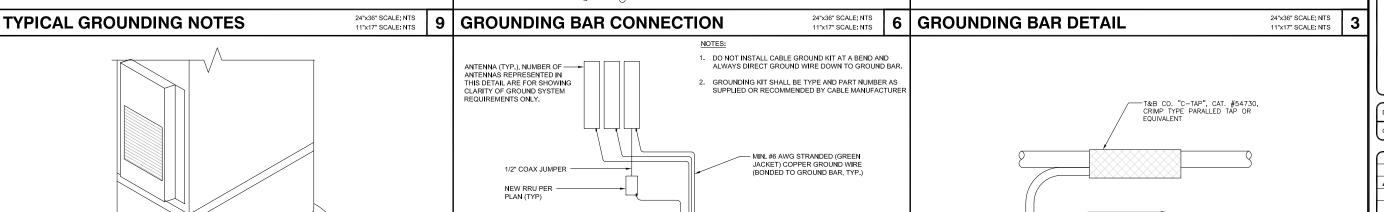
SFSFO00398A 724 ARASTRADERO RD PALO ALTO, CA 94304 **ROOFTOP**

SHEET TITLE

GROUNDING DETAILS

SHEET NUMBER

G-2





#2 UV RESISTANT GREEN INSULATED GROUNDING
JUMPER BETWEEN CABLE
TRAY SECTIONS, USE

DOUBLE LUG

CONNECTORS (TYP)

SECTION VIEW

TO CABLE TRAY/SUPPORT




MAIN GROUND BAR

- #2 AWG BARE COPPER GROUND CONDUCTOR T

BUILDING STEEL OR

GROUNDING SYSTEM

GROUNDING WIRE CONNECTION

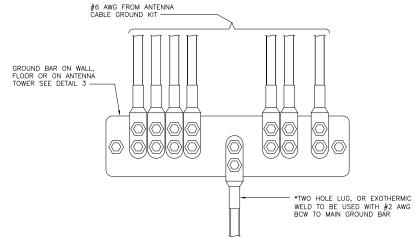

PROPOSED POST PROPOSED PIPE CLAMPS

PROPOSED GPS UNIT #6 AWG GROUND CONDUCTOR TO GROUND FOUIVALENT -PER CABLE MANUFACTURER'S 'TO CLOSEST ANTENNA OR MAIN GROUND BAR

ANTENNA GROUND BAR

#2AWG GREEN STRANDED CONDUCTOR

24"x36" SCALE: NTS

WIRE TO GROUND BAR CONNECTION

24"x36" SCALE: NTS **GPS UNIT GROUNDING**

-HOLE LONG BARREL TINNED

TIN COATED SOLID COPPER BUS BAR

SOLID COPPER LUG (TYP)

24"x36" SCALE: NTS

24"x36" SCALE: NTS

11"x17" SCALE: NTS

2

CABLE TRAY GROUND BUSS BAR


CABLE TRAY

-DIRECTION OF BOND TO TURN TO SHORTEST DISTANCE TO MGB

#6 AWG GREEN INSULATED

STRANDED COPPER WIRE (UNIT


* _ GROUND BARS AT THE BOTTOM OF TOWERS/MONOPOLES SHALL ONLY USE EXOTHERMIC WELDS.

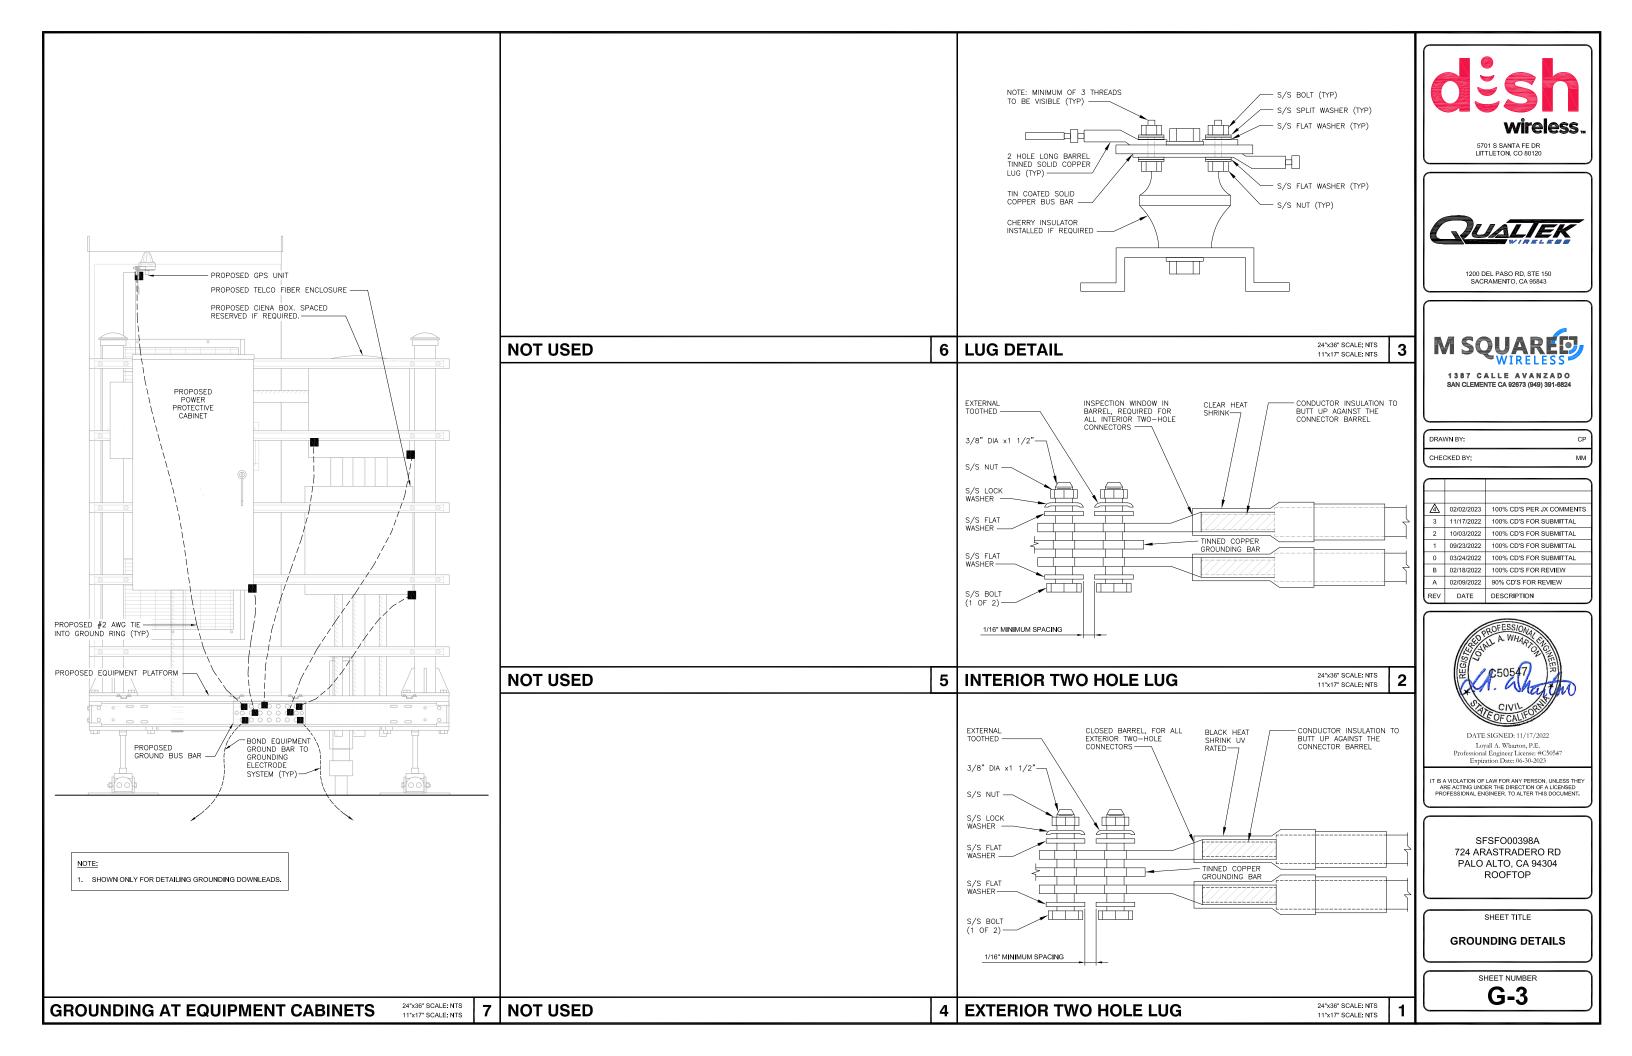

NOTE:

REFER TO LATEST COLOR CODE BEFORE
CONSTRUCTION START.

RF COLOR CODING

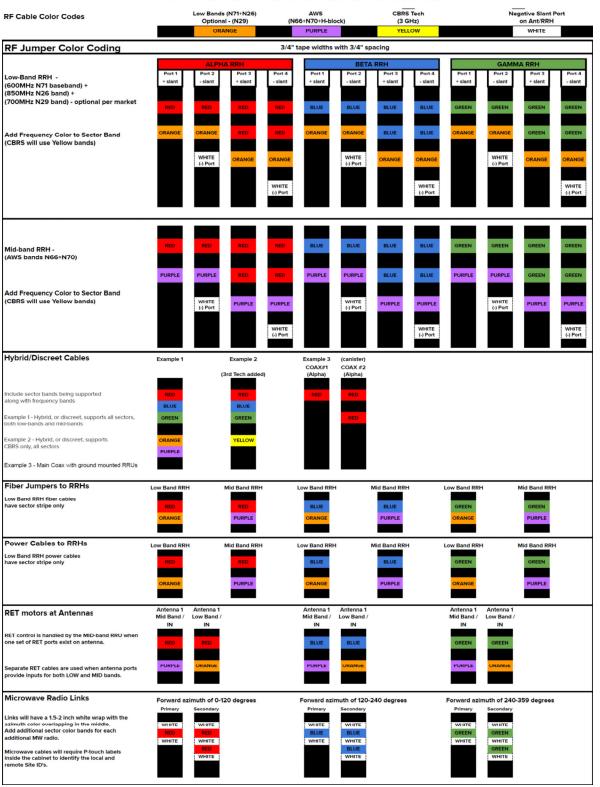



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| 3 | 11/17/2022 | 100% CD'S FOR SUBMITTAL |
| 2 | 10/03/2022 | 100% CD'S FOR SUBMITTAL |
| 1 | 09/23/2022 | 100% CD'S FOR SUBMITTAL |
| 0 | 03/24/2022 | 100% CD'S FOR SUBMITTAL |
| В | 02/18/2022 | 100% CD'S FOR REVIEW |
| Α | 02/09/2022 | 90% CD'S FOR REVIEW |
| REV | DATE | DESCRIPTION |



Loyall A. Wharton, P.E.
Professional Engineer License: #C50547
Expiration Date: 06-30-2023

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> SFSFO00398A 724 ARASTRADERO RD PALO ALTO, CA 94304 ROOFTOP

> > SHEET TITLE


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SHEET NUMBER

RF-1

NOTE:

REFER TO LATEST PLUMBING BEFORE CONSTRUCTION START.



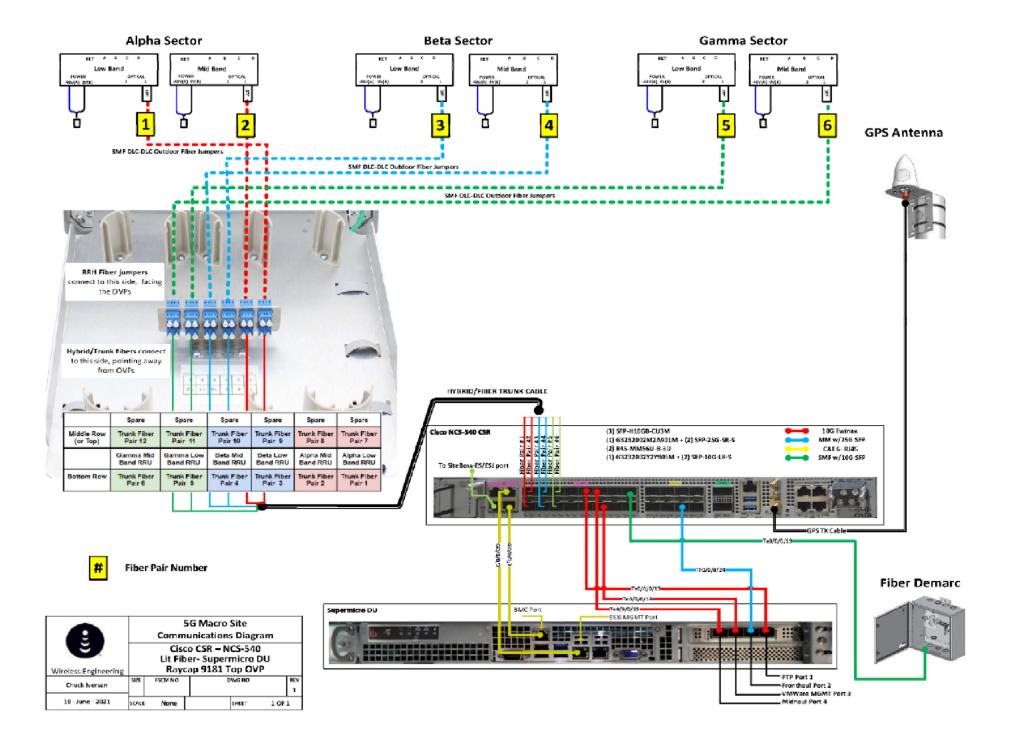

5701 S SANTA FE DR LITTLETON, CO 80120



1200 DEL PASO RD, STE 150 SACRAMENTO, CA 95843



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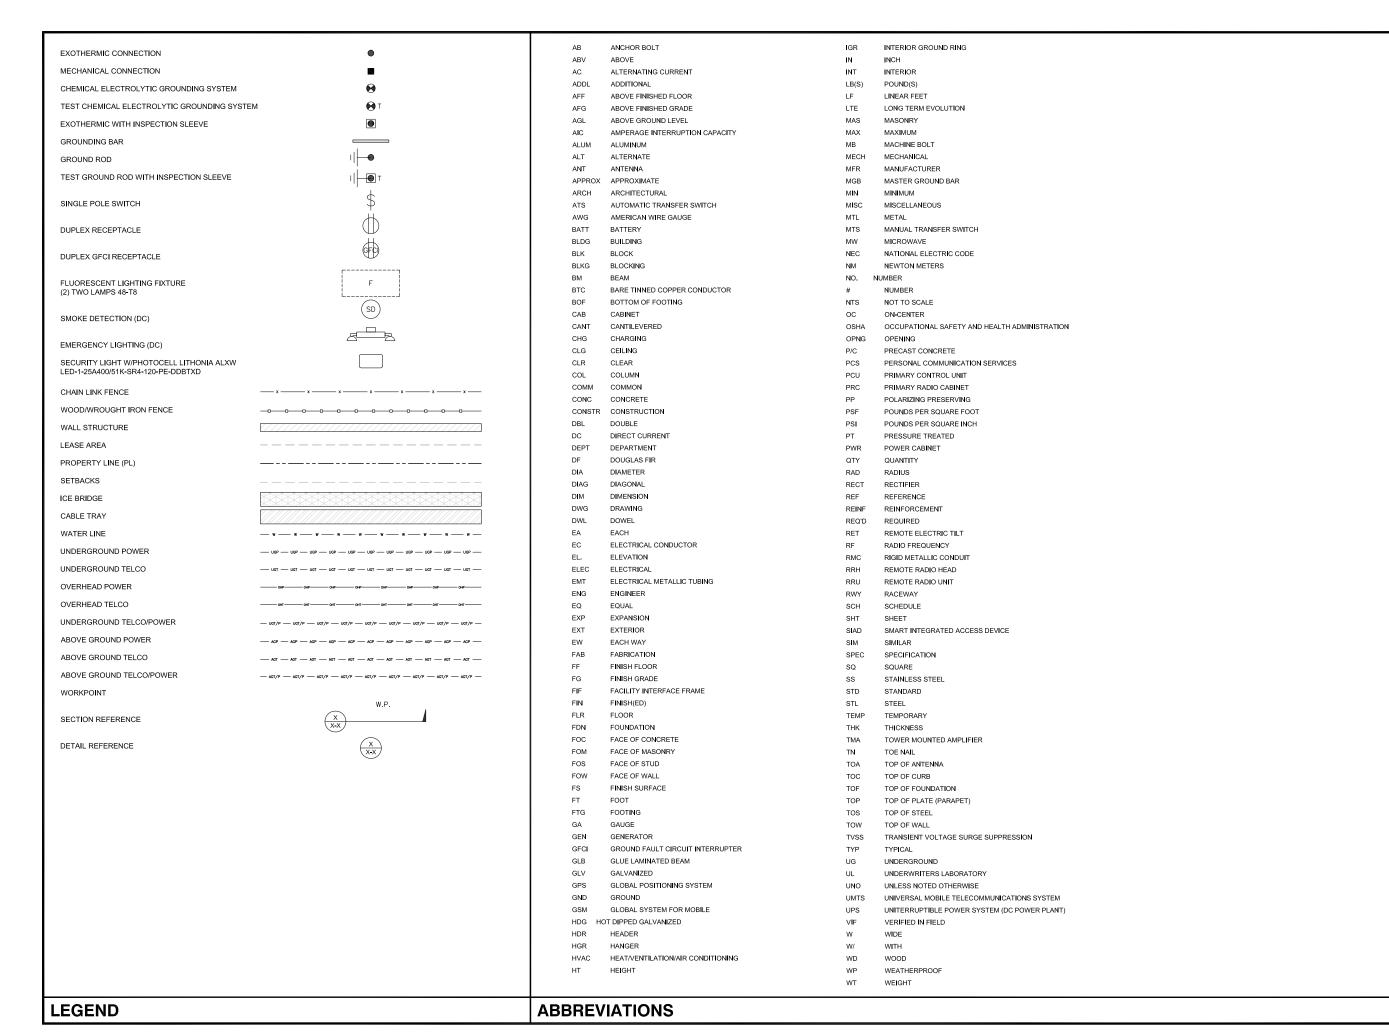
> SFSFO00398A 724 ARASTRADERO RD PALO ALTO, CA 94304 ROOFTOP

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PLUMBING DIAGRAM

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1200 DEL PASO RD, STE 150 SACRAMENTO, CA 95843



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LEGEND AND ABBREVIATIONS

SHEET NUMBER

SITE ACTIVITY REQUIREMENTS:

- NOTICE TO PROCEED NO WORK SHALL COMMENCE PRIOR TO CONTRACTOR RECEIVING A WRITTEN NOTICE TO PROCEED (NTP) AND THE ISSUANCE OF A PURCHASE ORDER. PRIOR TO ACCESSING/ENTERING THE SITE YOU MUST CONTACT THE DISH WIRELESS AND TOWER OWNER NOC & THE DISH WIRELESS AND TOWER OWNER CONSTRUCTION MANAGER.
- 2. "LOOK UP" DISH WIRELESS AND TOWER OWNER SAFETY CLIMB REQUIREMENT:
- THE INTEGRITY OF THE SAFETY CLIMB AND ALL COMPONENTS OF THE CLIMBING FACILITY SHALL BE CONSIDERED DURING ALL STAGES OF DESIGN, INSTALLATION, AND INSPECTION. TOWER MODIFICATION, MOUNT REINFORCEMENTS, AND/OR EQUIPMENT INSTALLATIONS SHALL NOT COMPROMISE THE INTEGRITY OR FUNCTIONAL USE OF THE SAFETY CLIMB OR ANY COMPONENTS OF THE CLIMBING FACILITY ON THE STRUCTURE. THIS SHALL INCLUDE, BUT NOT BE LIMITED TO: PINCHING OF THE WIRE ROPE, BENDING OF THE WIRE ROPE FROM ITS SUPPORTS, DIRECT CONTACT OR CLOSE PROXIMITY TO THE WIRE ROPE WHICH MAY CAUSE FRICTIONAL WEAR, IMPACT TO THE ANCHORAGE POINTS IN ANY WAY, OR TO IMPEDE/BLOCK ITS INTENDED USE. ANY COMPROMISED SAFETY CLIMB, INCLUDING EXISTING CONDITIONS MUST BE TAGGED OUT AND REPORTED TO YOUR DISH WIRELESS AND DISH WIRELESS AND TOWER OWNER POC OR CALL THE NOC TO GENERATE A SAFETY CLIMB MAINTENANCE AND CONTRACTOR NOTICE TICKET.
- 3. PRIOR TO THE START OF CONSTRUCTION, ALL REQUIRED JURISDICTIONAL PERMITS SHALL BE OBTAINED. THIS INCLUDES, BUT IS NOT LIMITED TO, BUILDING, ELECTRICAL, MECHANICAL, FIRE, FLOOD ZONE, ENVIRONMENTAL, AND ZONING. AFTER ONSITE ACTIVITIES AND CONSTRUCTION ARE COMPLETED, ALL REQUIRED PERMITS SHALL BE SATISFIED AND CLOSED OUT ACCORDING TO LOCAL JURISDICTIONAL REQUIREMENTS.
- 4. ALL CONSTRUCTION MEANS AND METHODS; INCLUDING BUT NOT LIMITED TO, ERECTION PLANS, RIGGING PLANS, CLIMBING PLANS, AND RESCUE PLANS SHALL BE THE RESPONSIBILITY OF THE GENERAL CONTRACTOR RESPONSIBLE FOR THE EXECUTION OF THE WORK CONTAINED HEREIN, AND SHALL MEET ANSI/ASSE A10.48 (LATEST EDITION); FEDERAL, STATE, AND LOCAL REGULATIONS; AND ANY APPLICABLE INDUSTRY CONSENSUS STANDARDS RELATED TO THE CONSTRUCTION ACTIVITIES BEING PERFORMED. ALL RIGGING PLANS SHALL ADHERE TO ANSI/ASSE A10.48 (LATEST EDITION) AND DISH WIRELESS AND TOWER OWNER STANDARDS, INCLUDING THE REQUIRED INVOLVEMENT OF A QUALIFIED ENGINEER FOR CLASS IV CONSTRUCTION, TO CERTIFY THE SUPPORTING STRUCTURE(S) IN ACCORDANCE WITH ANSI/TIA-3/22 (I ATEST EDITION)
- 5. ALL SITE WORK TO COMPLY WITH DISH WIRELESS AND TOWER OWNER INSTALLATION STANDARDS FOR CONSTRUCTION ACTIVITIES ON DISH WIRELESS AND TOWER OWNER TOWER SITE AND LATEST VERSION OF ANSI/TIA-1019-A-2012 "STANDARD FOR INSTALLATION, ALTERATION, AND MAINTENANCE OF ANTENNA SUPPORTING STRUCTURES AND ANTENNAS."
- 6. IF THE SPECIFIED EQUIPMENT CAN NOT BE INSTALLED AS SHOWN ON THESE DRAWINGS, THE CONTRACTOR SHALL PROPOSE AN ALTERNATIVE INSTALLATION FOR APPROVAL BY DISH WIRELESS AND TOWER OWNER PRIOR TO PROCEEDING WITH ANY SUCH CHANGE OF INSTALL ATION
- 7. ALL MATERIALS FURNISHED AND INSTALLED SHALL BE IN STRICT ACCORDANCE WITH ALL APPLICABLE CODES, REGULATIONS AND ORDINANCES. CONTRACTOR SHALL ISSUE ALL APPROPRIATE NOTICES AND COMPLY WITH ALL LAWS, ORDINANCES, RULES, REGULATIONS AND LAWFUL ORDERS OF ANY PUBLIC AUTHORITY REGARDING THE PERFORMANCE OF THE WORK. ALL WORK CARRIED OUT SHALL COMPLY WITH ALL APPLICABLE MUNICIPAL AND UTILITY COMPANY SPECIFICATIONS AND LOCAL JURISDICTIONAL CODES, ORDINANCES AND APPLICABLE FREGULATIONS
- 8. THE CONTRACTOR SHALL INSTALL ALL EQUIPMENT AND MATERIALS IN ACCORDANCE WITH MANUFACTURER'S RECOMMENDATIONS UNLESS SPECIFICALLY STATED OTHERWISE.
- 9. THE CONTRACTOR SHALL CONTACT UTILITY LOCATING SERVICES INCLUDING PRIVATE LOCATES SERVICES PRIOR TO THE START OF CONSTRUCTION.
- 10. ALL EXISTING ACTIVE SEWER, WATER, GAS, ELECTRIC AND OTHER UTILITIES WHERE ENCOUNTERED IN THE WORK, SHALL BE PROTECTED AT ALL TIMES AND WHERE REQUIRED FOR THE PROPER EXECUTION OF THE WORK, SHALL BE RELOCATED AS DIRECTED BY CONTRACTOR. EXTREME CAUTION SHOULD BE USED BY THE CONTRACTOR WHEN EXCAVATING OR DRILLING PIERS AROUND OR NEAR UTILITIES. CONTRACTOR SHALL PROVIDE SAFETY TRAINING FOR THE WORKING CREW. THIS WILL INCLUDE BUT NOT BE LIMITED TO A) FALL PROTECTION B) CONFINED SPACE C) ELECTRICAL SAFETY D) TRENCHING AND EXCAVATION E) CONSTRUCTION SAFETY PROCEDURES.
- 11. ALL SITE WORK SHALL BE AS INDICATED ON THE STAMPED CONSTRUCTION DRAWINGS AND DISH PROJECT SPECIFICATIONS, LATEST APPROVED REVISION.
- 12. CONTRACTOR SHALL KEEP THE SITE FREE FROM ACCUMULATING WASTE MATERIAL, DEBRIS, AND TRASH AT THE COMPLETION OF THE WORK. IF NECESSARY, RUBBISH, STUMPS, DEBRIS, STICKS, STONES AND OTHER REFUSE SHALL BE REMOVED FROM THE SITE AND DISPOSED OF LEGALLY.
- 13. ALL EXISTING INACTIVE SEWER, WATER, GAS, ELECTRIC AND OTHER UTILITIES, WHICH INTERFERE WITH THE EXECUTION OF THE WORK, SHALL BE REMOVED AND/OR CAPPED, PLUGGED OR OTHERWISE DISCONTINUED AT POINTS WHICH WILL NOT INTERFERE WITH THE EXECUTION OF THE WORK, SUBJECT TO THE APPROVAL OF DISH WIRELESS AND TOWER OWNER, AND/OR LOCAL UTILITIES.
- 14. THE CONTRACTOR SHALL PROVIDE SITE SIGNAGE IN ACCORDANCE WITH THE TECHNICAL SPECIFICATION FOR SITE SIGNAGE REQUIRED BY LOCAL JURISDICTION AND SIGNAGE REQUIRED ON INDIVIDUAL PIECES OF EQUIPMENT. ROOMS, AND SHELTERS.
- 15. THE SITE SHALL BE GRADED TO CAUSE SURFACE WATER TO FLOW AWAY FROM THE CARRIER'S EQUIPMENT AND TOWER AREAS.
- 16. THE SUB GRADE SHALL BE COMPACTED AND BROUGHT TO A SMOOTH UNIFORM GRADE PRIOR TO FINISHED SURFACE APPLICATION.
- 17. THE AREAS OF THE OWNERS PROPERTY DISTURBED BY THE WORK AND NOT COVERED BY THE TOWER, EQUIPMENT OR DRIVEWAY, SHALL BE GRADED TO A UNIFORM SLOPE, AND STABILIZED TO PREVENT EROSION AS SPECIFIED ON THE CONSTRUCTION DRAWINGS AND/OR PROJECT SPECIFICATIONS.
- 18. CONTRACTOR SHALL MINIMIZE DISTURBANCE TO EXISTING SITE DURING CONSTRUCTION. EROSION CONTROL MEASURES, IF REQUIRED DURING CONSTRUCTION, SHALL BE IN CONFORMANCE WITH THE LOCAL GUIDELINES FOR EROSION AND SEDIMENT CONTROL.
- 19. THE CONTRACTOR SHALL PROTECT EXISTING IMPROVEMENTS, PAVEMENTS, CURBS, LANDSCAPING AND STRUCTURES. ANY DAMAGED PART SHALL BE REPAIRED AT CONTRACTOR'S EXPENSE TO THE SATISFACTION OF OWNER.
- 20. CONTRACTOR SHALL LEGALLY AND PROPERLY DISPOSE OF ALL SCRAP MATERIALS SUCH AS COAXIAL CABLES AND OTHER ITEMS REMOVED FROM THE EXISTING FACILITY. ANTENNAS AND RADIOS REMOVED SHALL BE RETURNED TO THE OWNER'S DESIGNATED LOCATION.
- 21. CONTRACTOR SHALL LEAVE PREMISES IN CLEAN CONDITION. TRASH AND DEBRIS SHOULD BE REMOVED FROM SITE ON A DAILY BASIS.
- 22. NO FILL OR EMBANKMENT MATERIAL SHALL BE PLACED ON FROZEN GROUND. FROZEN MATERIALS, SNOW OR ICE SHALL NOT BE PLACED IN ANY FILL OR EMBANKMENT.

GENERAL NOTES:

1.FOR THE PURPOSE OF CONSTRUCTION DRAWING. THE FOLLOWING DEFINITIONS SHALL APPLY:

CONTRACTOR: GENERAL CONTRACTOR RESPONSIBLE FOR CONSTRUCTION

CARRIER:DISH WIRELESS

TOWER OWNER: TOWER OWNER

- THESE DRAWINGS HAVE BEEN PREPARED USING STANDARDS OF PROFESSIONAL CARE AND COMPLETENESS NORMALLY EXERCISED UNDER SIMILAR CIRCUMSTANCES BY REPUTABLE ENGINEERS IN THIS OR SIMILAR LOCALITIES. IT IS ASSUMED THAT THE WORK DEPICTED WILL BE PERFORMED BY AN EXPERIENCED CONTRACTOR AND/OR WORKPEOPLE WHO HAVE A WORKING KNOWLEDGE OF THE APPLICABLE CODE STANDARDS AND REQUIREMENTS AND OF INDUSTRY ACCEPTED STANDARD GOOD PRACTICE. AS NOT EVERY CONDITION OR ELEMENT IS (OR CAN BE) EXPLICITLY SHOWN ON THESE DRAWINGS, THE CONTRACTOR SHALL USE INDUSTRY ACCEPTED STANDARD GOOD PRACTICE FOR MISCELLANEOUS WORK NOT EXPLICITLY SHOWN.
- 3. THESE DRAWINGS REPRESENT THE FINISHED STRUCTURE. THEY DO NOT INDICATE THE MEANS OR METHODS OF CONSTRUCTION. THE CONTRACTOR SHALL BE SOLELY RESPONSIBLE FOR THE CONSTRUCTION MEANS, METHODS, TECHNIQUES, SEQUENCES, AND PROCEDURES, THE CONTRACTOR SHALL PROVIDE ALL MEASURES NECESSARY FOR PROTECTION OF LIFE AND PROPERTY DURING CONSTRUCTION. SUCH MEASURES SHALL INCLUDE, BUT NOT BE LIMITED TO, BRACING, FORMWORK, SHORING, ETC. SITE VISITS BY THE ENGINEER OR HIS REPRESENTATIVE WILL NOT INCLUDE INSPECTION OF THESE ITEMS AND IS FOR STRUCTURAL OBSERVATION OF THE FINISHED STRUCTURE ONLY.
- 4. NOTES AND DETAILS IN THE CONSTRUCTION DRAWINGS SHALL TAKE PRECEDENCE OVER GENERAL NOTES AND TYPICAL DETAILS. WHERE NO DETAILS ARE SHOWN, CONSTRUCTION SHALL CONFORM TO SIMILAR WORK ON THE PROJECT, AND/OR AS PROVIDED FOR IN THE CONTRACT DOCUMENTS. WHERE DISCREPANCIES OCCUR BETWEEN PLANS, DETAILS, GENERAL NOTES, AND SPECIFICATIONS, THE GREATER, MORE STRICT REQUIREMENTS, SHALL GOVERN, IF FURTHER CLARIFICATION IS REQUIRED CONTACT THE ENGINEER OF RECORD.
- 5. SUBSTANTIAL EFFORT HAS BEEN MADE TO PROVIDE ACCURATE DIMENSIONS AND MEASUREMENTS ON THE DRAWINGS TO ASSIST IN THE FABRICATION AND/OR PLACEMENT OF CONSTRUCTION ELEMENTS BUT IT IS THE SOLE RESPONSIBILITY OF THE CONTRACTOR TO FIELD VERIFY THE DIMENSIONS, MEASUREMENTS, AND/OR CLEARANCES SHOWN IN THE CONSTRUCTION DRAWINGS PRIOR TO FABRICATION OR CUTTING OF ANY NEW OR EXISTING CONSTRUCTION ELEMENTS. IF IT IS DETERMINED THAT THERE ARE DISCREPANCIES AND/OR CONFLICTS WITH THE CONSTRUCTION DRAWINGS THE ENGINEER OF RECORD IS TO BE NOTIFIED AS SOON AS POSSIBLE.
- 6. PRIOR TO THE SUBMISSION OF BIDS, THE BIDDING CONTRACTOR SHALL VISIT THE CELL SITE TO FAMILIARIZE WITH THE EXISTING CONDITIONS AND TO CONFIRM THAT THE WORK CAN BE ACCOMPLISHED AS SHOWN ON THE CONSTRUCTION DRAWINGS. ANY DISCREPANCY FOUND SHALL BE BROUGHT TO THE ATTENTION OF CARRIER POC AND TOWER OWNER.
- 7. ALL MATERIALS FURNISHED AND INSTALLED SHALL BE IN STRICT ACCORDANCE WITH ALL APPLICABLE CODES, REGULATIONS AND ORDINANCES. CONTRACTOR SHALL ISSUE ALL APPROPRIATE NOTICES AND COMPLY WITH ALL LAWS, ORDINANCES, RULES, REGULATIONS AND LAWFUL ORDERS OF ANY PUBLIC AUTHORITY REGARDING THE PERFORMANCE OF THE WORK. ALL WORK CARRIED OUT SHALL COMPLY WITH ALL APPLICABLE MUNICIPAL AND UTILITY COMPANY SPECIFICATIONS AND LOCAL JURISDICTIONAL CODES, ORDINANCES AND APPLICABLE REGULATIONS.
- 8. UNLESS NOTED OTHERWISE, THE WORK SHALL INCLUDE FURNISHING MATERIALS, EQUIPMENT, APPURTENANCES AND LABOR NECESSARY TO COMPLETE ALL INSTALLATIONS AS INDICATED ON THE DRAWINGS.
- 9. THE CONTRACTOR SHALL INSTALL ALL EQUIPMENT AND MATERIALS IN ACCORDANCE WITH MANUFACTURER'S RECOMMENDATIONS UNLESS SPECIFICALLY STATED OTHERWISE.
- 10. IF THE SPECIFIED EQUIPMENT CAN NOT BE INSTALLED AS SHOWN ON THESE DRAWINGS, THE CONTRACTOR SHALL PROPOSE AN ALTERNATIVE INSTALLATION FOR APPROVAL BY THE CARRIER AND TOWER OWNER PRIOR TO PROCEEDING WITH ANY SUCH CHANGE OF INSTALLATION.
- 11. CONTRACTOR IS TO PERFORM A SITE INVESTIGATION, BEFORE SUBMITTING BIDS, TO DETERMINE THE BEST ROUTING OF ALL CONDUITS FOR POWER, AND TELCO AND FOR GROUNDING CABLES AS SHOWN IN THE POWER, TELCO, AND GROUNDING PLAN DRAWINGS.
- 2. THE CONTRACTOR SHALL PROTECT EXISTING IMPROVEMENTS, PAVEMENTS, CURBS, LANDSCAPING AND STRUCTURES. ANY DAMAGED PART SHALL BE REPAIRED AT CONTRACTOR'S EXPENSE TO THE SATISFACTION OF DISH WIRELESS AND TOWER OWNER
- 13. CONTRACTOR SHALL LEGALLY AND PROPERLY DISPOSE OF ALL SCRAP MATERIALS SUCH AS COAXIAL CABLES AND OTHER ITEMS REMOVED FROM THE EXISTING FACILITY. ANTENNAS REMOVED SHALL BE RETURNED TO THE OWNER'S DESIGNATED LOCATION.
- 14. CONTRACTOR SHALL LEAVE PREMISES IN CLEAN CONDITION. TRASH AND DEBRIS SHOULD BE REMOVED FROM SITE ON A DAILY BASIS.



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GENERAL NOTES

SHEET NUMBER

CONCRETE, FOUNDATIONS, AND REINFORCING STEEL:

- ALL CONCRETE WORK SHALL BE IN ACCORDANCE WITH THE ACI 301, ACI 318, ACI 336, ASTM A184, ASTM A185 AND THE DESIGN AND CONSTRUCTION SPECIFICATION FOR CAST-IN-PLACE CONCRETE.
- 2. UNLESS NOTED OTHERWISE, SOIL BEARING PRESSURE USED FOR DESIGN OF SLABS AND FOUNDATIONS IS ASSUMED TO BE 1000 psf.
- 3. ALL CONCRETE SHALL HAVE A MINIMUM COMPRESSIVE STRENGTH (fc) OF 3000 psi AT 28 DAYS, UNLESS NOTED OTHERWISE. NO MORE THAN 90 MINUTES SHALL ELAPSE FROM BATCH TIME TO TIME OF PLACEMENT UNLESS APPROVED BY THE ENGINEER OF RECORD. TEMPERATURE OF CONCRETE SHALL NOT EXCEED 90°F AT TIME OF PLACEMENT.
- 4. CONCRETE EXPOSED TO FREEZE-THAW CYCLES SHALL CONTAIN AIR ENTRAINING ADMIXTURES. AMOUNT OF AIR ENTRAINMENT TO BE BASED ON SIZE OF AGGREGATE AND F3 CLASS EXPOSURE (VERY SEVERE). CEMENT USED TO BE TYPE II PORTLAND CEMENT WITH A MAXIMUM WATER-TO-CEMENT RATIO (W/C) OF 0.45.
- 5. ALL STEEL REINFORCING SHALL CONFORM TO ASTM A615. ALL WELDED WIRE FABRIC (WWF) SHALL CONFORM TO ASTM A185. ALL SPLICES SHALL BE CLASS "B" TENSION SPLICES, UNLESS NOTED OTHERWISE. ALL HOOKS SHALL BE STANDARD 90 DEGREE HOOKS, UNLESS NOTED OTHERWISE. YIELD STRENGTH (Fy) OF STANDARD DEFORMED BARS ARE AS FOLLOWS:

#4 BARS AND SMALLER 40 ksi

#5 BARS AND LARGER 60 ksi

- 6. THE FOLLOWING MINIMUM CONCRETE COVER SHALL BE PROVIDED FOR REINFORCING STEEL UNLESS SHOWN OTHERWISE ON DRAWINGS:
 - CONCRETE CAST AGAINST AND PERMANENTLY EXPOSED TO EARTH 3"
 - CONCRETE EXPOSED TO EARTH OR WEATHER:
- #6 BARS AND LARGER 2"
- #5 BARS AND SMALLER 1-1/2"
- CONCRETE NOT EXPOSED TO EARTH OR WEATHER:
- SLAB AND WALLS 3/4"
- BEAMS AND COLUMNS 1-1/2"
- 7. A TOOLED EDGE OR A 3/4" CHAMFER SHALL BE PROVIDED AT ALL EXPOSED EDGES OF CONCRETE, UNLESS NOTED OTHERWISE, IN ACCORDANCE WITH ACI 301 SECTION 4.2.4.

ELECTRICAL INSTALLATION NOTES

- ALL ELECTRICAL WORK SHALL BE PERFORMED IN ACCORDANCE WITH THE PROJECT SPECIFICATIONS, NEC AND ALL APPLICABLE FEDERAL, STATE, AND LOCAL CODES/ORDINANCES.
- CONDUIT ROUTINGS ARE SCHEMATIC. CONTRACTOR SHALL INSTALL CONDUITS SO THAT ACCESS TO EQUIPMENT IS NOT BLOCKED AND TRIP
 HAZARDS ARE ELIMINATED.
- 3. WIRING, RACEWAY AND SUPPORT METHODS AND MATERIALS SHALL COMPLY WITH THE REQUIREMENTS OF THE NEC.
- 4. ALL CIRCUITS SHALL BE SEGREGATED AND MAINTAIN MINIMUM CABLE SEPARATION AS REQUIRED BY THE NEC.
- 4.1. ALL EQUIPMENT SHALL BEAR THE UNDERWRITERS LABORATORIES LABEL OF APPROVAL, AND SHALL CONFORM TO REQUIREMENT OF THE NATIONAL ELECTRICAL CODE.
- 4.2. ALL OVERCURRENT DEVICES SHALL HAVE AN INTERRUPTING CURRENT RATING THAT SHALL BE GREATER THAN THE SHORT CIRCUIT CURRENT TO WHICH THEY ARE SUBJECTED, 22,000 AIC MINIMUM. VERIFY AVAILABLE SHORT CIRCUIT CURRENT DOES NOT EXCEED THE RATING OF ELECTRICAL EQUIPMENT IN ACCORDANCE WITH ARTICLE 110.24 NEC OR THE MOST CURRENT ADOPTED CODE PRE THE GOVERNING
- 5. EACH END OF EVERY POWER PHASE CONDUCTOR, GROUNDING CONDUCTOR, AND TELCO CONDUCTOR OR CABLE SHALL BE LABELED WITH COLOR-CODED INSULATION OR ELECTRICAL TAPE (3M BRAND, 1/2" PLASTIC ELECTRICAL TAPE WITH UV PROTECTION, OR EQUAL). THE IDENTIFICATION METHOD SHALL CONFORM WITH NEC AND OSHA.
- 6. ALL ELECTRICAL COMPONENTS SHALL BE CLEARLY LABELED WITH LAMICOID TAGS SHOWING THEIR RATED VOLTAGE, PHASE CONFIGURATION, WIRE CONFIGURATION, POWER OR AMPACITY RATING AND BRANCH CIRCUIT ID NUMBERS (i.e. PANEL BOARD AND CIRCUIT ID'S).
- 7. PANEL BOARDS (ID NUMBERS) SHALL BE CLEARLY LABELED WITH PLASTIC LABELS.
- 8. TIE WRAPS ARE NOT ALLOWED
- 9. ALL POWER AND EQUIPMENT GROUND WIRING IN TUBING OR CONDUIT SHALL BE SINGLE COPPER CONDUCTOR (#14 OR LARGER) WITH TYPE THHW, THWN, THWN-2, XHHW, XHHW-2, THW, THW-2, RHW, OR RHW-2 INSULATION UNLESS OTHERWISE SPECIFIED.
- 10. SUPPLEMENTAL EQUIPMENT GROUND WIRING LOCATED INDOORS SHALL BE SINGLE COPPER CONDUCTOR (#6 OR LARGER) WITH TYPE THHW, THWN, THWN-2, XHHW, XHHW-2, THW, THW-2, RHW, OR RHW-2 INSULATION UNLESS OTHERWISE SPECIFIED.
- 11. POWER AND CONTROL WIRING IN FLEXIBLE CORD SHALL BE MULTI-CONDUCTOR, TYPE SOOW CORD (#14 OR LARGER) UNLESS OTHERWISE SPECIFIED.
- 12. POWER AND CONTROL WIRING FOR USE IN CABLE TRAY SHALL BE MULTI-CONDUCTOR, TYPE TC CABLE (#14 OR LARGER), WITH TYPE THHW, THWN, THWN-2, XHHW, XHHW-2, THW, THW-2, RHW, OR RHW-2 INSULATION UNLESS OTHERWISE SPECIFIED.
- 13. ALL POWER AND GROUNDING CONNECTIONS SHALL BE CRIMP-STYLE, COMPRESSION WIRE LUGS AND WIRE NUTS BY THOMAS AND BETTS (OR EQUAL). LUGS AND WIRE NUTS SHALL BE RATED FOR OPERATION NOT LESS THAN 75° C (90° C IF AVAILABLE).
- 14. RACEWAY AND CABLE TRAY SHALL BE LISTED OR LABELED FOR ELECTRICAL USE IN ACCORDANCE WITH NEMA, UL, ANSI/IEEE AND NEC.
- 15. ELECTRICAL METALLIC TUBING (EMT), INTERMEDIATE METAL CONDUIT (IMC), OR RIGID METAL CONDUIT (RMC) SHALL BE USED FOR EXPOSED INDOOR LOCATIONS.
- 16. ELECTRICAL METALLIC TUBING (EMT) OR METAL-CLAD CABLE (MC) SHALL BE USED FOR CONCEALED INDOOR LOCATIONS.
- 17. SCHEDULE 40 PVC UNDERGROUND ON STRAIGHTS AND SCHEDULE 80 PVC FOR ALL ELBOWS/90s AND ALL APPROVED ABOVE GRADE PVC CONDUIT.
- 18. LIQUID-TIGHT FLEXIBLE METALLIC CONDUIT (LIQUID-TITE FLEX) SHALL BE USED INDOORS AND OUTDOORS, WHERE VIBRATION OCCURS OR FLEXIBILITY IS NEEDED.

- CONDUIT AND TUBING FITTINGS SHALL BE THREADED OR COMPRESSION-TYPE AND APPROVED FOR THE LOCATION USED. SET SCREW FITTINGS ARE NOT ACCEPTABLE.
- 20. CABINETS, BOXES AND WIRE WAYS SHALL BE LABELED FOR ELECTRICAL USE IN ACCORDANCE WITH NEMA, UL, ANSI/IEEE AND THE NEC.
- 21. WIREWAYS SHALL BE METAL WITH AN ENAMEL FINISH AND INCLUDE A HINGED COVER, DESIGNED TO SWING OPEN DOWNWARDS (WIREMOLD SPECMATE WIREWAY)
- 22. SLOTTED WIRING DUCT SHALL BE PVC AND INCLUDE COVER (PANDUIT TYPE E OR EQUAL).
 - CONDUITS SHALL BE FASTENED SECURELY IN PLACE WITH APPROVED NON-PERFORATED STRAPS AND HANGERS. EXPLOSIVE DEVICES (i.e. POWDER-ACTUATED) FOR ATTACHING HANGERS TO STRUCTURE WILL NOT BE PERMITTED. CLOSELY FOLLOW THE LINES OF THE STRUCTURE, MAINTAIN CLOSE PROXIMITY TO THE STRUCTURE AND KEEP CONDUITS IN TIGHT ENVELOPES. CHANGES IN DIRECTION TO ROUTE AROUND OBSTACLES SHALL BE MADE WITH CONDUIT OUTLET BODIES. CONDUIT SHALL BE INSTALLED IN A NEAT AND WORKMANLIKE MANNER. PARALLEL AND PERPENDICULAR TO STRUCTURE WALL AND CEILING LINES. ALL CONDUIT SHALL BE FISHED TO CLEAR OBSTRUCTIONS. ENDS OF CONDUITS SHALL BE TEMPORARILY CAPPED FLUSH TO FINISH GRADE TO PREVENT CONCRETE, PLASTER OR DIRT FROM ENTERING. CONDUITS SHALL BE RIGIDLY CLAMPED TO BOXES BY GALVANIZED MALLEABLE IRON BUSHING ON INSIDE AND GALVANIZED MALLEABLE IRON LOCKNUT ON OUTSIDE AND INSIDE
- 24. EQUIPMENT CABINETS, TERMINAL BOXES, JUNCTION BOXES AND PULL BOXES SHALL BE GALVANIZED OR EPOXY-COATED SHEET STEEL. SHALL MEET OR EXCEED UL 50 AND BE RATED NEMA 1 (OR BETTER) FOR INTERIOR LOCATIONS AND NEMA 3 (OR BETTER) FOR EXTERIOR LOCATIONS.
- 5. METAL RECEPTACLE, SWITCH AND DEVICE BOXES SHALL BE GALVANIZED, EPOXY-COATED OR NON-CORRODING; SHALL MEET OR EXCEED UL 514A AND NEMA OS 1 AND BE RATED NEMA 1 (OR BETTER) FOR INTERIOR LOCATIONS AND WEATHER PROTECTED (WP OR BETTER) FOR EXTERIOR LOCATIONS.
- 26. NONMETALLIC RECEPTACLE, SWITCH AND DEVICE BOXES SHALL MEET OR EXCEED NEMA OS 2 (NEWEST REVISION) AND BE RATED NEMA 1 (OR BETTER) FOR INTERIOR LOCATIONS AND WEATHER PROTECTED (WP OR BETTER) FOR EXTERIOR LOCATIONS.
- 27. THE CONTRACTOR SHALL NOTIFY AND OBTAIN NECESSARY AUTHORIZATION FROM THE CARRIER AND/OR DISH WIRELESS AND TOWER OWNER BEFORE COMMENCING WORK ON THE AC POWER DISTRIBUTION PANELS.
- 28. THE CONTRACTOR SHALL PROVIDE NECESSARY TAGGING ON THE BREAKERS, CABLES AND DISTRIBUTION PANELS IN ACCORDANCE WITH THE APPLICABLE CODES AND STANDARDS TO SAFEGUARD LIFE AND PROPERTY.
- 29. INSTALL LAMICOID LABEL ON THE METER CENTER TO SHOW "DISH WIRELESS".
- 30. ALL EMPTY/SPARE CONDUITS THAT ARE INSTALLED ARE TO HAVE A METERED MULE TAPE PULL CORD INSTALLED



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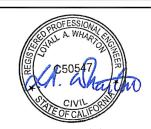


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| | 4 | 02/02/2023 | 100% CD'S PER JX COMMENTS |
| | 3 | 11/17/2022 | 100% CD'S FOR SUBMITTAL |
| ı | 2 | 10/03/2022 | 100% CD'S FOR SUBMITTAL |
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| | В | 02/18/2022 | 100% CD'S FOR REVIEW |
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SHEET TITLE

GENERAL NOTES

SHEET NUMBER

GROUNDING NOTES:

- 1. ALL GROUND ELECTRODE SYSTEMS (INCLUDING TELECOMMUNICATION, RADIO, LIGHTNING PROTECTION AND AC POWER GES'S) SHALL BE BONDED TOGETHER AT OR BELOW GRADE, BY TWO OR MORE COPPER BONDING CONDUCTORS IN ACCORDANCE WITH THE NEC.
- 2. THE CONTRACTOR SHALL PERFORM IEEE FALL-OF-POTENTIAL RESISTANCE TO EARTH TESTING (PER IEEE 1100 AND 81) FOR GROUND ELECTRODE SYSTEMS, THE CONTRACTOR SHALL FURNISH AND INSTALL SUPPLEMENTAL GROUND ELECTRODES AS NEEDED TO ACHIEVE A TEST RESULT OF 5 OHMS OR LESS.
- 3. THE CONTRACTOR IS RESPONSIBLE FOR PROPERLY SEQUENCING GROUNDING AND UNDERGROUND CONDUIT INSTALLATION AS TO PREVENT ANY LOSS OF CONTINUITY IN THE GROUNDING SYSTEM OR DAMAGE TO THE CONDUIT AND PROVIDE TESTING RESULTS.
- 4. METAL CONDUIT AND TRAY SHALL BE GROUNDED AND MADE ELECTRICALLY CONTINUOUS WITH LISTED BONDING FITTINGS OR BY BONDING ACROSS THE DISCONTINUITY WITH #6 COPPER WIRE UL APPROVED GROUNDING TYPE CONDUIT CLAMPS.
- 5. METAL RACEWAY SHALL NOT BE USED AS THE NEC REQUIRED EQUIPMENT GROUND CONDUCTOR. STRANDED COPPER CONDUCTORS WITH GREEN INSULATION, SIZED IN ACCORDANCE WITH THE NEC, SHALL BE FURNISHED AND INSTALLED WITH THE POWER CIRCUITS TO BTS FOLIPMENT
- 6. EACH CABINET FRAME SHALL BE DIRECTLY CONNECTED TO THE MASTER GROUND BAR WITH GREEN INSULATED SUPPLEMENTAL EQUIPMENT GROUND WIRES, #6 STRANDED COPPER OR LARGER FOR INDOOR BTS; #2 BARE SOLID TINNED COPPER FOR OUTDOOR BTS.
- 7. CONNECTIONS TO THE GROUND BUS SHALL NOT BE DOUBLED UP OR STACKED BACK TO BACK CONNECTIONS ON OPPOSITE SIDE OF THE GROUND BUS ARE PERMITTED.
- 8. ALL EXTERIOR GROUND CONDUCTORS BETWEEN EQUIPMENT/GROUND BARS AND THE GROUND RING SHALL BE #2 SOLID TINNED COPPER LINE ESS OTHERWISE INDICATED.
- 9. ALUMINUM CONDUCTOR OR COPPER CLAD STEEL CONDUCTOR SHALL NOT BE USED FOR GROUNDING CONNECTIONS
- 10. USE OF 90° BENDS IN THE PROTECTION GROUNDING CONDUCTORS SHALL BE AVOIDED WHEN 45° BENDS CAN BE ADEQUATELY SUPPORTED.
- 11. EXOTHERMIC WELDS SHALL BE USED FOR ALL GROUNDING CONNECTIONS BELOW GRADE.
- 12. ALL GROUND CONNECTIONS ABOVE GRADE (INTERIOR AND EXTERIOR) SHALL BE FORMED USING HIGH PRESS CRIMPS.
- 13. COMPRESSION GROUND CONNECTIONS MAY BE REPLACED BY EXOTHERMIC WELD CONNECTIONS.
- 14. ICE BRIDGE BONDING CONDUCTORS SHALL BE EXOTHERMICALLY BONDED OR BOLTED TO THE BRIDGE AND THE TOWER GROUND BAR.
- 15. APPROVED ANTIOXIDANT COATINGS (i.e. CONDUCTIVE GEL OR PASTE) SHALL BE USED ON ALL COMPRESSION AND BOLTED GROUND CONNECTIONS.
- 16. ALL EXTERIOR GROUND CONNECTIONS SHALL BE COATED WITH A CORROSION RESISTANT MATERIAL.
- 17. MISCELLANEOUS ELECTRICAL AND NON-ELECTRICAL METAL BOXES, FRAMES AND SUPPORTS SHALL BE BONDED TO THE GROUND RING, IN ACCORDANCE WITH THE NEC
- 18. BOND ALL METALLIC OBJECTS WITHIN 6 ft OF MAIN GROUND RING WITH (1) #2 BARE SOLID TINNED COPPER GROUND CONDUCTOR.
- 19. GROUND CONDUCTORS USED FOR THE FACILITY GROUNDING AND LIGHTNING PROTECTION SYSTEMS SHALL NOT BE ROUTED THROUGH
 METALLIC OBJECTS THAT FORM A RING AROUND THE CONDUCTOR, SUCH AS METALLIC CONDUITS, METAL SUPPORT CLIPS OR SLEEVES
 THROUGH WALLS OR FLOORS. WHEN IT IS REQUIRED TO BE HOUSED IN CONDUIT TO MEET CODE REQUIREMENTS OR LOCAL CONDITIONS,
 NON-METALLIC MATERIAL SUCH AS PVC CONDUIT SHALL BE USED. WHERE USE OF METAL CONDUIT IS UNAVOIDABLE (i.e., NONMETALLIC CONDUIT
 PROHIBITED BY LOCAL CODE) THE GROUND CONDUCTOR SHALL BE BONDED TO EACH END OF THE METAL CONDUIT.
- 20. ALL GROUNDS THAT TRANSITION FROM BELOW GRADE TO ABOVE GRADE MUST BE #2 BARE SOLID TINNED COPPER IN 3/4" NON-METALLIC, FLEXIBLE CONDUIT FROM 24" BELOW GRADE TO WITHIN 3" TO 6" OF CAD-WELD TERMINATION POINT. THE EXPOSED END OF THE CONDUIT MUST BE SEALED WITH SILICONE CAULK. (ADD TRANSITIONING GROUND STANDARD DETAIL AS WELL).
- 21. BUILDINGS WHERE THE MAIN GROUNDING CONDUCTORS ARE REQUIRED TO BE ROUTED TO GRADE, THE CONTRACTOR SHALL ROUTE TWO GROUNDING CONDUCTORS FROM THE ROOFTOP, TOWERS, AND WATER TOWERS GROUNDING RING, TO THE EXISTING GROUNDING SYSTEM, THE GROUNDING CONDUCTORS SHALL NOT BE SMALLER THAN 2/0 COPPER. ROOFTOP GROUNDING RING SHALL BE BONDED TO THE EXISTING GROUNDING SYSTEM, THE BUILDING STEEL COLUMNS, LIGHTNING PROTECTION SYSTEM, AND BUILDING MAIN WATER LINE (FERROUS OR NONFERROUS METAL PIPING ONLY). DO NOT ATTACH GROUNDING TO FIRE SPRINKLER SYSTEM PIPES.



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