SHEET INDEX DESCRIPTION TITLE SHEET GENERAL NOTES C-1.0 SITE PLAN EXISTING ENLARGED ROOF PLAN PROPOSED ENLARGED ROOF PLAN C-2.0 ENLARGED EQUIPMENT LAYOUT ENLARGED EQUIPMENT LAYOUT SITE ELEVATION ANTENNA DETAILS SITE DETAILS ANTENNA SCHEDULES EQUIPMENT SPECS UTILITY NOTES & UTILITY PLAN FINAL SINGLE LINE DIAGRAMS GROUNDING DETAILS AND NOTES SITE CONFIGURATIONS MATERIAL LIST SITE CONFIGURATIONS MATERIAL LIST SITE CONFIGURATIONS MATERIAL LIST STRUCTURAL NOTES ANTENNA MOUNTING DETAILS ANTENNA MOUNTING DETAILS EQUIPMENT SPECS

DRIVING DIRECTIONS

FROM: NORMAN Y. MINETA SAN JOSE INTERNATIONAL AIRPORT 1701 AIRPORT BLVD, SAN JOSE, CA 95110
GET ON US-101 N FROM AIRPORT BLVD AND AIRPORT PKWY
FOLLOW US-101 N TO SAN ANTONIO RD. TAKE EXIT 400C FROM CONTINUE ON SAN ANTONIO RD. DRIVE TO FABIAN WAY 3921 FABIAN WAY PALO ALTO, CA 94303

((Sirius XM))

SITE NAME

TAUBE KORET CAMPUS

SITE I.D.

SFX631B


SITE ADDRESS

3921 FABIAN WAY PALO ALTO, CA 94303

STRUCTURE TYPE

ROOFTOP

PROJECT TEAM

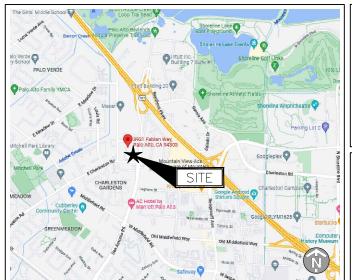

VICINITY MAP

((Sirius XM))

1500 ECKINGTON PLACE NE WASHINGTON DC, 20002 (202) 380-4157

ULLERTON

1100 E. WOODFIELD ROAD, SUITE 500 SCHAUMBURG, ILLINOIS 60173 TEL: 847-908-8400 www.FullertonEngineering.com

ENGINEER

APPLICANT

CODE COMPLIANCE:

- HANDICAP ACCESS REQUIREMENTS ARE NOT REQUIRED
- FACILITY IS UNMANNED AND NOT FOR HUMAN
- FACILITY HAS NO PLUMBING OR REFRIGERANTS
- THIS FACILITY SHALL MEET OR EXCEED ALL FAA AND FCC REGULATORY REQUIREMENTS

SCOPE OF WORK:

- INSTALL (1) NEW SIRIUS XM CABINET ON PROPOSED PLATFORM MOUNTED ON ELEVATED STEEL BEAM FRAME INSIDE SCREEN WALL
- INSTALL (1) NEW SIRIUS XM RX DISH ON PROPOSED MOUNT ATTACHED TO EXISTING SCREEN WALL
- INSTALL (1) NEW SIRIUS XM PANEL ANTENNA ON PROPOSED MOUNT ATTACHED TO EXISTING SCREEN WALL INSTALL (1) NEW SIRIUS XM VSAT ON PROPOSED MOUNT ATTACHED TO
- EXISTING SCREEN WALL
- INSTALL (1) NEW SIRIUS XM GPS ON EXISTING PENTHOUSE WALL ALL NEW MATERIAL SHALL BE FURNISHED AND INSTALLED BY CONTRACTOR UNLESS NOTED OTHERWISE. CABINETS, ANTENNAS AND CABLES FURNISHED BY OWNER AND INSTALLED BY CONTRACTOR

PROJECT SUMMARY

TAUBE KORET CAMPUS

SITE NO: SFX631B

SITE ADDRESS: 3921 FABIAN WAY

PALO ALTO, CA 94303

SANTA CLARA COUNTY **COUNTY:**

SITE COORDINATES RCRE

LATITUDE: 37.422177° (NAD 83) LONGITUDE -122.102056° 65' (NAD 83) GROUND ELEVATION: (AMSL)

CITY OF PALO ALTO JURISDICTION: PC-4918 ZONING:

APPLICANT: SIRILIS XM

1500 ECKINGTON PL NE WASHINGTON, DC 20002 TEL: (202) 380-4157 FAX: (202) 380-4570

LANDLORD: TAUBE KORET CAMPUS

3921 FABIAN WAY, PALO ALTO, CA 94303

BUILDING CODE: 2019 CALIFORNIA BUILDING CODE ELECTRICAL CODE: 2019 CALIFORNIA ELECTRICAL CODE

((Sirius XM)))

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ΑP	PROVED BY:	JP	
#	DATE	DESCRIPTION	INT.
	03/18/22	90% REVIEW	KK
	03/22/22	95% REVIEW	KK
0	03/28/22	FINAL	KK

CERTIFICATION STATEMENT

I HEREBY CERTIFY THAT THESE DRAWING WERE PREPARED BY ME OR UNDER MY DIRECT SUPERVISION AND CONTROL, AND TO THE BEST OF MY KNOWLEDGE AND BELIEF COMPLY WITH THE REQUIREMENTS OF ALL APPLICABLE CODES.

APPROVALS

DRAWING SCALED TO 11"x17"

DATE

DATE

DATE

CONST.

LANDLORD

SITE NAME

TAUBE KORET CAMPUS

SITE I.D.

SFX631B

SITE ADDRESS

3921 FABIAN WAY PALO ALTO, CA 94303

SHEET NAME

TITLE SHEET

SHEET NUMBER

GENERAL CONSTRUCTION NOTES:

- THIS SET OF PLANS HAS BEEN PREPARED FOR THE PURPOSES OF MUNICIPAL AND ACENCY REVIEW AND APPROVAL.
- 2. THESE PLANS ARE INTENDED TO BE USED TO DIRECT THE PROPOSED LAYOUT. DRAWINGS SHOULD NOT BE SCALED UNLESS OTHERWISE NOTED. PLANS, ELEVATIONS AND DETAILS ARE INTENDED TO SHOW THE END RESULT OF DESIGN. MINOR MODIFICATIONS MAY BE REQUIRED TO SUIT JOB DIMENSIONS OR CONDITIONS.
- 3. THE CONTRACTOR SHALL VERIFY ALL DIMENSIONS AND CONDITIONS AND NOTIFY THE PROJECT MANAGER OF ANY DISCREPANCIES BEFORE STARTING ANY WORK.
- ALL EQUIPMENT AND MATERIALS SHALL BE INSTALLED IN ACCORDANCE WITH THE MANUFACTURER'S RECOMMENDATIONS UNLESS OTHERWISE NOTED BY THE ENGINEER OF RECORD.
- 5. CONTRACTOR SHALL BE RESPONSIBLE FOR ALL WORK PERFORMED AND MATERIALS INSTALLED TO BE IN STRICT CONFORMANCE, AS A MINIMUM STANDARD, WITH ALL APPLICABLE CODES, REGULATIONS AND ORDINANCES HAVING JURISDICTION. ELECTRICAL SYSTEMS SHALL BE INSTALLED IN CONFORMANCE WITH THE NATIONAL ELECTRICAL CODE, AND ALL OTHER LOCAL AND STATE JURISDICTIONAL CODES, ORDINANCES, AND WITH LOCAL UTILITY COMPANY SPECIFICATIONS, WHICHEVER IS MORE STRINGENT.
- 6. THE CONTRACTOR SHALL KEEP CONTRACT AREA CLEAN, HAZARD FREE AND DISPOSE OF ALL DIRT, STUMPS, STONES, RUBBISH OR DEBRIS IN ACCORDANCE WITH ALL LOCAL AND ENVIRONMENTAL LAWS. NO MATERIALS OR EQUIPMENT SHALL BE PLACED ANYWHERE ON OR IN THE STRUCTURE WITHOUT MAKING ADEQUATE PROVISIONS TO PROTECT EXISTING PROPERTY. UPON COMPLETION, REPAIR ANY DAMAGE THAT MAY HAVE OCCURRED DURING CONSTRUCTION. REPAIR ALL EXISTING WALL SURFACES DAMAGED DURING CONSTRUCTION SUCH THAT THEY MATCH AND BLEND WITH ADJACENT SURFACES
- THE CONTRACTOR SHALL BE SOLELY RESPONSIBLE AND HAVE CONTROL OVER CONSTRUCTION MEANS, METHODS, TECHNIQUES, SEQUENCES, AND PROCEDURES.

WARRANTIES AND BONDS:

- THE CONTRACTOR SHALL GUARANTEE ALL LABOR AND MATERIALS USED IN THIS
 PROJECT FOR A MINIMUM PERIOD OF ONE (1) YEAR COMMENCING FROM THE DATE
 OF FINAL ACCEPTANCE BY THE CLIENT. THE CONTRACTOR IS NOT REQUIRED TO
 GUARANTEE MATERIAL SUPPLIED BY THE OWNER.
- FINAL DATE OF ACCEPTANCE IS DEEMED AS THE DATE THAT ALL REQUIRED STATE AND FEDERAL APPROVAL HAVE BEEN OBTAINED INCLUDING, BUT NOT LIMITED TO: A. FINAL INSPECTION – D14
 B. CERTIFICATE OF OCCUPANCY
- ANY DEFICIENCIES THAT COME EVIDENT DURING THIS ONE (1) YEAR PERIOD SHALL BE CORRECTED BY THE CONTRACTOR AT THE CONTRACTOR'S EXPENSE.

DELIVERY, STORAGE AND HANDLING:

- THE CONTRACTOR SHALL BE RESPONSIBLE FOR ALL PROCEDURES AND SCHEDULING ASSOCIATED WITH HOISTING, STAGING, AND ERECTING OF MATERIALS AND EQUIPMENT TO AND/OR UPON THE SITE.
- 2. ALL ELEMENTS OF THE EXISTING SITE, I.E. STRUCTURES, SITE PLANTINGS, ETC. SHALL BE PROTECTED AS NECESSARY FROM SAID ACTIONS. THIS WORK MUST BE DONE IN A SAFE, SECURE NONDESTRUCTIVE MANNER FOR PROTECTING PERSONNEL AND PROPERTY.

SITE WORK GENERAL NOTES:

- 1. THE CONTRACTOR SHALL CALL UTILITIES PRIOR TO THE START OF CONSTRUCTION.
- 2. ALL SITE WORK SHALL BE AS INDICATED ON THE DRAWING AND STIPULATED IN THE SPECIFICATION PROJECT SUMMARY.
- 3. IF NECESSARY, RUBBISH, STUMPS, DEBRIS, STICKS, STONES, AND OTHER REFUSE SHALL BE REMOVED FROM THE SITE AND DISPOSED OF LEGALLY.
- 4. THE SITE SHALL BE GRADED TO CAUSE SURFACE WATER FLOW AWAY FROM THE EQUIPMENT SHELTER AND TOWER AREAS.
- 5. NO FILL OR EMBANKMENT MATERIAL SHALL BE PLACED ON FROZEN GROUND. FROZEN MATERIALS, SNOW OR ICE SHALL NOT BE PLACED IN ANY FILL OR FMBANKMENT
- THE SUB GRADE SHALL BE COMPACTED AND BROUGHT TO A SMOOTH UNIFORM GRADE PRIOR TO FINISHED SURFACE APPLICATION.
- 7. ALL EXISTING INACTIVE SEWER, WATER, GAS, ELECTRIC AND OTHER UTILITIES, WHICH INTERFERE WITH THE EXECUTION OF THE WORK, SHALL BE REMOVED AND/OR CAPPED, PLUGGED OR OTHERWISE DISCONTINUED AT POINTS WHICH WILL NOT INTERFERE WITH THE EXECUTION OF THE WORK, SUBJECT TO THE APPROVAL OF FNGINFFRING
- 8. THE AREAS OF THE OWNERS PROPERTY DISTURBED BY THE WORK AND NOT COVERED BY THE BUILDING OR DRIVEWAY, SHALL BE GRADED TO A UNIFORM SLOPE, FERTILIZED AND SEEDED.
- 9. CONTRACTOR SHALL MINIMIZE DISTURBANCE TO EXISTING SITE DURING CONSTRUCTION. EROSION CONTROL MEASURES, SHALL BE IN CONFORMANCE WITH THE LOCAL GUIDELINES FOR EROSION AND SEDIMENT CONTROL.
- 10. ALL BACK FILL SHALL BE COMPACTED TO 95% MODIFIED PROCTOR DENSITY AS DETERMINED BY ASTM STANDARD TEST PROCEDURES.

CONSTRUCTION SPECIFICATIONS:

- 1. THE CONTRACTOR SHALL VISIT THE SITE OF THE PROPOSED WORK AND FULLY ACQUAINT THEMSELVES WITH THE CONDITIONS AS THEY EXIST IN ORDER THAT ANY RESTRICTIONS PERTAINING TO THE WORK ARE UNDERSTOOD. ALL AREAS AND DIMENSIONS ARE INDICATED ON THE DRAWINGS AS ACCURATELY AS POSSIBLE, BUT ALL CONDITIONS SHALL BE VERIFIED BY EACH CONTRACTOR AND/OR SUBCONTRACTOR AT THE SITE. THE FAILURE OF THE CONTRACTOR TO EXAMINE OR RECEIVE ANY FORM, INSTRUMENT OR DOCUMENT, OR TO VISIT THE SITE SHALL NOT RELIEVE THE CONTRACTOR FROM ANY OBLIGATION WITH RESPECT TO THEIR QUOTED PRICE. THE SUBMISSION OF A QUOTATION SHALL ACKNOWLEDGE THAT THE CONTRACTOR AND THEIR SUBCONTRACTORS HAVE FULLY EXAMINED THE SITE AND KNOW THE EXISTING CONDITIONS AND HAVE MADE PROVISIONS FOR OPERATING UNDER THE CONDITIONS AS THEY EXIST AT THE SITE AND HAVE INCLUDED ALL NECESSARY ITEMS.
- THE GENERAL CONTRACTOR'S RESPONSIBILITIES SHALL INCLUDE, BUT NOT BE LIMITED TO, CONSTRUCTION OF THE EQUIPMENT FOUNDATION, INCLUDING ELECTRICAL SERVICE, TELEPHONE CONDUITS, GROUNDING SYSTEM AND COORDINATION WITH LOCAL UTILITY COMPANIES.
- 3. THE ANTENNA INSTALLERS RESPONSIBILITIES SHALL INCLUDE, BUT NOT BE LIMITED TO, CABLE TRAY INSTALLATION, ROUTING OF CABLES FROM RADIO EQUIPMENT TO ANTENNAS, ASSOCIATED HARDWARE FOR SECURING ANTENNA CABLES, ANTENNA MOUNTS, DETERMINING SUPPLIER OF ANTENNAS, GROUNDING OF ANTENNAS TO GROUNDING SYSTEM, INSTALLING ANTENNAS AND VERIFYING WITH RADIO FREQUENCY ENGINEERS, THE ALIGNMENT, LOCATION, AND PROPER ORIENTATION OF ANTENNAS.
- 4. THE CONTRACTORS SHALL COORDINATE CONSTRUCTION ACTIVITIES WITH THE BUILDING LANDLORD IN ORDER TO AVOID CONFLICTS WITH CURRENT USE OF THE SITE.
- THE OWNER MAY HAVE WORK PERFORMED UNDER SEPARATE CONTRACTS, CONCURRENTLY. WITH THE WORK OF THIS CONTRACT.
- THE GENERAL CONTRACTOR SHALL PERMIT ACCESS TO THE PROJECT TO THESE CONTRACTORS TO PERFORM THEIR WORK.
- 7. CONTRACTOR SHALL CONFORM TO ALL APPLICABLE LOCAL, COUNTY, STATE, AND FEDERAL CODES, LAWS AND REQUIREMENTS, INCLUDING OSHA.
- 8. THE CONTRACTOR SHALL APPLY AND PAY FOR THE CONSTRUCTION PERMIT, CERTIFICATE OF OCCUPANCY AND ALL OTHER REQUIRED PERMITS OR LICENSES. THE CONTRACTOR IS RESPONSIBLE FOR OBTAINING ALL INSPECTIONS.
- 9. CARE SHALL BE EXERCISED IN PROTECTING THE BUILDING OCCUPANTS DURING THE DEMOLITION AND CONSTRUCTION PERIODS OF THIS PROJECT. EVERY EFFORT SHALL BE MADE TO MAINTAIN A CLEAN OPERATION. DEBRIS SHALL NOT ACCUMULATE. ALL DEBRIS WILL BE DEPOSITED IN A SUITABLE CONTAINER ON A DAILY BASIS AND SHALL BE EMPTIED ON A REGULAR SCHEDULE. THE LOCATION OF THE CONTAINER SHALL BE COORDINATED WITH THE BUILDING MANAGER.
- 10. SAFETY PROCEDURES: ATTENTION IS DIRECTED TO FEDERAL, STATE, AND LOCAL LAWS, RULES AND REGULATIONS CONCERNING CONSTRUCTION SAFETY AND HEALTH STANDARDS. THE CONSTRUCTION COMPANY AWARDED THIS PROJECT SHALL ENSURE ALL WORKING SURROUNDINGS AND CONDITIONS ARE SANITARY AND ARE NOT HAZARDOUS OR DANGEROUS TO THE HEALTH OR SAFETY OF THE WORK CREWS OR BUILDING OCCUPANTS. PRECAUTION SHALL BE EXERCISED AT ALL TIMES FOR THE PROTECTION OF PERSONS AND PROPERTY. IT IS MANDATORY THAT THE SAFETY PROVISIONS OF APPLICABLE LOCAL LAWS, OSHA REGULATIONS AND BUILDING AND CONSTRUCTION CODES, BE OBSERVED FOR ALL CONTRACTORS AND ANTENNA RIGGERS.
- 11. THE GENERAL CONTRACTOR MUST COORDINATE ALL ROOF RELATED WORK WITH THE LANDLORD'S PRE—APPROVED ROOFER. THE GENERAL CONTRACTOR MUST CONFIRM THE COMPATIBILITY OF ALL MATERIALS AND ENSURE THAT ALL EXISTING ROOF WARRANTIES, IF ANY, REMAIN IN EFFECT.



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В	03/22/22	95% REVIEW	KK
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SITE NAME

TAUBE KORET
CAMPUS

SITE I.D.

SFX631B

SITE ADDRESS

3921 FABIAN WAY PALO ALTO, CA 94303

SHEET NAME

GENERAL NOTES


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T-2

ABBREVIATIONS ABOVE FINISHED FLOOR ABOVE GRADE LEVEL ABOVE MEAN SEA LEVEL AGL AMSL APPROX APPROXIMATE AWG AMERICAN WIRE GAUGE BLDG BTS BUILDING BASE TRANSMISSION STATION CLR COL CONC CLEAR COLUMN CONCRETE CND CONDUIT DWG DRAWING FOOT(FEET) EGB EQUIPMENT GROUND BAR ELEC EMT ELECTRICAL ELECTRICAL METALLIC TUBING ELEVATION ELEV EQUIP EQUIPMENT EXISTING EXISTING EXT FND EXTERIOR FOUNDATION GAUGE GALV GALVANIZED GLOBAL POSITIONING SYSTEM GROUND LONG TERM EVOLUTION MAX MAXIMUM MFR MANUFACTURER MGB MASTER GROUND BAR MINIMUM NOT TO SCALE ON CENTER OE/OT RGS OVERHEAD ELECTRIC/TELCO RIGID GALVANIZED STEEL INCH(ES) INTERIOR LB.(#) POUND(S) RRÙ" REMOTE RADIO UNIT SQUARE FOOT STEEL TYPICAL UNDERGROUND ELECTRIC UNDERGROUND TELCO UNLESS NOTED OTHERWISE UNO VERIFY IN FIELD XFMR TRANSFORMER CENTERLINE PLATE SYMBOLS

Ę.	CENTERLINE
/	REVISION
•	WORK POINT
0	UTILITY POLE
	BRICK
	COMPRESSED STONE
	CONCRETE
	EARTH
	GRAVEL
	MASONRY
	STEEL
	CENTERLINE
	PROPERTY LINE
	LEASE LINE
	EASEMENT LINE
	CHAIN LINK FENCE
	WOOD FENCE
——UE——	BELOW GRADE ELECTRIC
——— UT ———	BELOW GRADE TELEPHONE
OE/OT	OVERHEAD ELECTRIC/TELEPHONE

(A) SECTION REFERENCE



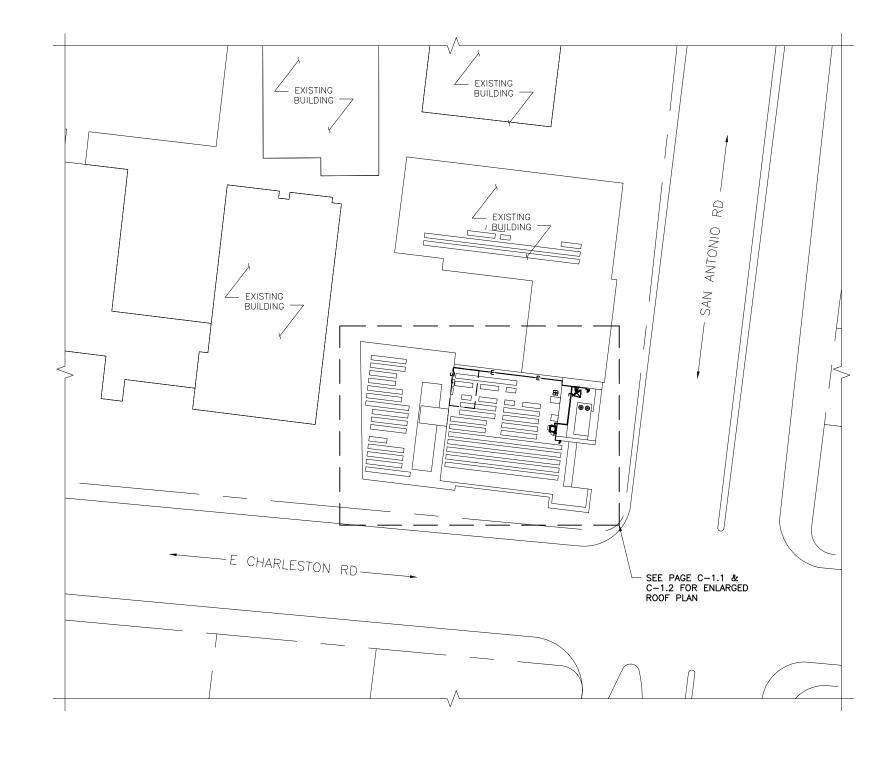

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TAUBE KORET CAMPUS

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SFX631B

SITE ADDRESS

3921 FABIAN WAY PALO ALTO, CA 94303

SHEET NAME


SITE PLAN

SHEET NUMBER

C-1.0

SITE PLAN

SCALE: 1" = 60'-0"

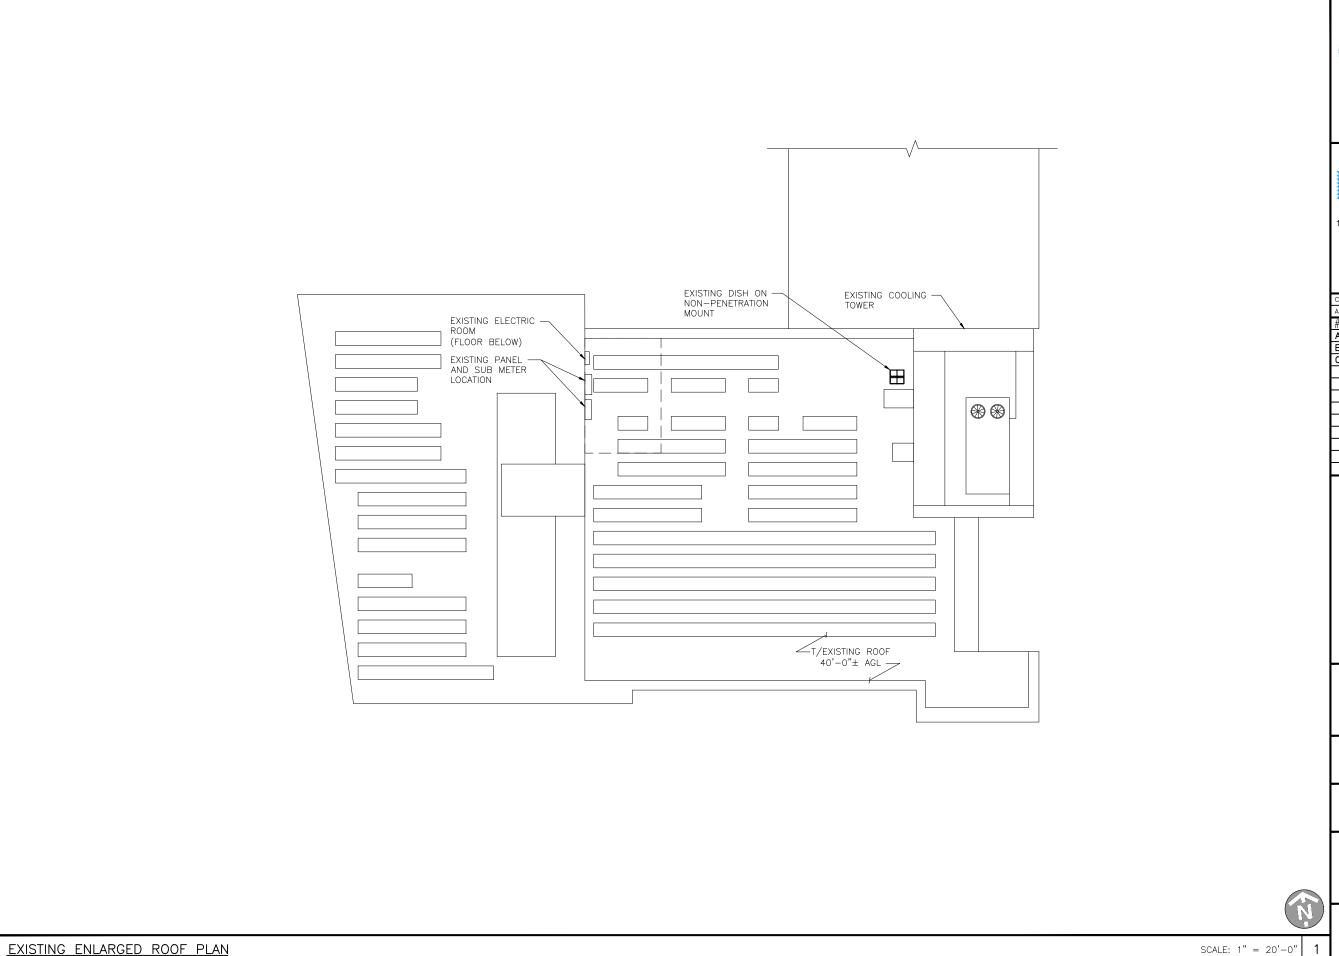





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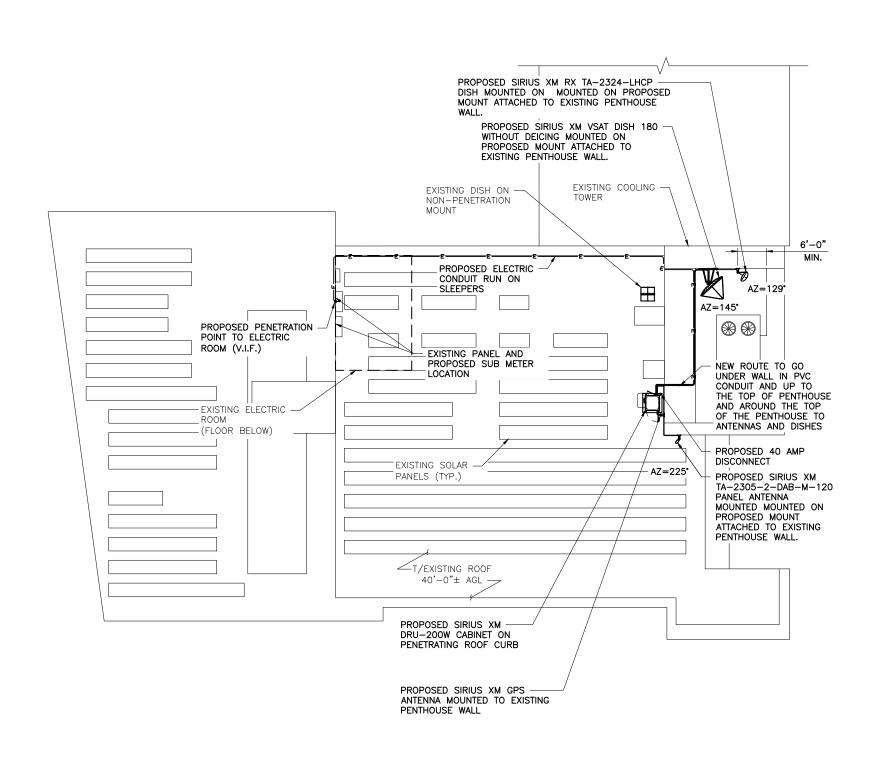
3921 FABIAN WAY PALO ALTO, CA 94303

SHEET NAME EXISTING ENLARGED ROOF PLAN

SHEET NUMBER

C-1.1

2020.0030.0031







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SITE NAME

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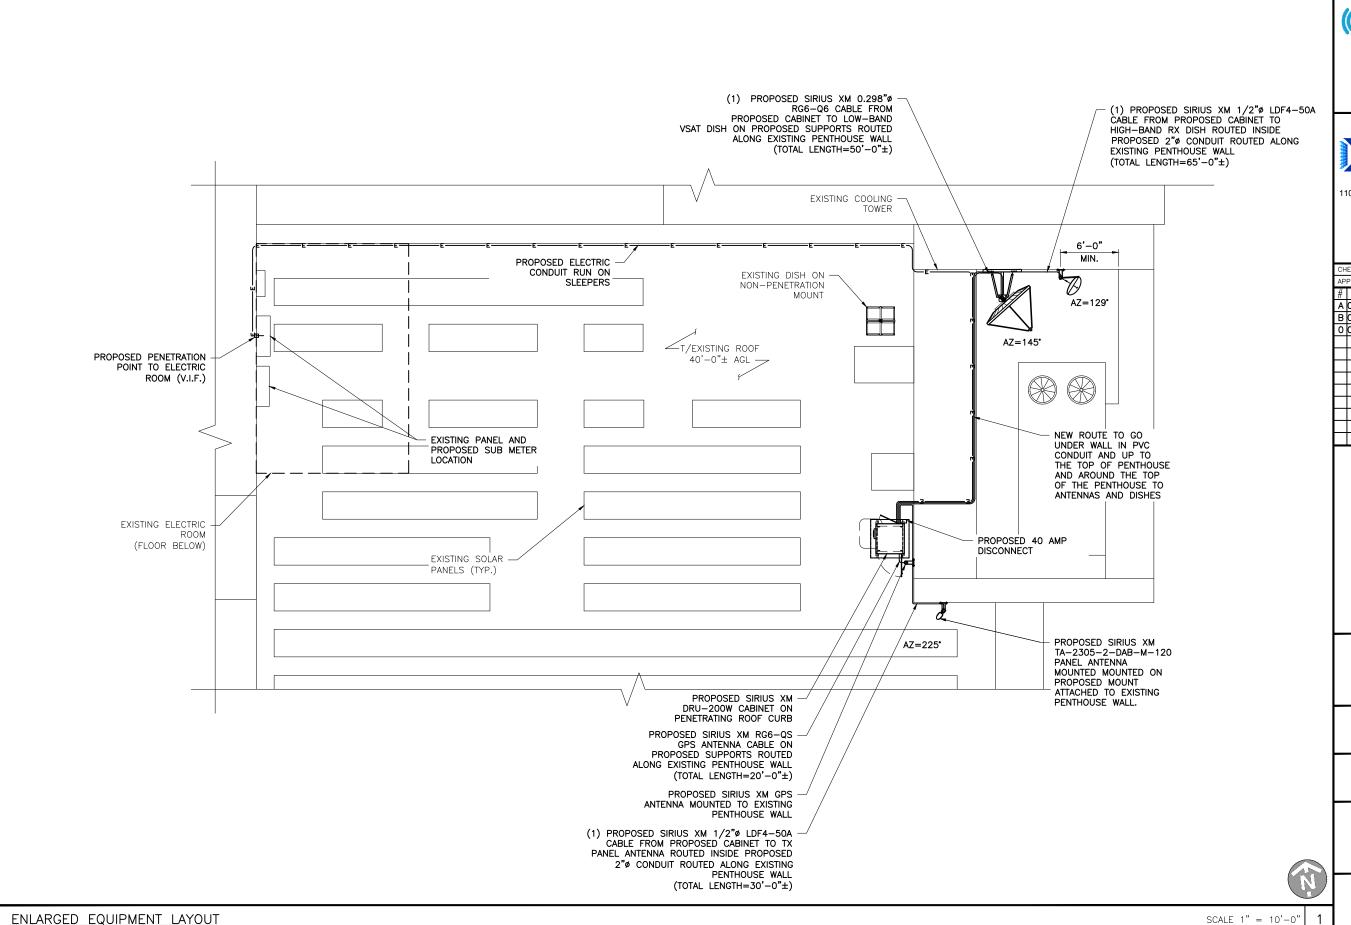
3921 FABIAN WAY PALO ALTO, CA 94303

PROPOSED ENLARGED ROOF PLAN

SHEET NUMBER

C-1.2

PROPOSED ENLARGED ROOF PLAN SCALE: 1" = 20'-0"



((Sirius XM))

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SITE NAME

TAUBE KORET
CAMPUS

SITE I.D.

SFX631B


SITE ADDRESS

3921 FABIAN WAY PALO ALTO, CA 94303

SHEET NAME
ENLARGED
EQUIPMENT
LAYOUT

SHEET NUMBER

C-2.0

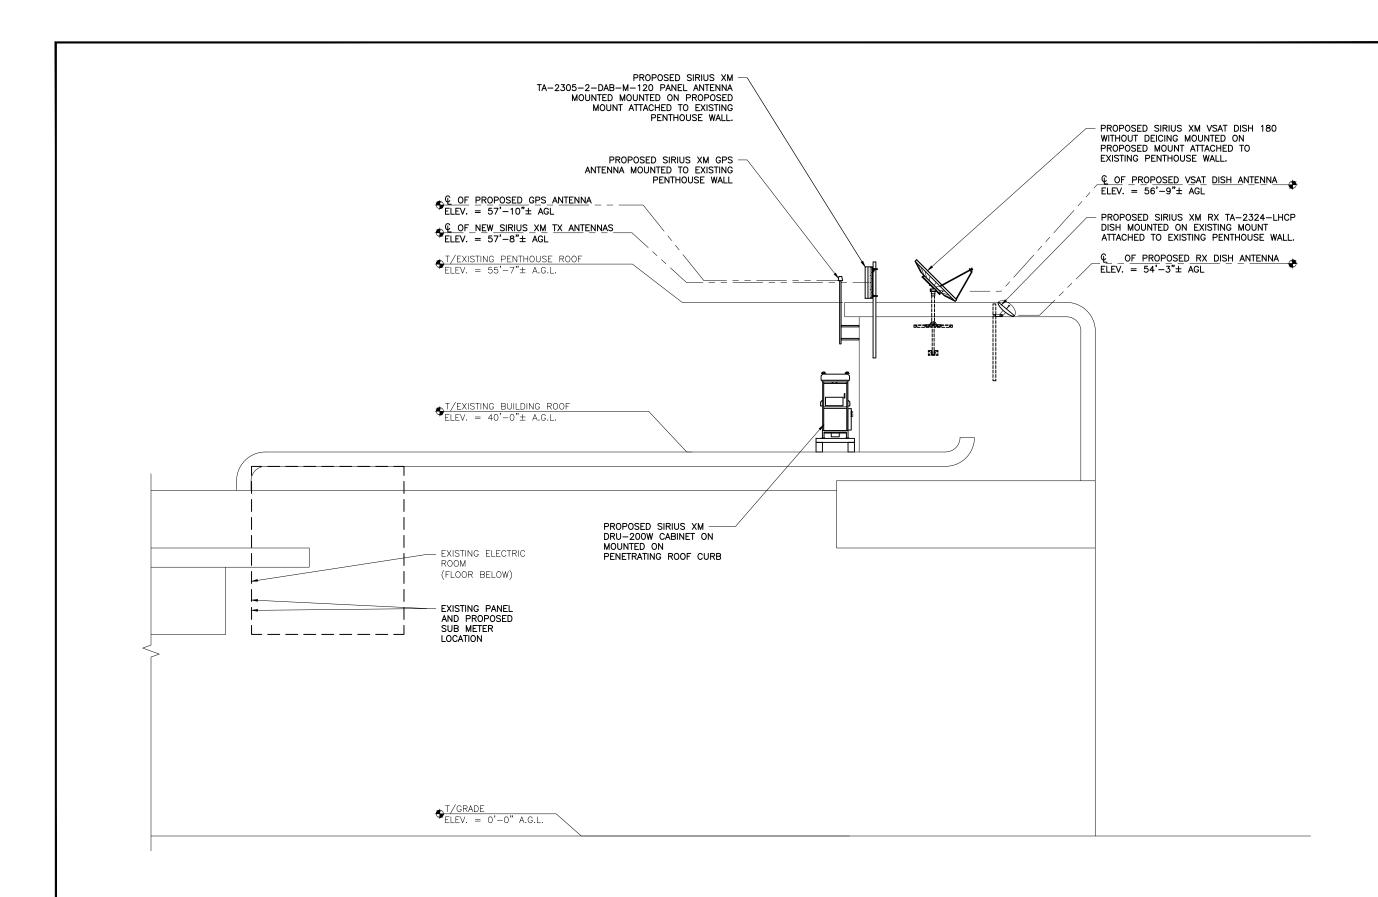





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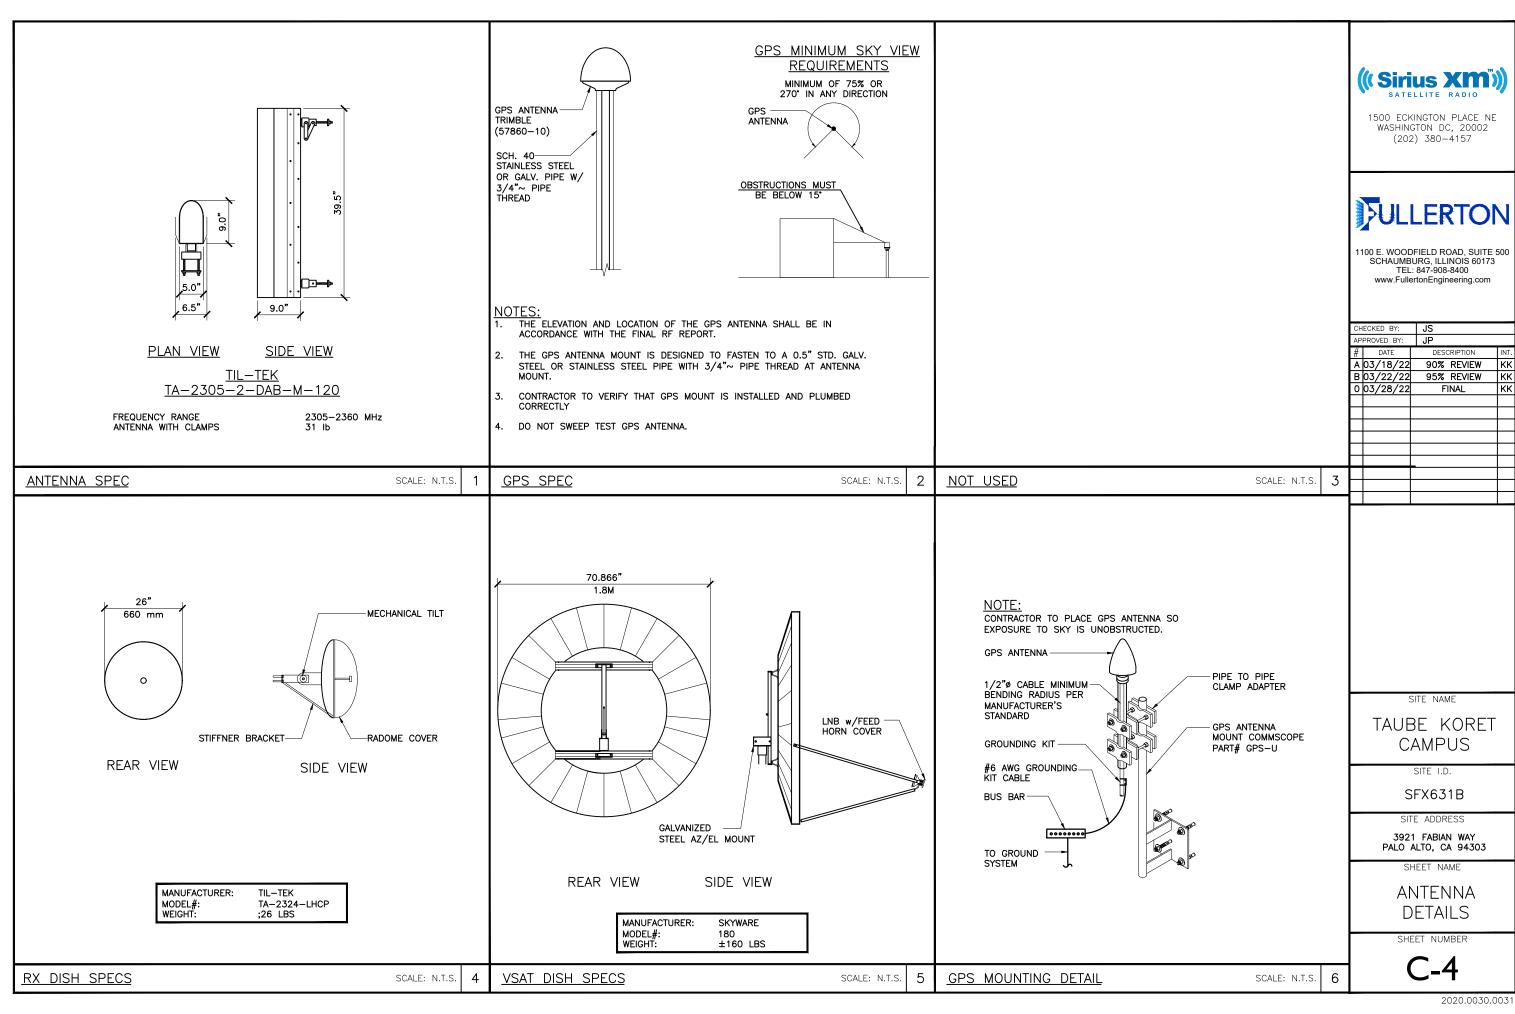
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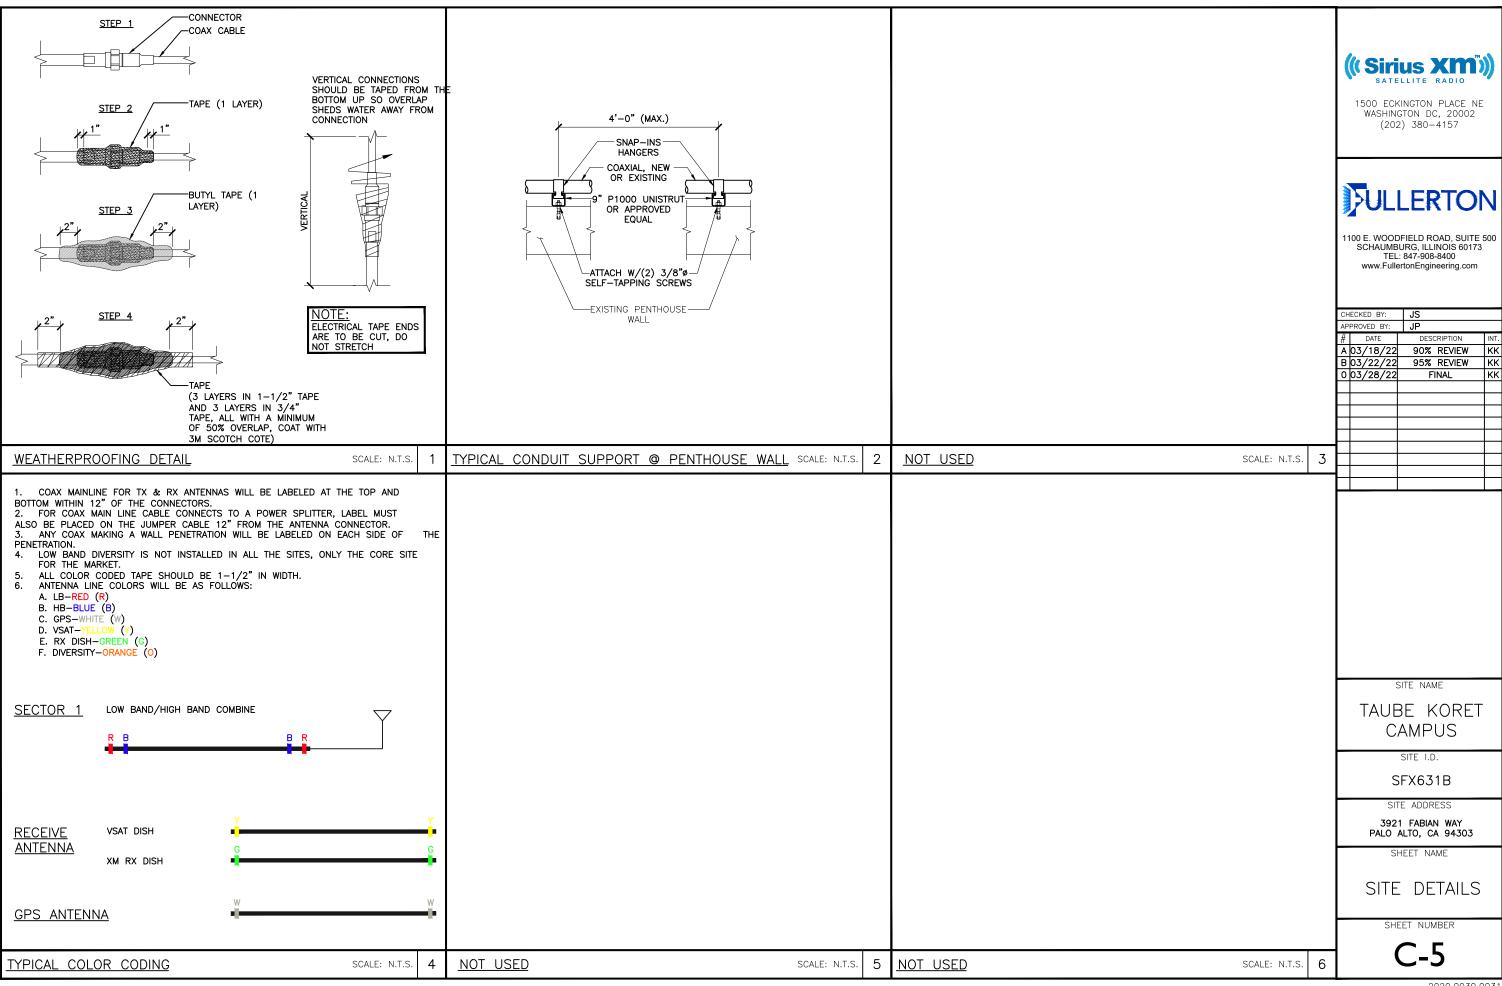
SITE ELEVATION

SHEET NUMBER


C-3


SOUTH ELEVATION





				NEW A	NTENNA	CONFIGU	 JRATION					1
			ANTE						C	ABLE		
ANTENNA NUMBER	NEW OR EXISTING	ANTENNA MANUFACTURER	ANTENNA TYPE	MODEL NUMBER	AZIMUTH (TN)	TILT (+ OR -	© OF ANTENNA FROM) GROUND LEVEL (FT)	NEW OR EXISTING	CABLE TYPE	CABLE SIZE (DIA. IN)	CABLE LENGTH (FT)	((Sirius XM))
1	NEW	TIL-TEK	PANEL	TA-2305-2-DAB-M-120	225°	0°	57'-8"	NEW	LDF4-50A	0.5"	35'	1500 ECKINGTON PLACE NE
2	NEW	SKYWARE	VSAT DISH	180 W/O DEICING	145°	+40*	56'-9"	NEW	RG6-QS	0.298"	50'	WASHINGTON DC, 20002 (202) 380-4157
3	NEW	TIL-TEK	RX DISH	TA-2324-LHCP	129°	+32*	54'-3"	NEW	LDF4-50A	0.5"	65'	
4	NEW	TRIMBLE	GPS	57860-10	N/A	N/A	57'–10"	NEW	RG6-QS	0.298"	20'	
				NEW	EQUIPME	NT SCH	EDULE		•			ULLERTON
CABINET NUMBER	CABINET MANUFACTURE	CABINET R TYPE	MODEL NUMBER	NOTES								1100 E. WOODFIELD ROAD, SUITE 500 SCHAUMBURG, ILLINOIS 60173
1	UBS	REPEATER	DRU-200W	PROPOSED								TEL: 847-908-8400 www.FullertonEngineering.com
				NEV	V POWER	R SCHED	ULE					
AMPERE	VOLTAGE	PHASE	NOTES									CHECKED BY: JS
40 AMPS	120/208V	SINGLE	DISTRIBUTION PANEL	SUBMETERED TO AN EMON D	MON LOCATED IN	ELECTRIC ROO	М					APPROVED BY: JP # DATE DESCRIPTION INT.
												A 03/18/22 90% REVIEW KK B 03/22/22 95% REVIEW KK
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												SITE NAME
												TAUBE KORET CAMPUS
												SITE I.D.
												SFX631B
												SITE ADDRESS
												3921 FABIAN WAY PALO ALTO, CA 94303
												SHEET NAME
												ANTENNA
												SCHEDULES
												SHEET NUMBER
												C-6
												2020.0030.0031

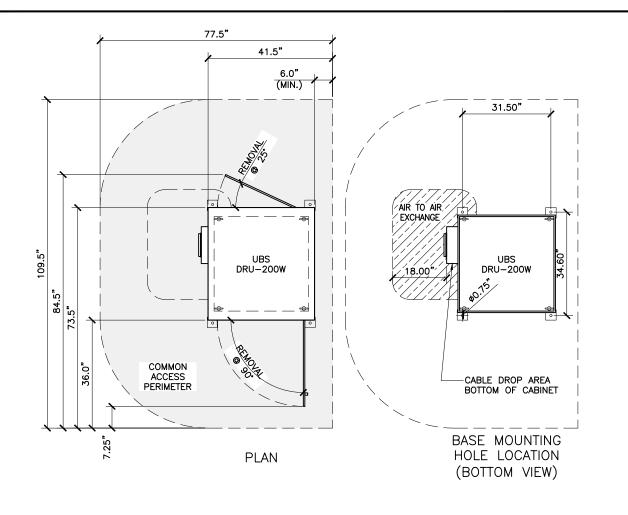

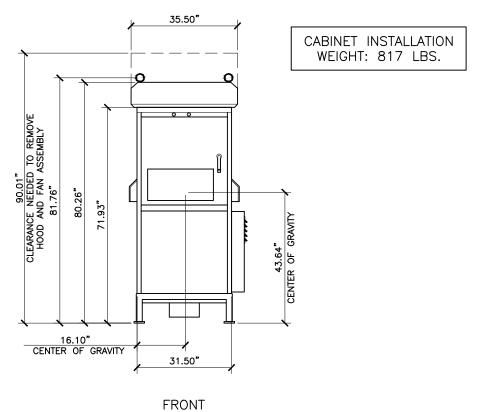





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SITE ADDRESS

3921 FABIAN WAY PALO ALTO, CA 94303

SHEET NAME

EQUIPMENT SPECS

SHEET NUMBER

C-7

UBS DRU-200W CABINET DETAIL

SCALE: 3/8" = 1'-0"

- SERVICE EQUIPMENT NOTES:

 1. ALL ELECTRICAL EQUIPMENT SHALL BE LABELED WITH PERMANENT ENGRAVED PLASTIC LABELS
- 2. PATCH, REPAIR AND PAINT ANY AREA THAT HAS BEEN DAMAGED IN THE COURSE OF THE ELECTRICAL WORK

CONDUCTOR NOTES:

- 1. ALL CONDUCTORS SHALL BE COPPER
- 2. ALL WIRING SHALL BE COPPER WITH THHN/THWN DUAL RATED 600 VOLTS INSULATION
- 3. GROUNDING CONDUCTORS SHALL BE SOLID TINNED COPPER UNLESS OTHERWISE NOTED

CONDUIT NOTES:

- 1. SCH 80 PVC CONDUIT SHALL BE USED WHEN INSTALLED IN OR UNDER CONCRETE SLABS, IN CONTACT WITH EARTH, OR EXPOSED ABOVE GRADE
- 2. EMT SHALL BE USED ONLY FOR INTERIOR RUNS AND SHALL HAVE COMPRESSION TYPE FITTINGS
- 3. SEAL TIGHT, FLEXIBLE CONDUIT MAY BE USED WHERE CODE PERMITS. ALL CONDUIT SHALL HAVE FULL SIZE EQUIPMENT GROUND WIRE
- 4. SERVICE CONDUITS SHALL HAVE NO MORE THAN (3) -90° BENDS IN ANY SINGLE RUN. THE CONTRACTOR SHALL PROVIDE PULL BOXES AS NEEDED WHERE CONDUIT REQUIREMENTS EXCEED THESE CONDITIONS
- 5. ALL CABLES, POWER AND/OR TELEPHONE AND/OR FIBER SYSTEM CONDUITS SHALL HAVE A MINIMUM 24" RADIUS SWEEPS TO EQUIPMENT, PULL BOXES, ETC., UNLESS OTHERWISE NOTED, OR AS REQUIRED BY UTILITY

NEW CABLE GROUNDING NOTES:

- 1. AVOID DISRUPTION OF EXISTING GROUNDING SYSTEM. REPAIR ANY DAMAGE TO THE SATISFACTION OF THE OWNER
- 2. CONTRACTOR SHALL CONNECT GROUND KITS TO THE EXISTING GROUND BARS AT THE TOP AND BASE OF TOWER
- 3. CONTRACTOR SHALL CONNECT GROUND KITS TO THE NEW GROUND BAR BEFORE ENTRY TO CARINET
- 4. NO BACK TO BACK LUGGING OF GROUNDS

GENERAL GROUNDING NOTES:

- 1. VERTICAL DROPS SHALL BE 20'-0" OF #2 AWG SOLID TINNED COPPER WIRE. CADWELD TO GROUND BAR
- 2. ALL BENDS MINIMUM 8" RADIUS
- 3. APPLY ANTI-OXIDATION COMPOUND TO ALL CONNECTIONS
- 4. BARE COPPER CONDUCTORS SHALL NOT BE IN CONTACT WITH ANY DISSIMILAR MATERIAL. PLACE ON STANDOFFS, IF NECESSARY TO ALLOW FOR PROPER INSTALLATION
- 5. SHARP BENDS IN GROUNDING CONDUCTORS SHALL BE AVOIDED. 90° BENDS
- 6. ALL GROUNDING CONDUCTORS SHALL BE KEPT AS SHORT AS POSSIBLE. THE SHORTEST PRACTICAL ROUTE SHALL BE CHOSEN WITH THE LEAST AMOUNT OF BENDS AND SPLICES. USE THIS RULE AT ALL TIMES
- 7. ALL CONNECTIONS TO GROUND BARS SHALL BE WITH A 2-HOLE LUG UNLESS OTHERWISE SPECIFIED
- 8. WHEN GROUNDING MORE THAN ONE PIECE OF EQUIPMENT, DO NOT USE THE EQUIPMENT AS A GROUNDING CONDUCTOR. DOUBLE—STACKING OF LUGS SHALL BE USED TO GET FROM EQUIPMENT TO EQUIPMENT
- 9. REMOVE ALL PAINT BENEATH THE SURFACE OF GROUND LUGS




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CHECKED BY: JS **ELECTRICAL NOTES** APPROVED BY: I.IP SCALE: N.T.S. A 03/18/22 90% REVIEW KK B 03/22/22 95% REVIEW 0 03/28/22 FINAL EXISTING COOLING -TOWER PROPOSED ELECTRIC EXISTING DISH ON CONDUIT RUN ON NON-PENETRATION SLEEPERS MOUNT AZ=129° AZ=145° T/EXISTING ROOF 40'-0"± AGL -PROPOSED PENETRATION -MAIN GROUND POINT TO ELECTRIC CONNECTION POINT ROOM (V.I.F.) NEW ROUTE TO GO UNDER WALL IN PVC EXISTING PANEL AND PROPOSED SUB METER CONDUIT AND UP TO LOCATION THE TOP OF PENTHOUSE AND AROUND THE TOP OF THE PENTHOUSE TO SITE NAME ANTENNAS AND DISHES TAUBE KORET EXISTING ELECTRIC ROOM CAMPUS PROPOSED 40 AMP (FLOOR BELOW) DISCONNECT EXISTING SOLAR SITE I.D. PANELS (TYP.) SFX631B PROPOSED SIRIUS XM DRU-200W CABINET ON PENETRATING ROOF CURB SITE ADDRESS 3921 FABIAN WAY PALO ALTO, CA 94303 PROPOSED SIRIUS XM AZ=225° PROPOSED SIRIUS XM GPS TA-2305-2-DAB-M-120 SHEET NAME ANTENNA MOUNTED TO EXISTING PANEL ANTENNA PENTHOUSE WALL MOUNTED MOUNTED ON PROPOSED MOUNT ENLARGED ATTACHED TO EXISTING UTILITY PLANS PENTHOUSE WALL. SHEET NUMBER 2 NOT USED SCALE 1" = 10'-0"



CONDUCTOR NOTES:

- 1. ALL CONDUCTORS SHALL BE COPPER
- 2. GROUNDING CONDUCTORS SHALL BE SOLID TINNED COPPER UNLESS OTHERWISE NOTED.

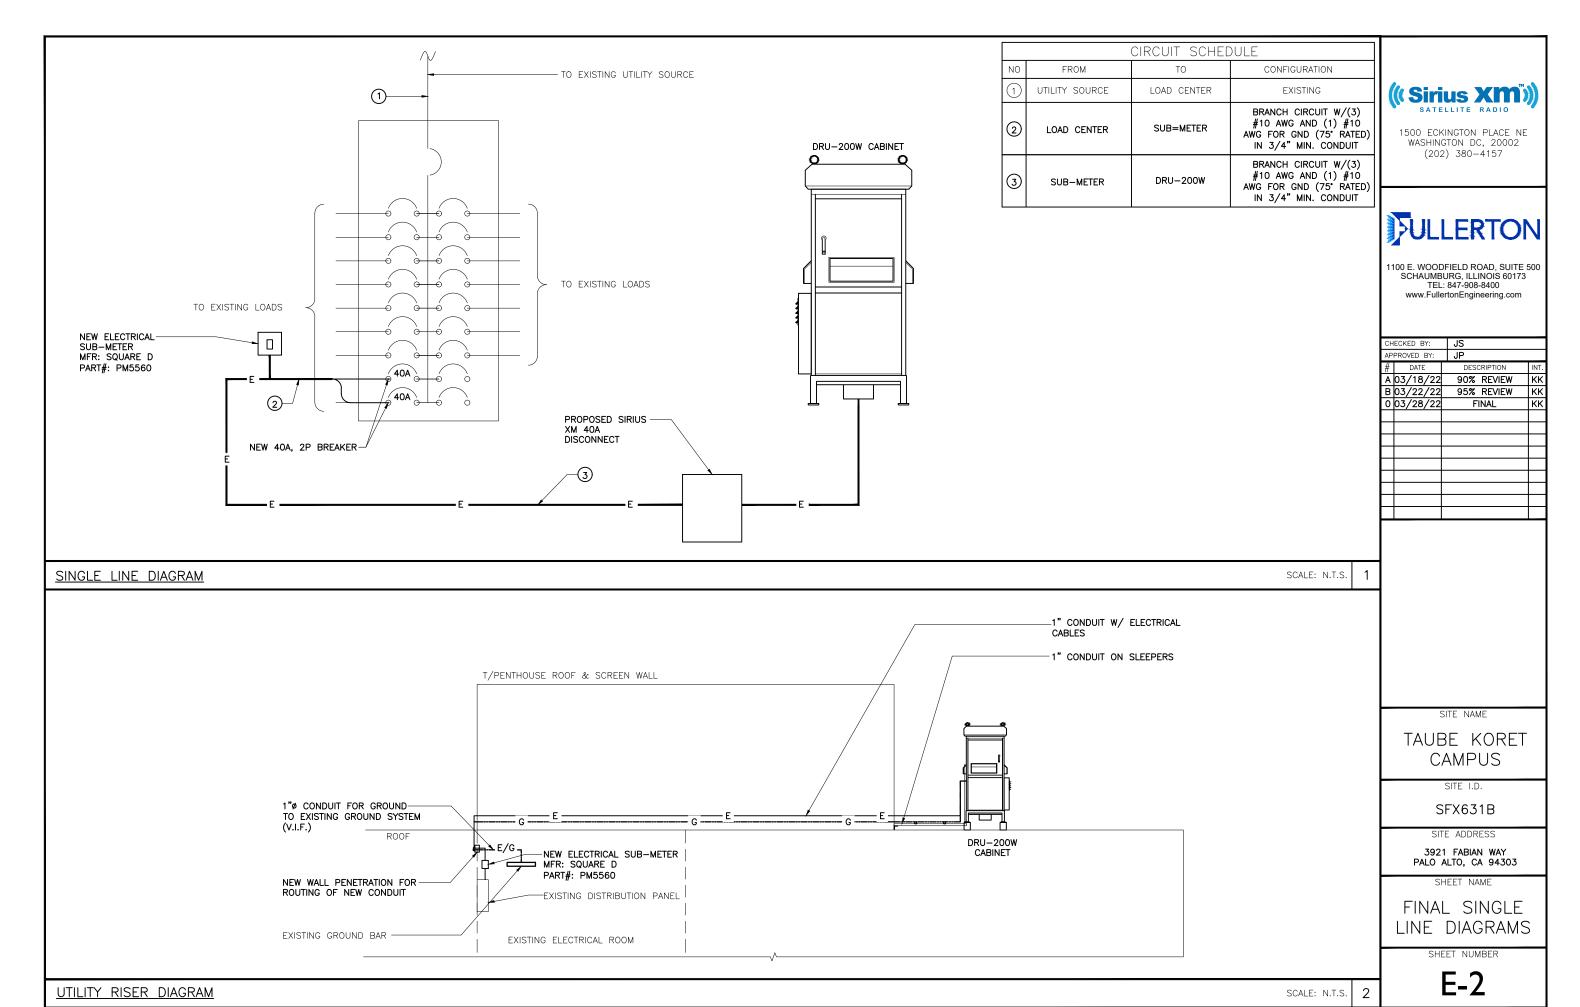
- NEW CABLE GROUNDING NOTES:

 1. AVOID DISRUPTION OF EXISTING GROUNDING SYSTEM. REPAIR ANY DAMAGE TO THE SATISFACTION OF THE OWNER
- CONTRACTOR SHALL CONNECT GROUND KITS TO THE EXISTING GROUND BARS AT THE TOP AND BASE OF TOWER
- CONTRACTOR SHALL CONNECT GROUND KITS TO THE NEW GROUND BAR BEFORE ENTRY TO CABINET
- 4. NO BACK TO BACK LUGGING OF GROUNDS

GENERAL GROUNDING NOTES:


- 1. VERTICAL DROPS SHALL BE 20'-0" OF #2 AWG SOLID TINNED COPPER WIRE. CADWELD TO GROUND BAR.
- 2. ALL BENDS MINIMUM 8" RADIUS.
- 3. APPLY ANTI-OXIDATION COMPOUND TO ALL CONNECTIONS.
- BARE COPPER CONDUCTORS SHALL NOT BE IN CONTACT WITH ANY DISSIMILIAR MATERIAL. PLACE ON STANDOFFS, IF NECESSARY TO ALLOW FOR PROPER INSTALLATION.
- SHARP BENDS IN GROUNDING CONDUCTORS SHALL BE AVOIDED. 90° BENDS SHALL NOT BE USED.
- ALL GROUNDING CONDUCTORS SHALL BE KEPT AS SHORT AS POSSIBLE. THE SHORTEST PRACTICAL ROUTE SHALL BE CHOSEN WITH THE LEAST AMOUNT OF BENDS AND SPLICES. USE THIS RULE AT ALL TIMES.
- ALL CONNECTIONS TO GROUND BARS SHALL BE WITH A 2-HOLE LUG UNLESS OTHERWISE SPECIFIED.
- WHEN GROUNDING MORE THAN ONE PIECE OF EQUIPMENT, DO NOT USE THE EQUIPMENT AS A GROUNDING CONDUCTOR. DOUBLE-STACKING OF LUGS SHALL BE USED TO GET FROM EQUIPMENT TO EQUIPMENT.
- 9. REMOVE ALL PAINT BENEATH THE SURFACE OF GROUND
- 10. GROUND SYSTEM TO BE TESTED TO 5 OHMS OR LESS

NOTES

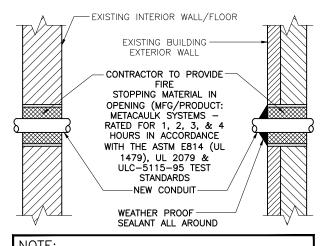

NOTE:

WHEN CORING INTO EXISTING WALL / FLOOR, CONTRACTOR TO REPAIR ALL OPENING TO EXISTING CONDITION, AND MAINTAIN ALL EXISTING FIRE RATINGS.

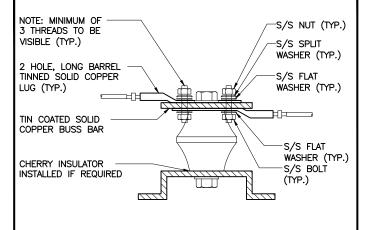


GROUND LUG DETAIL

2

SCALE: N.T.S.

- ALL HARDWARE 18-8 STAINLESS STEEL INCLUDING SPLIT WASHERS.
- COAT WIRE END WITH ANTI-OXIDATION COMPOUND PRIOR TO INSERTION INTO LUG BARREL AND CRIMPING.
- APPLY ANTI-OXIDATION COMPOUND BETWEEN ALL LUGS AND BUSS BARS PRIOR TO MATING AND BOLTING.

SCALE: N.T.S.

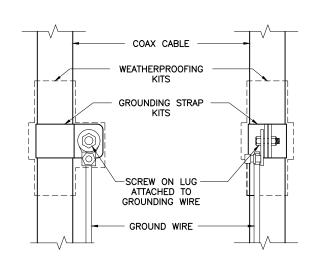

(((Sirius XM)))

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-	AP	PROVED BY:	JP					
-	#	DATE	DESCRIPTION	INT.				
-	Α	03/18/22	90% REVIEW	KK				
	В	03/22/22	95% REVIEW	KK				
	0	03/28/22	FINAL	KK				
1								

COAX GROUND KIT

DO NOT INSTALL CABLE GROUND KIT AT A BEND AND ALWAYS DIRECT GROUND WIRE DOWN TO GROUND BAR.

SCALE: N.T.S.

#6 AWG STRANDED INSULATED GND

> COLLECTION GROUND BAR (AS

REQUIRED)

SCALE: N.T.S.

THIS DETAILS IS TYPICAL FOR EACH CABLE WHERE IT IS SPECIFIED TO BE GROUNDED

ALL NEW GROUND BARS SHALL BE TIED TO (E) GROUND RING OR TO (F) GROUND BARS

WALL PENETRATION


MECHANICAL CONNECTION EXOTHERMIC CONNECTION

GROUND EACH CABINET FROM GROUND BAR INSIDE CABINET TO MASTER GROUND BAR. INSTALL GROMMET AT BOTTOM OF CABINET, 2 HOLE LUG.

GND WIRE (TYP.)

SCALE: N.T.S.

FINAL SINGLE LINE GROUNDING DIAGRAM

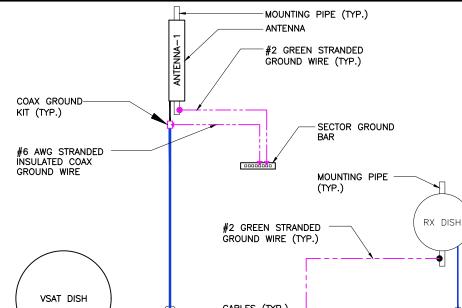

TYP.)

SITE NAME

TAUBE KORET **CAMPUS**

SITE I.D.


SFX631B SITE ADDRESS

3921 FABIAN WAY PALO ALTO, CA 94303

SHEET NAME GROUNDING DETAILS AND NOTES

SHEET NUMBER

5

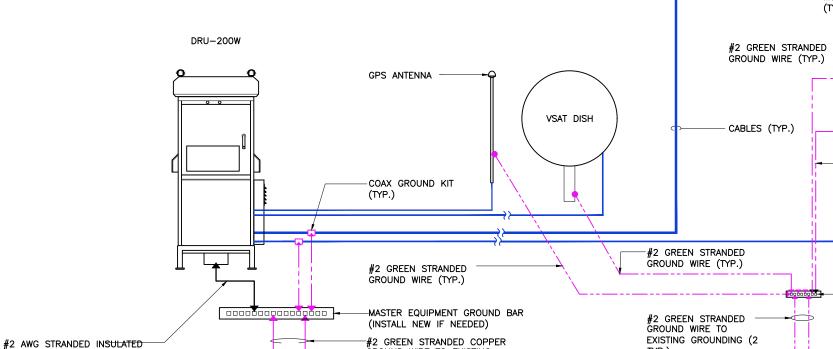

GROUND WIRE TO EXISTING

GROUNDING (2 TYP.)





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Ä 03/18/22 90% REVIEW KK B 03/22/22 95% REVIEW KK 0 03/28/22 FINAL KK

CHECKED BY: JS

APPROVED BY: JP

		ITEM #	DESCRIPTION	SIZE	QUANTITY	LENGTH	MANUFACTURER	PART NUMBER	REMARKS	PROVIDED BY
		1	HB RX DISH (2320-2345 MHz)	25.25"	1 NEW	N/A	TIL-TEK	TA-2324-LHCP	CIRCULAR POLARIZED SOLID PARABOLIC DISH ANTENNA	SIRIUS XM
		2	7-16 DIN MALE CONNECTOR	N/A	1 NEW	N/A	COMMSCOPE	L4TDM-PSA	ATTACH TO CABLE PRIOR TO INSTALLATION	VENDOR
		3	GROUNDING KIT	N/A	1 NEW	N/A	COMMSCOPE	SG12-06B2A	INCLUDES 59" #6 GROUND WIRE, INSTALL 1 KIT EVERY 100 FT. MIN.	VENDOR
		4	COAXIAL CABLE	1/2"	1 NEW	65'	COMMSCOPE	LDF4-50	MINIMUM BEND RADIUS PER MANUFACTURER SPECS	VENDOR
		<u> </u>	GROUNDING KIT	1/2"	1 NEW	N/A	COMMSCOPE	SG12-06B2A	INCLUDES 59" #6 GROUND WIRE, INSTALL 1 KIT EVERY 100 FT. MIN.	VENDOR
		<u> </u>	N MALE CONNECTOR	N/A	1 NEW	N/A	COMMSCOPE	L4TNM-PSA	_	VENDOR
			CABINET	N/A	1 NEW	N/A	UBS	DRU-200W	-	SIRIUS XM
Į.										

SITE NAME

TAUBE KORET CAMPUS

SITE I.D.

SFX631B

SITE ADDRESS

3921 FABIAN WAY PALO ALTO, CA 94303

SHEET NAME
SITE
CONFIGURATIONS
MATERIAL LIST


SHEET NUMBER

E-4

RX ANTENNA CONFIGURATION

SCALE: N.T.S. 1

LAID DADT WASOZA DV	ITEM #	DESCRIPTION	SIZE	QUANTITY	LENGTH	MANUFACTURER	PART NUMBER	REMARKS	PROVIDED BY	
LNB PART #4507A BY NORSAT F-FEMALE CONNECTOR	—— 1	VSAT DISH	1.8M	1 NEW	N/A	SKYWARE	180 W/O DEICING	SKYWARE VSAT DISH ANTENNA	VENDOR	((Sirius XM))) 1500 ECKINGTON PLACE NE WASHINGTON DC, 20002 (202) 380-4157
	— 2	LNB	N/A	1 NEW	N/A	NORSAT	4507A	_	VENDOR	TULLERTON 1100 E. WOODFIELD ROAD, SUITE 500
	3	F-MALE CONNECTOR	N/A	1 NEW	N/A	THOMAS AND BETTS	SNS1P6QS	_	VENDOR	SCHAUMBURG, ILLINOIS 60173 TEL: 847-908-8400 www.FullertonEngineering.com CHECKED BY: JS APPROVED BY: JP # DATE DESCRIPTION INT
-	— 4	COAX CABLE	0.298"	1 NEW	50'	BELDEN	RG6-SQ	_	VENDOR	# DATE DESCRIPTION INT A 03/18/22 90% REVIEW KK B 03/22/22 95% REVIEW KK 0 03/28/22 FINAL KK
	─ 5	F-MALE CONNECTOR	N/A	1 NEW	N/A	THOMAS AND BETTS	SNS1P6QS	_	VENDOR	
	— 6	CABINET	N/A	1 NEW	N/A	UBS	DRU-200W	_	SIRIUS XM	
VSAT ANTENNA CONFIGURATION									SCALE: N.T.S. 1	
	ITEM #	DESCRIPTION	SIZE	QUANTITY	LENGTH	MANUFACTURER	PART NUMBER	REMARKS	PROVIDED BY	SITE NAME
	<u> </u>	GPS ANTENNA	N/A	1 NEW	N/A	TRIMBLE	57860-10	_	SIRIUS XM	TAUBE KORET CAMPUS
	- 2	F CONNECTOR	N/A	1 NEW	N/A	THOMAS AND BETTS	SNS1P6QS	_	VENDOR	SITE I.D SFX631B
	<u> </u>	COAX CABLE	0.298"	1 NEW	20'	BELDEN	RG6-SQ	_	VENDOR	SITE ADDRESS
	4	F CONNECTOR	N/A	1 NEW	N/A	THOMAS AND BETTS	SNS1P6QS	_	VENDOR	3921 FABIAN WAY PALO ALTO, CA 94303 SHEET NAME
	─ 5	F TO N CONNECTOR	N/A	1 NEW	N/A	EMERSON	26-8020	_	SIRIUS XM	SITE CONFIGURATIONS MATERIAL LIST
	 6	CABINET	N/A	1 NEW	N/A	UBS	DRU-200W	-	SIRIUS XM	SHEET NUMBER E-5
GPS ANTENNA CONFIGURATION									SCALE: N.T.S. 2	2020.0030.003

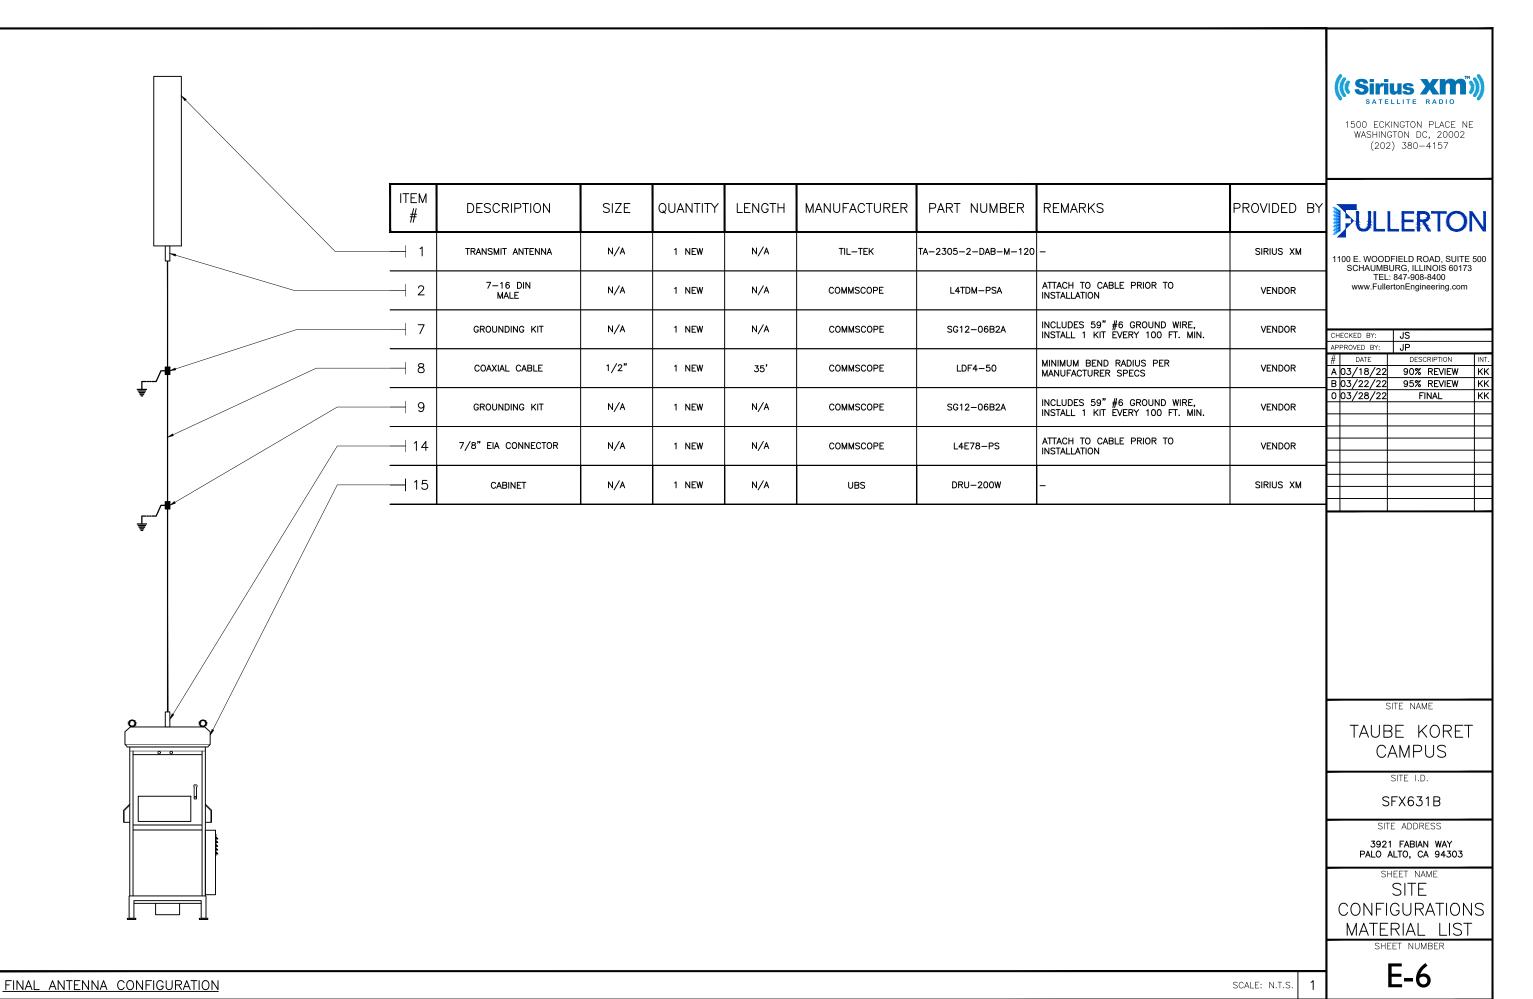

STRUCTURAL NOTES:

2019 CALIFORNIA BUILDING CODE ACI 318-14 BUILDING CODE REQUIREMENT FOR STRUCTURAL CONCRETE ASCE 7-16 MINIMUM DESIGN LOADS AND ASSOCIATED CRITERIA FOR BUILDINGS

DESIGN CRITERIA:

DEAD LOADS: SEE PLANS FOR EQUIPMENT WEIGHT

ASCE 7-16 DESIGN CATEGORIES

RISK CATEGORY IV

WIND LOAD 92 MPH (BASIC DESIGN WIND SPEED)

RISK CATEGORY

SEISMIC DESIGN CRITERIA

 $S_S = 1.538$ Sds = 1.23 $F_0 = 1.2$ SI = 0.60SdI = 0.68 $F_V = 1.7$ SmI = 1.02Sms = 1.845 TL = 12 secSOIL SITE CLASS D - DEFAULT (ASSUMED) SEISMIC IMPORTANCE FACTOR 1.0 SEISMIC DESIGN CATEGORY

SEISMIC DEMAND NON STRUCTURAL COMPONENTS (ASCE 13.3) ap = 2.5

 $R_{p} = 6.0$ $I_{p} = 1.5$ \dot{W}_{p} = SEE PLANS z/h = 1.0

omega sub 0 = 2.0 (OVERSTRENGTH FACTOR)

MANDATORY SUBMITALS AND INSPECTIONS:

POST- INSTALLED ANCHORS IN CONCRETE (CBC 1901.3.4)

STEEL BOLTING

GENERAL NOTES

- THE CONTRACTOR SHALL BE RESPONSIBLE FOR FOLLOWING ALL LAWS, REGULATIONS, AND RULES SET FORTH BY FEDERAL, STATE, AND LOCAL AUTHORITIES WITH JURISDICTION OVER THE PROJECT. THIS RESPONSIBILITY IS IN EFFECT REGARDLESS OF WHETHER THE LAW, ORDINANCE, REGULATION OR RULE IS MENTIONED IN THESE SPECIFICATIONS.
- 2. ALL WORK SHALL BE COMPLETED AS INDICATED ON THE DRAWINGS, PROJECT SPECIFICATIONS, AND THE CONSTRUCTION CONTRACT DOCUMENTS.
- THE CONTRACTOR SHALL HAVE AND MAINTAIN A VALID CONTRACTOR'S LICENSE FOR THE LOCATION IN WHICH THE WORK IS TO BE PERFORMED. FOR JURISDICTIONS THAT LICENSE INDIVIDUAL TRADES, THE TRADESMAN OR SUBCONTRACTOR PERFORMING THOSE TRADES SHALL BE LICENSED.
- FOLLOW ALL APPLICABLE RULES AND REGULATIONS OF THE OCCUPATIONAL SAFETY AND HEALTH ADMINISTRATION (OSHA) AND STATE LAW AS DEFINED IN THE FEDERAL OCCUPATIONAL SAFETY AND HEALTH ACT.
- PRIOR TO THE SUBMISSION OF THE BID, THE CONTRACTOR SHALL VISIT THE JOB SITE, VERIFY ALL DIMENSIONS AND BECOME FAMILIAR WITH THE FIELD CONDITIONS, ANY DISCREPANCIES SHALL BE BROUGHT TO THE ATTENTION OF
- DRAWING PLANS SHALL NOT BE SCALED.
- THE CONTRACTOR SHALL NOT PROCEED WITH ANY WORK NOT CLEARLY IDENTIFIED ON THE DRAWINGS WITHOUT THE PRIOR WRITTEN APPROVAL OF THE
- THE CONTRACTOR SHALL INSTALL ALL EQUIPMENT AND MATERIALS IN ACCORDANCE WITH MANUFACTURER RECOMMENDATIONS UNLESS SPECIFICALLY OTHERWISE NOTED.
- ALL MEANS AND METHODS OF CONSTRUCTION DEALING WITH TOWER CONSTRUCTION AND SAFETY, STEEL ERECTION, EXCAVATIONS, TRENCHING, SCAFFOLDING, FORMWORK, ÉLECTRICAL, AND WORK IN CONFINED SPACES ARE THE SOLE RESPONSIBILITY OF THE CONTRACTOR.
- 10. THE CONTRACTOR SHALL BE RESPONSIBLE FOR INITIATING, MAINTAINING, AND SUPERVISING ALL SAFETY PRECAUTIONS AND PROGRAMS IN CONNECTION WITH
- 11. THE CONTRACTOR SHALL BE EXPERIENCED IN THE PERFORMANCE OF WORK SIMILAR TO THAT DESCRIBED HEREIN. BY ACCEPTANCE OF THIS ASSIGNMENT, THE CONTRACTOR IS ATTESTING THAT HE DOES HAVE SUFFICIENT EXPERIENCE AND ABILITY AND THAT HE IS KNOWLEDGEABLE OF THE WORK TO BE
- 12. THE CONTRACTOR SHALL PROVIDE SUFFICIENT TEMPORARY BRACING AND/OR SHORING OF ALL STRUCTURAL AND NON-STRUCTURAL ELEMENTS DURING CONSTRUCTION UNTIL ALL STRUCTURAL ELEMENTS HAVE BEEN PROPERLY INSTALLED.
- 13. INCORRECTLY FABRICATED, DAMAGED, OR OTHERWISE MISFITTING OR NONCONFORMING MATERIALS SHALL BE REPORTED TO THE PROJECT MANAGER AND ENGINEER, AND SHALL REQUIRE APPROVAL PRIOR TO PERFORMING ANY REMEDIAL OR CORRECTIVE ACTION.

STRUCTURAL STEEL NOTES:

- STRUCTURAL STEEL MATERIALS CONFORM TO THE LATEST EDITION OF APPLICABLE STANDARDS AND TO ALL APPLICABLE CODES AND REQUIREMENTS OF LOCAL AUTHORITIES HAVING JURISDICTION, WHICHEVER IS MORE STRINGENT. ALL STRUCTURAL STEEL SHALL BE IN ACCORDANCE WITH THE LATEST APPLICABLE REQUIREMENTS OF AISC, ASTM, ACI, CRSI, AWS AND ALL OTHER APPLICABLE STANDARDS
- ALL STEEL SHALL BE GALVANIZED IN ACCORDANCE WITH ASTM A123 UNLESS NOTED ON THE CONSTRUCTION DRAWINGS.
- ROLLED STEEL SHAPES, PLATES AND BARS SHALL BE NO LESS THAN 3/16 INCHES IN THICKNESS AND SHALL COMPLY WITH ASTM A-36 AS A MINIMUM.
- STEEL PIPE SHALL COMPLY WITH ASTM A-501 OR ASTM A-53, TYPE E OR S, GRADE B. A-500 GRADE B STEEL MAY BE SUBSTITUTED.
- GALVANIZED STEEL GRATING SHALL BE A MINIMUM 1-1/4 INCH X 1/8 INCH AT 3/16 INCHES ON CENTER.
- COLD FORMED CHANNELS, C'S AND Z'S USED AS GIRTS SHALL CONFORM TO THE REQUIREMENTS OF ASTM STANDARD A607 GRADE 50.
- - A. CONTRACTOR SHALL PROVIDE ALL HARDWARE REQUIRED TO COMPLETE FIELD ERECTION OF STRUCTURE AS INDICATED BY CONTRACT DOCUMENTS OR THESE SPECIFICATIONS.
 - HIGH STRENGTH THREADED FASTENERS SHALL BE INSTALLED IN ACCORDANCE WITH AISC SPECIFICATIONS FOR STRUCTURAL JOINTS USING ASTM A-325 BOLTS. USE A-325N BEARING-TYPE CONNECTION BOLTS UNLESS NOTED OTHERWISE.
 - GRATING AND PLATES SHALL BE FASTENED WITH SADDLE CLIPS. THE NECESSARY HOLES TO COMPLETE ALL PHASES OF CONSTRUCTION SHALL BE PROVIDED AND CALLED OUT ON THE APPROVED SHOP DRAWINGS. ALL HOLES SHALL BE DRILLED OR PUNCHED PERPENDICULAR TO METAL SURFACES, FLAME CUT OR BURNED HOLES WILL NOT BE PERMITTED.
 - D. ALL UNFINISHED THREADED FASTENERS SHALL COMPLY WITH ASTM A-307, GRADE A, REGULAR LOW-CARBON STEEL BOLTS AND NUTS WITH HEXAGONAL HEADS.
 - ALL HIGH STRENGTH THREADED FASTENERS SHALL BE HEAVY HEXAGONAL BOLTS AND NUTS WITH HARDENED WASHERS, ALL FROM QUENCHED AND TEMPERED MEDIUM CARBON STEEL COMPLYING WITH



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СН	ECKED BY:	JS			
ΑP	PROVED BY:	JP			
#	DATE	DESCRIPTION	INT.		
Α	03/18/22	90% REVIEW	ΚK		
В	03/22/22	95% REVIEW	кк		
0	03/28/22	FINAL	кк		
	АР # А В	CHECKED BY: APPROVED BY: # DATE A 03/18/22 B 03/22/22 0 03/28/22	APPROVED BY: JP # DATE DESCRIPTION A 03/18/22 90% REVIEW B 03/22/22 95% REVIEW		

SITE NAME

TAUBE KORET CAMPUS

SITE I.D.


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SITE ADDRESS 3921 FABIAN WAY PALO ALTO, CA 94303

SHEET NAME


STRUCTURAL NOTES

SHEET NUMBER

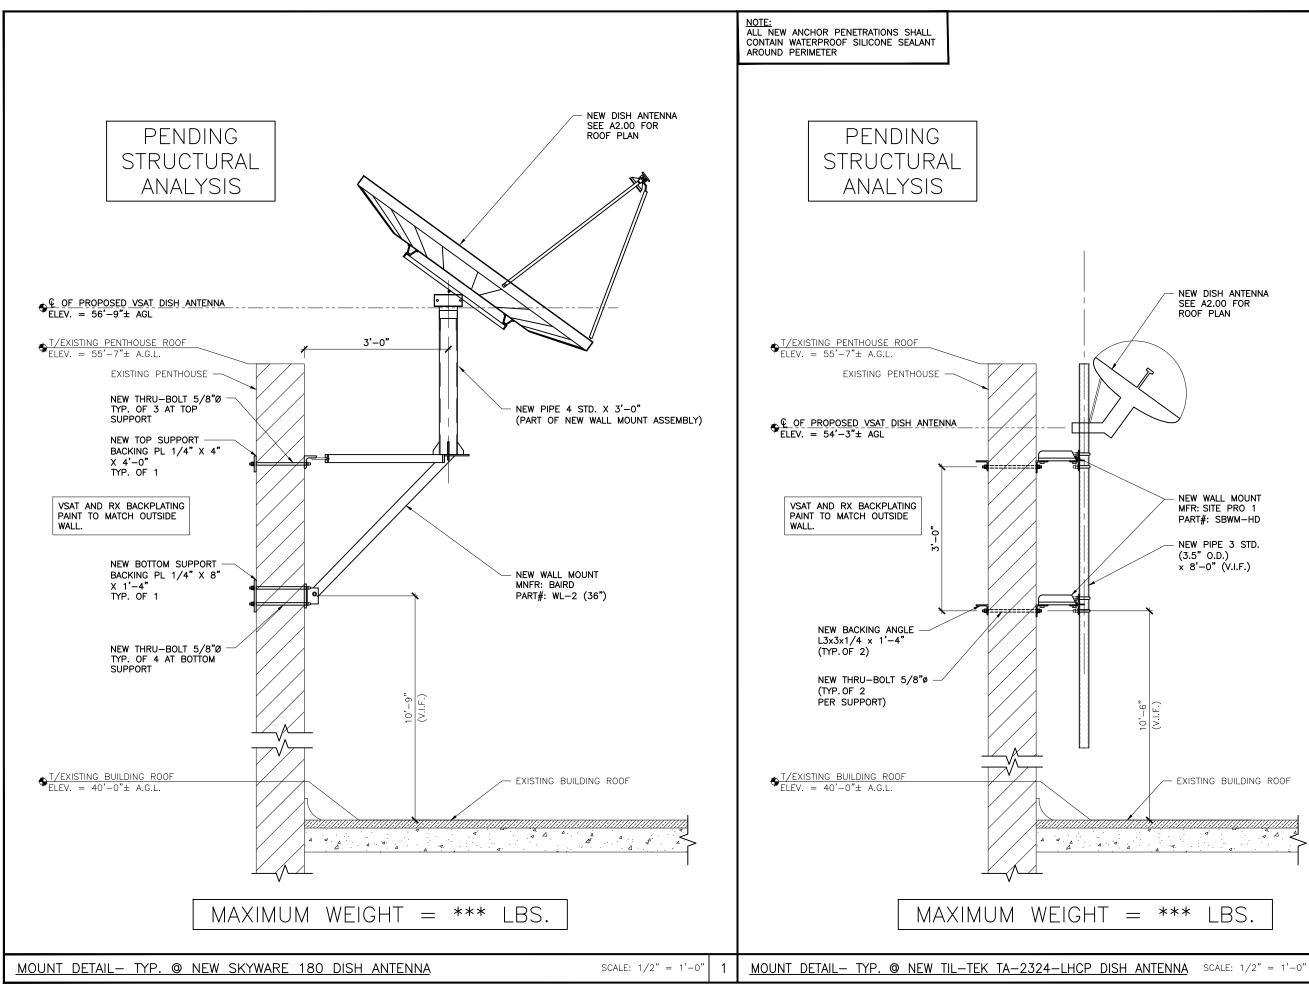

NOTE:
ALL NEW ANCHOR PENETRATIONS SHALL
CONTAIN WATERPROOF SILICONE SEALANT AROUND PERIMETER

> PENDING STRUCTURAL **ANALYSIS**

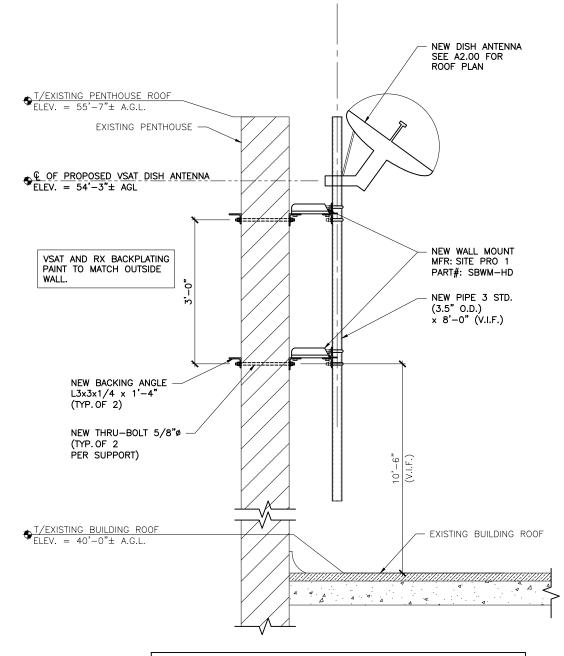

MAXIMUM WEIGHT = ***

LBS



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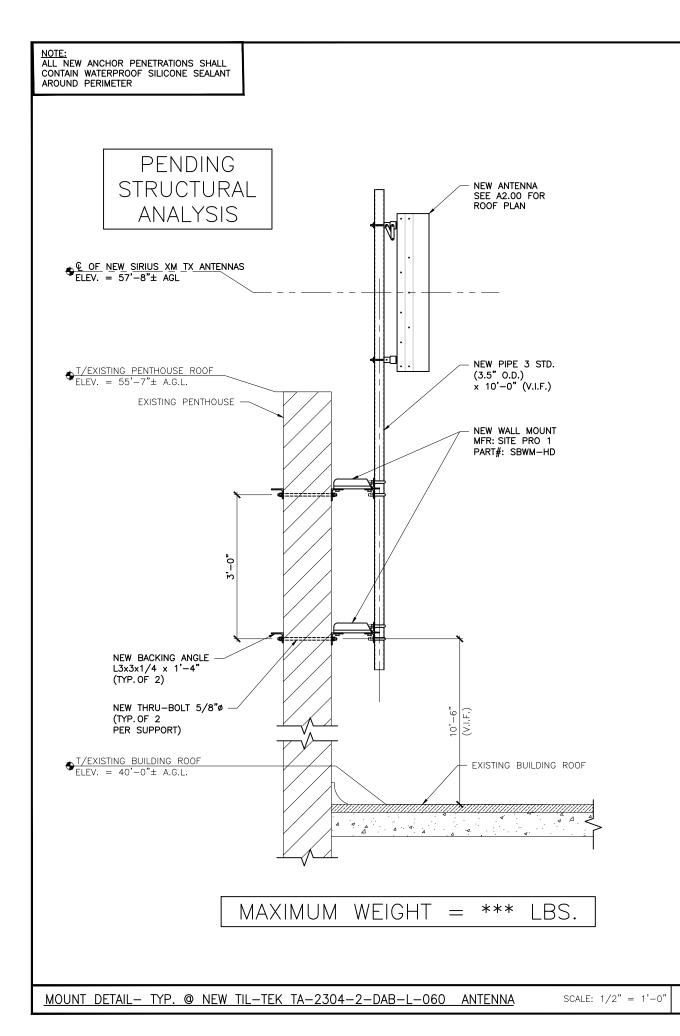
SFX631B

SITE ADDRESS

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SHEET NAME **ANTENNA** MOUNTING DETAILS

SHEET NUMBER







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	03/28/22	FINAL	KK			

SITE NAME

TAUBE KORET
CAMPUS

SITE I.D.

SFX631B

SITE ADDRESS

3921 FABIAN WAY PALO ALTO, CA 94303

SHEET NAME
ANTENNA
MOUNTING
DETAILS

SHEET NUMBER

C 7

SCALE: 1/2" = 1'-0" 2

