


the **MELT**

STANFORD SHOPPING CENTER
180 EL CAMINO REAL, # 705 A, BLDG. E, PALO ALTO, CA 94304

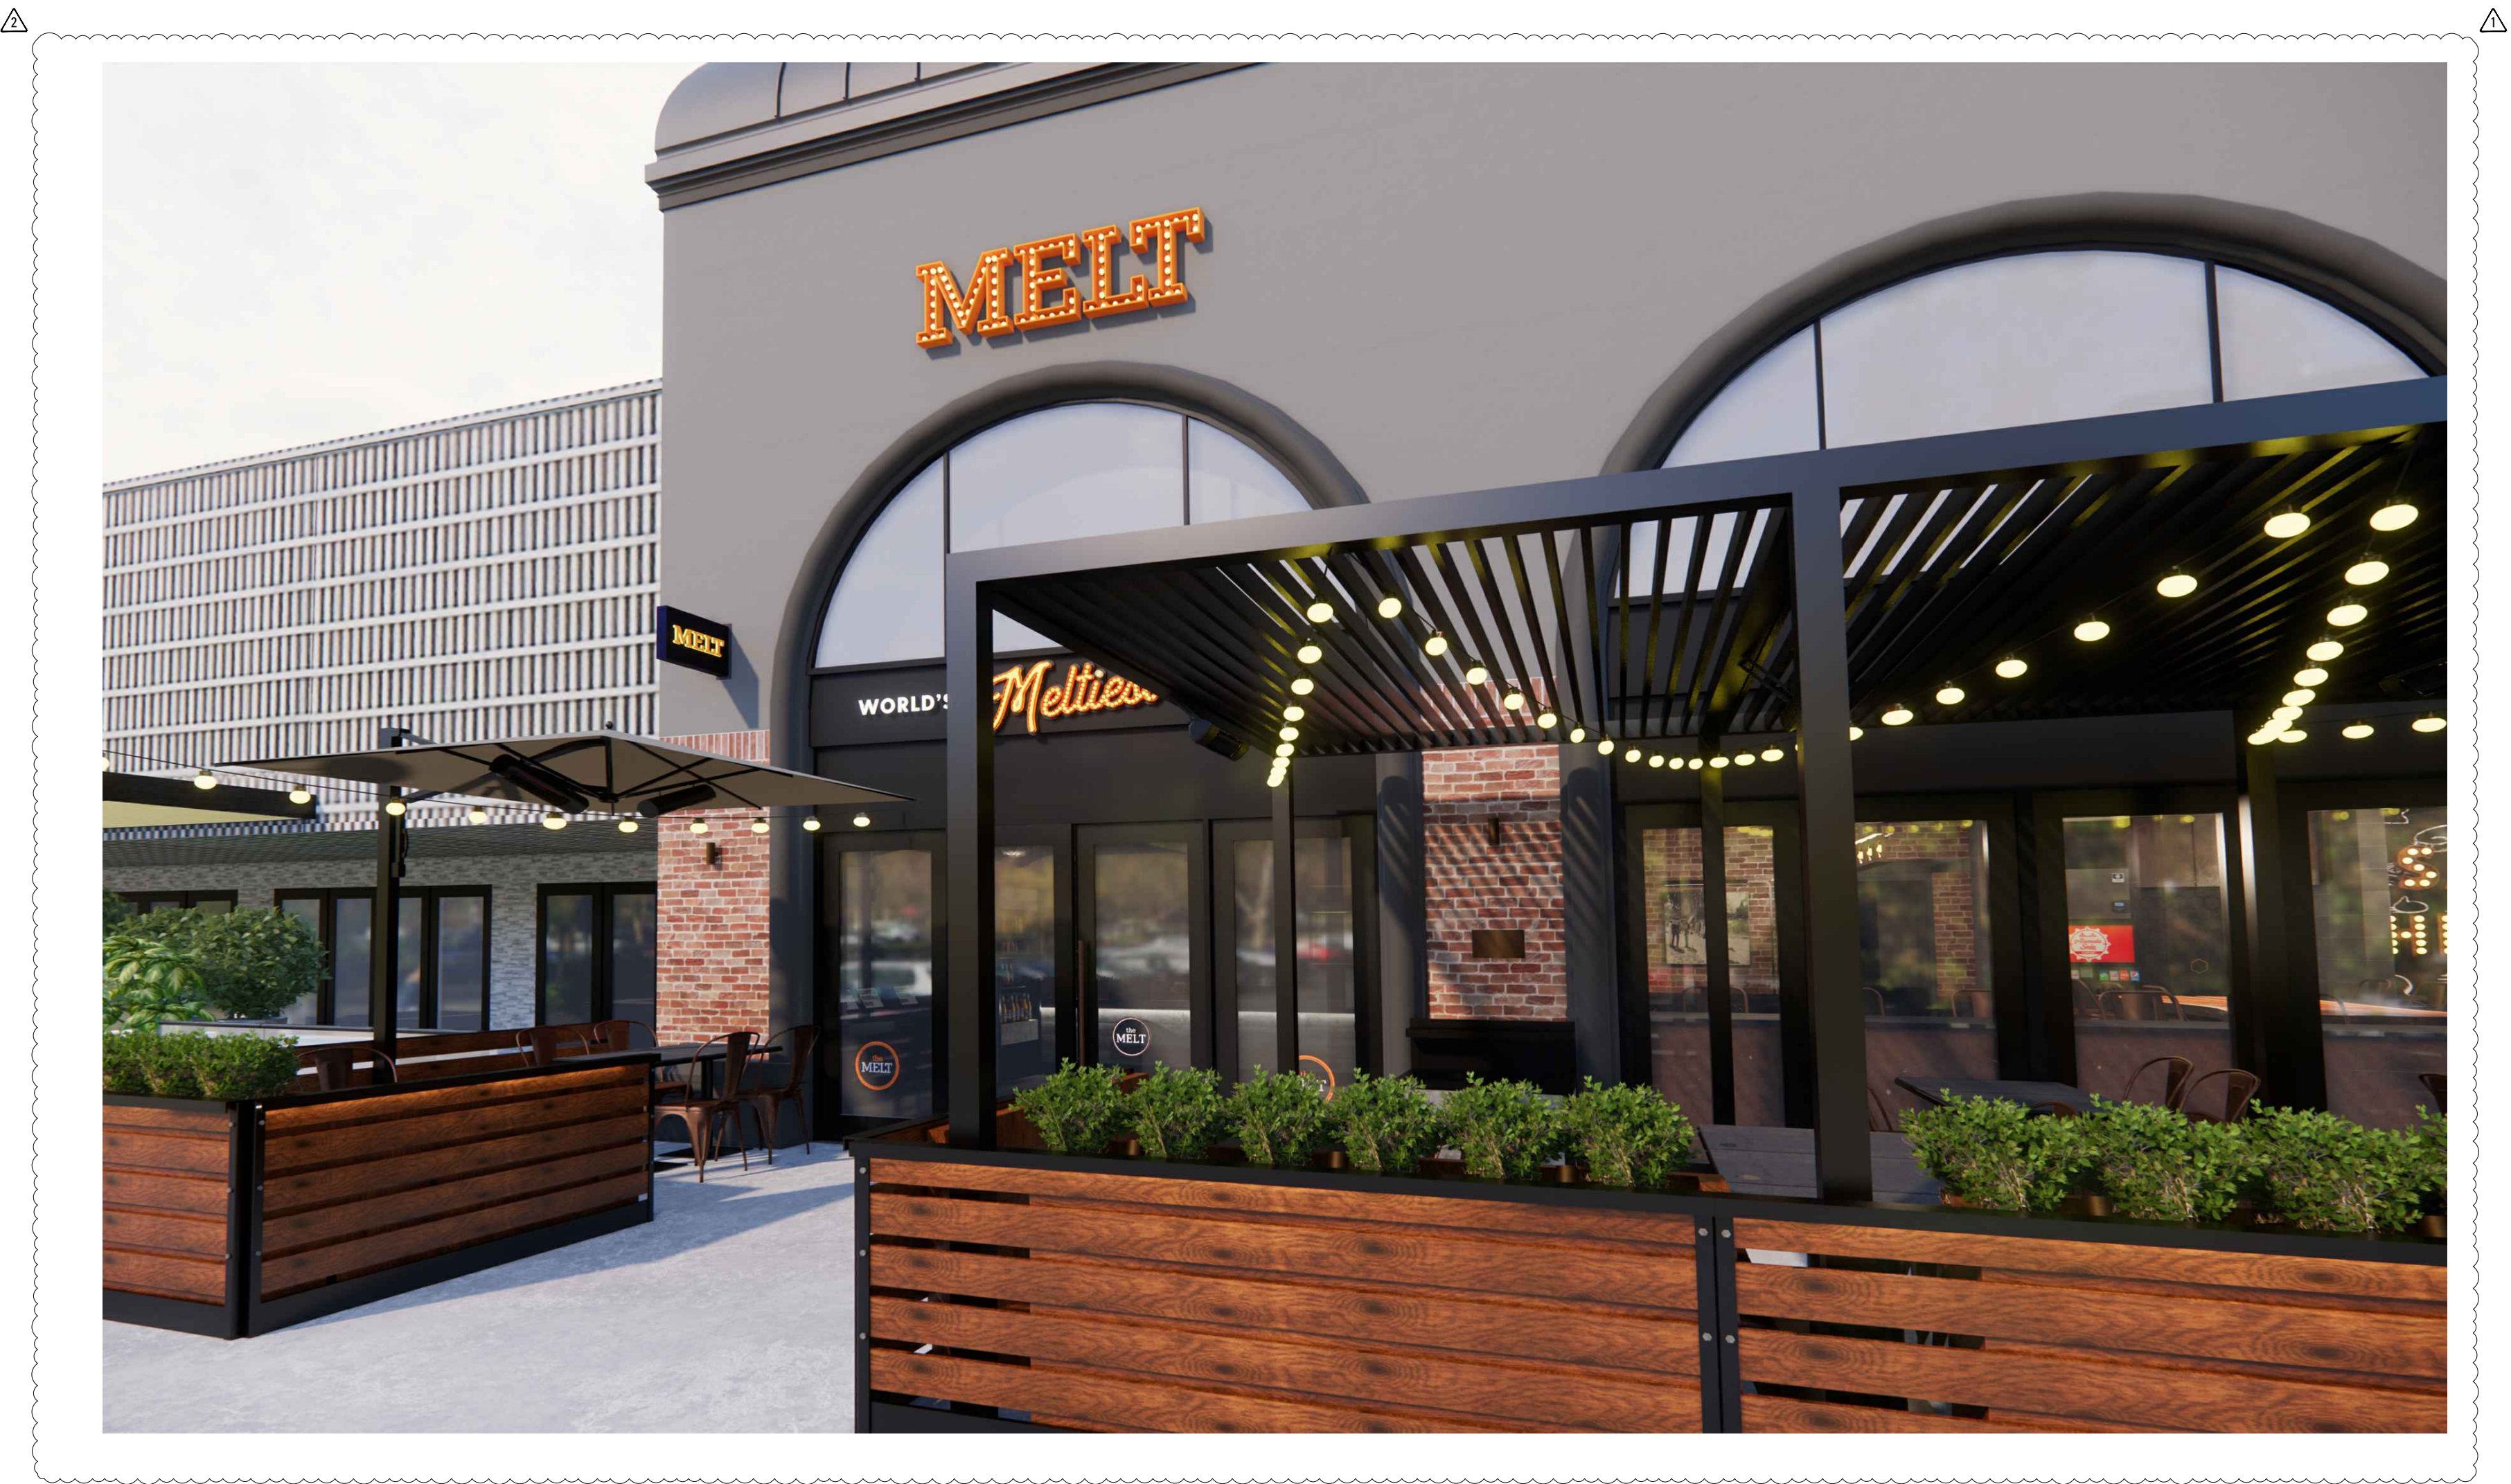

PROJECT TEAM

OWNER:
THE MELT
SCOTT MEYER
smeyer@themelt.com
206.391.5031

ARCHITECT:
KATHRYN CULLEY-RAPATA, AIA
CA LICENSE NO. C-31564
510.459.5136

PROJ. CONSULTANT :
GLOBEATELIÊ
ALIANA RAMOS
aliana@globeateliê.com
614.563.4883

MECH. / ELEC. / PLUMBING :
T/E/S ENGINEERING
NICK GINGERICH
ngingerich@tesengineering.com
440.614.0323

LIGHTING:
SHIMSTONE DESIGN STUDIO
RACHEL EICHORN
re@shimstone.com
201.861.5390

EXPEDITER:
LANDSHARK DEVELOPMENT
SERVICES GROUP
JASON M. SMITH
jsmith@landsharkdevelopment.com
714.235.8235

the MELT

ARB SUBMITTAL

STANFORD SHOPPING CENTER

180 EL CAMINO REAL, SUITE 705A, BLDG. E, PALO ALTO, CALIFORNIA 94304

ABBREVIATION INDEX

ABV	ABOVE	F.F.L.	FINISHED FLOOR LEVEL	(N)	NEW	T.O.	TOP OF
ACT	ACOUSTICAL CEILING TILE	FIN	FINISH FLOOR	N.T.S.	NOT TO SCALE	TYP	TYPICAL
A.F.F.	ABOVE FINISH FLOOR	FL	FLOOR	O.C.	ON CENTER	U.L.	UNDERWRITERS
ALUM	ALUMINUM	FLG	FLOORING	O.D.	OUTSIDE DIMENSION		LABORATORIES
ASTM	AMERICAN SOCIETY FOR TESTING AND MATERIALS	FLU	FLUORESCENT	OPNG	OPENING	U.O.N.	UNLESS OTHERWISE NOTED
BD	BOARD	F.R.T.	FIRE RESISTIVE TREATED	OPP.	OPPOSITE		
BLKG	BLOCKING	GA	GAUGE	PL	PLATE	VERT	VERTICAL
B.O.	BOTTOM OF	G.C.	GENERAL CONTRACTOR	PLYWD	PLYWOOD	V.I.F.	VERIFY IN FIELD
CL	CENTERLINE	GYP BD	GYP SUM BOARD	PREFIN	PREFINISHED	W/	WITH
CLG	CEILING	HDF	HIGH DENSITY FIBERBOARD	PM	PROJECT MANAGER	W/O	WOOD WITHOUT
COL	COLUMN	HGT	HEIGHT	QTY	QUANTITY		
CONC	CONCRETE	HORIZ	HORIZONTAL	(R)	RELOCATED		
CONSTR	CONSTRUCTION	H.M.	HOLLOW METAL	RAD	RADIUS		
CONT	CONTINUOUS	HR	HOUR	REQD	REQUIRED		
C.T.F.	CUT TO FIT	I.D.	INSIDE DIMENSION	(REF)	REFERENCE		
C/C	CENTER TO CENTER	INT	INTERIOR	R.O.	ROUGH OPENING		
DIAG	DIAGONAL	LAV	LAVATORY	S.C.	SOLID CORE		
DIA.	DIAMETER	LL	LANDLORD	SECT	SECTION		
EA	EACH	LL	LEASE LINE	SH	SHEET		
ELEV	ELEVATION	MAX	MAXIMUM	SIM	SIMILAR		
E.P.A.	ENVIRONMENTAL PROTECTION AGENCY	MDF	MEDIUM DENSITY FIBERBOARD	SPL	SPECIAL		
EQ	EQUAL	MFG	MANUFACTURER	SQ	SQUARE		
EXIST(E)	EXISTING	MISC	MISCELLANEOUS	SQ FT / S.F.	SQUARE FEET		
/EXT	EXTERIOR	MIN	MINIMUM	STC	SOUND TRANSMISSION COEFFICIENT		
F.C.D.	FINISHED CABINET DIMENSION	MTD	MOUNTED	STL	STEEL		
FD	FLOOR DRAIN	MTL	METAL	STRUCT	STRUCTURE		
		N.I.C.	NOT IN CONTRACT	SURF	SURFACE		
				TEMP	TEMPERATURE		

ANNOTATION SYMBOLS

DETAIL NUMBER

SHEET NUMBER

ELEVATION NUMBER

SHEET NUMBER

MATCH-LINE NUMBER

MATCH LINE

WALL TYPE / WALL NOTE

DEMO NOTES

KEY NOTES

FINISH / DETAIL NOTES

ROOM NAME

ROOM NUMBER

ROOM NUMBER W/O FINISHES

DECK FINISH

CEILING FINISH

WALL FINISH

BASE FINISH

FLOOR FINISH

LAYOUT POINT

DATUM POINT

CALL-OUT NUMBER

SHEET NUMBER

SECTION NUMBER

SHEET NUMBER

NORTH ARROW

IT TAG

EQUIPMENT TAG

COLUMN GRID

REVISION TAG AND CLOUD

DOOR TAG

DRAWING TITLE

ROOM NAME

ROOM NUMBER

ROOM NUMBER W/O FINISHES

CEILING HEIGHT

CEILING FINISH

CEILING FINISH 1

CEILING FINISH 2

LOCATION

LEVELS

INDEX OF DRAWINGS

DATE		07-05-22	09-25-23	06-12-24	07-17-24	
SHEET	SHEET TITLE	ARB SET	REV 01	REV 02	REV 03	REV 04
ARCHITECTURAL						
G00.00	COVER SHEET	●	●	●	●	
G00.10	TITLE SHEET	●	●	●	●	
G00.20	SITE PLAN AND PARKING INFO	●	●	1	●	
G00.21	ENLARGED SITE PLAN WITH CIRCULATION	●	●	●	●	
G00.30	LIFE SAFETY PLAN	●	●	●	●	
G00.40A	SITE CONTEXT AND RENDERINGS	●	●	●	●	
G00.40B	SITE CONTEXT AND RENDERINGS	●	●	●	●	
G00.40C	ADJACENT TENANT RENDERINGS	●	●	1	●	
D01.01A	DEMOLITION PLAN	●	●	●	●	
D01.01B	DEMOLITION REELECTED CEILING PLAN	●	●	●	●	
D01.02	DEMOLITION STOREFRONT ELEVATIONS	●	●	●	●	
A02.01	CONSTRUCTION FLOOR PLAN	●	●	●	●	
A03.01	REFLECTED CEILING PLAN AND PHOTOMETRIC RCP	●	●	●	●	
A05.01	FLOOR AND WALL FINISH PLAN	●	●	●	●	
A05.02	FINISH SCHEDULE	●	●	●	●	
A08.01	STOREFRONT ELEVATIONS	●	●	●	●	
A08.02	STOREFRONT DETAILS	●	●	●	●	
A08.03	STOREFRONT DETAILS	●	●	●	●	
ARCHITECTURAL SHEETS TOTAL		15	15	15	15	
EXHIBITS						
X.01	ZERO WASTE SHEET	●	●	●	●	
X.02	LIGHTING CUT SHEETS	●	●	●	●	
X.02A	LIGHTING CUT SHEETS	●	●	●	●	
X.03	CONSTRUCTION DETAILS	●	●	●	●	
X.04	CONSTRUCTION DETAILS	●	●	●	●	
T-1	SPECIAL TREE PROTECTION INSTRUCTION SHEET	●	●	●	●	
T-2	SPECIAL TREE PROTECTION INSTRUCTION SHEET	●	●	●	●	
SIGNAGE						
A10-01	SIGNAGE DRAWINGS (SHEET 1 OF 5)	●	●	●	●	
A10-02	SIGNAGE DRAWINGS (SHEET 2 OF 5)	●	●	●	●	
A10-03	SIGNAGE DRAWINGS (SHEET 3 OF 5)	●	●	●	●	
A10-04	SIGNAGE DRAWINGS (SHEET 4 OF 5)	●	●	●	●	
A10-05	SIGNAGE DRAWINGS (SHEET 5 OF 5)	●	●	●	●	
EXHIBITS & SIGNAGE SHEETS TOTAL		11	9	10	10	
TOTAL SHEETS		26	24	25	25	

PROJECT SUMMARY

PROJECT SCOPE:
EXTERIOR TENANT REMODEL AT RESTAURANT WITH MINOR ELECTRICAL AND STRUCTURAL WORK. NO INTERIOR WORK.

NO CHANGE IN ZONING IS PROPOSED UNDER THIS APPLICATION.
ALL EXISTING RATED CONSTRUCTION TO BE MAINTAINED

MODIFICATIONS TO EXISTING AUTOMATIC FIRE SPRINKLER SYSTEM UNDER SEPARATE PERMIT

PROJECT DESCRIPTION:

THE MELT, PALO ALTO
180 EL CAMINO REAL,
SUITE 705A, BLDG. E,
PALO ALTO,
CALIFORNIA 94304

LANDLORD:

SIMON
CONTACT: JOHN STEEN
SENIOR TENANT COORDINATOR
317-404-8985
RWESSELLS@SIMON.COM

EXPEDITOR:

LANDSHARK DEVELOPMENT SERVICES
CONTACT: JASON M. SMITH
714.235.0235
JSMITH@LANDSHARKDEVELOPMENT.COM

TENANT:

FISH SIX RESTAURANT CORP, DBA THE MELT
925 MARKET STREET
SAN FRANCISCO, CA 94103
CONTACT: SCOTT MEYER
SMEYER@THEMELT.COM

ZONING:

CC
BUILDING CONSTRUCTION TYPE: IIIB (SPRINKLERED)

EXISTING OCCUPANCY CLASSIFICATION: A-2
PROPOSED OCCUPANCY CLASSIFICATION: A-2

APPLICABLE CODES

BUILDING:	CALIFORNIA ADMINISTRATIVE CODE (CAC)	2022
ELECTRICAL:	CALIFORNIA BUILDING CODE (CBC)	2022
MECHANICAL:	CALIFORNIA ELECTRICAL CODE (CEC)	2022
PLUMBING:	CALIFORNIA MECHANICAL CODE (CMC)	2022
ENERGY:	CALIFORNIA PLUMBING CODE (CPC)	2022
FIRE:	CALIFORNIA ENERGY CODE (CEC)	2022
	CALIFORNIA FIRE CODE (CFC)	2022
	CALIFORNIA GREEN BUILDING STANDARDS CODE (CAL GREEN)	2022

TOTAL LEASED SQUARE FOOTAGE: 3205 SF

TOTAL SQUARE FOOTAGE UNDER THIS EXTERIOR PERMIT: 743 SF
TOTAL SQUARE FOOTAGE UNDER THE SEPARATE INTERIOR PERMIT: 2462 SF

OCCUPANT LOAD OF EGRESS (CBC TABLE 1004.5):

AREA:	SQUARE FOOTAGE:	OCCUPANT LOAD FACTOR:	NO. OF OCCUPANTS:
KITCHEN	800 GSF	200 GROSS	4
INTERIOR DINING	1485 SF	15 NET	99
EXTERIOR DINING	743 SF	15 NET	50
RESTROOMS	177 SF	N/A	0

TOTAL NUMBER OF OCCUPANTS, INTERIOR: 103

NUMBER OF EXITS REQUIRED: 2
NUMBER OF EXITS PROVIDED: 3

OCCUPANT LOAD FACTOR (BSC, DSA-SS & DSA-SS/CC) TABLE 4-1 OF CPC 2022

AREA:	SQUARE FOOTAGE:	OCCUPANT LOAD FACTOR:	NO. OF OCCUPANTS:
KITCHEN	867	50 NET	18
INTERIOR DINING	1161	30 NET	50
EXTERIOR DINING	539	30 NET	25


TOTAL NUMBER OF OCCUPANTS, INTERIOR PLUS EXTERIOR SEATING: 93

OCCUPANT LOAD, MALE: 47
OCCUPANT LOAD, FEMALE: 47

PLUMBING FIXTURES CALCULATIONS FOR TYPE A-2 OCCUPANCY AS PER TABLE 422.1 OF CPC 2022

	MEN		WOMEN	
	REQUIRED	PROVIDED	REQUIRED	PROVIDED
WC	1	1	2	2
URINAL	1	1	-	-
LAVATORY	1	1	1	1
OTHER:	MOP SINK IN THE BOH			
REQUIRED: 1				
PROVIDED: 1				

VICINITY MAP

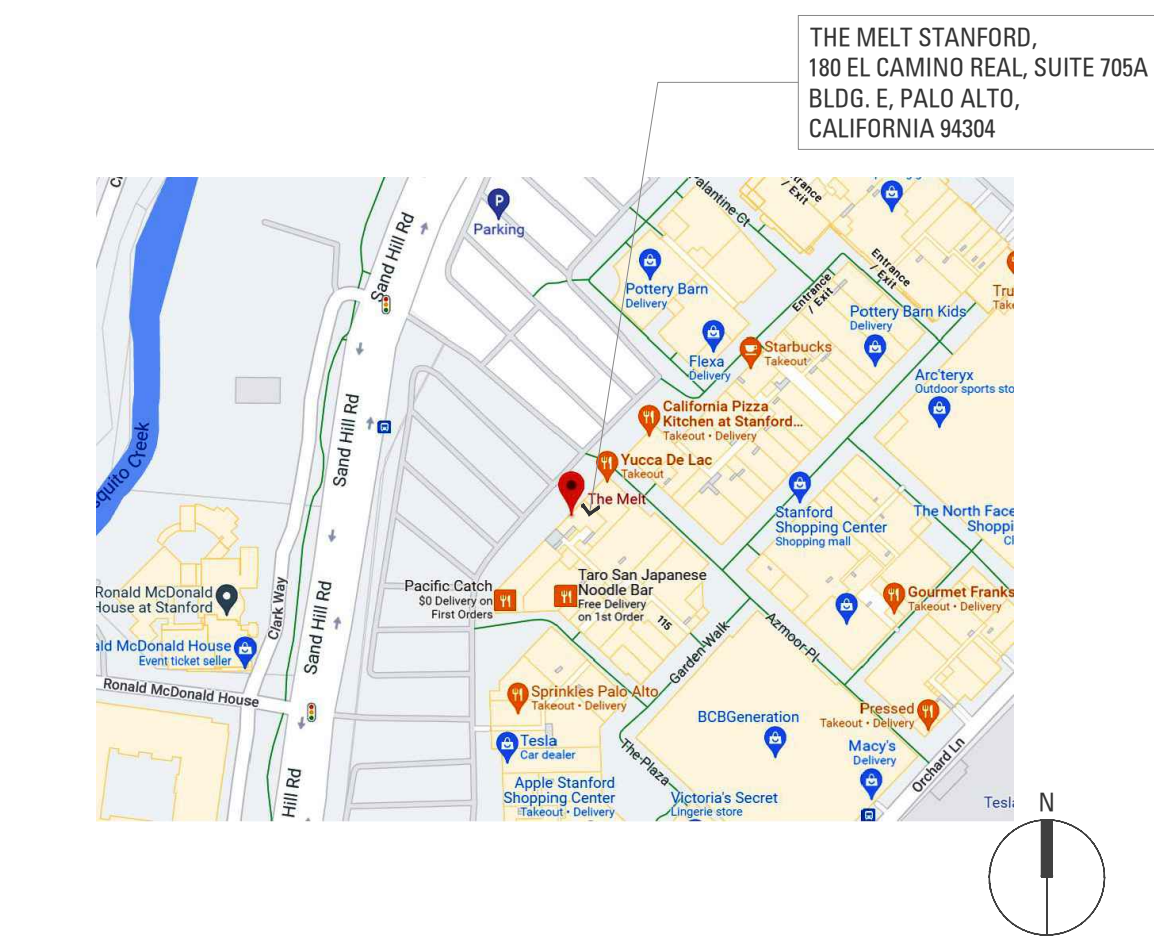

GENERAL NOTES

- THE USE OF THESE DOCUMENTS IS RESTRICTED TO THE ORIGINAL SITE FOR WHICH THEY WERE PREPARED. REUSE OR REPRODUCTION OF THE DOCUMENTS, (WHOLE OR IN PART) FOR ANY OTHER PURPOSE IS PROHIBITED. ARCHITECT RETAINS ALL RIGHTS OF OWNERSHIP.
- THE G.C. SHALL REVIEW ALL DOCUMENTS, FIELD VERIFY ALL DIMENSIONS, INSPECT EXISTING FIELD CONDITIONS AND CONFIRM THAT THE WORK CAN BE BUILT AS SHOWN IN THE CONSTRUCTION DRAWINGS. ANY DISCREPANCIES BETWEEN THESE DRAWINGS AND THE EXISTING CONDITIONS AS OBSERVED ON SITE BY THE G.C. AND/OR ANY SUBCONTRACTORS SHALL BE BROUGHT TO THE ATTENTION OF THE OWNER AND ARCHITECT PRIOR TO PROCEEDING WITH THE WORK.
- THE CONTRACTOR AND SUB-CONTRACTORS SHALL BE SOLELY RESPONSIBLE FOR COMPLYING WITH ALL FEDERAL, STATE, AND LOCAL SAFETY REQUIREMENTS TOGETHER WITH EXERCISING PRECAUTIONS AT ALL TIMES FOR THE PROTECTION OF PERSONS INCLUDING EMPLOYEES AND PROPERTY. IT IS THE SOLE RESPONSIBILITY OF THE CONTRACTOR AND SUB-CONTRACTORS TO INITIATE, MAINTAIN, AND SUPERVISE ALL SAFETY REQUIREMENTS, PRECAUTIONS, AND PROGRAMS IN CONNECTION WITH THE WORK.
- THE GENERAL CONTRACTOR SHALL BE RESPONSIBLE TO COORDINATE ALL WORK AND FOR THE MEANS, METHODS, PROCEDURES, TECHNIQUES, AND SEQUENCE OF CONSTRUCTION.
- GENERAL CONTRACTOR SHALL PROVIDE ALL REQUIRED PERMITS, FEES, AND INSPECTIONS AS MAY BE REQUIRED BY GOVERNING BODIES HAVING LEGAL JURISDICTION.
- THE GENERAL CONTRACTOR IS TO GUARANTEE ALL WORK INCLUDING WORK DONE BY SUB-CONTRACTORS FOR A PERIOD OF A MINIMUM ONE (1) YEAR COMMENCING WITH THE DATE OF SUBSTANTIAL COMPLETION OF THE WORK, OR AS STATED IN CONTRACT WITH OWNER, WHICHEVER IS GREATER.
- GENERAL CONTRACTOR SHALL BE RESPONSIBLE FOR ALL SCHEDULING AND MONITORING OF ON-SITE TESTING AND INSPECTION SERVICES AS LISTED IN THE PROJECT MANUAL AND GENERAL CONDITIONS.
- WHEN CONTRACTOR ACCEPTS DELIVERY OF ALL ITEMS NOTED ON PLANS EITHER IN CONTRACT OR NOT IN CONTRACT, THEY SHALL BE RESPONSIBLE FOR LOSS AND/ OR DAMAGE TO THESE ITEMS.
- THE GENERAL CONTRACTOR & EACH SUBCONTRACTOR IS TO HAVE A FULL TIME QUALIFIED SUPERVISOR ON THE SITE AT ALL TIMES WHILE WORK IS BEING PERFORMED.
- THE CONTRACTOR SHALL MAINTAIN FOR THE ENTIRE DURATION OF THE WORK ALL EXITS, EXIT LIGHTING, FIRE PROTECTION DEVICES, AND ALARMS IN CONFORMANCE WITH ALL APPLICABLE CODES AND ORDINANCES.
- DO NOT SCALE DRAWINGS. WRITTEN DIMENSIONS GOVERN. ALL PARTITION LOCATIONS, ALL DOOR AND OPENING LOCATIONS SHALL BE SHOWN ON FLOOR PLAN. IN CASE OF CONFLICT NOTIFY THE ARCHITECT. FLOOR PLAN BY ARCHITECT SUPERSEDES ALL OTHER PLANS. ALL DIMENSIONS MARKED "CLEAR" SHALL BE MAINTAINED AND SHALL ALLOW FOR THICKNESS OF ALL FINISHES INCLUDING CARPET, PAD, CERAMIC TILE, V.C.T., SLATWALL, ETC.
- ALL DIMENSIONS ON ARCHITECTURAL DRAWINGS LOCATING STRUCTURAL ELEMENTS ARE TO CENTERLINE OF STEEL COLUMNS AND STEEL BEAMS UNLESS NOTED OTHERWISE.
- ALL SAW CUTTING AND CORING LOCATIONS SHALL BE REVIEWED IN FIELD BY THE GENERAL CONTRACTOR PRIOR TO CUTTING/CORING.
- ALL EXTERIOR WOOD BLOCKING IS TO BE PRESSURE TREATED PER AWPA U1 AND M4.
- ALL FASTENERS, CONNECTORS, OR OTHER HARDWARE IN DIRECT CONTACT WITH PRESERVATIVE TREATED OR FIRE RETARDANT TREATED WOOD SHALL BE STAINLESS STEEL TYPE 304 OR TYPE 316, OR HOT-DIPPED GALVANIZED STEEL ASTM A653, CLASS G-185 WITH 1.85 OUNCES OF ZINC PER SQUARE FOOT TO REDUCE THE CORROSION PROCESS.
- PROVIDE PORTABLE FIRE EXTINGUISHERS WITH U.L LABEL WITH 75 FT TRAVEL DISTANCE TO ALL POSITIONS OF BUILDING OR AS DIRECTED BY THE FIRE DEPARTMENT FIELD INSPECTOR.

SITE PLAN



RESERVED FOR CITY APPROVAL STAMPS

ARCHITECT:

KATHRYN CULLEY-RAPATA, AIA
CA LICENSE NO. C-31564
CONTACT: KATE CULLEY-RAPATA
PH: 510-459-5136

STAMP & SEAL:

PROJECT CONSULTANT:

globeateliê
2041 EAST STREET PMB 475
CONCORD CA 94520

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CLIENT:

the MELT

THE MELT, STANFORD
180 EL CAMINO REAL, SUITE 705A, BLDG. E,
PALO ALTO, CALIFORNIA 94304

PROJECT:

PROJECT#: GA21-MLT004
DOCUMENT DATE: 06-12-24
DOCUMENT PHASE:

ARB SUBMITTAL REV 03

DATE	ISSUE
07-05-22	ARB SET
09-25-23	REVISION 01
06-12-24	REVISION 02
07-17-24	REVISION 03

DRAWN BY: AA
CHECKED BY: AR
SHEET TITLE

TITLE SHEET

SHEET NUMBER

G00.00

Stanford Shopping Center Parking and Loading Tabulation

as of 6/13/24

GROSS FLOOR AREA (GFA) for Parking						
BUILDING	BASEMENT	GROUND	2ND	3RD	OUTDOOR	TOTAL
C-North		26,213	11,919		0	38,132
C-South		30,754	7,546		0	38,300
D		62,860	17,691		186	80,737
E		27,452	12,678		2,520	42,650
F	15,459	44,454	6,565		0	66,478
H		21,584	0		0	21,584
L		23,610	2,467		784	26,861
M		55,048	13,596		0	68,644
N		20,403	391		0	20,794
P		9,955			0	9,955
V		30,859	32,637		1,674	65,170
W		10,630	0		1,148	11,778
AA		29,306	0		0	29,306
BB		25,979	25,995		174	52,148
CC		16,493	0		0	16,493
DD		16,823	16,825		0	33,648
EE (Future)		11,799	0		1,246	13,045
FF (Future)		22,268	6,473			28,741
Bloomingdale's*		120,000				120,000
Macy's*		225,830				225,830
Neiman Marcus*		120,000				120,000
Flemings		7,088			1,176	8,264
Nordstrom*		180,000				180,000
Container Store		24,116				24,116
Crate&Barrel		39,173				39,173
Bank of America		4,185				4,185
Restoration Hardware		17,713	15,524	8,613		41,850
TOTAL	15,459	1,224,595	170,307	8,613	8,908	1,427,882

GBA ~ Anchors, Small shops, office, storage, utility rooms, trash rooms, back of house, service corridors
GFA ~ GBA + outdoor space under permanent canopies

Loading Space	Required 3/First 120k sf	Required 1/50k sf over 120k sf	Required	Existing	Proposed	Deficient
3/70,000 -120,000 sf with 1 additional space per 50,000 sf over 120,000 sf	3	26	29	24	25	4

Vehicular Parking Provided by Space Type	Notes	Regular	ADA	EVSE	EV (Ready)	ADA EVSE/Ready***	x2 PK EVSE	Dedicated Parking	TOTAL
Required Parking Spaces 1/275 GFA									5,192
Existing Parking Spaces	As of 3/27/2019	5,218	101	29	96				5,444
Proposed Parking Spaces	Macys Mens Project		10	0	49				59
Dedicated Parking - Tesla	16PLN-00040							-6	-6
Loss of Physical Parking Spaces	Macys Mens Project	-240							-240
Loss of Physical Parking Spaces	Building EE	-1							-1
Total Parking Spaces		4,977	111	29	145			-6	5,256
Excess number of spaces (Proposed - Required and Dedicated Spaces)									
Per AB1100: EVSE & EV Ready Van accessible & accessible spaces adjacent to an accessible path of travel are counted x2 towards the parking total									

NET FLOOR AREA (NFA) for Entitlements*						
BUILDING	BASEMENT	GROUND	2ND	3RD	OUTDOOR	TOTAL
C-North		22,136	2,094			24,230
C-South		29,277	4,418			33,695
D		58,383	17,691		186	76,260
E		24,167	0		2,520	26,687
F	8,461	40,922	4,386		0	53,769
H		18,979	0		0	18,979
L		21,531	0		784	22,315
M		52,107	10,508		0	62,615
N		18,596	391		0	18,987
P		9,955			0	9,955
V		28,279	31,126		0	59,405
W		10,008	0		1,148	11,156
AA		28,491	0		0	28,491
BB		20,167	22,829		174	43,170
CC		16,130	0		0	16,130
DD		16,202	16,513		0	32,715
EE (Future)		11,554	0		1,246	12,800
FF (Future)		22,268	6,473			28,741
Bloomingdale's*		114,000				114,000
Macy's*		214,539				214,539
Neiman Marcus*		114,000				114,000
Flemings		7,220			1,176	8,396
Nordstrom*		171,000				171,000
Container Store		24,116				24,116
Crate&Barrel		39,173				39,173
Bank of America		4,185				4,185
Restoration Hardware		17,731	15,524	8,613		41,868
TOTAL	8,461	1,155,116	131,953	8,613	7,234	1,311,377
						Allowable NFA
						1,412,562
						Available NFA
						100,985

NFA ~ GFA - mall office space, sealed off space and common area


NOTES:
* Includes 5% reduction in Anchor Store GFA for space classified as 'non-occupied' to calculate NFA per COPA Planning Dept. letter dated Apr. 23, 2014. Note that the Redevelopment Phase 1 table ('Existing as of 5/23/12') pre-dated this agreement, thus did not take into account the 5% reduction for NFA, therefore some figures will differ.
** per PAMC Ch. 18.16.060(e) and COPA Planning Dept. letter dated Feb. 27, 2014.
395 Quarry Road (Bank of America) has been deleted from this table. The site has an existing 4,185 sf building, 21 parking spaces and is zoned CN. The property is managed by Simon, but is not counted towards Stanford Shopping Center FAR (Gross & Net) as it is not within the PAMC 18.16.030(d) definition of "Stanford Shopping Center" properties which are defined as all properties zoned CC and bounded by El Camino Real, Sand Hill Road, Quarry Road, and Vineyard Lane.

HAZARD & EGRESS NOTES-

1. PROVIDE 80° HEADROOM FROM THE WALKWAY SURFACE TO ANY OVERHANGING OBSTRUCTION
2. HEADROOM OF 80° MINIMUM SHALL BE MAINTAINED FOR WALKS, CORRIDORS, AISLES, ETC
3. OBSTRUCTIONS WITHIN THE WALK PATHWAY (i.e. POLES OR FIRE HYDRANTS SHALL PROVIDE A 36° MIN. CLEAR WIDTH TO THE EDGE OF THE WALK.
4. PROTRUDING OBJECTS WITH LEADING EDGES BETWEEN 27° AND 80° ABOVE THE FINISHED FLOOR ABOVE THE FINISHED FLOOR LEVEL SHALL NOT PROTRUDE MORE THEN 4" INTO WALKS, CORRIDORS, ETC.
5. OBJECTS WITH PROTRUDING EDGES LESS THAN 27° ABOVE THE FINISHED FLOOR MAY PROTRUDE ANY AMOUNT.
6. FREE-STANDING OBJECTS MOUNTED ON POSTS BETWEEN 27° AND 80° ABOVE THE FLOOR MAY PROJECT A MINIMUM OF 12".
7. NOT USED
8. ABRUPT CHANGES IN LEVEL OF 4" OR MORE ADJACENT TO WALKS, EXCEPT BETWEEN WALKS AND ADJACENT STREETS OR DRIVES, SHALL BE IDENTIFIED BY 6" HIGH WARNING CURBS ABOVE THE WALK SURFACE.

NOTE: PRIOR TO STOCKING THE STORE, THE FOLLOWING SHALL BE COMPLETED IN ORDER:

- A. A COMPLETED SAFE PATH OF TRAVEL IS PROVIDED INSIDE THE BUILDING.
- B. THE INSIDE SHALL BE COMPLETED AND SIGNED OFF BY THE BUILDING INSPECTOR.
- C. THE FIRE DEPARTMENT PROVIDED A RELEASE FOR STOCKING SHELVES
- D. THE BUILDING INSPECTOR HAS THE FINAL WORD IF IT WILL BE SAFE FOR EMPLOYEES TO STOCK SHELVING IN A CONSTRUCTION SITE.

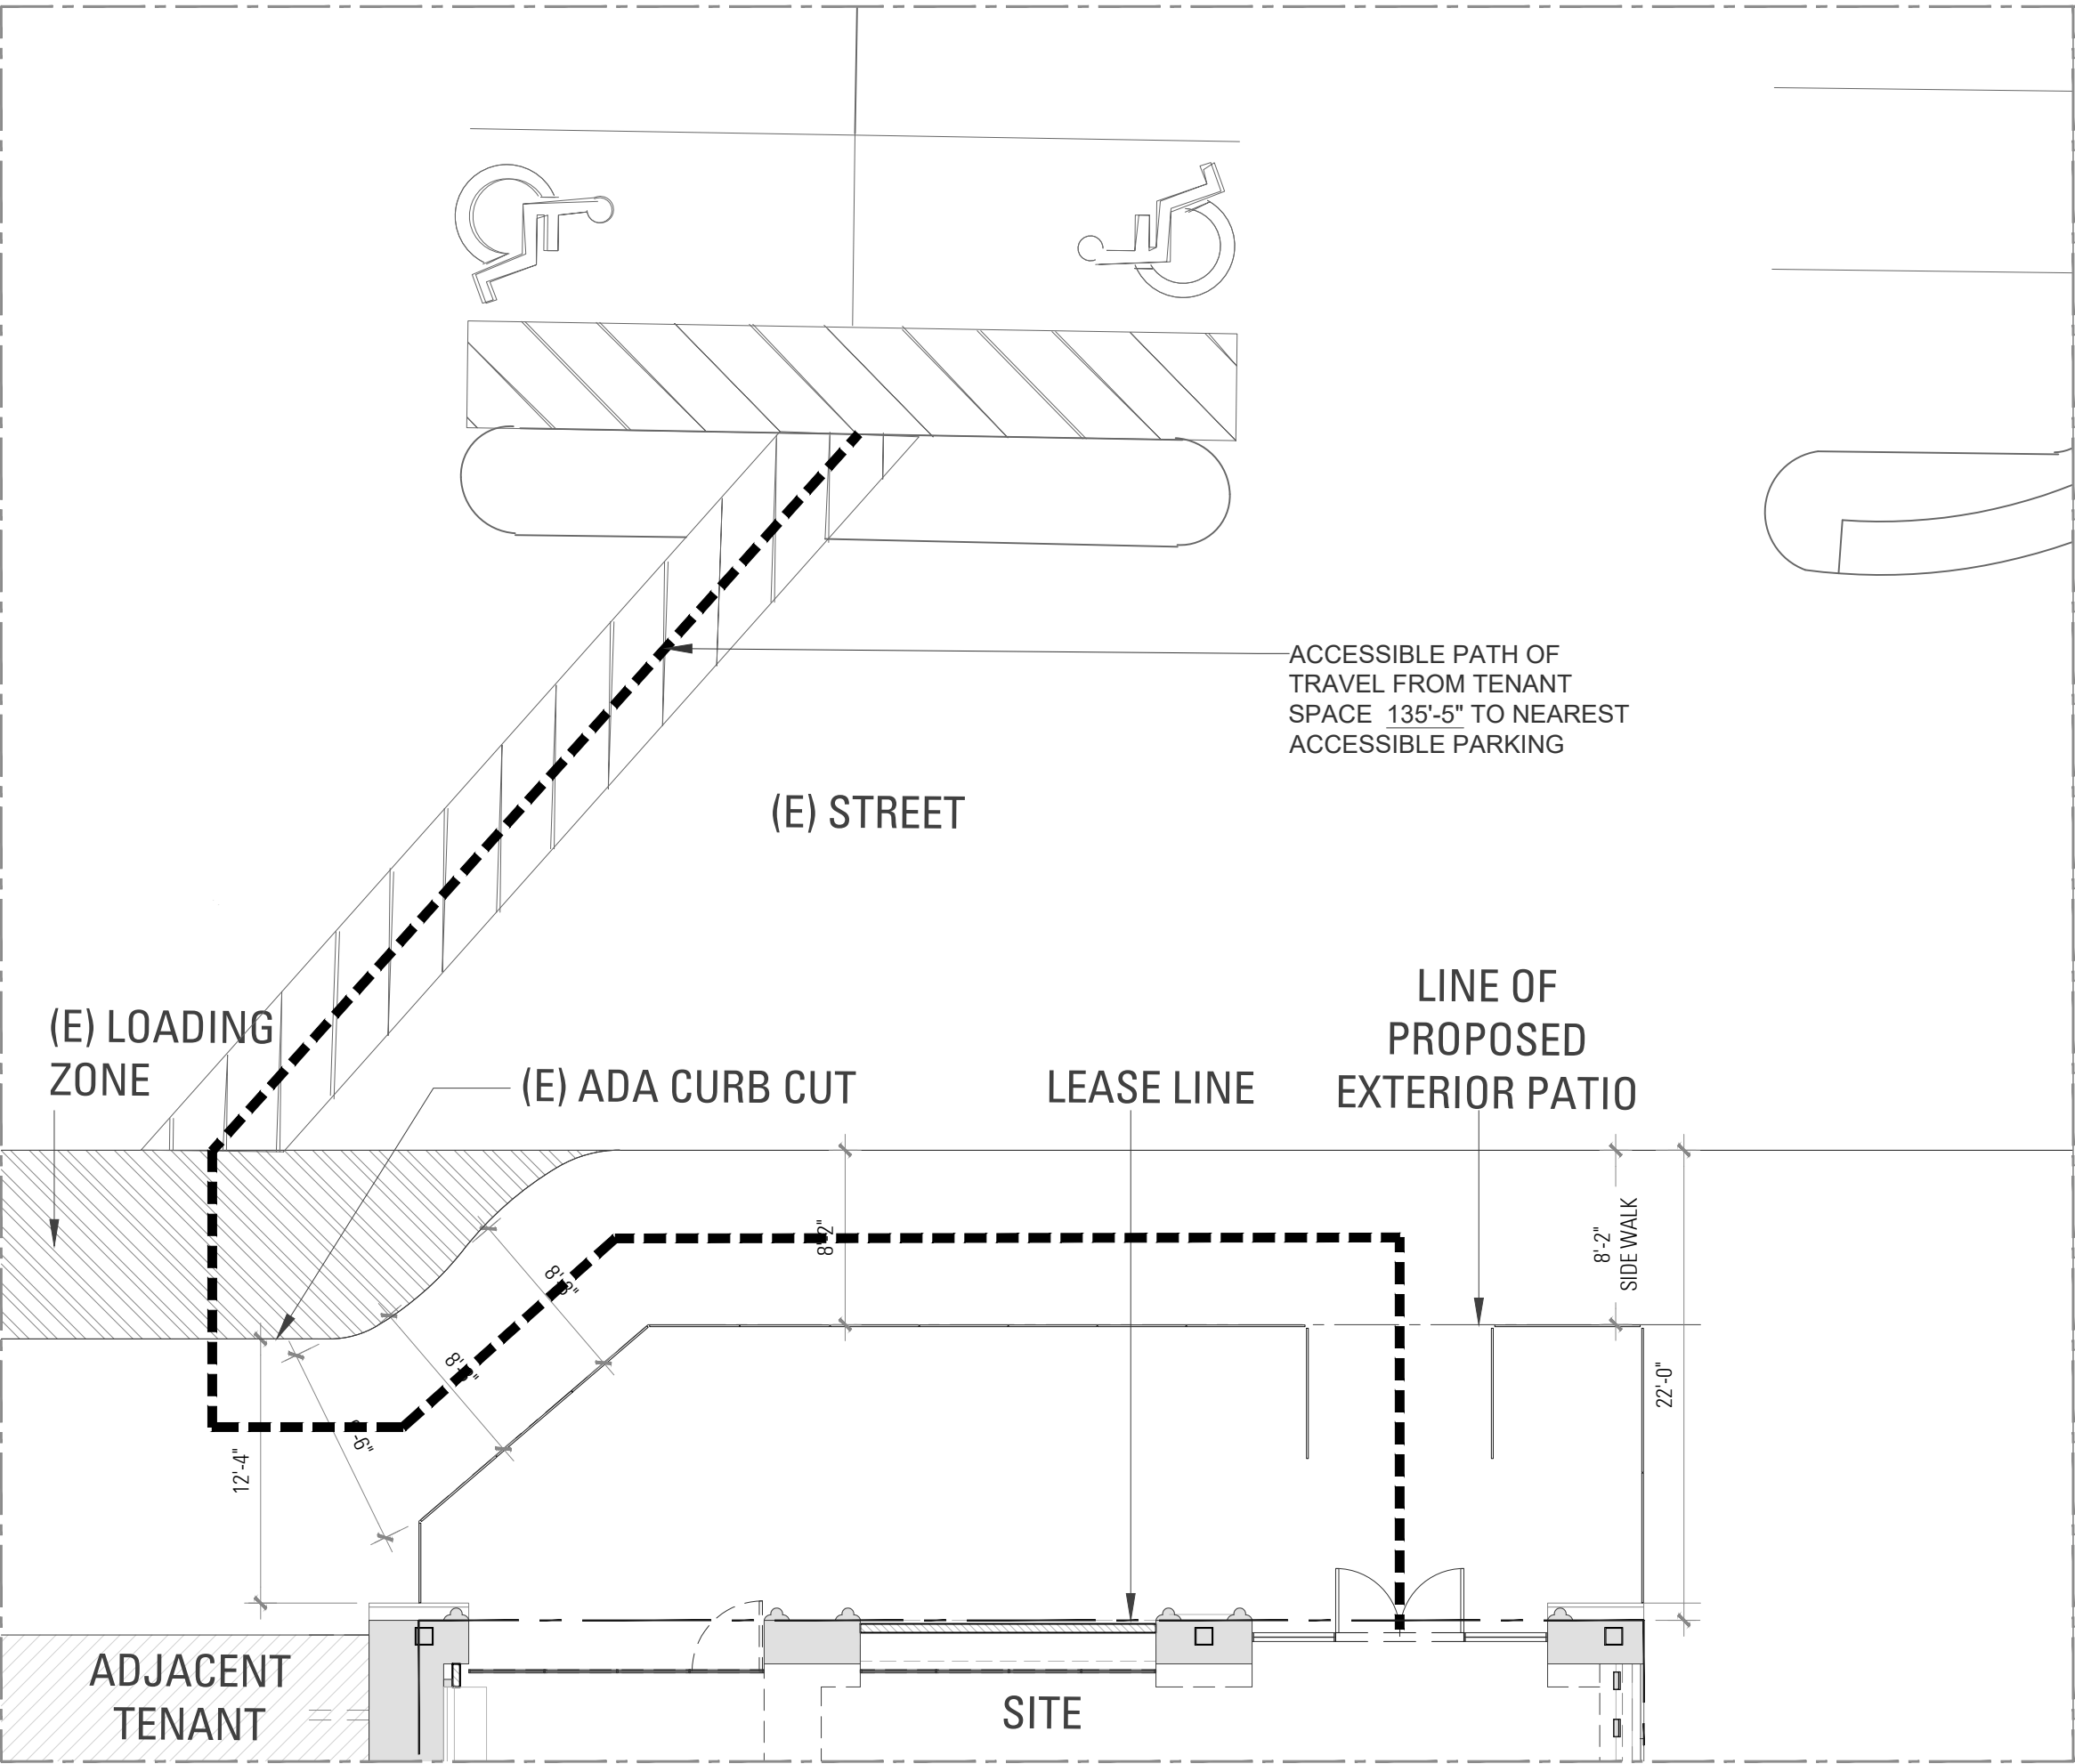

2 ENLARGED PLAN
1/8" = 1'-0"



1 STANFORD SHOPPING CENTRE PLAN
1/128" = 1'-0"

ARCHITECT:

KATHRYN CULLEY-RAPATA, AIA
CA LICENSE NO. C-31564
CONTACT: KATE CULLEY-RAPATA
PH: 510-459-5136

STAMP & SEAL:

PROJECT CONSULTANT:

globeateliê
2041 EAST STREET PMB 475
CONCORD CA 94520

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CLIENT:

theMELT

THE MELT, STANFORD
180 EL CAMINO REAL, SUITE 705A, BLDG. E,
PALO ALTO, CALIFORNIA 94304

PROJECT:

PROJECT#: GA21-MLT004
DOCUMENT DATE: 06-12-24
DOCUMENT PHASE:
ARB SUBMITTAL REV 03


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DRAWN BY: AA
CHECKED BY: AR
SHEET TITLE


SITE PLAN & PARKING INFO

SHEET NUMBER

G00.20

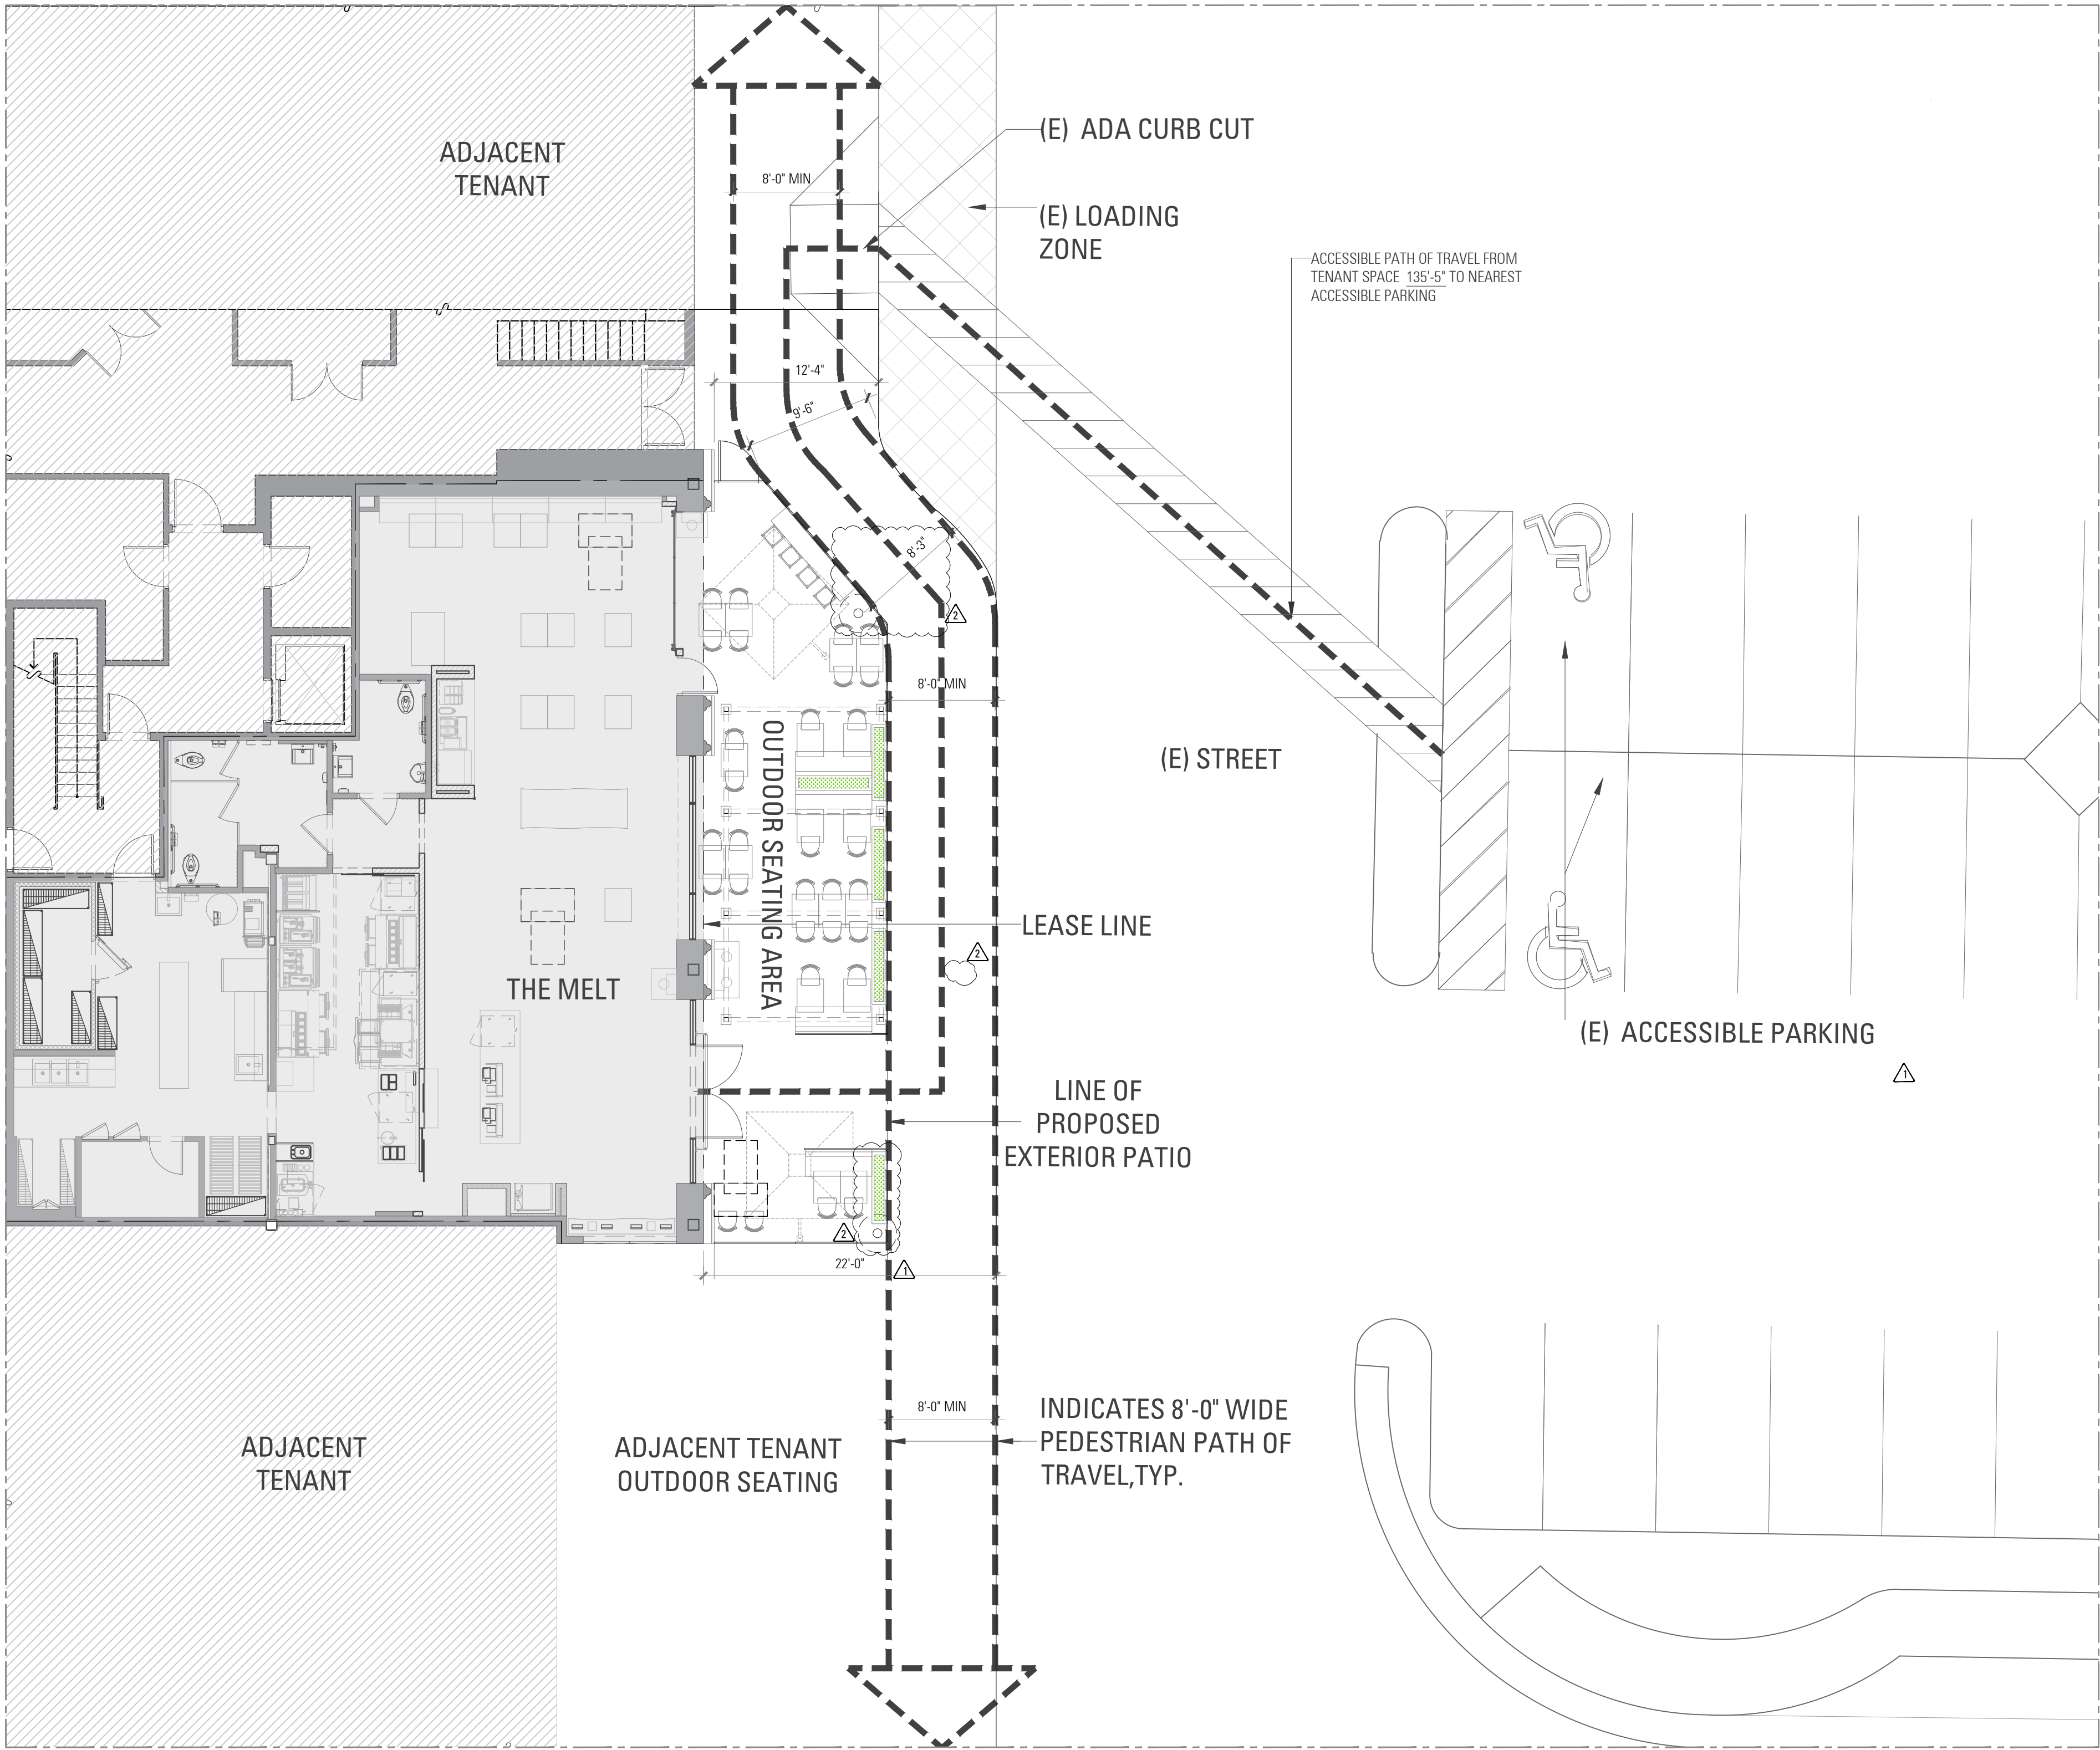

1 ENLARGED SITE PLAN WITH CIRCULATION
1/8" = 1'-0"

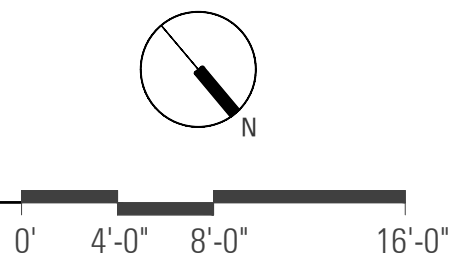

HAZARD AND EGRESS NOTES

1. PROVIDE 80° HEADROOM FROM THE WALKWAY SURFACE TO ANY OVERHANGING OBSTRUCTION
 2. HEADROOM OF 80° MINIMUM SHALL BE MAINTAINED FOR WALKS, CORRIDORS, AISLES, ETC
 3. OBSTRUCTIONS WITHIN THE WALK PATHWAY (i.e. POLES OR FIRE HYDRANTS SHALL PROVIDE A 36° MIN. CLEAR WIDTH TO THE EDGE OF THE WALK.
 4. PROTRUDING OBJECTS WITH LEADING EDGES BETWEEN 27° AND 80° ABOVE THE FINISHED FLOOR ABOVE THE FINISHED FLOOR LEVEL SHALL NOT PROTRUDE MORE THEN 4" INTO WALKS, CORRIDORS, ETC.
 5. OBJECTS WITH PROTRUDING EDGES LESS THAN 27° ABOVE THE FINISHED FLOOR MAY PROTRUDE ANY AMOUNT.
 6. FREE-STANDING OBJECTS MOUNTED ON POSTS BETWEEN 27° AND 80° ABOVE THE FLOOR MAY PROJECT A MINIMUM OF 12".
 7. NOT USED.
 8. ABRUPT CHANGES IN LEVEL OF 4" OR MORE ADJACENT TO WALKS, EXCEPT BETWEEN WALKS AND ADJACENT STREETS OR DRIVES, SHALL BE IDENTIFIED BY 6" HIGH WARNING CURBS ABOVE THE WALK SURFACE.
- NOTE: PRIOR TO STOCKING THE STORE, THE FOLLOWING SHALL BE COMPLETED IN ORDER:
- A. A COMPLETED SAFE PATH OF TRAVEL IS PROVIDED INSIDE THE BUILDING.
 - B. THE INSIDE SHALL BE COMPLETED AND SIGNED OFF BY THE BUILDING INSPECTOR.
 - C. THE FIRE DEPARTMENT PROVIDED A RELEASE FOR STOCKING SHELVES
 - D. THE BUILDING INSPECTOR HAS THE FINAL WORD IF IT WILL BE SAFE FOR EMPLOYEES TO STOCK SHELVING IN A CONSTRUCTION SITE.

NOTES

EXISTING ACCESSIBLE PARKING, SITE, ACCESSIBLE SIGNAGE EXTERIOR ACCESSIBLE ROUTES OF TRAVEL FROM THE PRIMARY ENTRANCE DOORS AND SIGNS ARE EXISTING AND SHALL BE IN COMPLIANCE WITH CURRENT CODES

PLAN LEGEND

EXISTING BASE BUILDING - NOT IN TENANT PROJECT SCOPE

AREA NOT IN EXTERIOR SCOPE OF WORKEXISTING WALL

ARCHITECT:

KATHRYN CULLEY-RAPATA, AIA
CA LICENSE NO. C-31564
CONTACT: KATE CULLEY-RAPATA
PH: 510-459-5136

STAMP & SEAL:

PROJECT CONSULTANT:

globeatelié

2041 EAST STREET PMB 475
CONCORD CA 94520

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CLIENT:

THE MELT, STANFORD

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PALO ALTO, CALIFORNIA 94304

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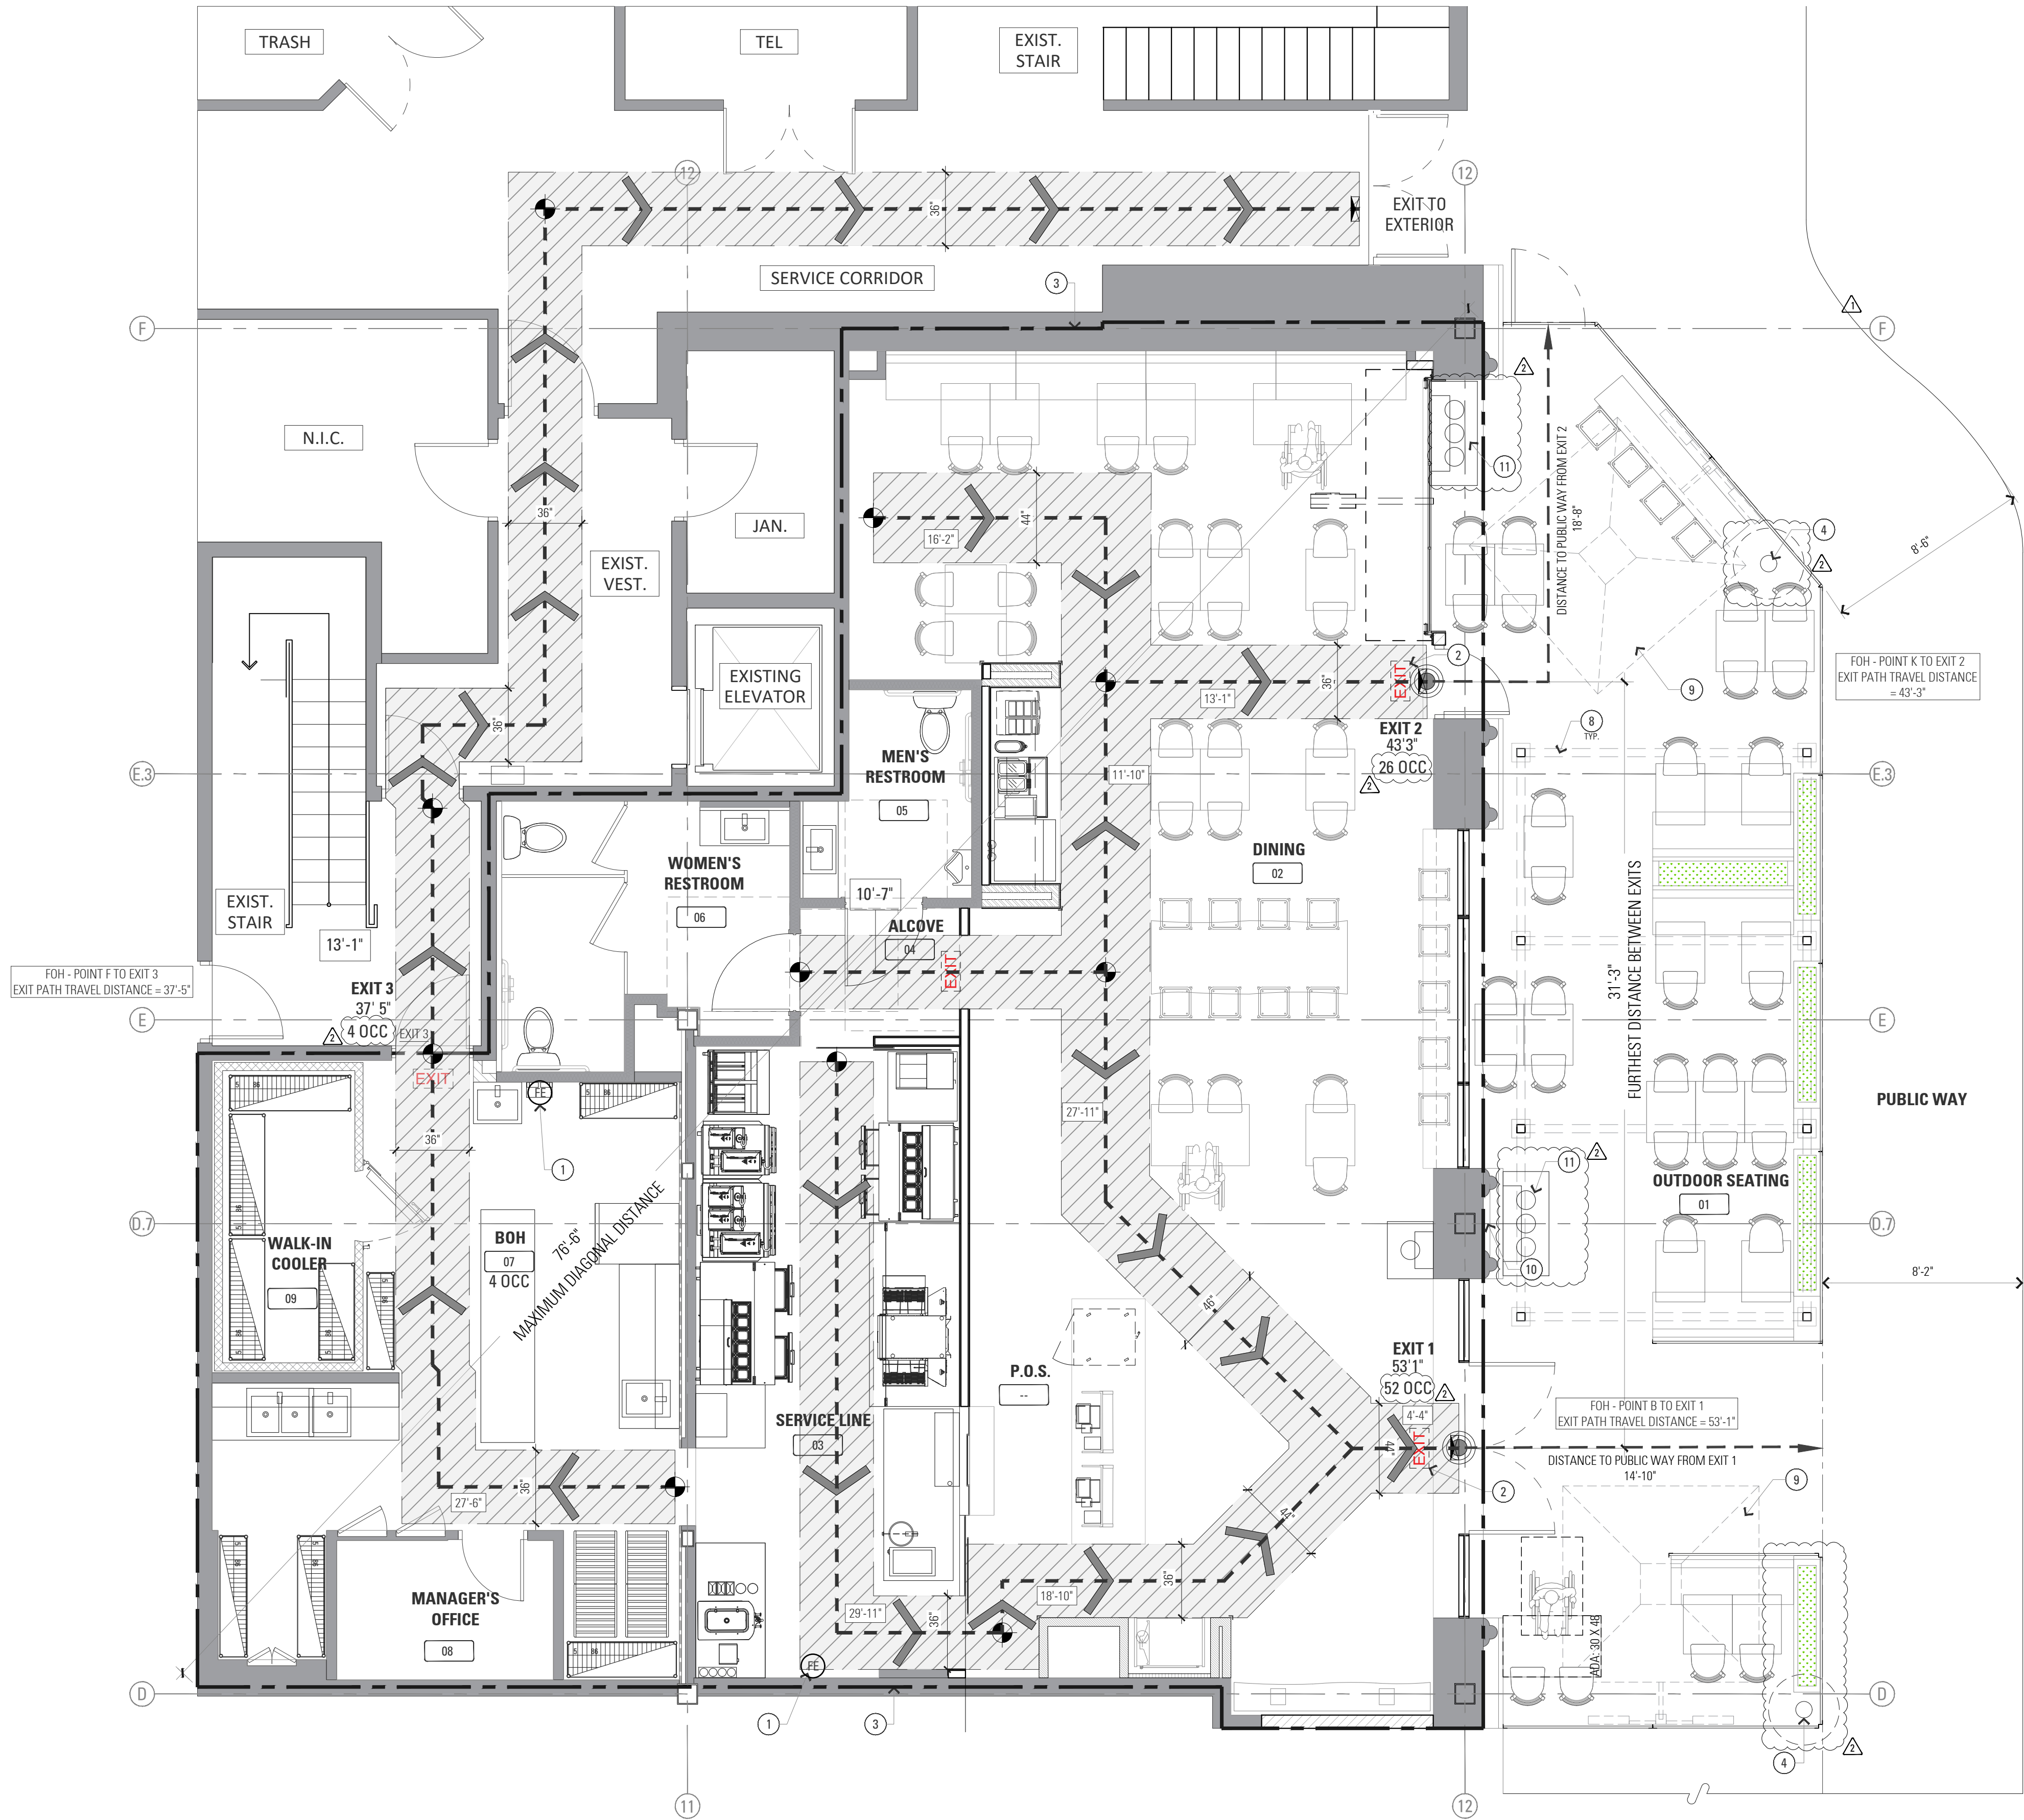
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SHEET TITLE

ENLARGED SITE
PLAN WITH
CIRCULATION

SHEET NUMBER

G00.21



LIFE SAFETY KEYNOTES

- 1 FIRE EXTINGUISHER LOCATION
- 2 EXIT SIGN
- 3 1 HOUR SEPARATION
- 4 RELOCATED STREET LIGHTS
- 5 NOT USED
- 6 NOT USED
- 7 NOT USED
- 8 TUUCI SOLANOX CABANA - 12' X 24' WITH HEATER AND TRELLIS. SEE SHEET X.04 FOR MORE INFORMATION.
- 9 TUUCI OCEAN MASTER MAX CANTILEVER UMBRELLA 8' X 8' WITH RADIANT HEATER. SEE SHEET X.04 FOR MORE INFORMATION.
- 10 BRASS BRAILLE "THE MELT" PLAQUE. (SEE DETAIL)
- 11 COLOR-CODED THREE-DIRECTION REFUSE CONTAINER.

BRASS BRAILLE "THE MELT" PLAQUE DETAIL



COMPLIANCE NOTES

THIS PROJECT CONSISTS OF THE BUILD-OUT OF A RETAIL TENANT. DUE TO THE NATURE OF THE PROJECT, THE SCOPE OF CONSTRUCTION WITHIN THE DOCUMENTS CONSISTS ONLY OF AREA WITHIN THE LEASED PREMISES.

ALL ASPECTS OF THIS PROJECT REQUIRED TO CONFORM TO ACCESSIBILITY REQUIREMENTS FOR FEDERAL GUIDELINES SHALL ALSO DO.

- EXTINGUISHERS:
- G.C. TO PROVIDE MIN. OF 1 FIRE EXTINGUISHERS. G.C. TO VERIFY AND COORDINATE LOCATIONS AND QUANTITIES WITH LOCAL FIRE MARSHAL.
 - NFPA INSPECTION TAGS SHALL BE ATTACHED TO ALL FIRE EXTINGUISHERS.
 - PORTABLE FIRE EXTINGUISHERS SHALL BE PROVIDED PER LOCAL FIRE CODE. TYPE AND LOCATIONS OF EXTINGUISHERS SHALL BE AS DIRECTED BY THE FIRE DEPARTMENT.

LIFE SAFTEY LEGEND

- DIRECTION OF TRAVEL
- EXIT
- 36" MIN. EGRESS EXIT PATH
- EXIT ACCESS TRAVEL DISTANCE
- EXIT SIGN
- FIRE EXTINGUISHER, TYPE K

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CA LICENSE NO. C-31564
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PH: 510-459-5136

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PROJECT CONSULTANT:

globeateliê
2041 EAST STREET PMB. 475
CONCORD CA 94520

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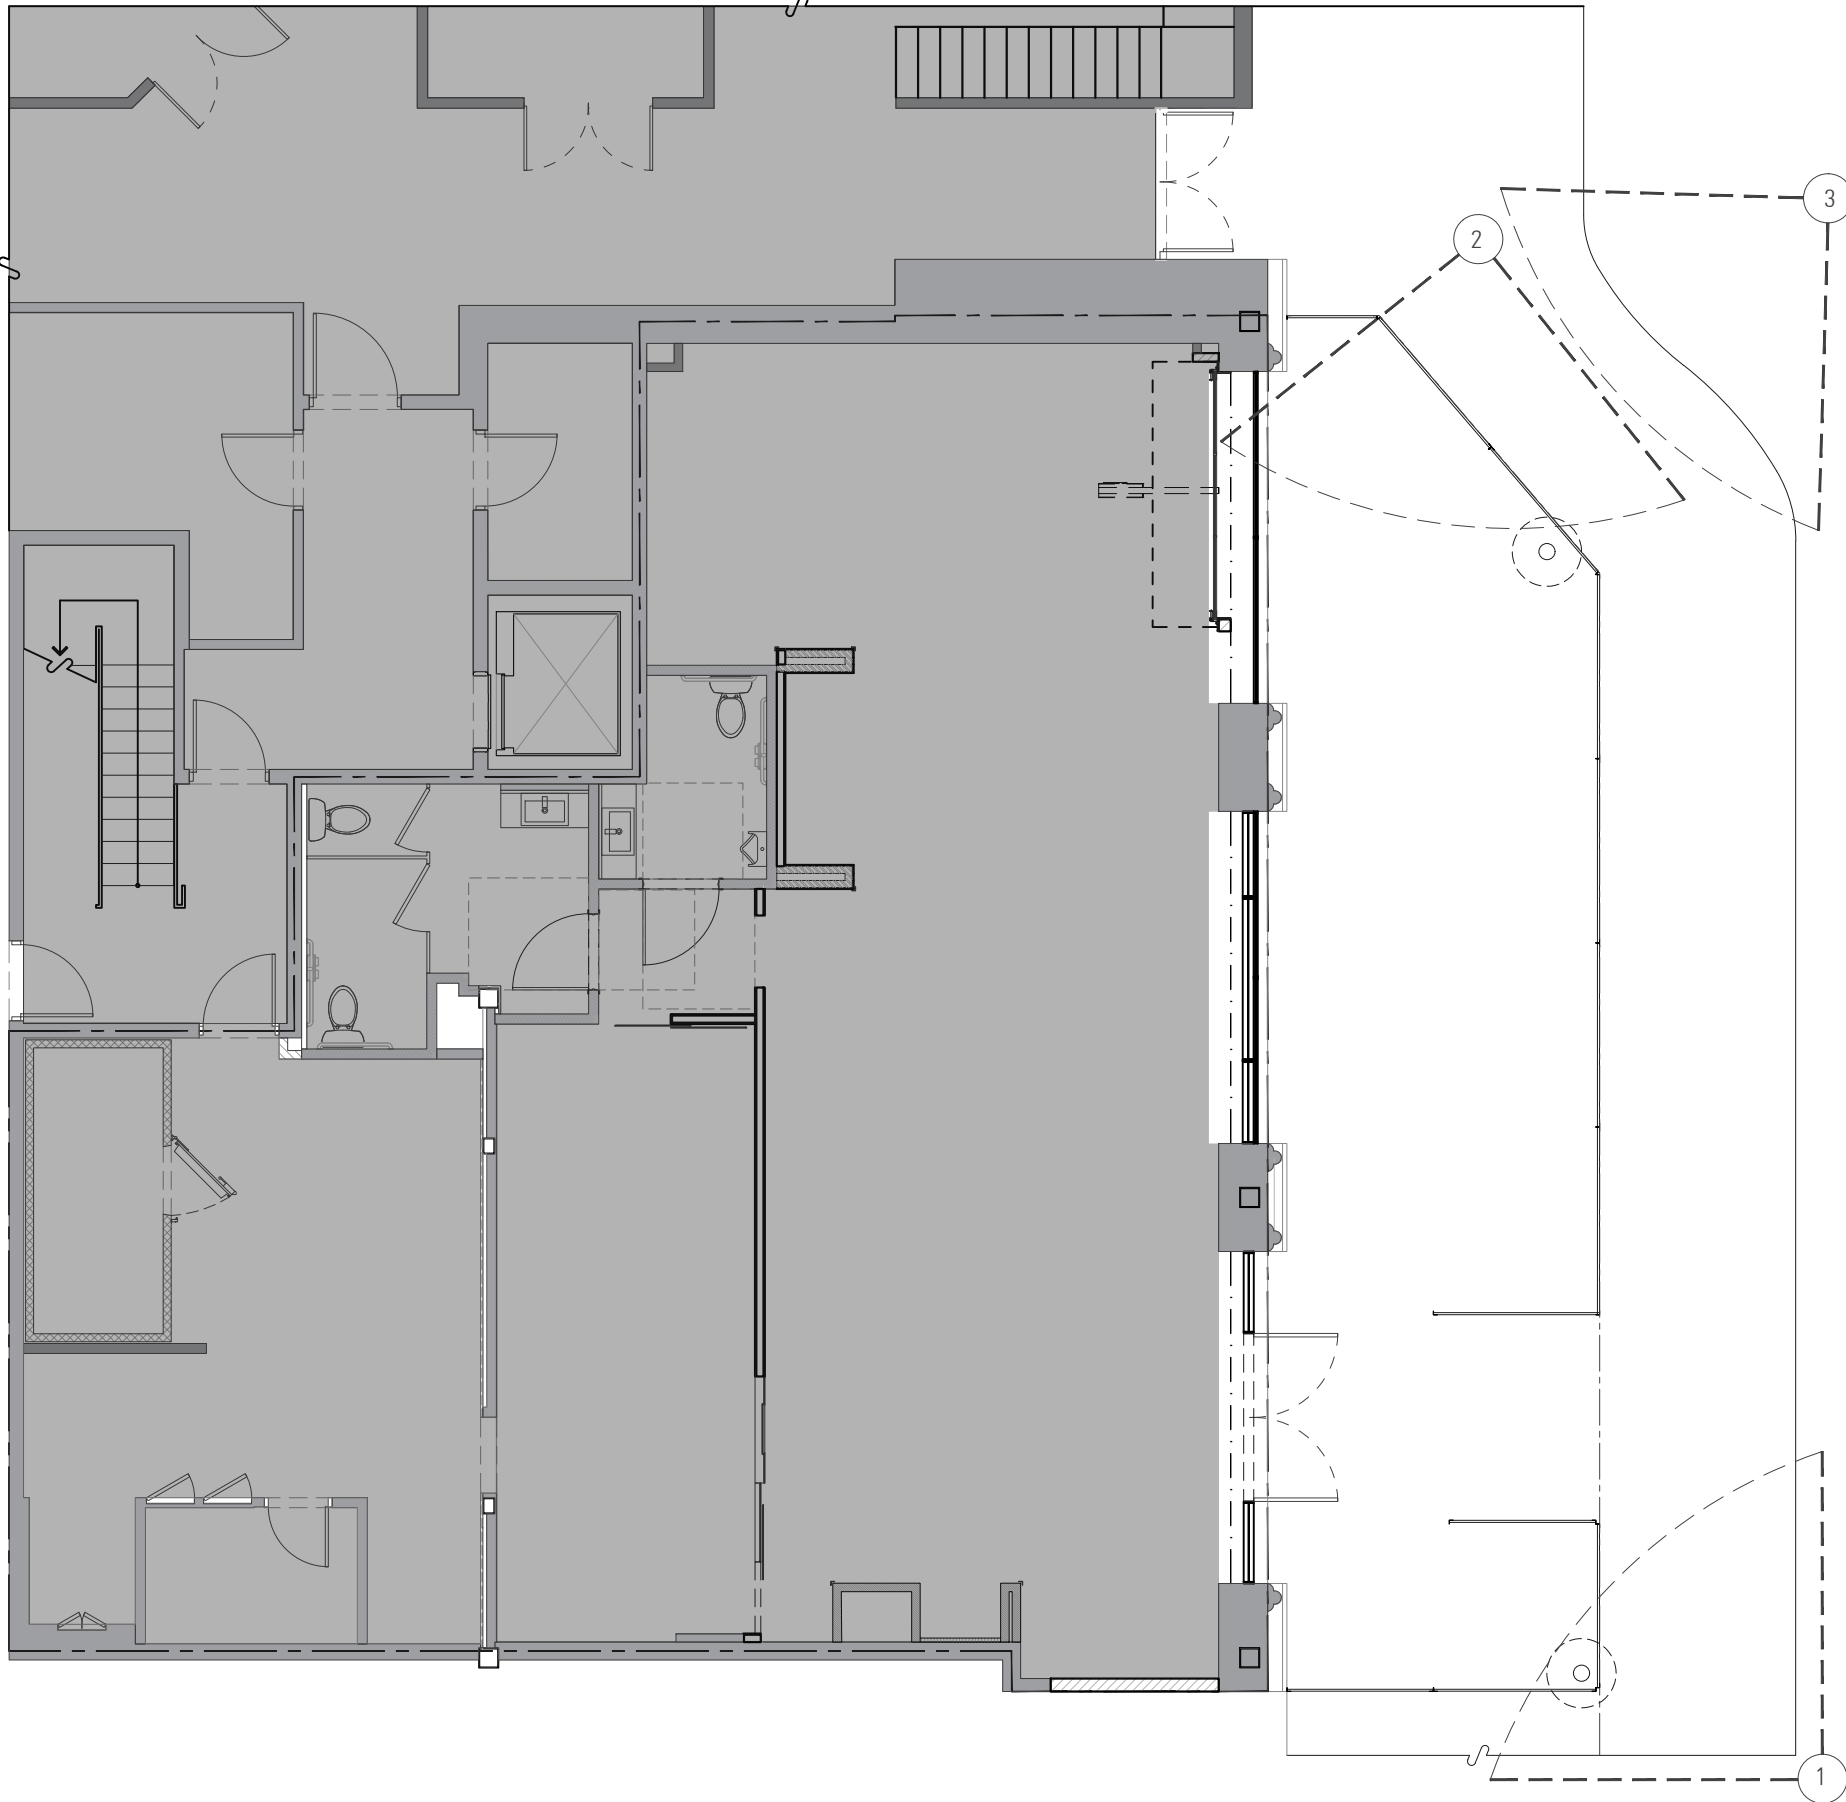
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SHEET TITLE

LIFE SAFETY PLAN

SHEET NUMBER

G00.30

KEY PLAN




EXISTING



NOTE:
CABANA WITH OPERABLE LOUVERS.
SEE DETAIL 1/X.04

PROPOSED

1 VIEW
N.T.S.

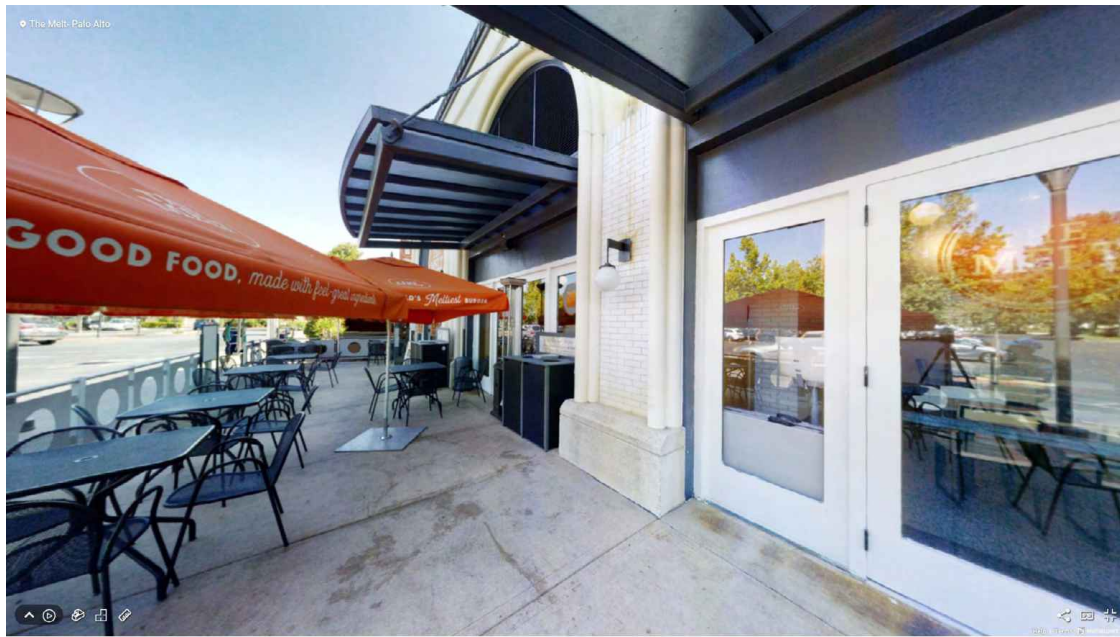

EXISTING



PROPOSED

2 VIEW
N.T.S.



EXISTING



3 VIEW
N.T.S.



PROPOSED

ARCHITECT:

KATHRYN CULLEY-RAPATA, AIA
CA LICENSE NO. C-31564
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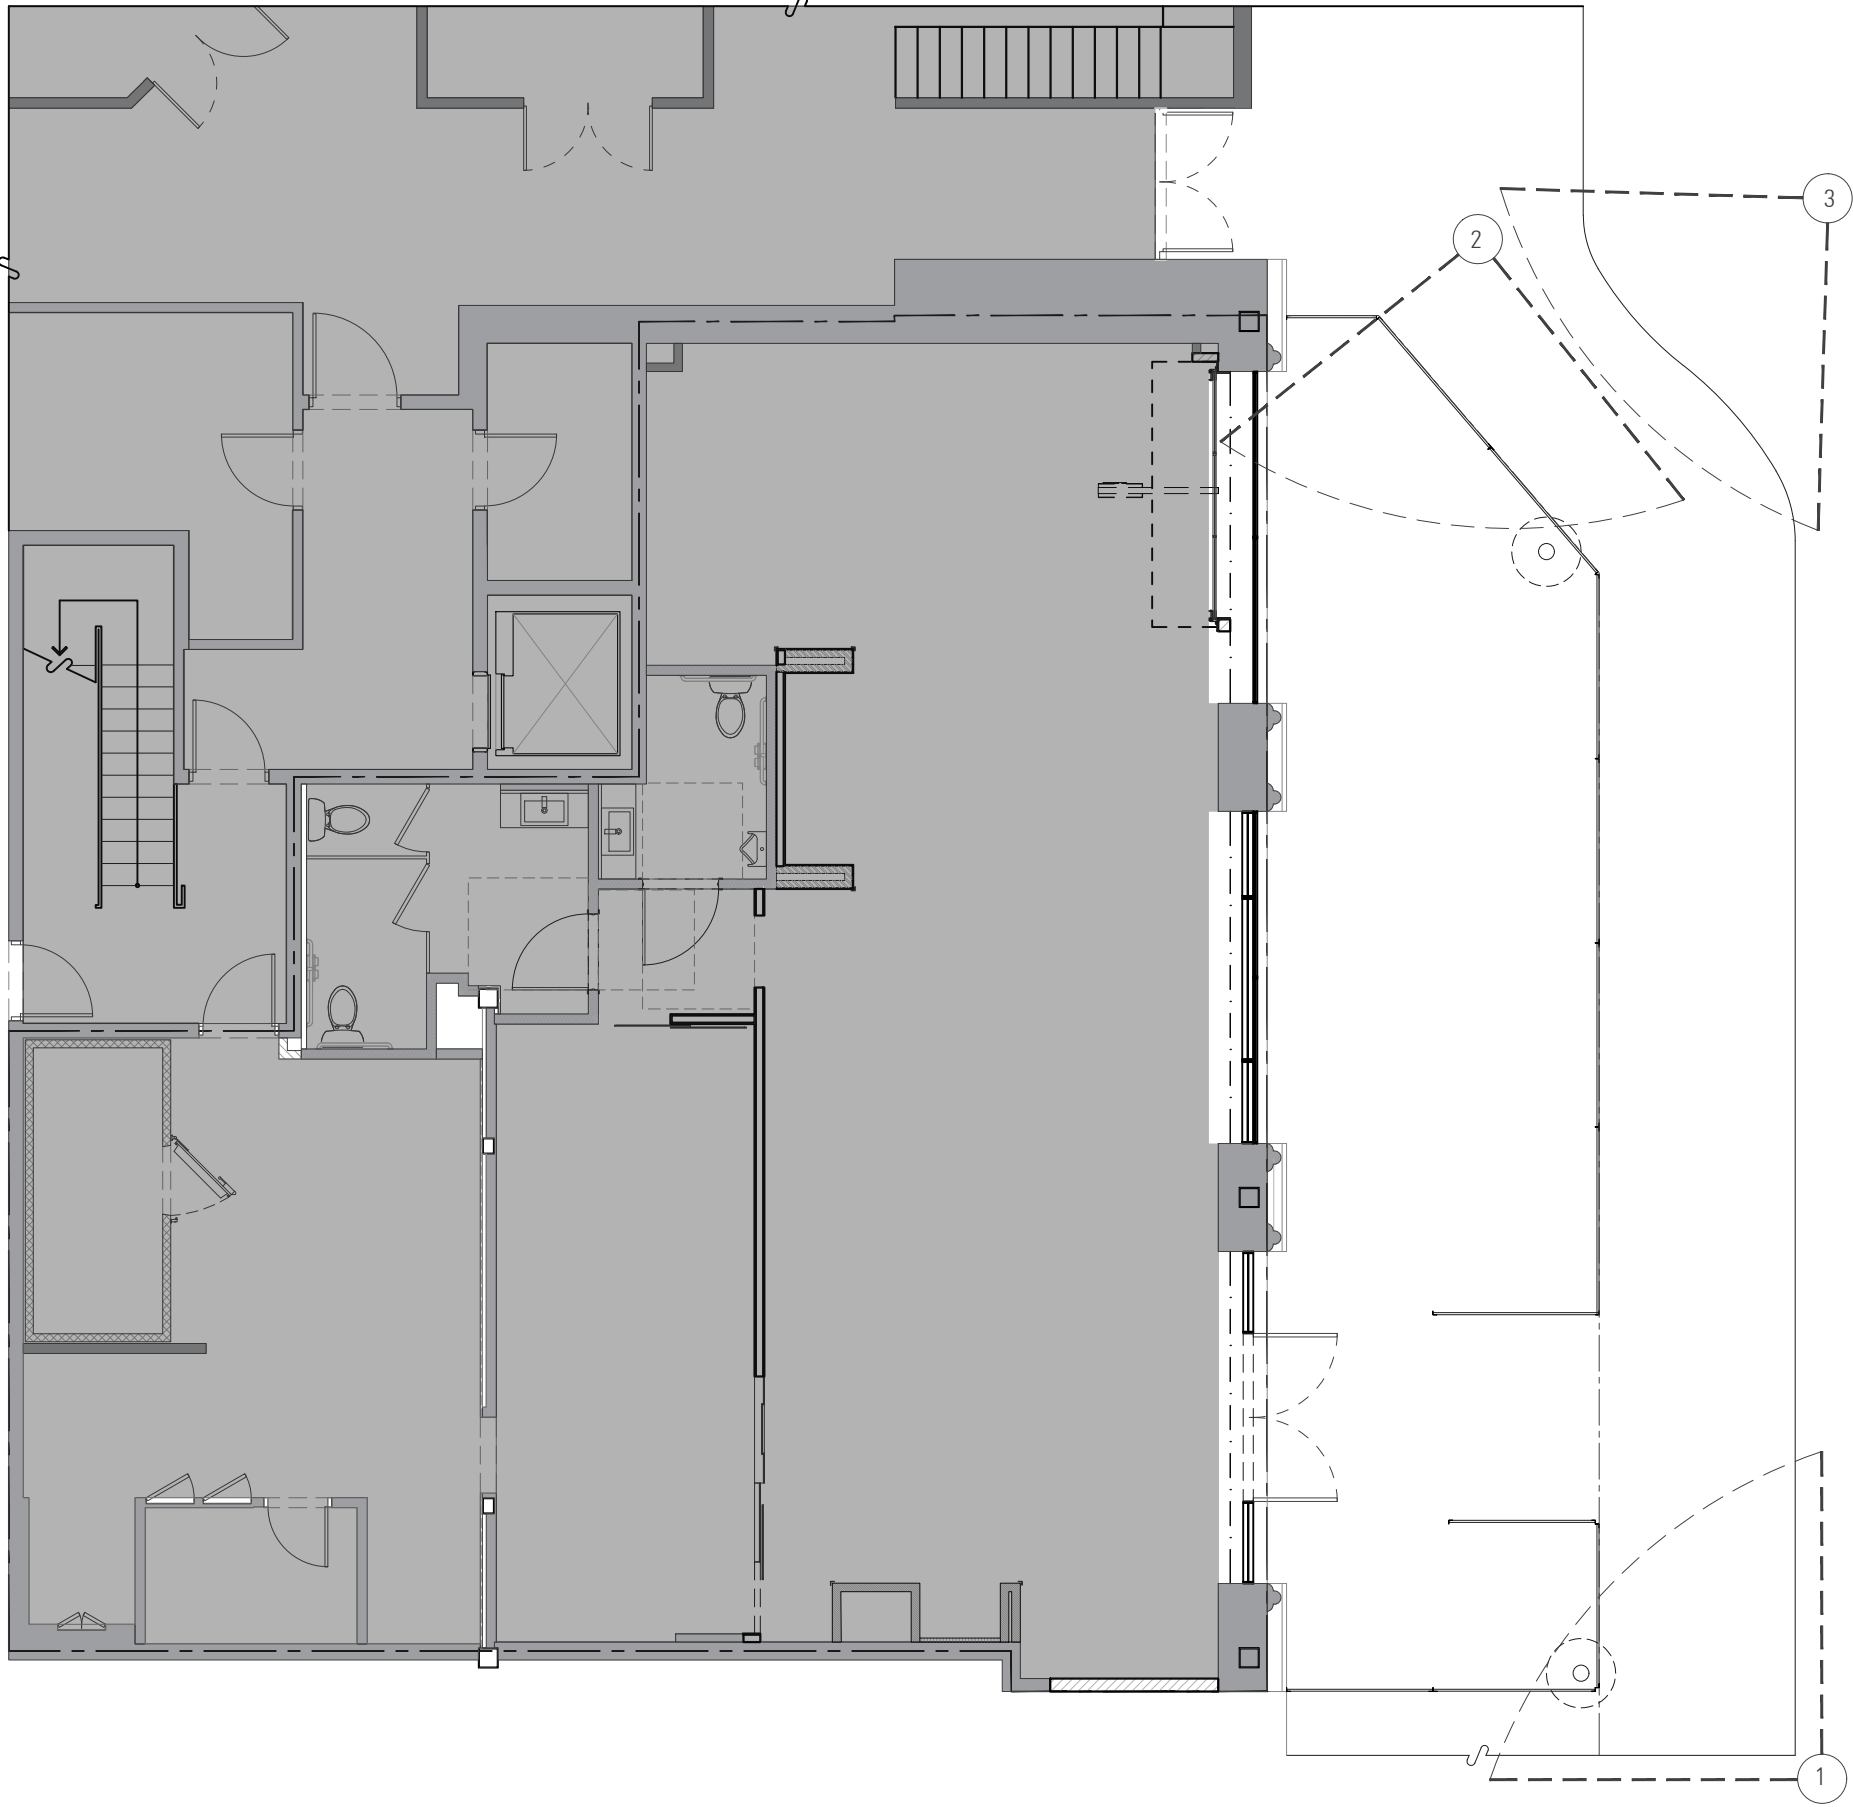
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**SITE CONTEXT AND
RENDERINGS**

SHEET NUMBER

G00.40A

KEY PLAN




EXISTING



PROPOSED

1 VIEW
N.T.S.

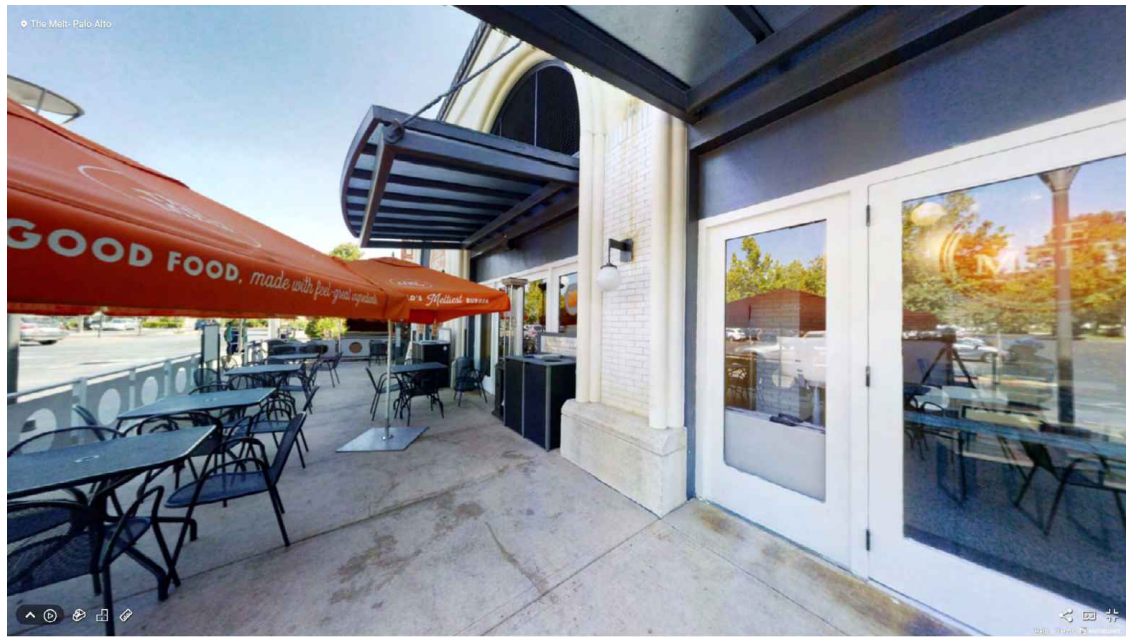

EXISTING



PROPOSED

2 VIEW
N.T.S.



EXISTING



PROPOSED

3 VIEW
N.T.S.

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SITE CONTEXT AND RENDERINGS

SHEET NUMBER

G00.40B

1 DEMOLITION PLAN
1/4" = 1'-0"



KEY NOTES

- 1 LEASE LINE.
- 2 EXTERIOR WALL TO REMAIN. SEE STOREFRONT DEMO ELEVATIONS FOR MORE INFO.
- 3 REMOVE EXISTING DOOR.
- 4 REMOVE EXISTING STOREFRONT.
- 5 REMOVE ALL EXISTING TABLES, CHAIRS, AND TRASH ENCLOSURES IN COMPLIANCE WITH NEW SEATING PLAN LAYOUT
- 6 REMOVE EXISTING FENCE. PATCH & REPAIR PAVING AS REQUIRED, COORDINATE WITH NEW FENCE DETAILS AND LOCATION.
- 7 EXISTING CURB TO REMAIN. PATCH & REPAIR IF DAMAGED DURING CONSTRUCTION.
- 8 EXISTING EXTERIOR ARCHITECTURAL FEATURES TO REMAIN. PATCH AND REPAIR AS NEEDED TO RECEIVE NEW FINISHES.
- 9 EXISTING EXTERIOR PAVING TO REMAIN. CLEAN, PATCH AND REPAIR AS NEEDED. COORDINATE WITH THE MELT AND WITH LANDLORD FOR SPECIFIC REQUIREMENTS.
- 10 REMOVE EXISTING FABRIC BANNER SIGNAGE AND MOUNTING BRACKETS ATTACHED TO STUCCO SURFACE. PATCH AND REPAIR SURFACE TO RECEIVE NEW FINISHES. PREPARE FOR MOUNTING OF NEW BLADE SIGN. ⚠
- 11 REMOVE EXISTING BANNER LIGHTING / EXTERIOR LIGHTS / SURFACE MOUNTED LIGHTING FOR SIGNAGE ILLUMINATION. KEEP EXISTING J-BOXES AND POWER FOR FUTURE LIGHTING; SEE EXTERIOR ELEVATIONS.
- 12 REMOVE EXISTING DOORS AND FRAMES. PREPARE FOR INFILL. ⚠
- 13 REMOVE ARCH INFILL. REFER TO DEMO ELEVATION SHEET D3.0 FOR EXTENTS VERIFY STRUCTURE AND COORDINATE WITH ARCHITECT IF REQUIRED.
- 14 REMOVE EXISTING EXTERIOR CANOPY. PATCH & REPAIR SURFACE TO RECEIVE NEW FINISHES.
- 15 REMOVE EXISTING EXTERIOR AWNING. PATCH & REPAIR SURFACE TO RECEIVE NEW FINISHES.
- 16 REMOVE EXISTING NON-FUNCTIONAL METAL LOUVERS ⚠
- 17 NOT USED
- 18 (E) STREET LIGHT TO BE RELOCATED. PATCH AND REPAIR SIDEWALK AS NEEDED. ⚠
- 19 EXISTING ENTRY DOOR TO REMAIN
- 20 EXISTING STOREFRONT TO REMAIN. FRAMES TO BE PAINTED P3 SW6258- TRICORN BLACK/ POWDER COAT, MATTE
- 21 PREPARE EXISTING MOULDING AT ARCHES TO RECEIVE NEW TRIM.

DEMO PLAN NOTES

- GENERAL:
1. DIMENSIONS SHOWN ARE TO THE FACE OF FINISH.
 2. G.C. TO COORDINATE PERMIT, APPROVALS, AND LOCATION OF DUMPSTER AND STORAGE UNIT PRIOR TO REQUIRED STORE CLOSING
 3. U.O.N. ALL WALL ELECTRICAL RECEPTACLES ARE TO REMAIN.
 4. AUTOMATIC SPRINKLER SYSTEM TO REMAIN OPERATIONAL AT ALL TIMES EXCEPT AS COORDINATED WITH THE MELT PM.
 5. REVIEW ANY POTENTIAL DISRUPTION TO RESTAURANT OPERATIONS IN ADVANCE WITH THE MELT PM.


PLAN LEGEND

EXISTING BASE BUILDING - NOT IN TENANT PROJECT SCOPE

AREA NOT IN EXTERIOR SCOPE OF WORK

EXISTING WALL

KEY PLAN

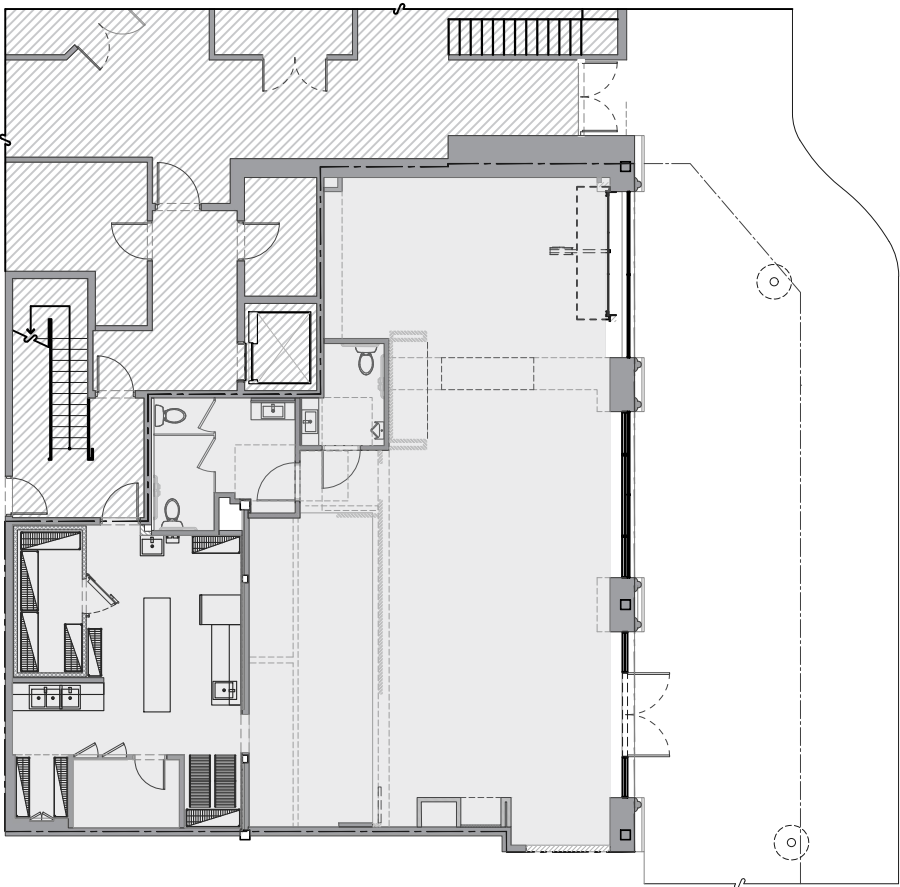

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KATHRYN CULLEY-RAPATA, AIA
CA LICENSE NO. C-31564
CONTACT: KATE CULLEY-RAPATA
PH: 510-459-5136

STAMP & SEAL:

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globeateliè
2041 EAST STREET PMB 475
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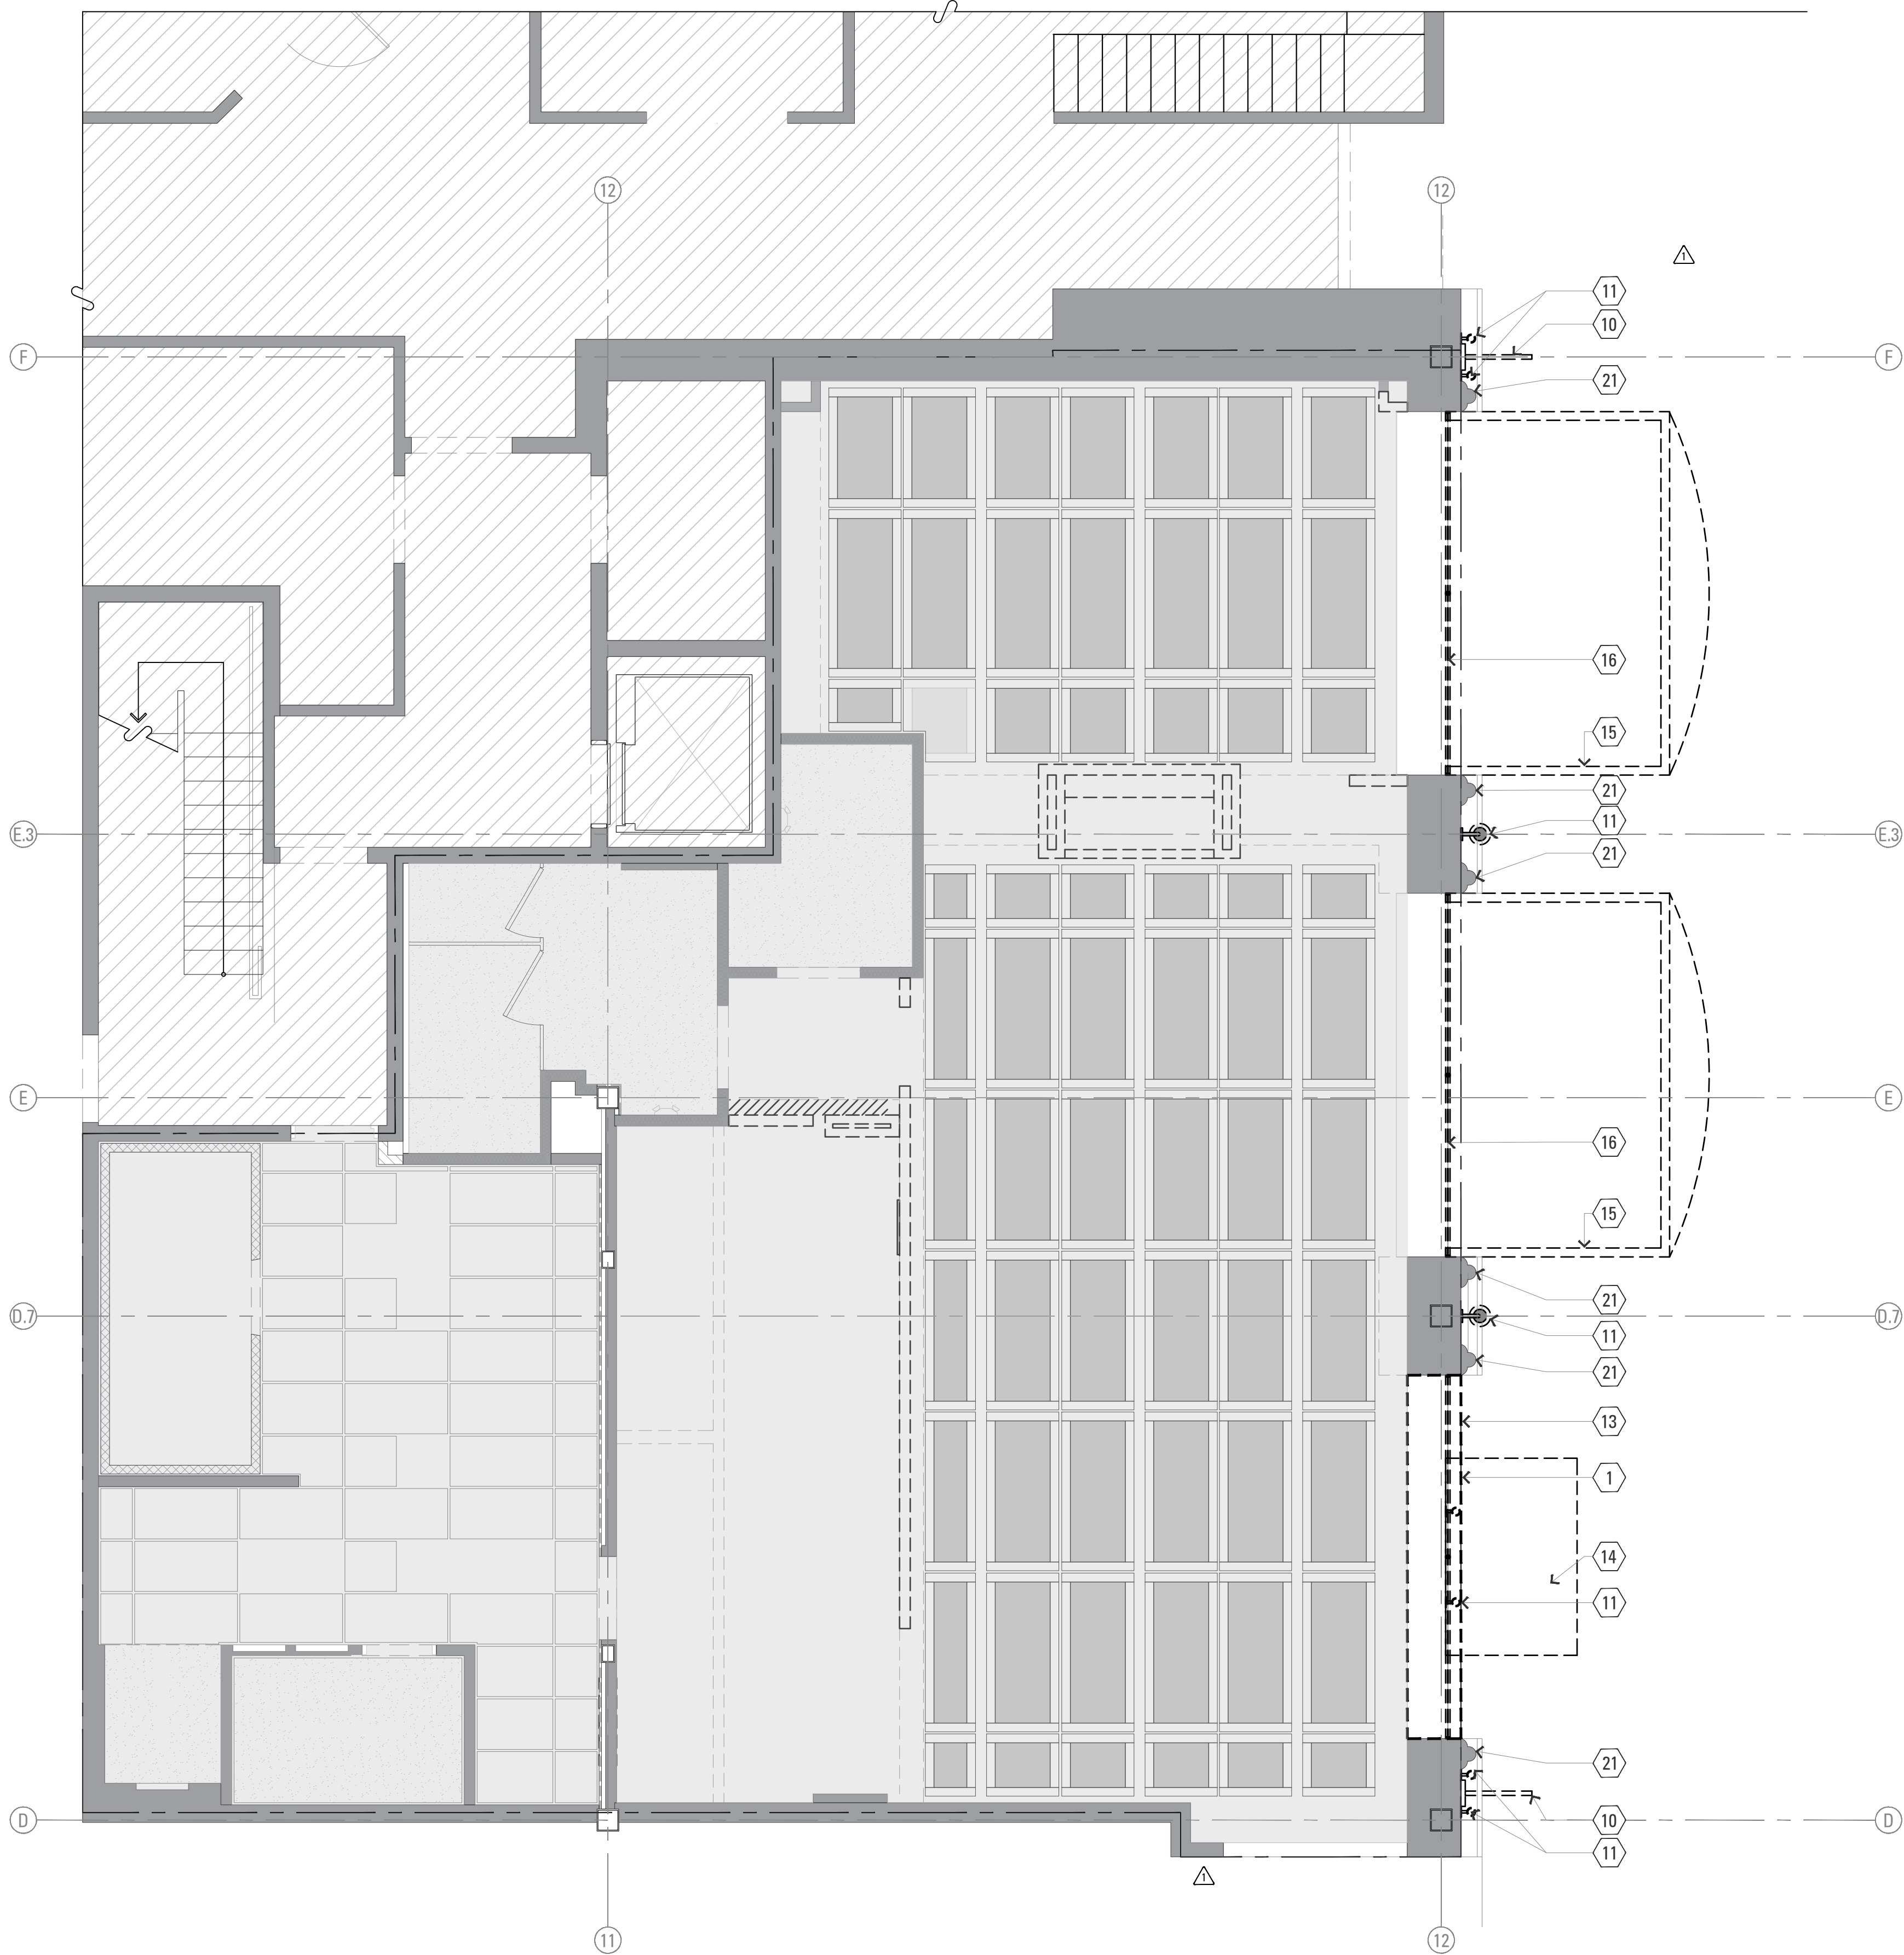
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SHEET TITLE

DEMOLITION PLAN

SHEET NUMBER

D01.01A



2 DEMOLITION REFLECTED CEILING PLAN
1/4" = 1'-0"

KEY NOTES

- 1 LEASE LINE.
- 2 EXTERIOR WALL TO REMAIN. SEE STOREFRONT DEMO ELEVATIONS FOR MORE INFO.
- 3 REMOVE EXISTING DOOR.
- 4 REMOVE EXISTING STOREFRONT.
- 5 REMOVE ALL EXISTING TABLES, CHAIRS, AND TRASH ENCLOSURES IN COMPLIANCE WITH NEW SEATING PLAN LAYOUT
- 6 REMOVE EXISTING FENCE. PATCH & REPAIR PAVING AS REQUIRED, COORDINATE WITH NEW FENCE DETAILS AND LOCATION.
- 7 EXISTING CURB TO REMAIN. PATCH & REPAIR IF DAMAGED DURING CONSTRUCTION.
- 8 EXISTING EXTERIOR ARCHITECTURAL FEATURES TO REMAIN. PATCH AND REPAIR AS NEEDED TO RECEIVE NEW FINISHES.
- 9 EXISTING EXTERIOR PAVING TO REMAIN. CLEAN, PATCH AND REPAIR AS NEEDED. COORDINATE WITH THE MELT AND WITH LANDLORD FOR SPECIFIC REQUIREMENTS.
- 10 REMOVE EXISTING FABRIC BANNER SIGNAGE AND MOUNTING BRACKETS ATTACHED TO STUCCO SURFACE. PATCH AND REPAIR SURFACE TO RECEIVE NEW FINISHES. PREPARE FOR MOUNTING OF NEW BLADE SIGN. ⚠
- 11 REMOVE EXISTING BANNER LIGHTING / EXTERIOR LIGHTS / SURFACE MOUNTED LIGHTING FOR SIGNAGE ILLUMINATION. KEEP EXISTING J-BOXES AND POWER FOR FUTURE LIGHTING; SEE EXTERIOR ELEVATIONS.
- 12 REMOVE EXISTING DOORS AND FRAMES. PREPARE FOR INFILL. ⚠
- 13 REMOVE ARCH INFILL. REFER TO DEMO ELEVATION SHEET D3.0 FOR EXTENTS VERIFY STRUCTURE AND COORDINATE WITH ARCHITECT IF REQUIRED.
- 14 REMOVE EXISTING EXTERIOR CANOPY. PATCH & REPAIR SURFACE TO RECEIVE NEW FINISHES.
- 15 REMOVE EXISTING EXTERIOR AWNING. PATCH & REPAIR SURFACE TO RECEIVE NEW FINISHES.
- 16 REMOVE EXISTING NON-FUNCTIONAL METAL LOUVERS ⚠
- 17 NOT USED
- 18 (E) STREET LIGHT TO BE RELOCATED. PATCH AND REPAIR SIDEWALK AS NEEDED. ⚠
- 19 EXISTING ENTRY DOOR TO REMAIN
- 20 EXISTING STOREFRONT TO REMAIN. FRAMES TO BE PAINTED P3 SW6258- TRICORN BLACK/ POWDER COAT, MATTE
- 21 PREPARE EXISTING MOULDING AT ARCHES TO RECEIVE NEW TRIM.

DEMO PLAN NOTES

GENERAL:

1. DIMENSIONS SHOWN ARE TO THE FACE OF FINISH.
2. G.C. TO COORDINATE PERMIT, APPROVALS, AND LOCATION OF DUMPSTER AND STORAGE UNIT PRIOR TO REQUIRED STORE CLOSING
3. U.O.N. ALL WALL ELECTRICAL RECEPTACLES ARE TO REMAIN.
4. AUTOMATIC SPRINKLER SYSTEM TO REMAIN OPERATIONAL AT ALL TIMES EXCEPT AS COORDINATED WITH THE MELT PM.
5. REVIEW ANY POTENTIAL DISRUPTION TO RESTAURANT OPERATIONS IN ADVANCE WITH THE MELT PM.


PLAN LEGEND

EXISTING BASE BUILDING - NOT IN TENANT PROJECT SCOPE

AREA NOT IN EXTERIOR SCOPE OF WORK

EXISTING WALL

KEY PLAN

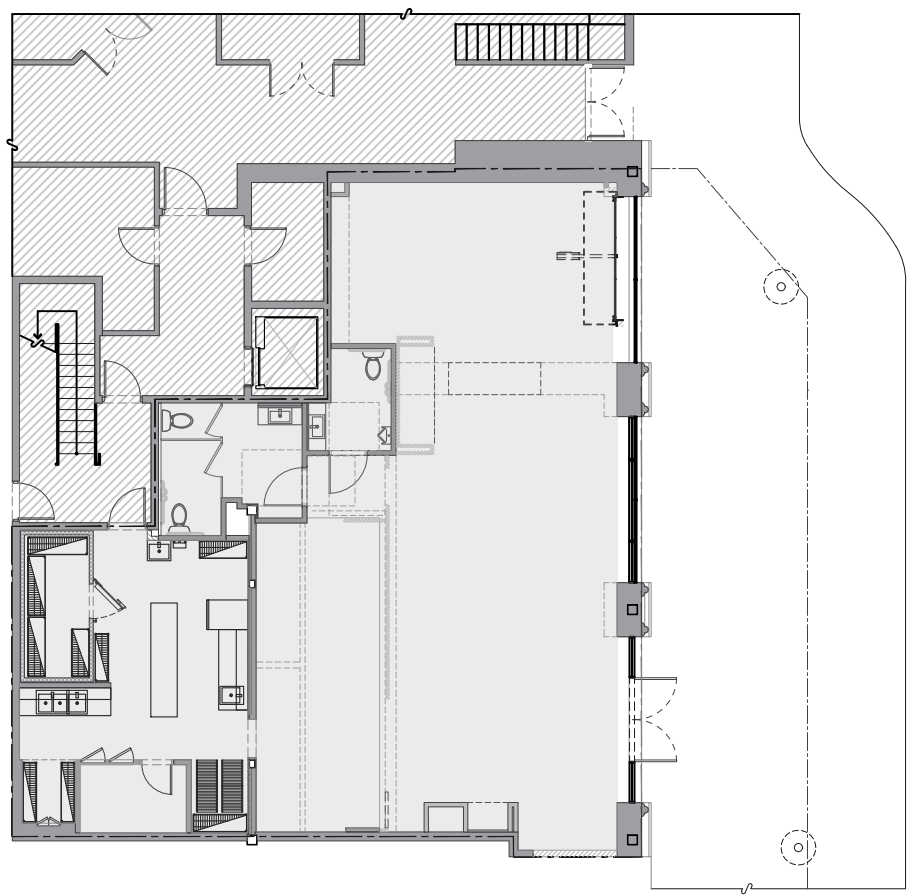

ARCHITECT:

KATHRYN CULLEY-RAPATA, AIA
CA LICENSE NO. C-31564
CONTACT: KATE CULLEY-RAPATA
PH: 510-459-5136

STAMP & SEAL:

PROJECT CONSULTANT:

globeateliè
2041 EAST STREET PMB 475
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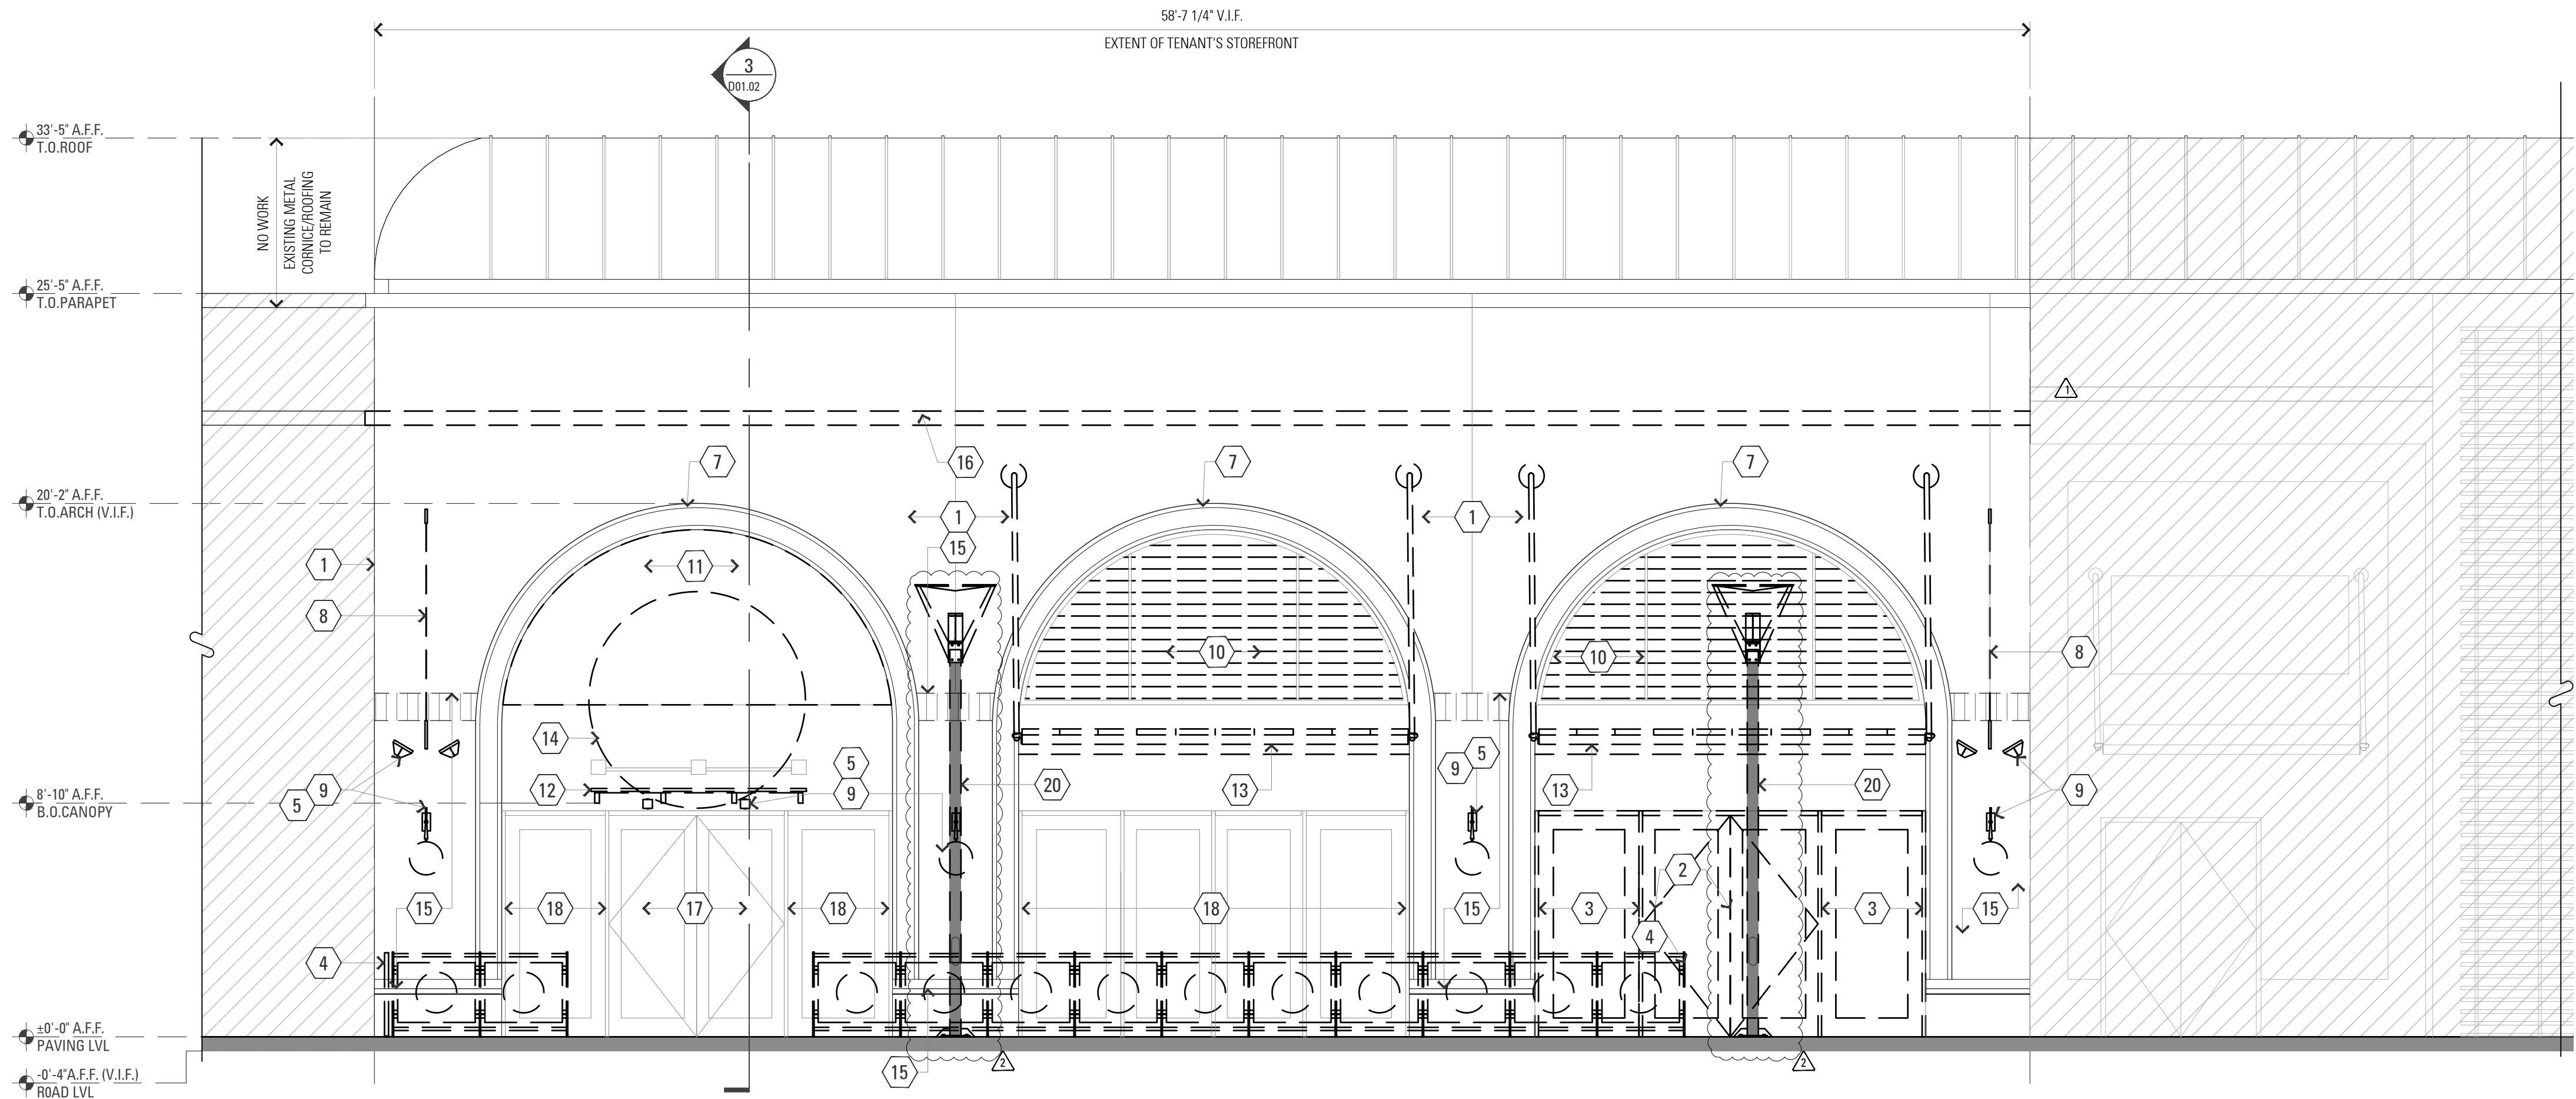
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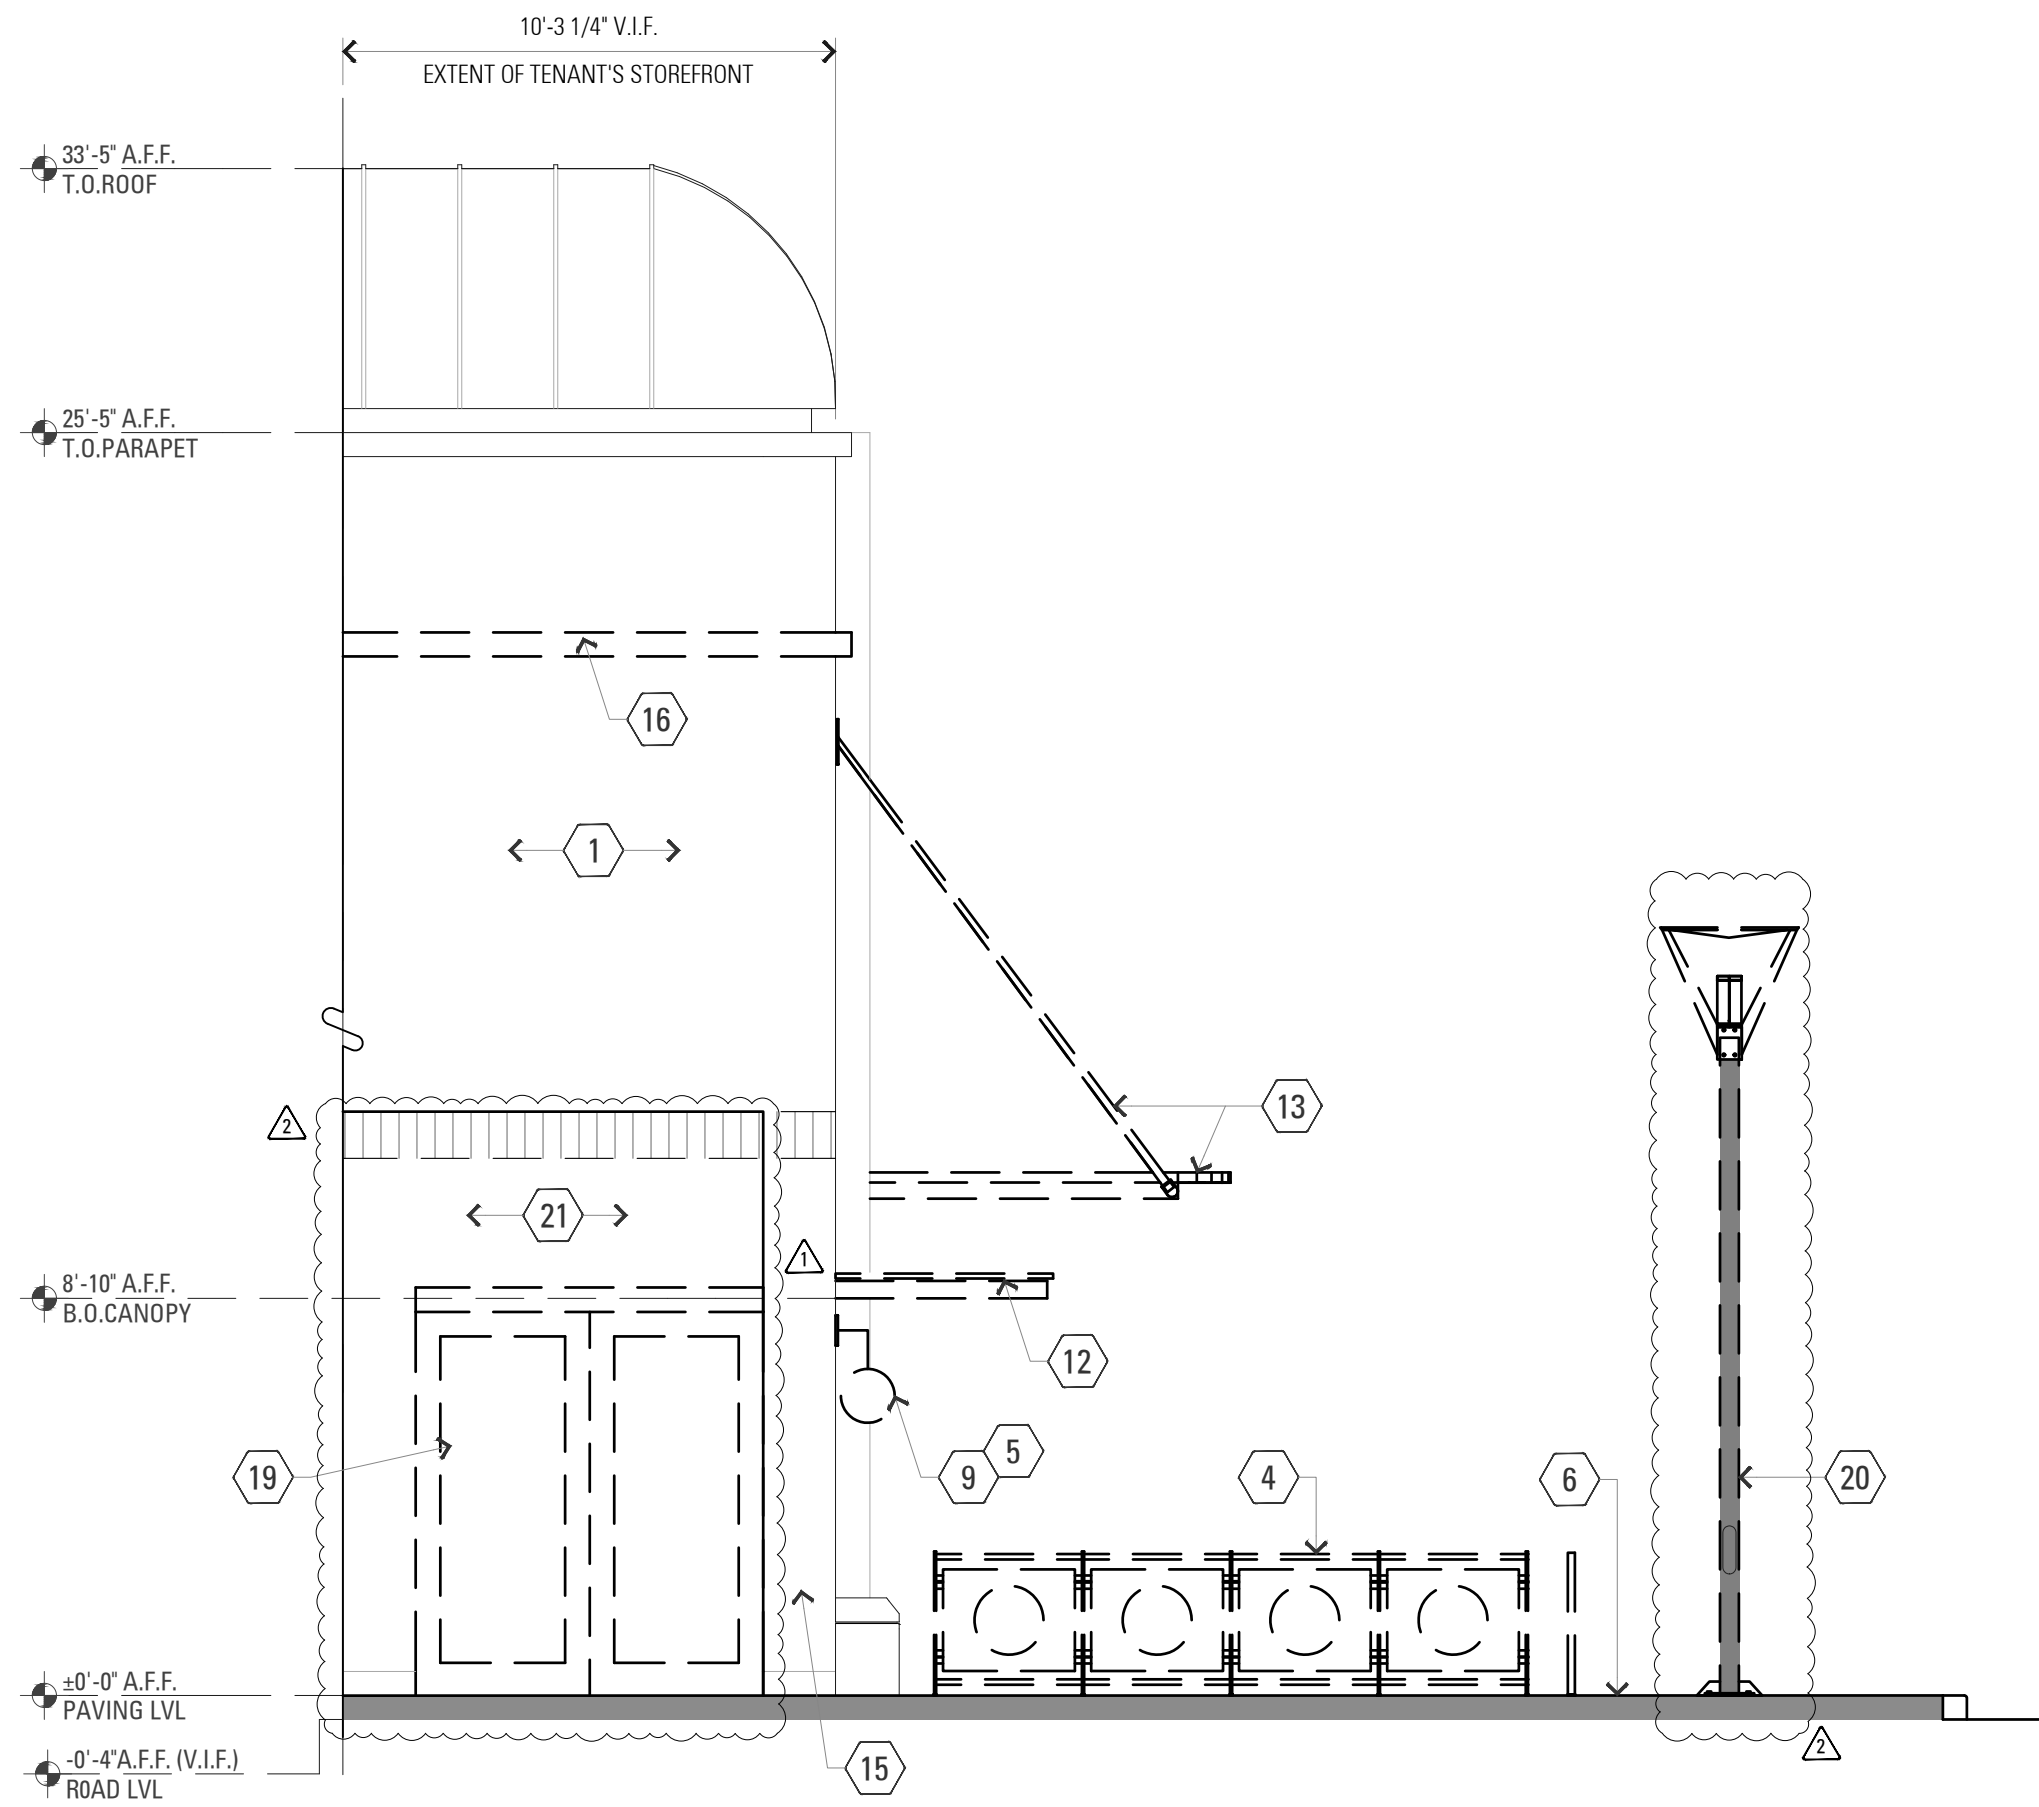
**DEMOLITION
REFLECTED CEILING
PLAN**

SHEET NUMBER


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1 DEMOLITION NORTH ELEVATION
1/4" = 1'-0"



2 DEMOLITION EAST ELEVATION
1/4" = 1'-0"



3 DEMOLITION SECTION
1/4" = 1'-0"

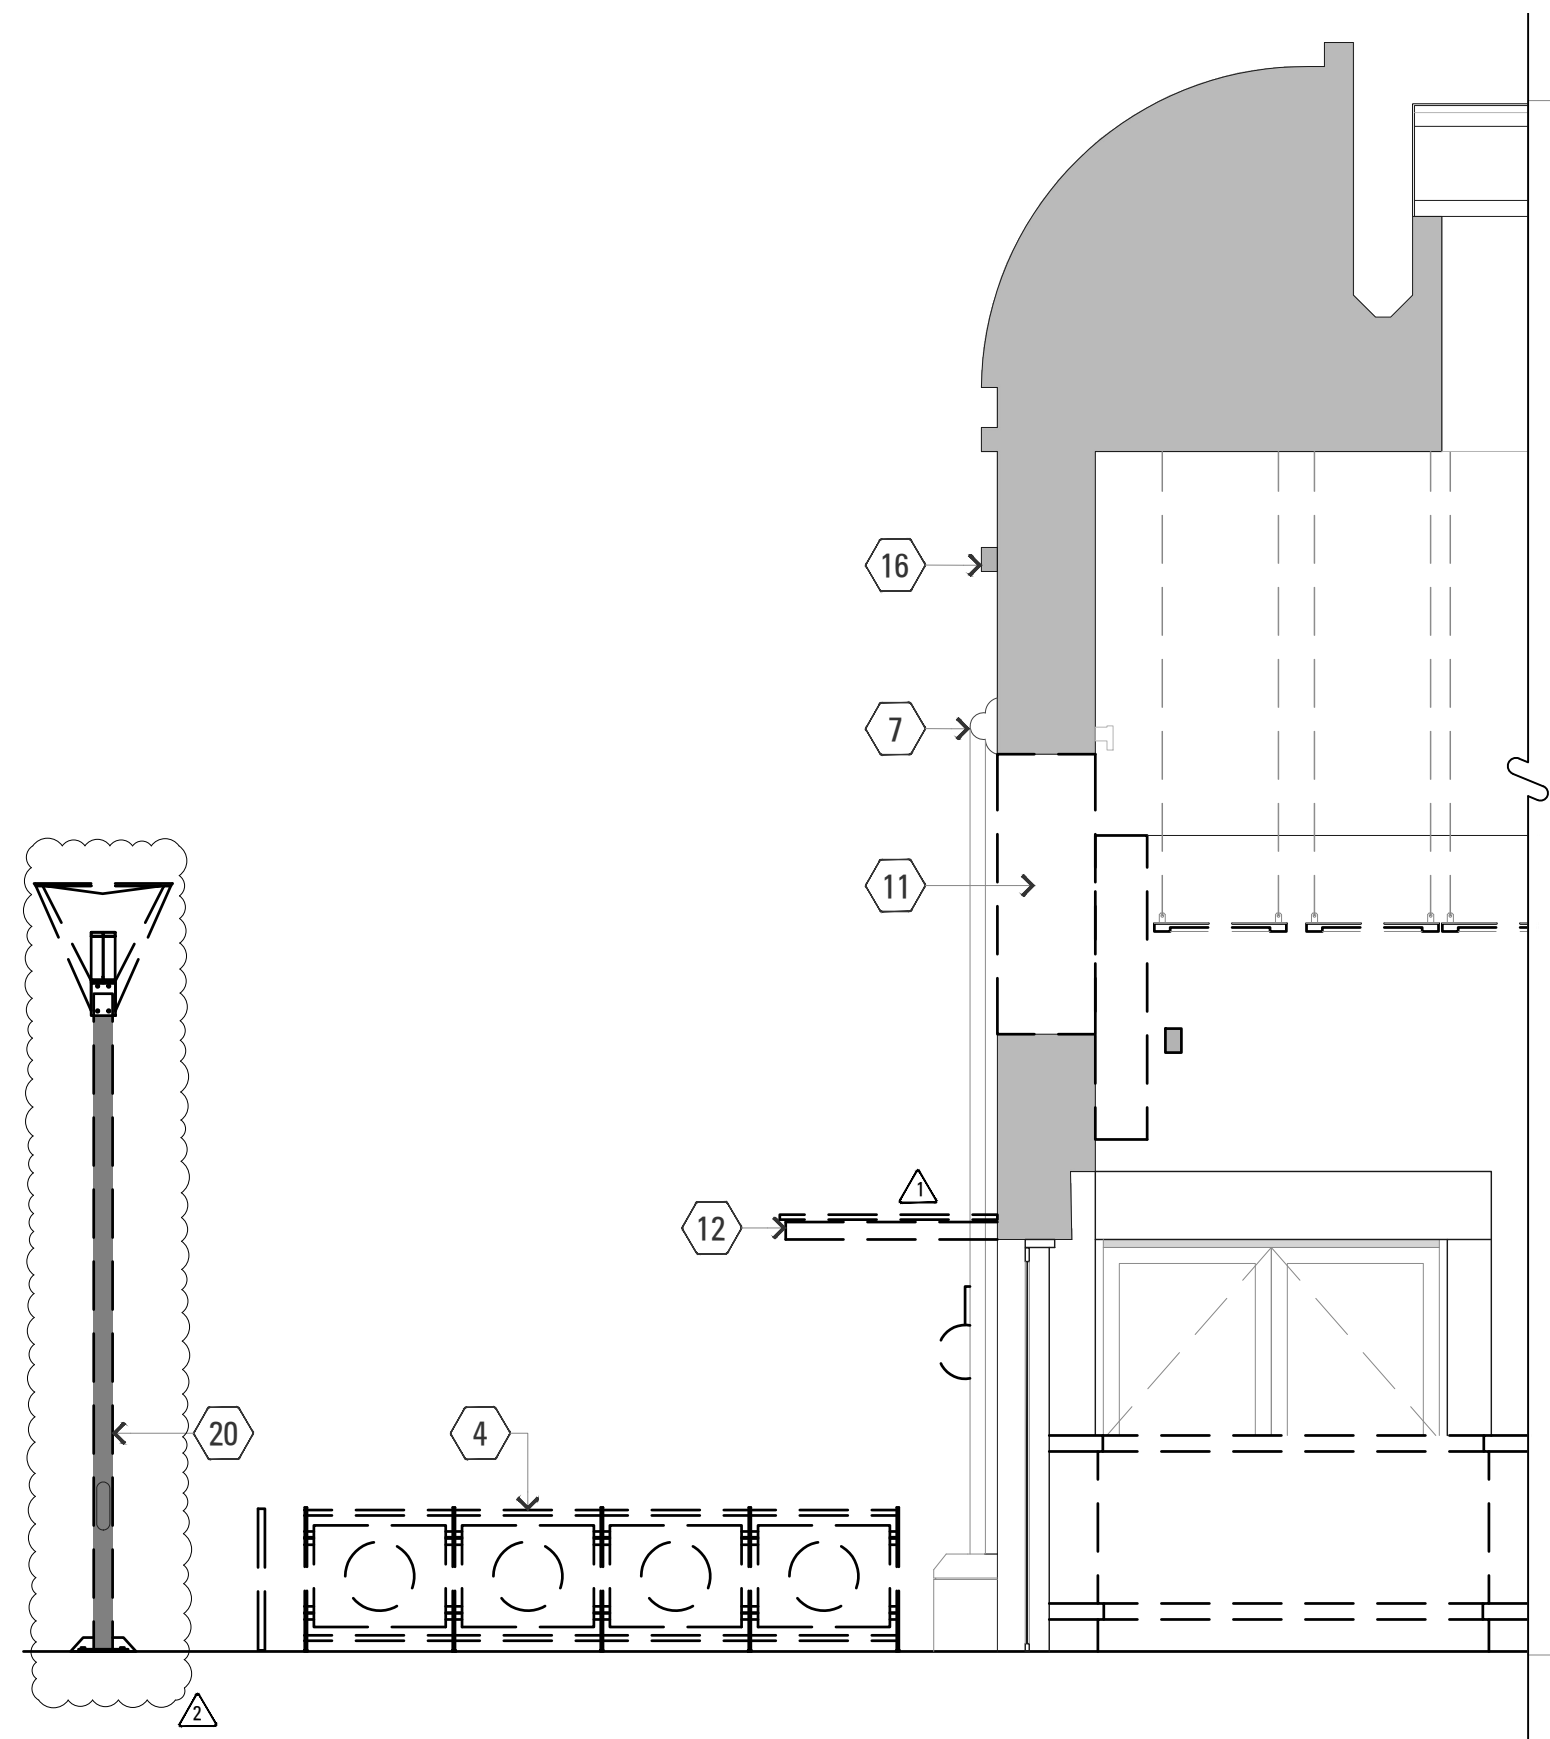KEY NOTES

- 1 EXTERIOR WALL TO REMAIN.
- 2 REMOVE EXISTING DOOR.
- 3 REMOVE EXISTING STOREFRONT - GLAZING AND FRAMES.
- 4 REMOVE EXISTING FENCE. PATCH & REPAIR PAVING AS REQUIRED, COORDINATE WITH NEW FENCE DETAILS AND CONSTRUCTION PLAN FOR LOCATION.
- 5 KEEP J-BOX AND POWER
- 6 EXISTING CURB TO REMAIN. PATCH & REPAIR IF DAMAGED DURING CONSTRUCTION.
- 7 PREPARE EXISTING MOULDING AT ARCHES TO RECEIVE NEW TRIM.
- 8 REMOVE EXISTING FABRIC BANNER SIGNAGE AND MOUNTING BRACKETS ATTACHED TO STUCCO SURFACE. PATCH AND REPAIR SURFACE TO RECEIVE NEW FINISHES.
- 9 REMOVE EXISTING BANNER LIGHTING / EXTERIOR LIGHTS / SURFACE MOUNTED LIGHTING FOR SIGNAGE ILLUMINATION.
- 10 REMOVE EXISTING NON-FUNCTIONAL LOUVERS. PREPARE OPENING TO RECEIVE ARCHED, ENERGY EFFICIENT WINDOW GLASS.
- 11 REMOVE EXTERIOR INFILL. VERIFY STRUCTURE AND COORDINATE WITH ARCHITECT IF REQUIRED.
- 12 REMOVE EXISTING EXTERIOR CANOPY. PATCH AND REPAIR SURFACE TO RECEIVE NEW FINISHES.
- 13 REMOVE EXISTING EXTERIOR AWNING. PATCH & REPAIR SURFACE TO RECEIVE NEW FINISHES.
- 14 REMOVE EXISTING "THE MELT" SIGN. PATCH AND REPAIR AS NEEDED.
- 15 REMOVE EXISTING GLAZED BRICK VENEER TILE OVER EXISTING STUCCO EXTERIOR WALL. PATCH & REPAIR TO RECEIVE NEW FINISHES.
- 16 REMOVE EXISTING LEDGER. PATCH AS NEEDED AND PREPARE FOR NEW PAINT.
- 17 EXISTING DOOR TO REMAIN
- 18 EXISTING STOREFRONT TO REMAIN. FRAMES TO BE PAINTED P3 SW6258- TRICORN BLACK/ POWDER COAT, MATTE.
- 19 REMOVE EXISTING DOORS AND FRAME.
- 20 (E)STREET LIGHT TO BE RELOCATED. PATCH AND REPAIR SIDEWALK AS NEEDED.
- 21 CLEAN AND PREPARE SURFACE TO BE PAINTED.

ELEVATION DEMO NOTES


GENERAL:

1. DIMENSIONS SHOWN ARE TO THE FACE OF FINISH.
2. GENERAL CONTRACTOR TO DISCONNECT ALL EXISTING EQUIPMENT AS REQUIRED PER SCOPE OF OUTLINED WORK. SHUTDOWNS MAY BE STAGED, UNLESS MAJOR ELECTRICAL OR PLUMBING WORK IS REQUIRED THAT COULD CAUSE DAMAGE TO EQUIPMENT THAT IS CONNECTED. G.C. TO COORDINATE ANY DISRUPTION TO SERVICES WITH THE MELT PM IN ADVANCE.
3. G.C. TO COORDINATE PERMIT, APPROVALS, AND LOCATION OF DUMPSTER AND STORAGE UNIT PRIOR TO REQUIRED STORE CLOSING
4. GENERAL CONTRACTOR TO CHECK AND REPAIR ALL MECHANICAL, PLUMBING AND ELECTRICAL CONNECTIONS FOR ALL THE EQUIPMENT AS INDICATED ON EQUIPMENT PLAN WITH THE APPROVAL OF THE MELT PM.
5. U.O.N. ALL WALL ELECTRICAL RECEPTACLES ARE TO REMAIN.
6. COORDINATE REMOVAL / RELOCATION OF ANY IT-RELATED ITEMS INCLUDING P.O.S. STATIONS, SCREENS, & KIOSKS.
7. AUTOMATIC SPRINKLER SYSTEM TO REMAIN OPERATIONAL AT ALL TIMES EXCEPT AS COORDINATED WITH MELT PM.
8. REVIEW ANY POTENTIAL DISRUPTION TO RESTAURANT OPERATIONS IN ADVANCE WITH THE MELT PM.

ELEVATION LEGEND

- EXISTING BASE BUILDING - NOT IN TENANT PROJECT SCOPE
- EXISTING CONSTRUCTION

KEY ELEVATION

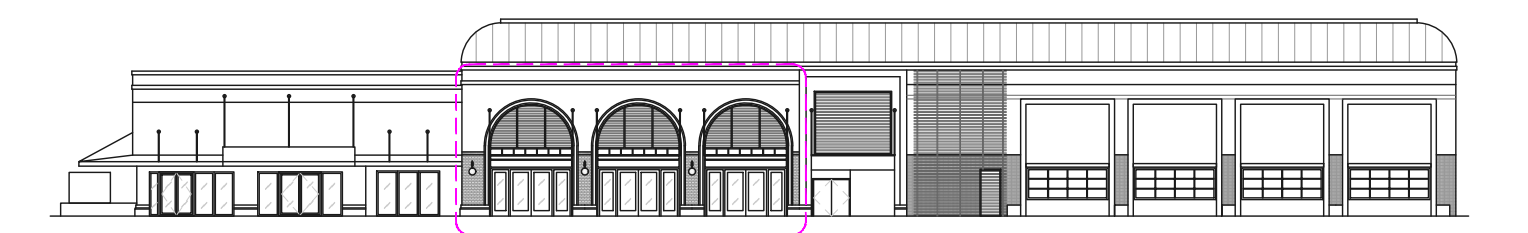

4 KEY ELEVATION
1/4" = 1'-0"

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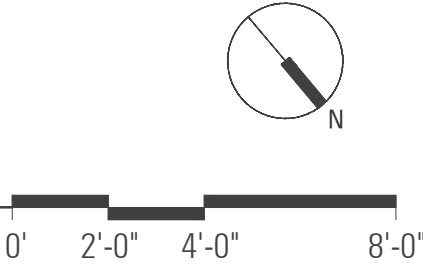
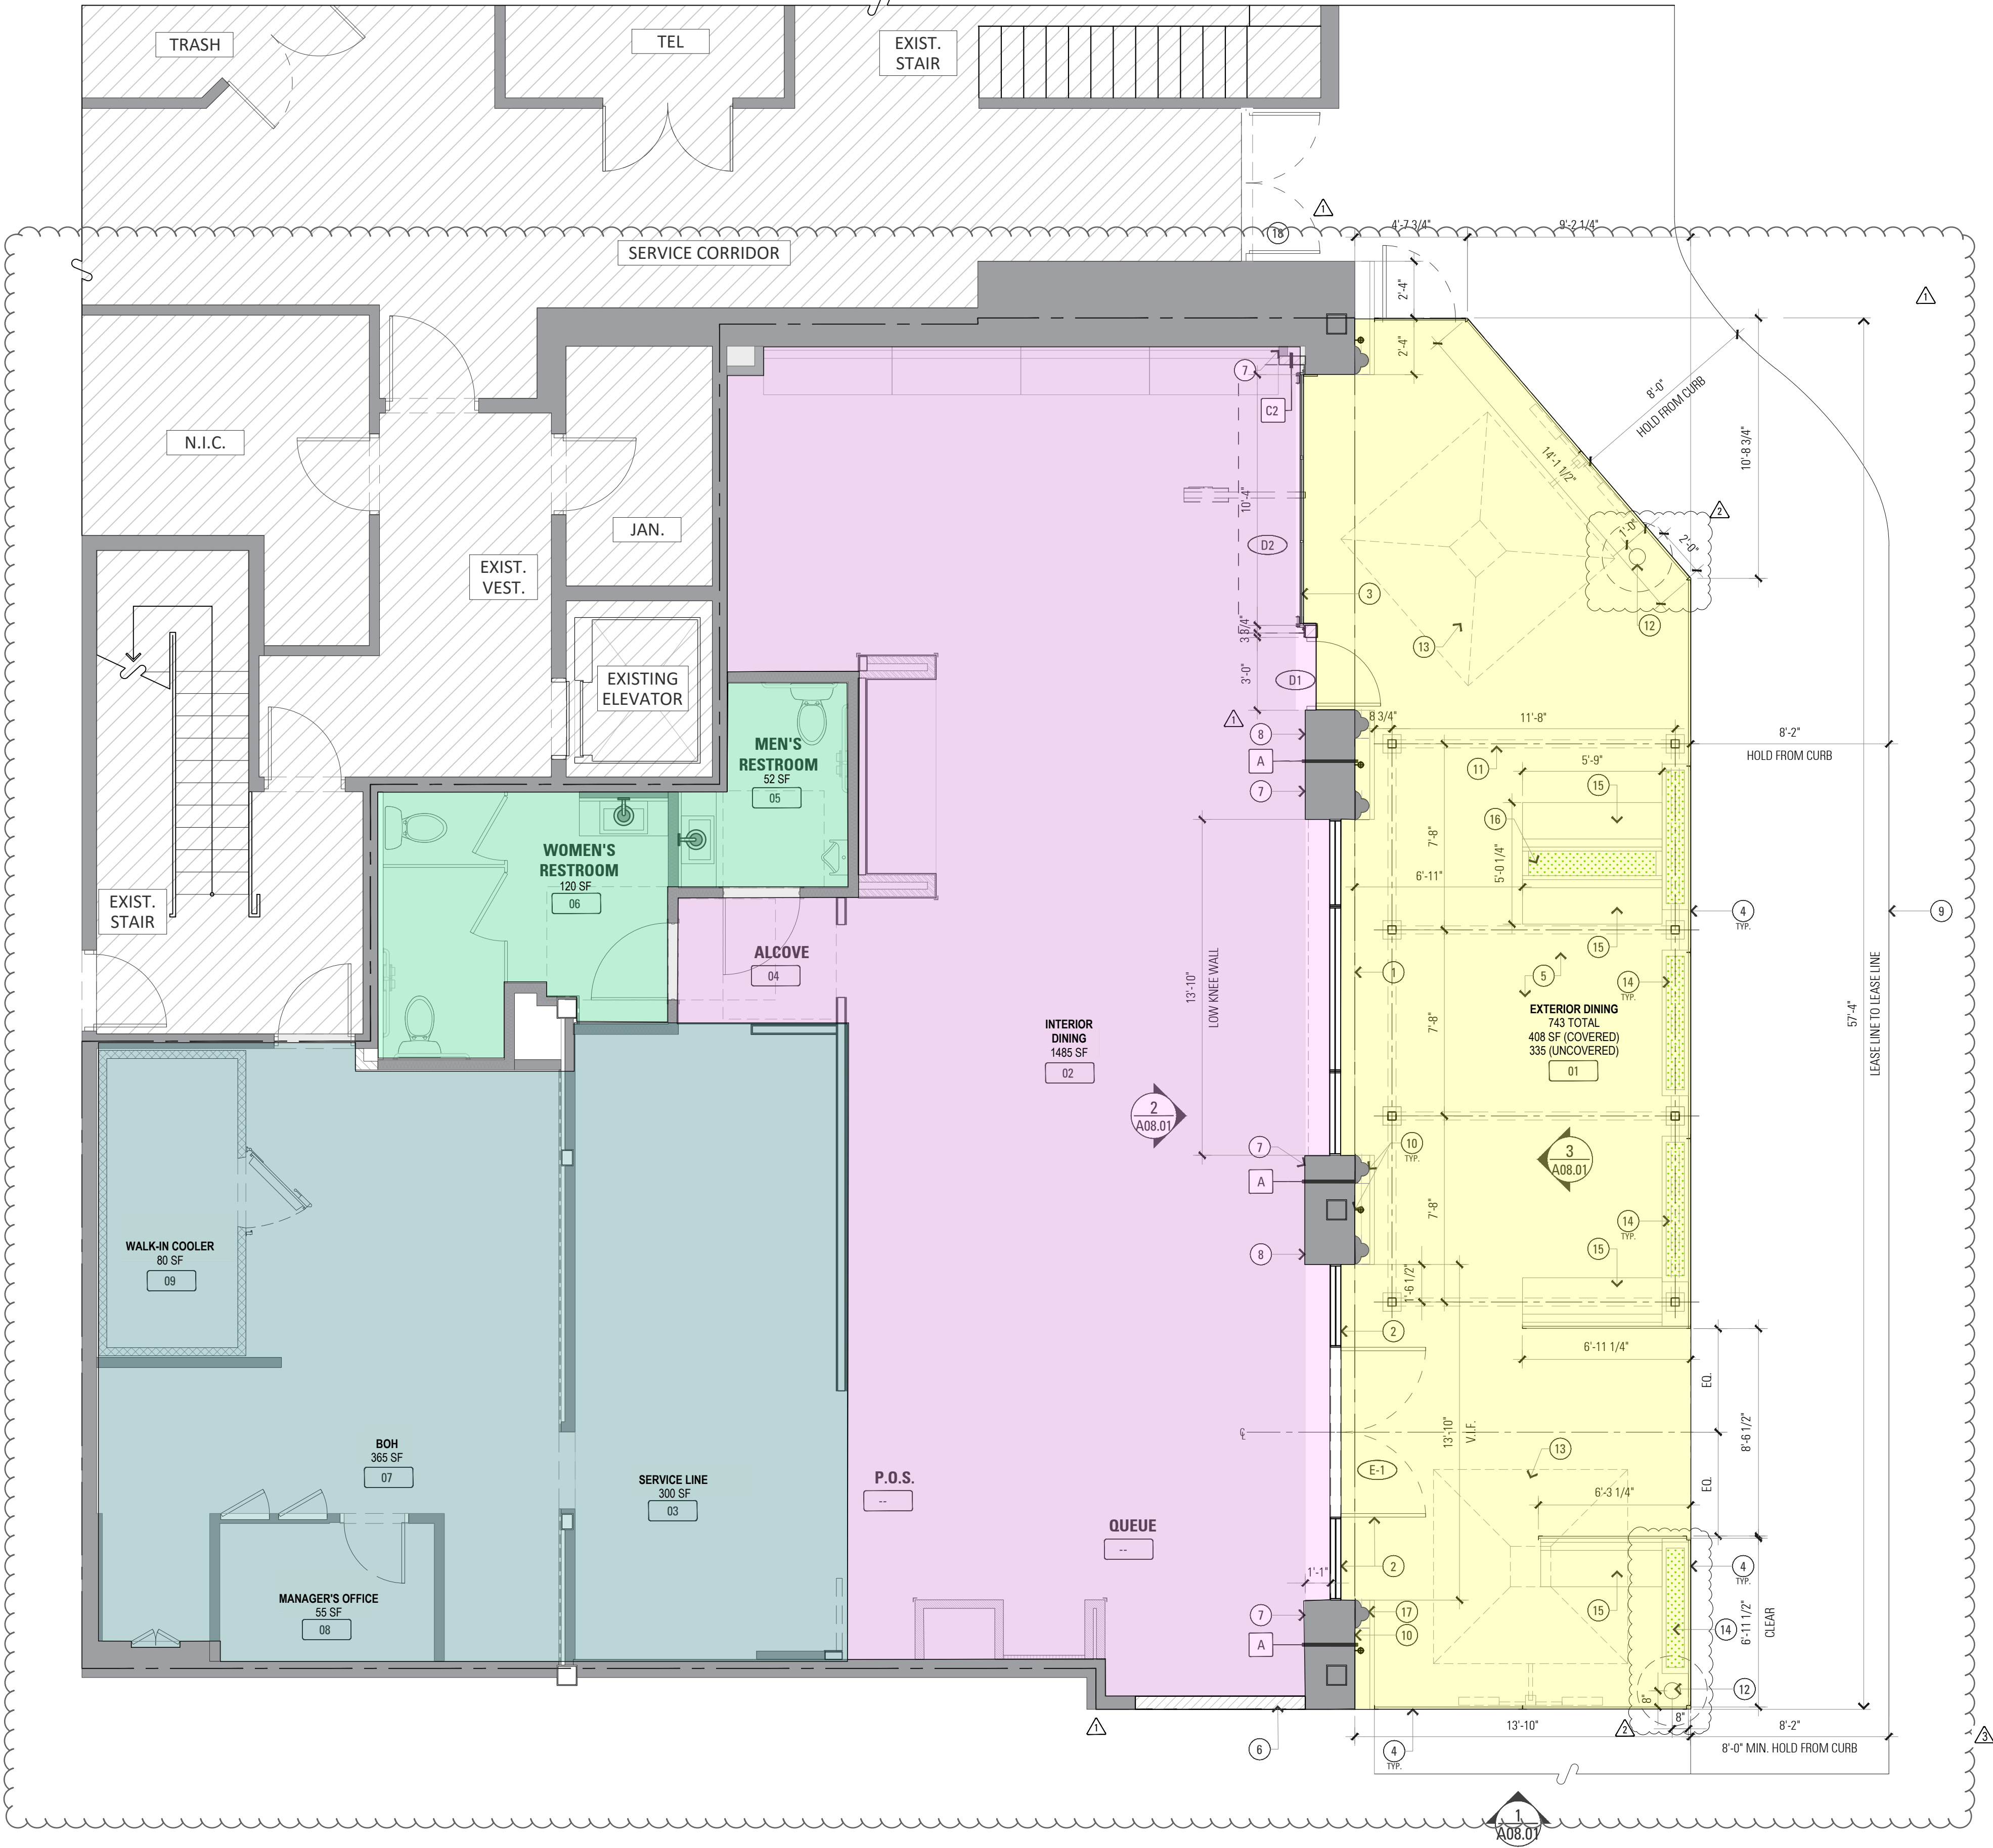
DEMOLITION
STOREFRONT
ELEVATIONS

SHEET NUMBER

D01.02

1 CONSTRUCTION FLOOR PLAN

1/4" = 1'-0"



KEY NOTES

- LEASE LINE
- EXISTING STOREFRONT AND ENTRY DOORS -D1
- NEW MOTORIZED GARAGE DOOR WITH BREAK AWAY SWING DOOR FOR EGRESS
- NEW EXTERIOR FENCE. SEE EXHIBIT SHEET X.03 FOR MORE INFORMATION.
- EXTERIOR FLOORING TO REMAIN.
- INFILL WALL TO MATCH ADJACENT FINISHES AND WALL RATINGS.
- EXISTING INTERIOR WALLS
- PROVIDE AND INSTALL A TACTILE SIGN STATING "EXIT" AND COMPLYING WITH ICC ANSI A17.1-2009 ADJACENT TO EACH EXTERIOR DOOR TO THE EXIT DISCHARGE (WHERE INDICATED).
- EXISTING CURB LINE
- PATCH & REPAIR WALL SURFACE TO RECEIVE NEW FINISHES.
- TUUCI SOLANOX CABANA - 12' X 8' WITH HEATER AND TRELIS. SEE SHEET X.04 FOR MORE INFORMATION.
- RELOCATED STREET LIGHT; DETAILS FOR BASE AT STREET LIGHT TO BE INCLUDED IN TI PERMIT DRAWINGS.
- TUUCI OCEAN MASTER MAX CANTILEVER UMBRELLA 8' X 8' WITH RADIANT HEATER. SEE SHEET X.04 FOR MORE INFORMATION.
- NEW PLANTER WITH BOXWOOD HEDGE. REFER SHEET X.03 FOR DETAILS.
- NEW BANQUETTE SEATING. REFER SHEET X.03 FOR DETAILS.
- PLANTER WITH BOXWOOD HEDGE BETWEEN / BEHIND BANQUETTE BENCHES. REFER SHEET X.03 FOR DETAILS.
- NEW PANEL MOULDING AT ARCHES. FLEX TRIM A9. SEE DETAIL 3/A08.02 FOR MORE INFORMATION.
- SERVICE DOOR ENTRY IS NOT WITHIN SCOPE.

PLAN NOTES

- GENERAL:
- DIMENSIONS SHOWN ARE FROM THE FINISHED FACE.
 - DIMENSIONS NOTED AS "CLEAR" OR "HOLD" ARE MIN. REQ'D. ONLY DIMENSIONS FOLLOWED BY A (+/-) MAY VARY TO ACCOMMODATE (E) CONDITIONS.
 - WRITTEN DIMENSIONS TAKE PRECEDENCE OVER SCALE ON THE CONSTRUCTION DOCUMENTS. DO NOT SCALE DRAWINGS.
 - GENERAL CONTRACTOR SHALL BE RESPONSIBLE FOR BARRICADING OFF OF AREA NOT IN CONTRACT DURING CONSTRUCTION. COORDINATE BARRICADE CONSTRUCTION AND APPEARANCE WITH LANDLORD.
 - CUTTING AND PATCHING: WHERE EXISTING CONDITIONS ARE CUT OR DISTURBED TO PERMIT INSTALLATION OF NEW WORK, MATCH AND PATCH EXISTING DISTURBED CONSTRUCTION/FINISH.

- WINDOWS / DOORS:
- ALL DOOR AND WINDOW OPENING DIMENSIONS ARE TO ROUGH OPENING.

- LAYOUT NOTES:
- NOTIFY ARCHITECT IMMEDIATELY OF ANY INCONSISTENCIES OR DISCREPANCIES WITH PLANS IN RELATION TO EXISTING FIELD CONDITIONS.
 - CONSULTANT DRAWINGS ARE SUPPLEMENTAL TO THE ARCHITECTURAL DRAWINGS. IT IS THE RESPONSIBILITY OF THE GENERAL CONTRACTOR TO CROSS CHECK WITH ARCHITECTURAL DRAWINGS PRIOR TO THE ORDERING/ INSTALLATION OF ANY MECHANICAL, PLUMBING, AND ELECTRICAL WORK. ANY DISCREPANCIES BETWEEN THE ARCHITECTURAL AND THE CONSULTING ENGINEERS DRAWINGS SHALL BE BROUGHT TO THE ARCHITECTS ATTENTION FOR IMMEDIATE CLARIFICATION.

PLAN LEGEND

- EXISTING BASE BUILDING - NOT IN TENANT PROJECT SCOPE
- AREA NOT IN EXTERIOR SCOPE OF WORK

WALL TYPES

- A EXISTING WALL
- (1) LAYER 5/8" F.R.T.W. PLYWOOD OVER 6" MTL. STUDS @ 16" O.C. PLYWOOD
- C1 FROM SLAB TO DECK ABOVE.
- C2 5/8" TYPE 'X' GYP. BD. OVER 3 5/8" MTL. STUDS @ 16" O.C.

AREA DIAGRAM

OCCUPANT LOAD OF EGRESS (CBC TABLE 1004.5):			
AREA:	SQUARE FOOTAGE:	OCCUPANT LOAD FACTOR:	NO. OF OCCUPANTS:
KITCHEN	800 GSF	200 GROSS	4
INTERIOR DINING	1485 SF	15 NET	99
EXTERIOR DINING	743 SF	15 NET	50
RESTROOMS	177 SF	N/A	0
NOT IN SCOPE			

NOTE: ALL NEW WALLS SHOULD HAVE A SMOOTH FINISH

MAXIMUM ALLOWABLE CLEAR SPAN HEIGHT IN FEET (L/240)
NON-BEARING DRYWALL STEEL STUDS, TRACK AND ACCESSORIES BY CLARK DIETRICH BUILDING SYSTEMS
ICC REPORT NO. ESR-2457

STUD SIZE & GAUGE	12" O/C	16" O/C	24" O/C
1 5/8" x 3 5/8" x 25 GA	14'-8"	13'-4"	11'-8"
1 5/8" x 3 5/8" x 20 GA	18'-1"	16'-6"	14'-4"
1 5/8" x 6" x 20 GA	27'-1"	24'-7"	21'-6"
1 5/8" x 3 5/8" x 18 GA	21'-0"	19'-1"	16'-8"
1 5/8" x 6" x 18 GA	31'-2"	28'-4"	24'-9"

ARCHITECT:

KATHRYN CULLEY-RAPATA, AIA
CA LICENSE NO. C-31564
CONTACT: KATE CULLEY-RAPATA
PH: 510-459-5136

STAMP & SEAL:

PROJECT CONSULTANT:

globeateliê
2041 EAST STREET PMB 475
CONCORD CA 94520

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theMELT

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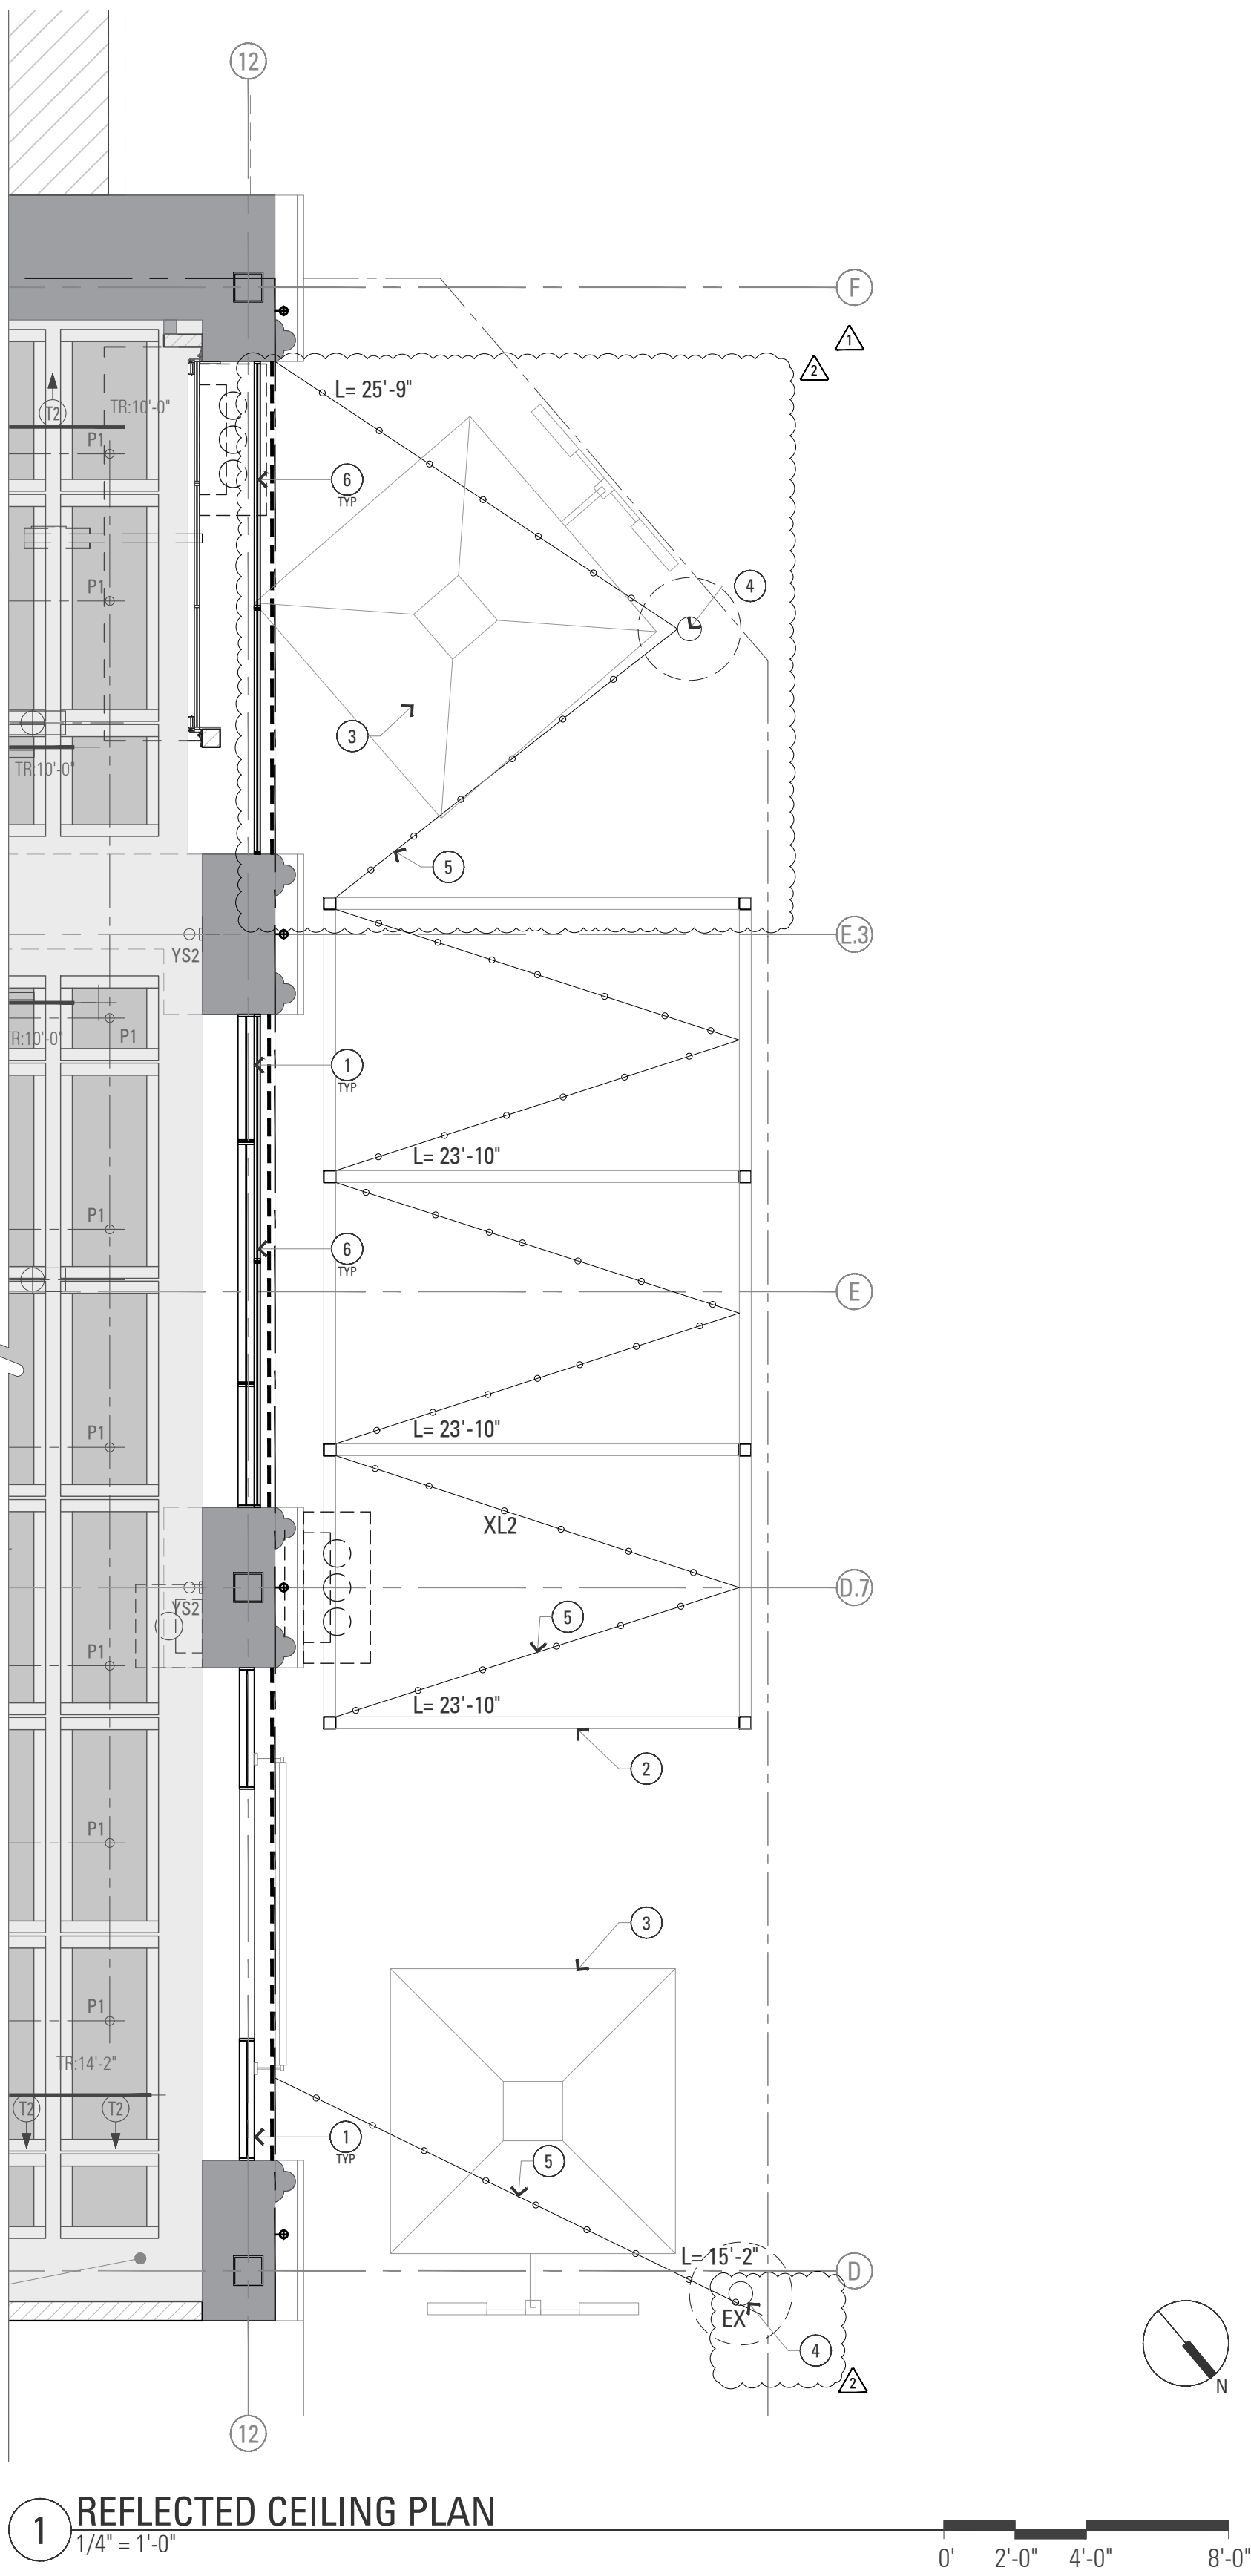
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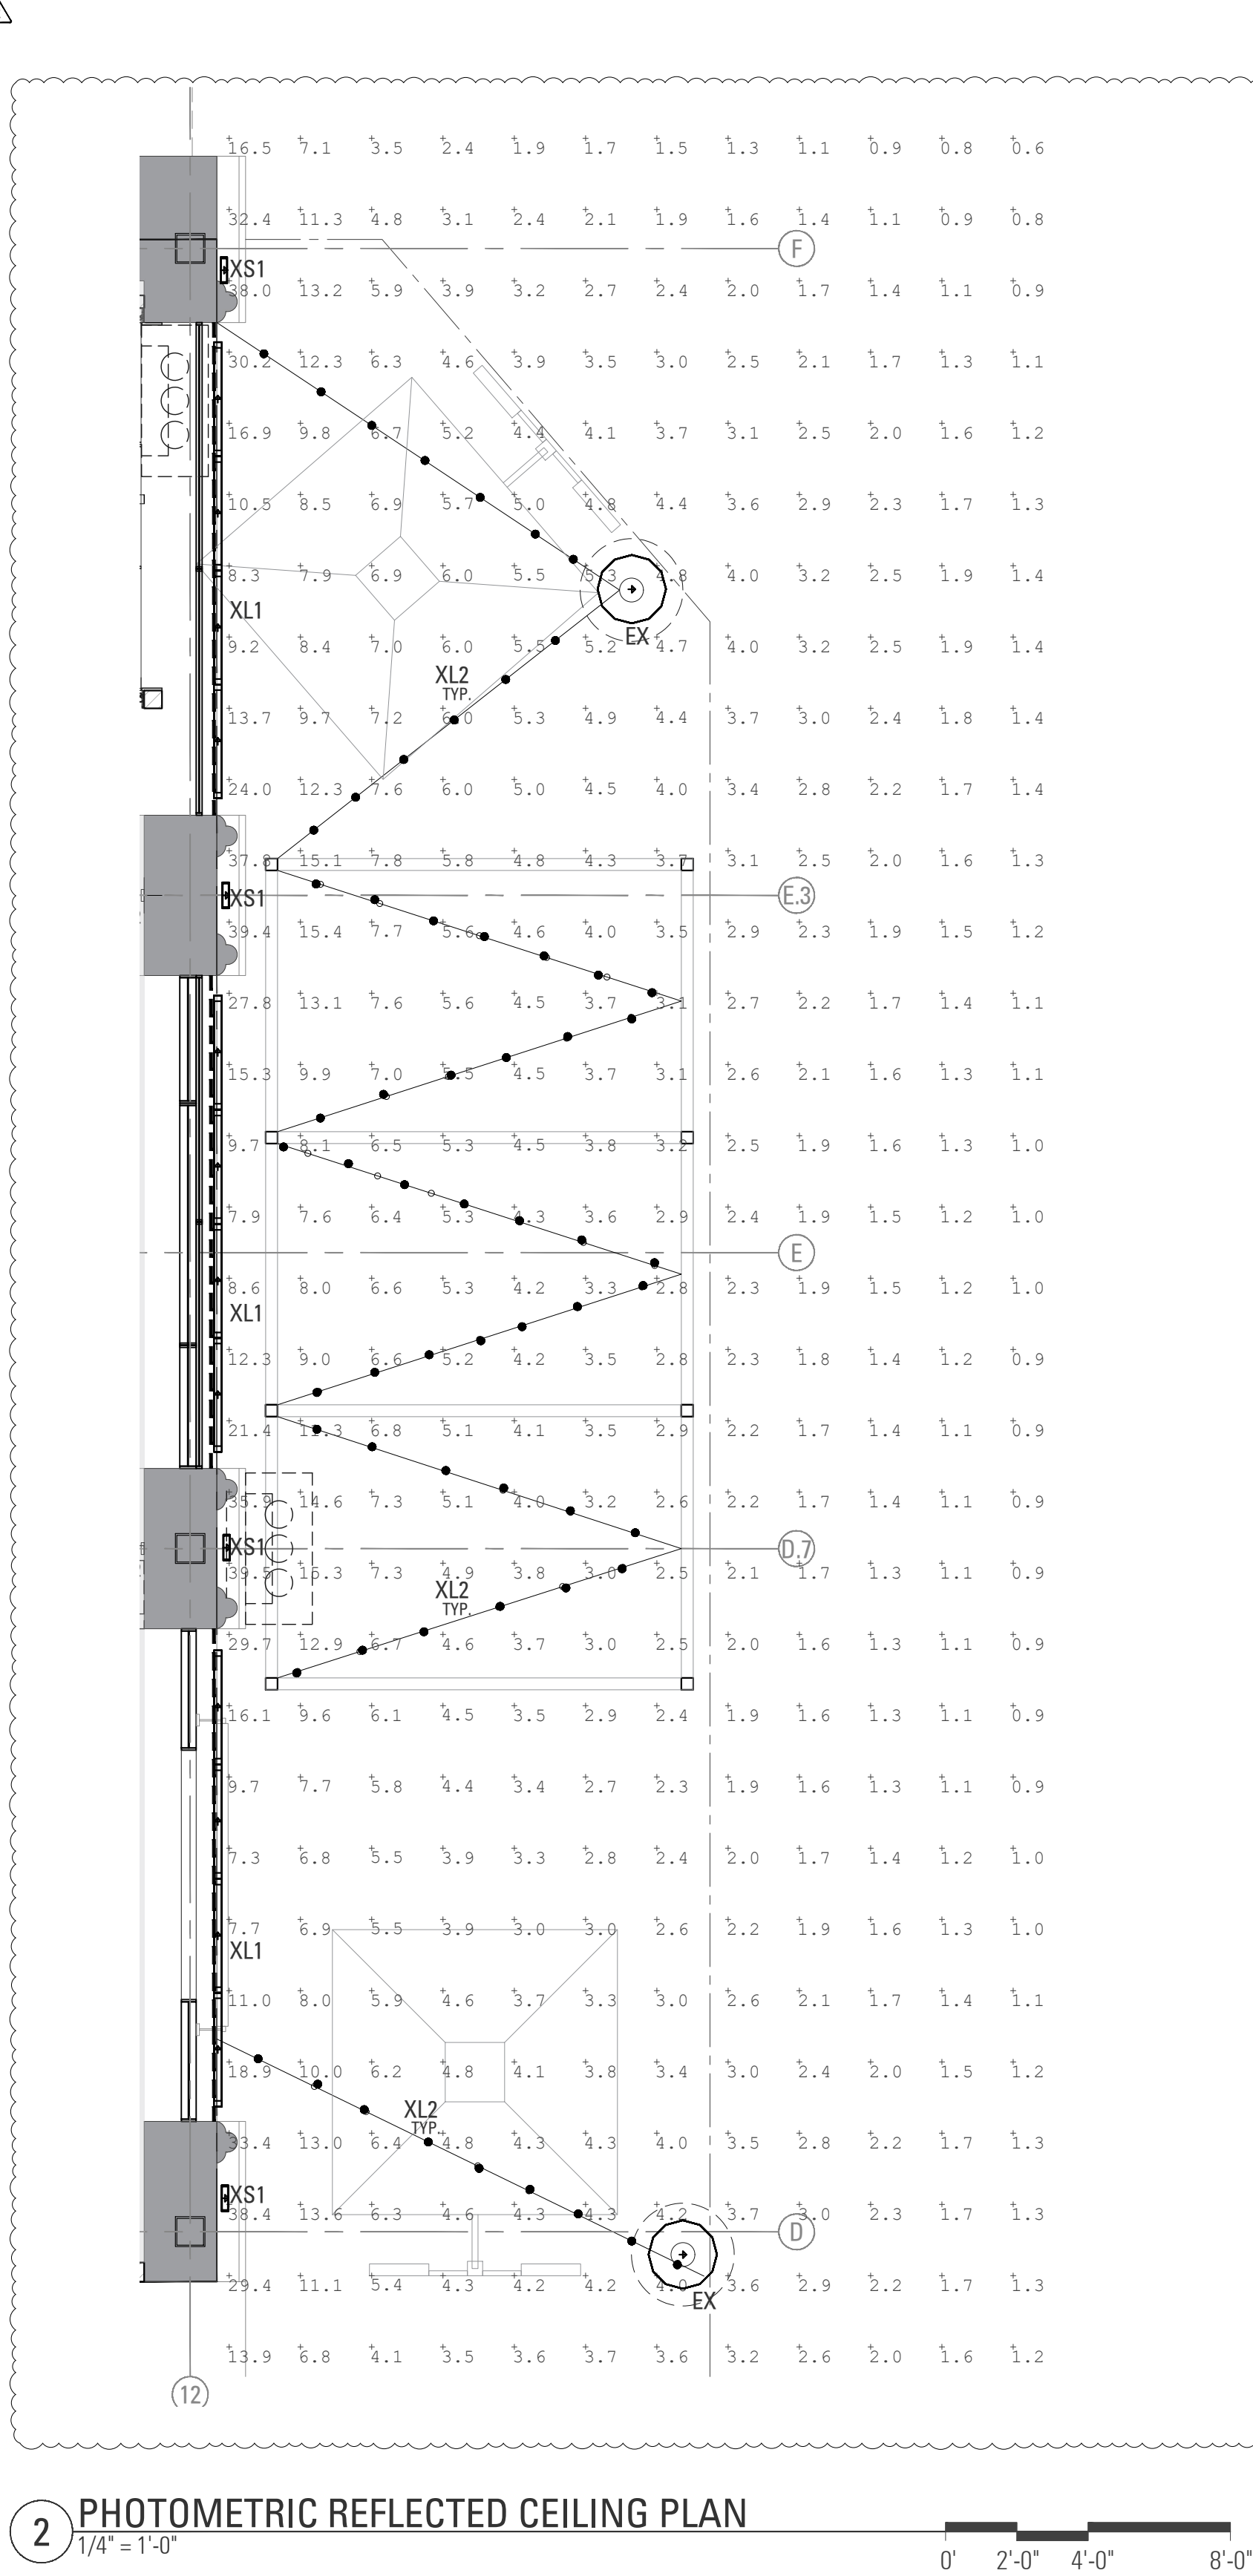
CONSTRUCTION
FLOOR PLAN

SHEET NUMBER

A02.01



1 REFLECTED CEILING PLAN
1/4" = 1'-0"



2 PHOTOMETRIC REFLECTED CEILING PLAN
1/4" = 1'-0"

EXTERIOR PHOTOMETRIC REPORT

Luminaire Schedule							
Symbol	Qty	Label	Arrangement	Description	LLF	Luminaire Lumens	Luminaire Watts
	12	XL1	Single	FTP15-27K-24V-C90, 3.2' LONG	0.950	491	9.708
	2	EX	Single	EXISTING S.3983-SPS007252	0.750	1786	40
	4	XS1	Single	131 WALL SCNCE	0.950	1108	14.5
	61	XL2	Single	UB-EX-WW-G19-C	0.950	44	1.4
Calculation Summary							
Label		CalcType	Units	Avg	Max	Min	Avg/Min
CalcPts_1		Illuminance	Fc	5.14	39.5	0.6	8.57

NOTE:
REFER TO CUT SHEETS ON X.02 FOR DETAILS.
LIGHTING FIXTURES PROVIDED BY OWNER.
EXTERIOR LIGHT POLLUTION REDUCTION OUTDOOR LIGHTING SHALL COMPLY W/ CIBSC & TABLE 5.106.8.

KEY NOTES

- EXISTING STOREFRONT GLAZING
- TUUCI SOLANOX CABANA - 12' X 24' WITH HEATER AND TRELLIS. SEE SHEET X.04 FOR MORE INFORMATION
- TUUCI OCEAN MASTER MAX CANTILEVER UMBRELLA 8'-0" X 8'-0" WITH RADIANT HEATER
- RELOCATED STREET LIGHT
- NEW STRING LIGHT. TOKISTAR EXBK-24-UBWW-G19-C
- NEW GLAZING IN ARCHED OPENING


REFLECTED CEILING PLAN NOTES

- ALL LIGHTING TO BE LED.
- EFFECTIVE LIGHTING CONTROLS STANDARD THROUGHOUT.

LIGHTING NOTES

- UNLESS NOTED OTHERWISE, ALL LIGHTING EQUIPMENT REMOVED AS PART OF THIS CONTRACT SHALL REMAIN THE PROPERTY OF "THE MELT" (THE CLIENT) AND SHALL BE DELIVERED TO CLIENT'S MAINTENANCE FACILITY AFTER REMOVAL.
- THE CONTRACTOR SHALL COORDINATE ALL WORK AND MATERIALS WITH SPECIAL ATTENTION TO ALL OTHER CONSTRUCTION CONTRACTS.
- ALL ELECTRICAL & LIGHTING EQUIPMENT SHALL BE PROVIDED COMPLETE WITH ALL ACCESSORIES, HANGERS, SUPPORTS, CONTROLS, ETC FOR A FULLY FUNCTIONING SYSTEM REGARDLESS OF PRESENCE ON PLANS.
- LOCATION OF FIXTURES AS SHOWN ON THE DRAWINGS ARE APPROXIMATE AND SHALL BE COORDINATED WITH MECHANICAL EQUIPMENT, DUCT, PIPING ETC IN THE FIELD.
- DESCRIPTIONS, MANUFACTURER'S NAMES AND CATALOG NUMBERS OF LIGHTING FIXTURES ARE SPECIFIED TO ACHIEVE DESIRED LIGHTING LEVELS. REFER TO LIGHTING FIXTURE SPECIFICATION FOR MATERIALS SUBSTITUTIONS.
- IF CONFLICT IS PRESENT BETWEEN DESCRIPTION AND MODEL #, EQUIPMENT DESCRIPTION SHALL TAKE PRECEDENT.
- ALL FIXTURES' INSTALLATIONS SHALL BE SUBJECT TO THE REVIEW AND APPROVAL OF THE CLIENT / ARCHITECT.
- CONTRACTOR SHALL FIELD VERIFY THE MOUNTING HEIGHT OF SUSPENDED/PENDANT LIGHT FIXTURE BEFORE PURCHASING LIGHT FIXTURES. AND THE LENGTH OF HANGING CABLE OR STEM.
- SEE EXHIBIT SHEETS FOR SPECIFICATION ON LIGHTING FIXTURE

KEY PLAN

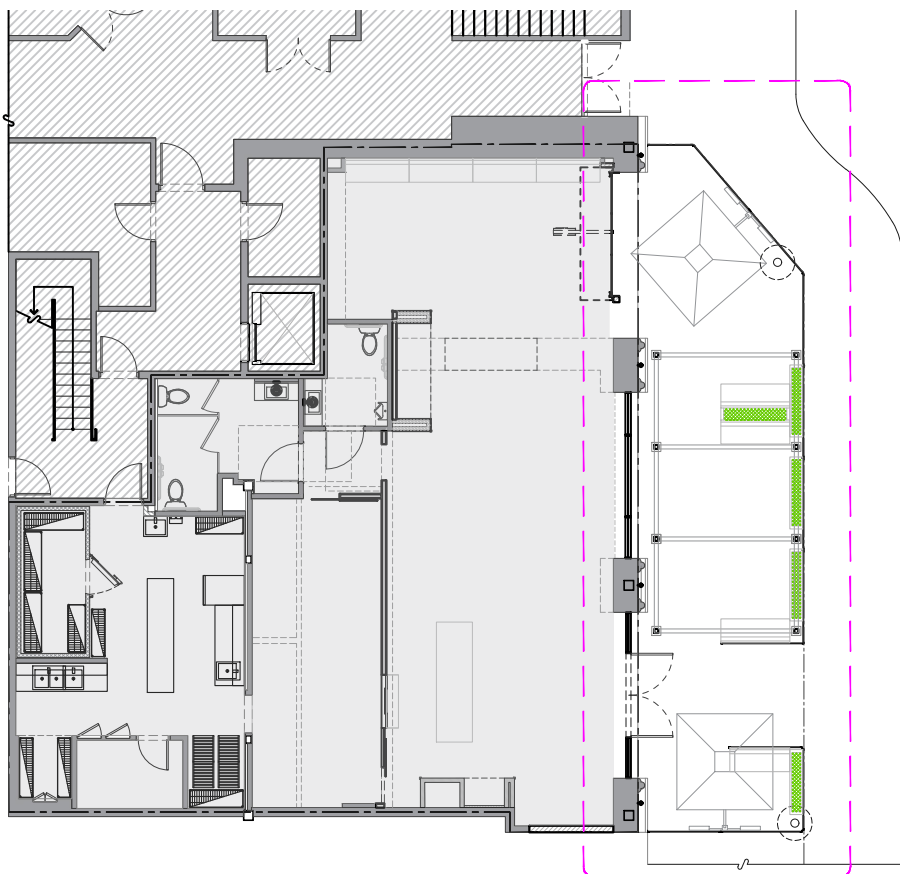

ARCHITECT:

KATHRYN CULLEY-RAPATA, AIA
CA LICENSE NO. C-31564
CONTACT: KATE CULLEY-RAPATA
PH: 510-459-5136

STAMP & SEAL:

PROJECT CONSULTANT:

globeatelié
2041 EAST STREET PMB 475
CONCORD CA 94520

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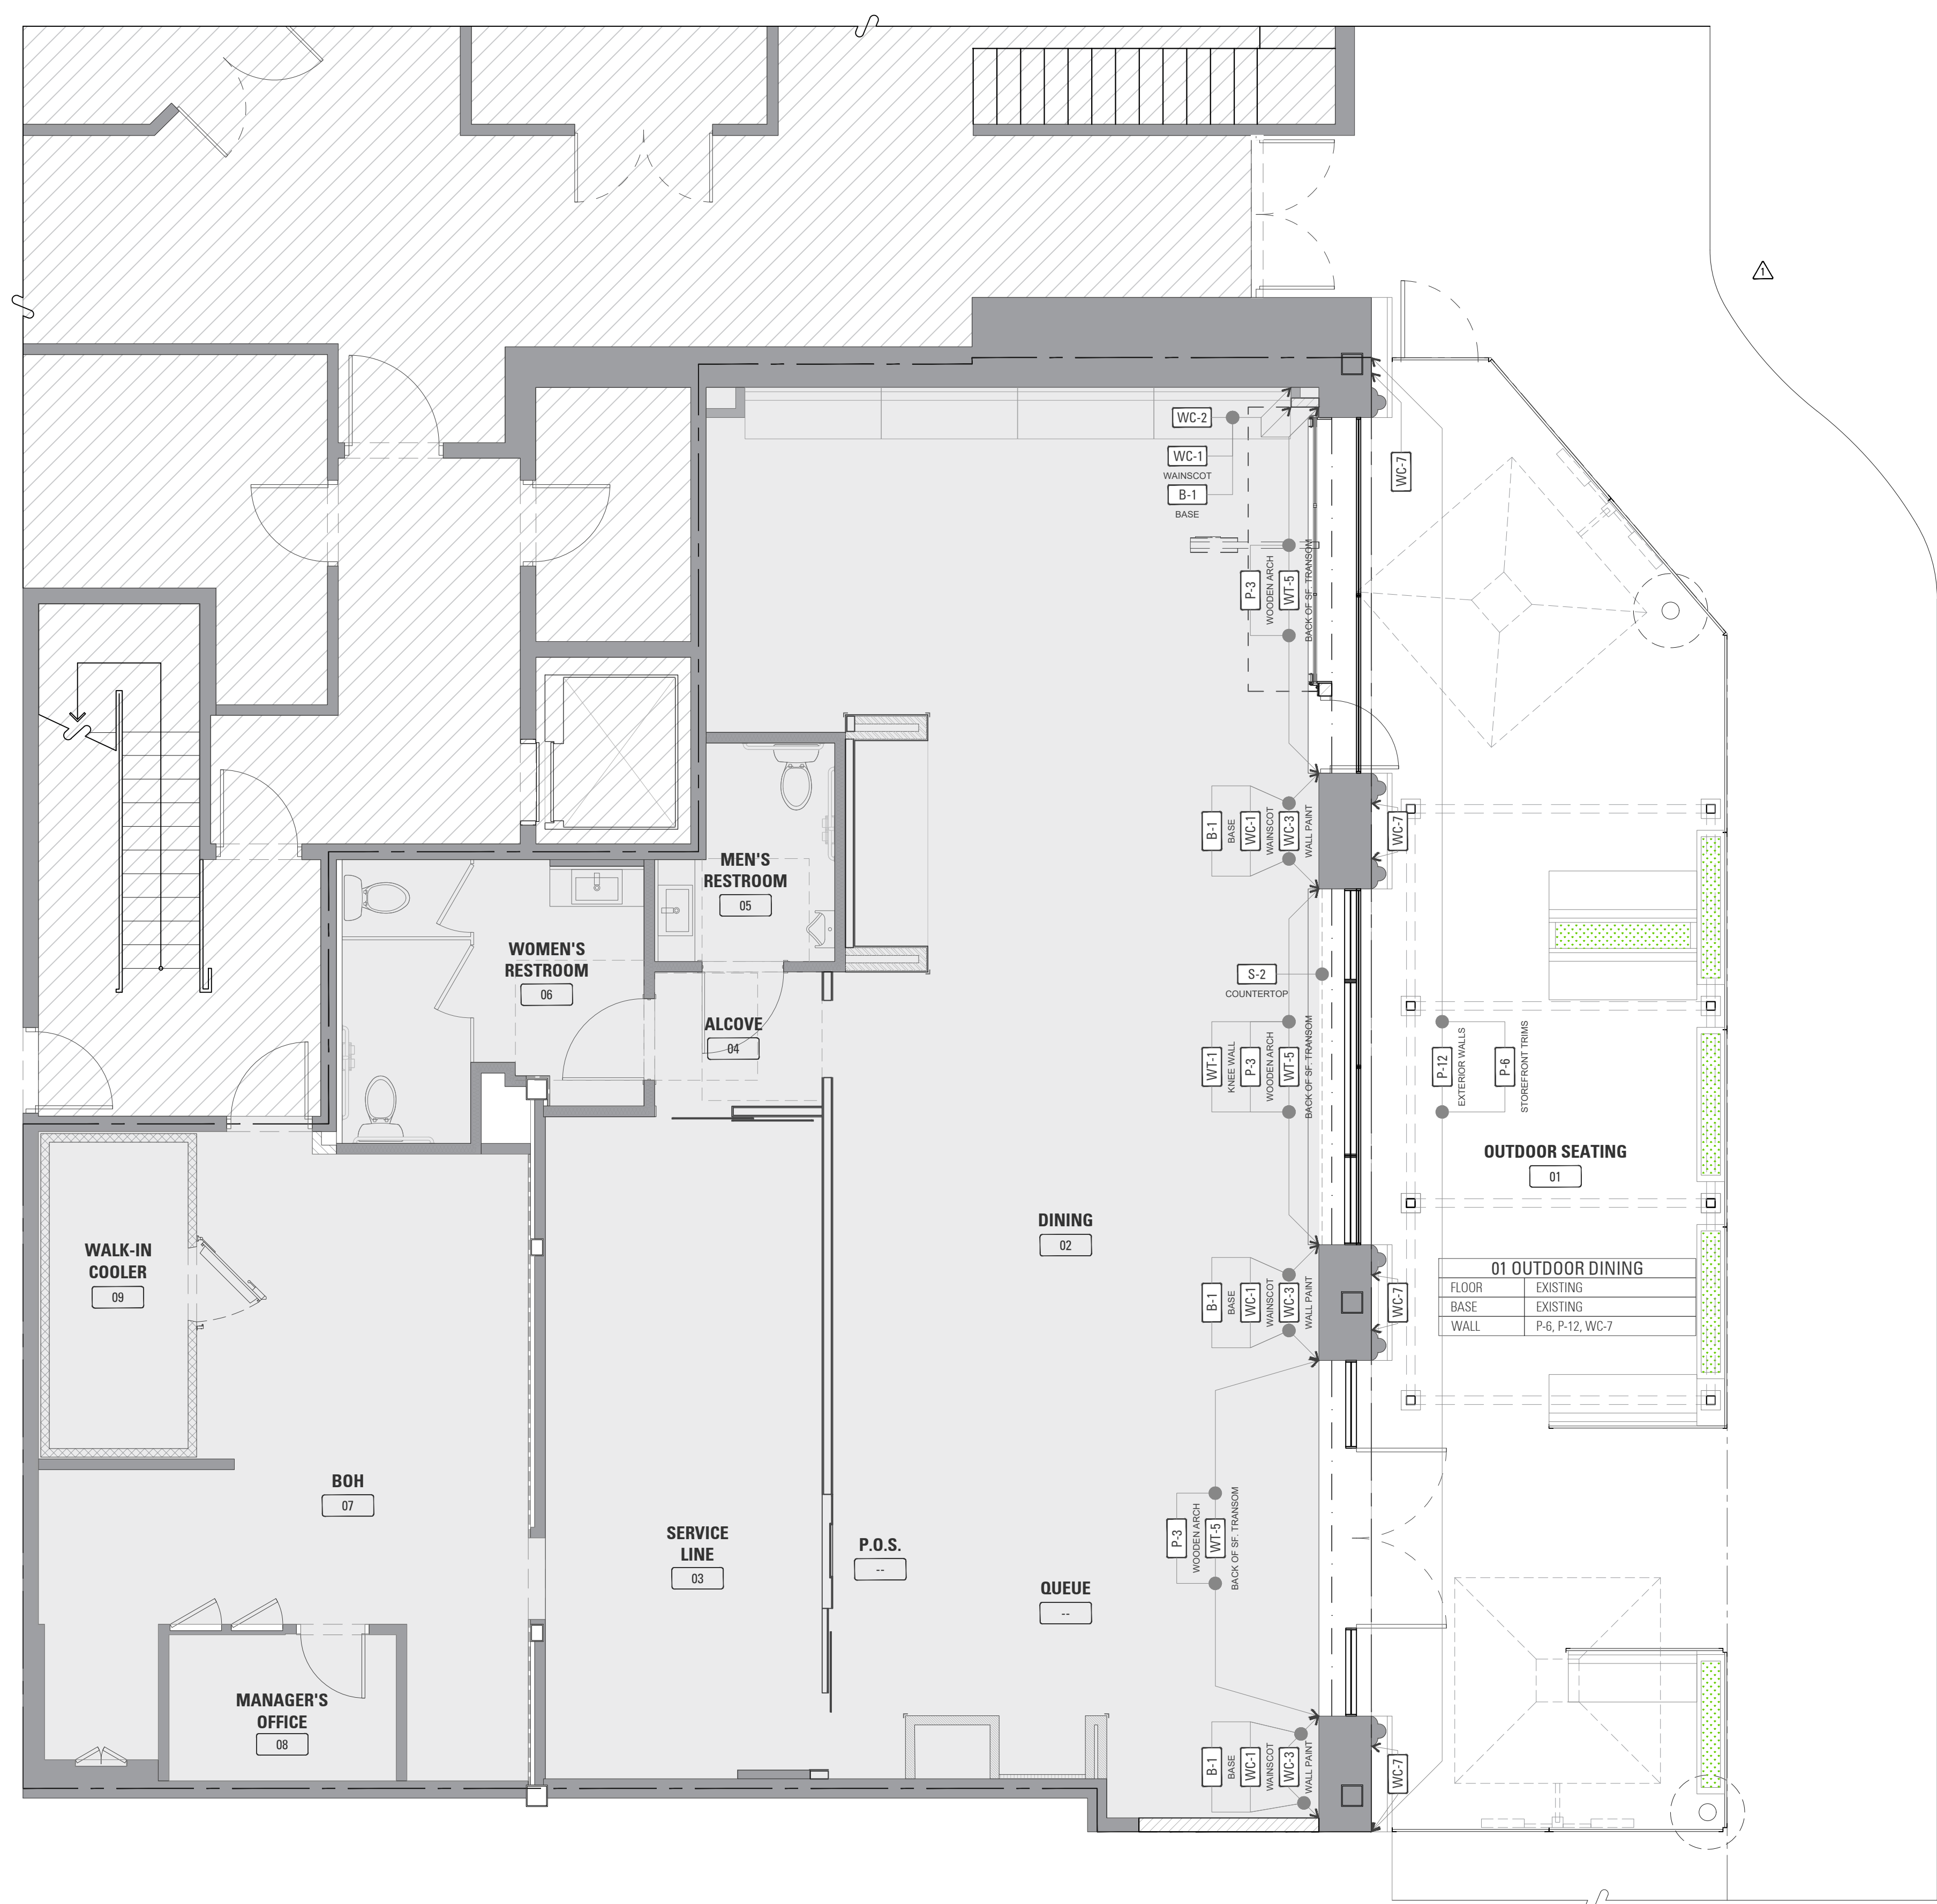
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CHECKED BY: AR
SHEET TITLE

REFLECTED CEILING
PLAN AND
PHOTOMETRIC RCP

SHEET NUMBER

A03.01



1 FINISH PLAN
1/4" = 1'-0"

PLAN NOTES

- ALL HOLLOW METAL FRAMES ARE TO BE PAINTED P-2 ALUMINUM GLAZING SYSTEMS, GARAGE DOORS ARE FACTORY FINISHED TO MATCH P-3
- ALL NEW SCHEDULED / NOTED FLOOR FINISHES SHALL EXTEND BENEATH ALL BUILT-IN CASEWORK
- WALL SURFACE ABOVE DOOR FRAMES TO MATCH ADJACENT WALL FINISH AND COLOR WHERE APPLICABLE, UON.
- SEE SHEET A08.01 FOR FINISH SCHEDULE

PLAN LEGEND

	EXISTING BASE BUILDING - NOT IN TENANT PROJECT SCOPE		AREA NOT IN EXTERIOR SCOPE OF WORK
	EXISTING WALL		

FURNITURE SCHEDULE

MATERIALS	VENDOR/MANUFACTURER
DINING CHAIRS - PEWTER	RESTAURANT FURNITURE PLUS -PEWTER
BAR STOOLS - COPPER	TRENDLER SEATING - COPPER 30" H
TABLES 24 X 30	OCH INC. (OUR COUNTRY HOME) WOOD TOP WITH BLACK POWDER COATED BASE.
TABLES 30 X 48	OCH INC. (OUR COUNTRY HOME) CONCRETE LOOK RESIN TOP WITH BLACK POWDER COATED BASE.
BAR HEIGHT TABLE 97 X 18	TBD POSSIBLY CUSTOM TO MATCH EXTERIOR TABLES
CUSTOM BENCH SEATING	NEWTCHWOOD AMERICA INC. - VOYAGER SERIES - SPANISH WALNUT
TRASH ENCLOSURE	TBD POSSIBLY CREATIVE PALETTE
UMBRELLA	TUUCI OCEAN MASTER MAX CANTILEVER UMBRELLA 8'-0" X 8'-0" WITH LED AND RADIANT HEATER
CABANA	TUUCI SOLANOX CABANA - 12' X 24' WITH LIGHTS, HEATER AND TRELLIS. SEE SHEET X.04 FOR MORE INFORMATION
FENCING	NEWTCHWOOD AMERICA INC. - VOYAGER SERIES - SPANISH WALNUT

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globeateliê
2041 EAST STREET PMB 475
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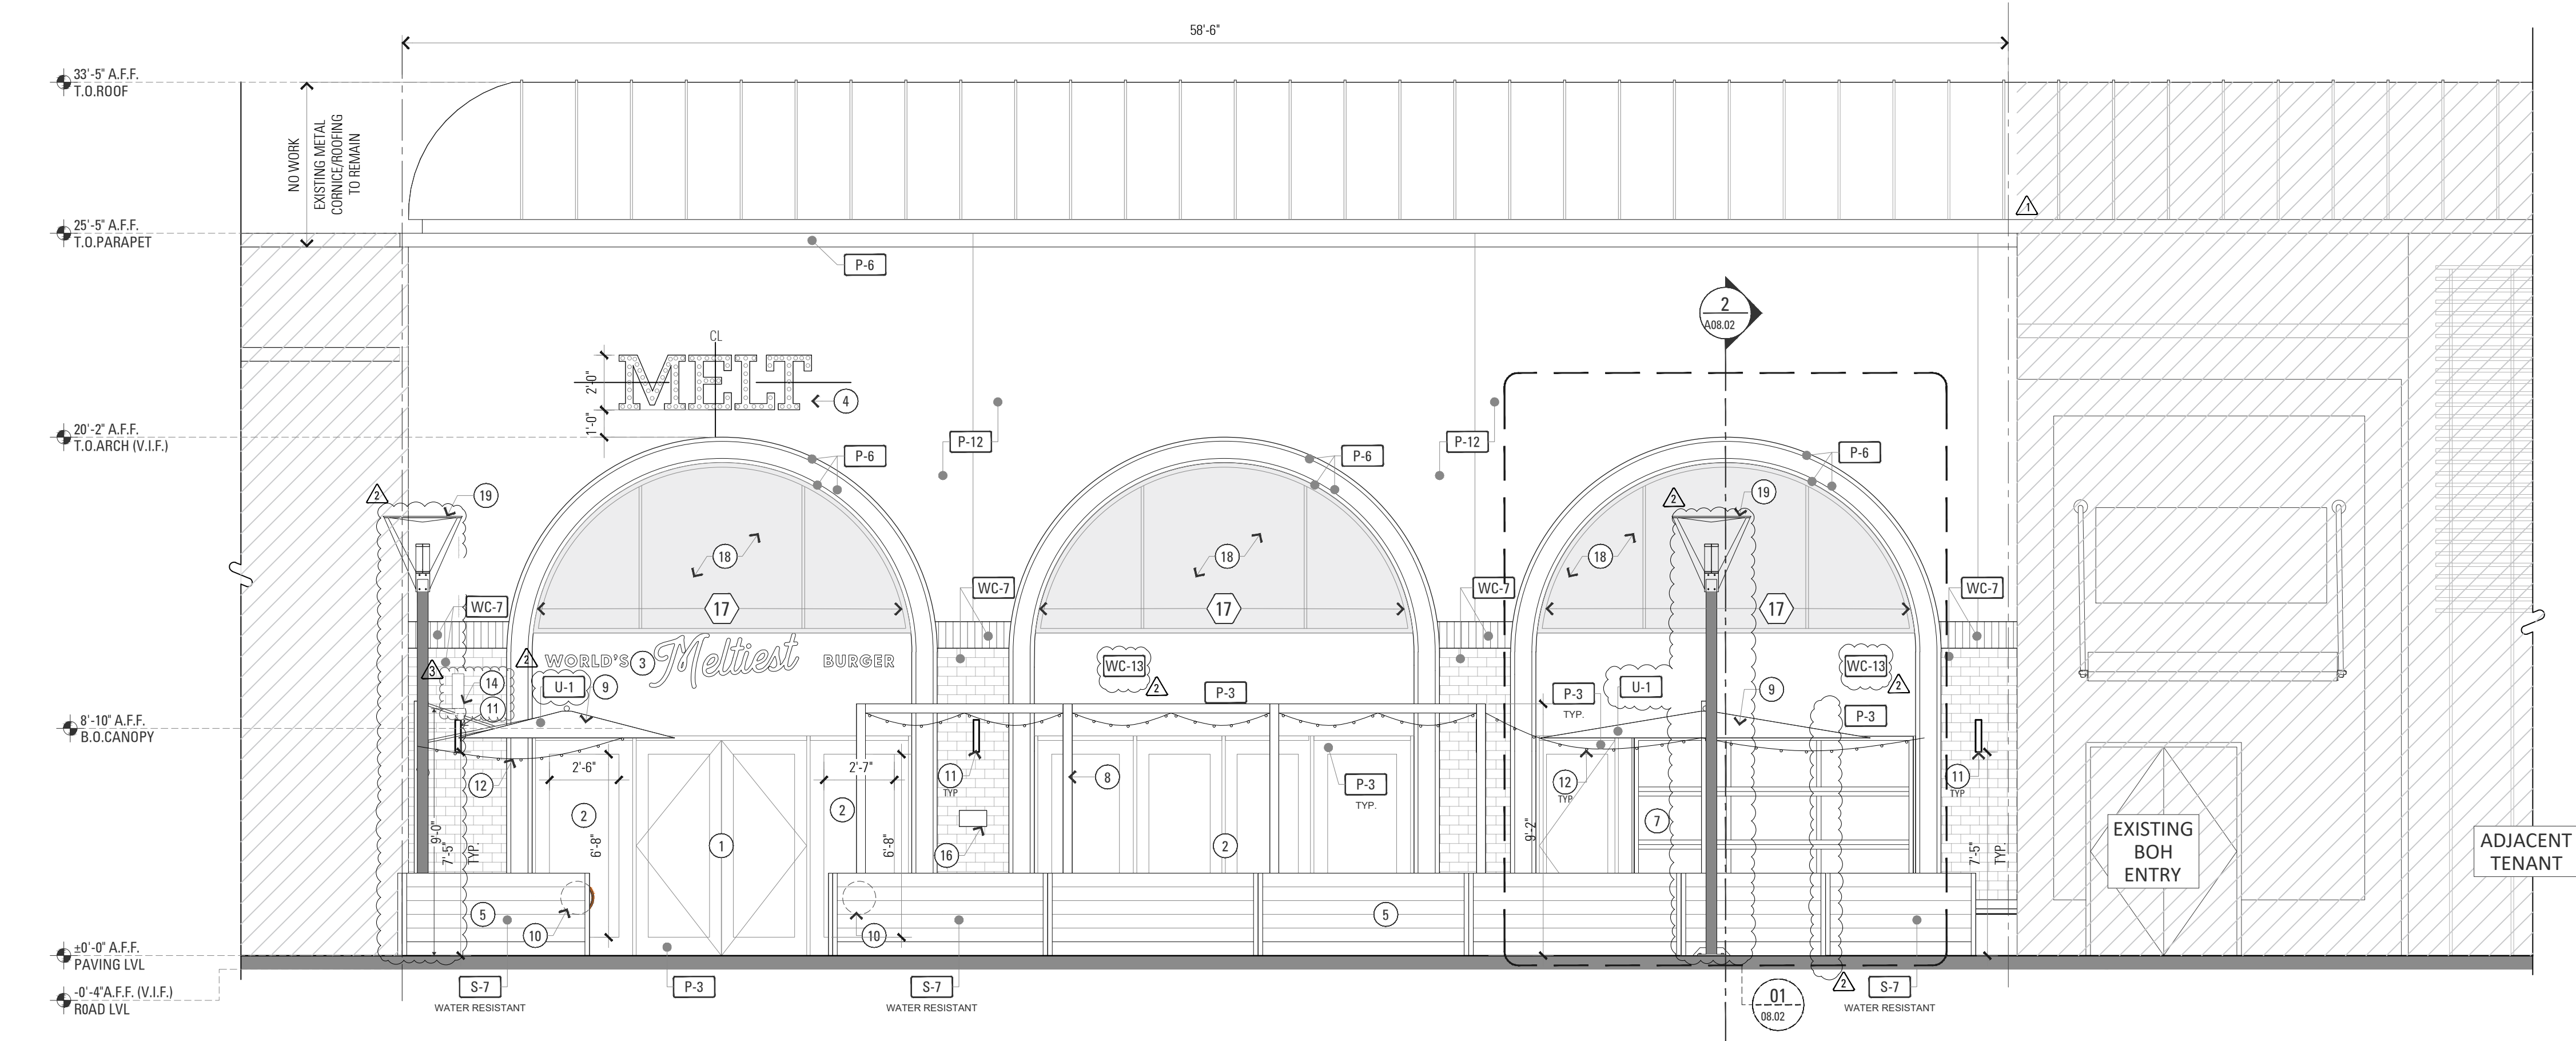
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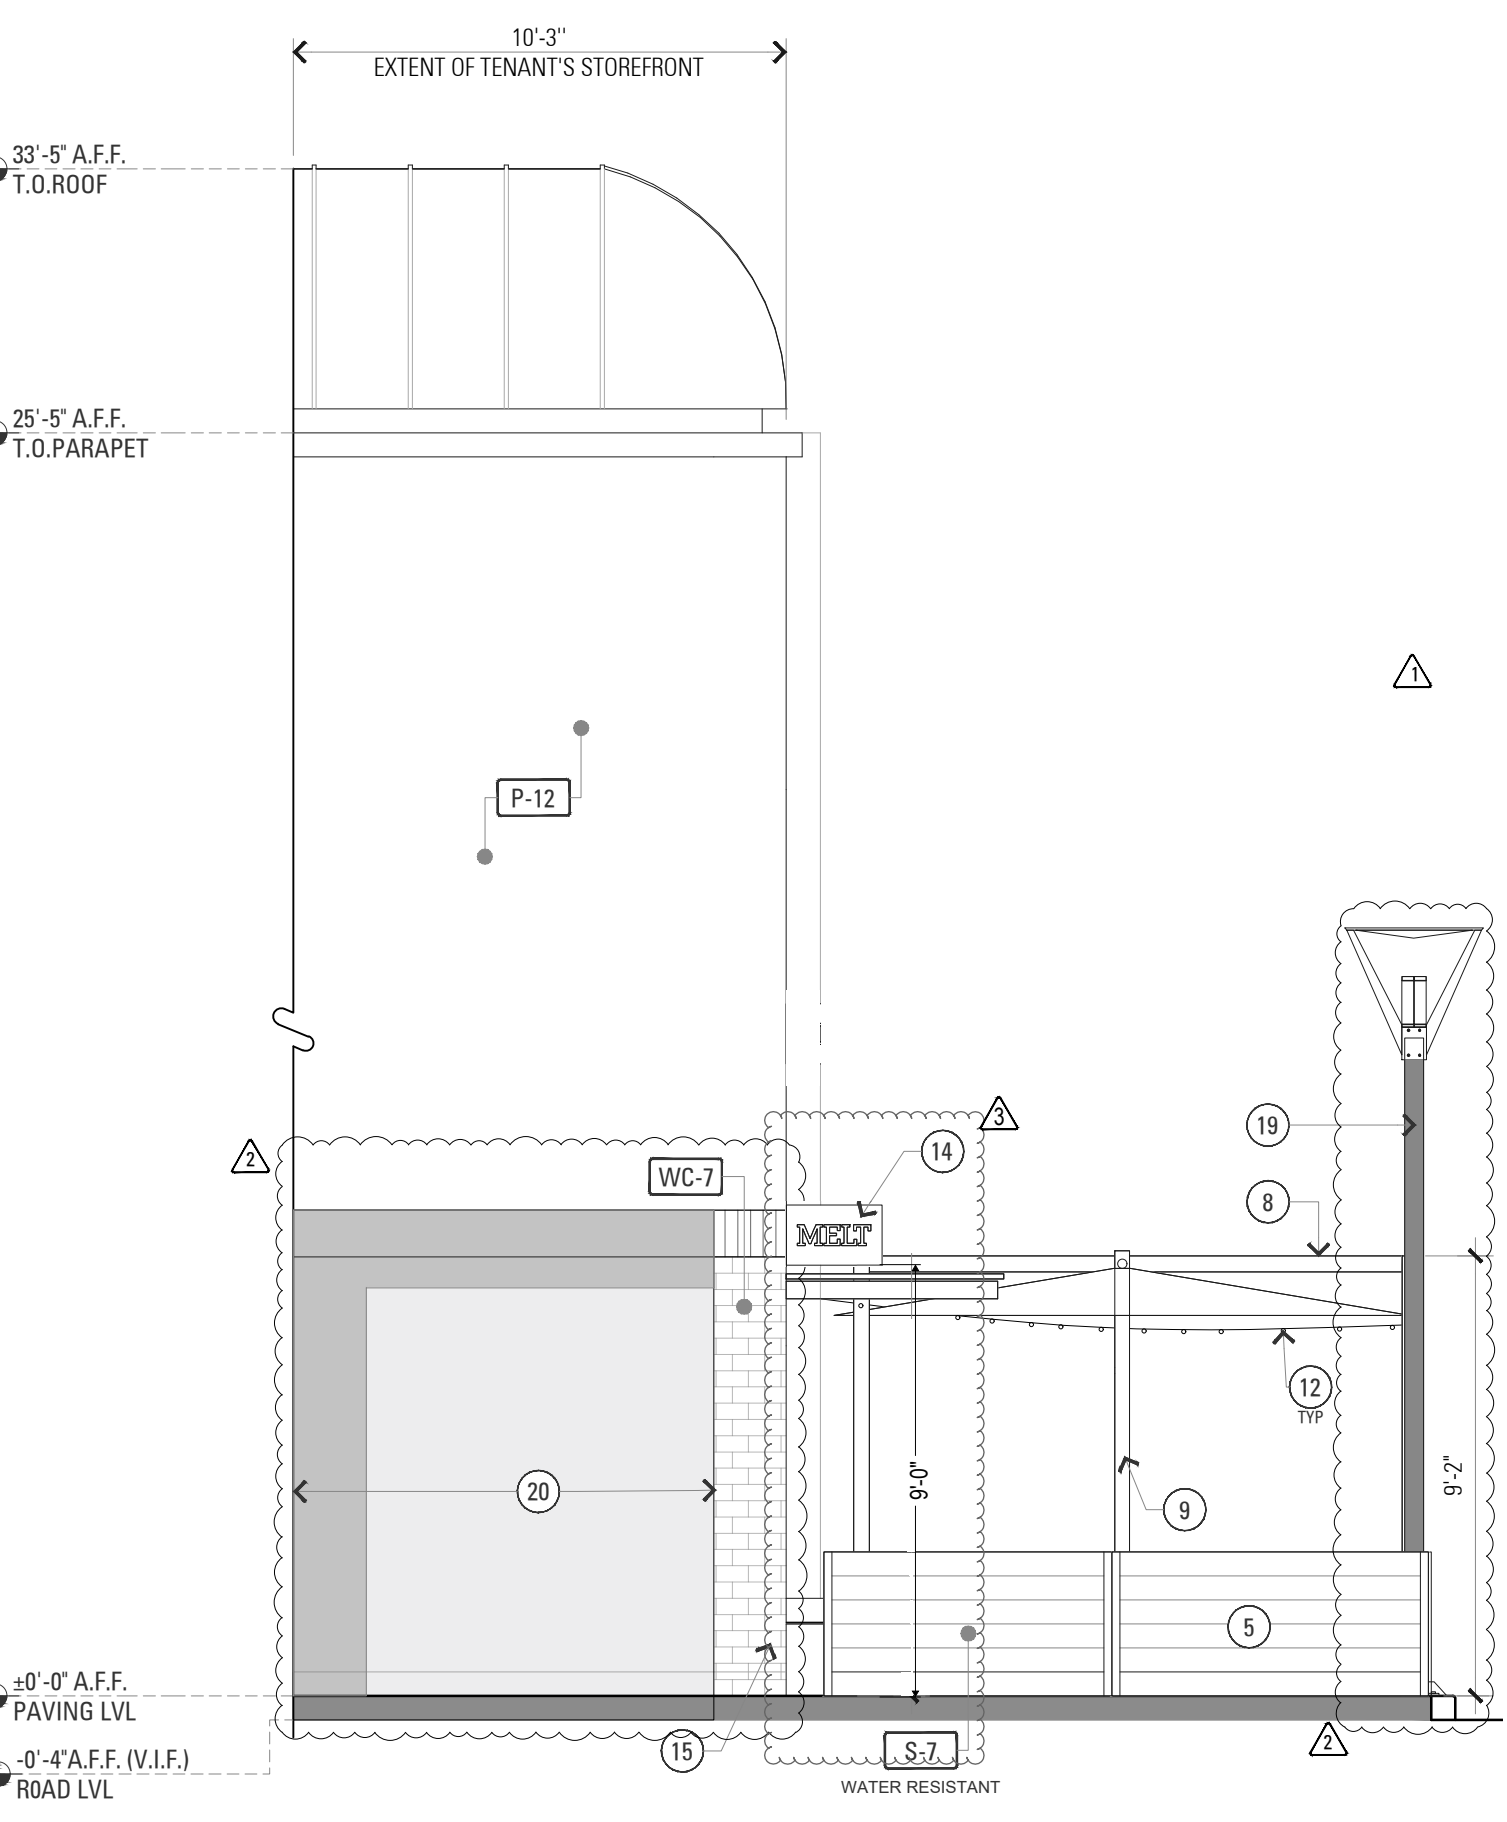
FLOOR AND WALL
FINISH PLAN

SHEET NUMBER

A05.01



3 NORTH WEST ELEVATION (EXTERIOR)
1/4" = 1'-0"



1 SOUTH WEST ELEVATION (EXTERIOR)
1/4" = 1'-0"

EXTERIOR FINISH SCHEDULE

WALL FINISHES

SWATCH	TAG	PRODUCT/ FINISH	MANUFACTURER	LOCATION	REMARKS
	S-7	WOODEN FINISH PLANK VOYAGER SERIES- SPANISH WALNUT : 6"H X 1"W X 16"L - SKU- UH02-16-N-WN	NEWTECHWOOD AMERICA INC.	EXTERIOR	
	S-8	OPAQUE ALL SEASON WINDOW FILM: MATTE BLACK	3M	SPANDREL GLAZING IN ARCHES	
	WC-7	PEPPERMILL- THIN BRICK FLATS : 2-1/4"H X 1/2"W X 7-5/8"L - SKU 6060011298 THIN BRICK CORNERS: 2-1/4"H X 1/2"W X 7-5/8"L - SKU 6060011298	GENERAL SHALE	EXTERIOR	
	WC-11	KAWNEER STOREFRONT	KAWNEER FINISH NO 29	EXTERIOR	AA-M10C21 A44 Architectural Class I (0.7 mils minimum)
	WC-13	MAPES PANEL STANDARD COLORS- BLACK	MAPES PANEL	EXTERIOR	

PAINT FINISHES

	P-3	SW6258 - TRICORN BLACK STAIN FINISH DURABLE EXTERIOR PAINT	SHERWIN WILLIAMS	EXTERIOR	
	P-6	SW7019 - GAUNTLET GRAY - EGGSHELL	SHERWIN WILLIAMS	EXTERIOR	
	P-12	SW7017 - DORIAN GRAY	SHERWIN WILLIAMS	STOREFRONT	
	U-1	STINGRAY 9050	TUUCI	UMBRELLA FABRIC - CANVAS	


ELEVATION KEY NOTES

- EXISTING ENTRY DOOR PAINTED P-3
- EXISTING STOREFRONT GLAZING. PAINT MULLIONS P-3
- NEW SIGNAGE.
- ILLUMINATED LOGO FIXED ON THE WALL SURFACE.
- NEW EXTERIOR FENCE. SEE EXHIBIT SHEET X.03 FOR MORE INFORMATION.
- NOT USED
- NEW MOTORIZED GARAGE DOOR WITH BREAK AWAY SWING DOOR FOR EGRESS
- TUUCI SOLANOX CABANA - 12' X 4' WITH HEATER AND TRELLIS. SEE SHEET X.04 FOR MORE INFORMATION.
- TUUCI OCEAN MASTER MAX CANTILEVER UMBRELLA 8' X 8' WITH RADIANT HEATER
- NEW WINDOW VINYL ON INTERIOR SURFACE OF GLASS
- NEW LIGHTS/SCONCES
- NEW STRING LIGHTS
- NOT USED
- NEW BLADE SIGN 15" TALL X 24" PROJECTION. B.O. SIGN AT 13'2"
- NEW INFILLED WALL TO MATCH ADJACENT FINISHES
- BRASS BRAILLE "THE MELT" PLAQUE
- NEW GLAZING IN ARCHED OPENING. PAINT EXISTING MULLIONS P-3
- NEW ARCHED WINDOWS TO RECEIVE 3M OPAQUE ALL SEASON WINDOW FILM.
- RELOCATED LIGHT POLE.
- PAINT TO MATCH ADJACENT TENANT FINISHES.

LEGEND

- EXISTING BASE BUILDING - NOT IN
TENANT PROJECT SCOPE
- AREA NOT IN EXTERIOR
SCOPE OF WORK

KEY ELEVATION

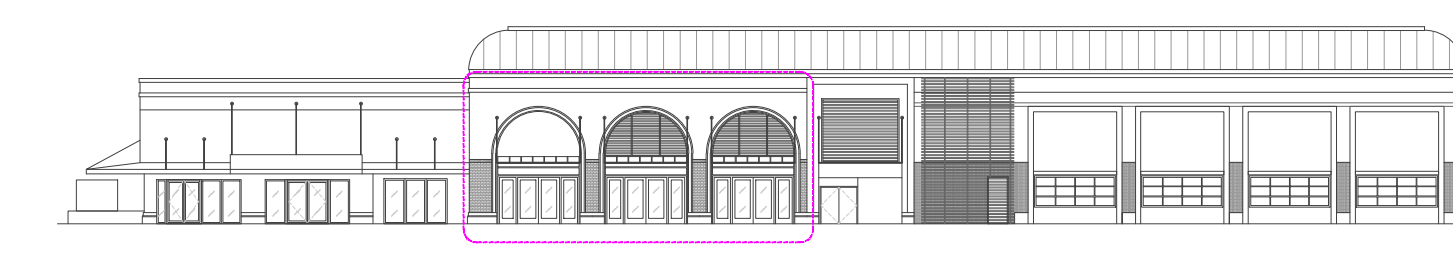

4 KEY ELEVATION
1/4" = 1'-0"

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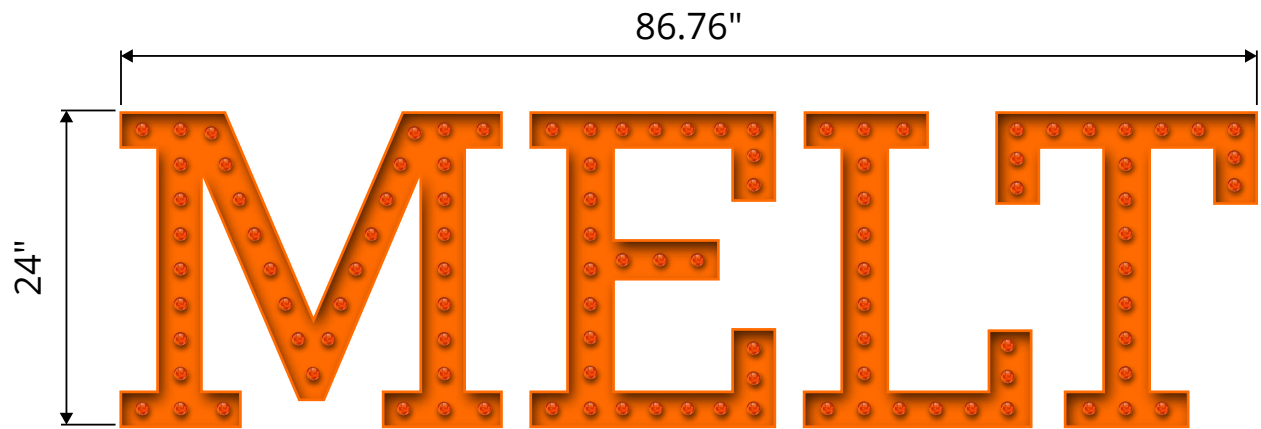
SHEET TITLE

**STOREFRONT
ELEVATIONS**

SHEET NUMBER

A08.01

14.46 SQ FT



1.1

PRIMARY SIGN ELEVATION

Scale : 3/4" = 1'-0"

1.1



1.3

PROPOSED FRONT ELEVATION

Scale: 1/8"=1'-0"

COLOR SCHEDULE


 PMS 1505C

DETAILS

- 5" DEEP OPEN FACE CHANNEL LETTERS
- INTERIOR & RETURNS PAINTED PMS 1505C
- ORANGE MINLEON LED G30 BULBS
- 3/4" SPACED OFF WALL (PMS 1505C)

FRONTAGE:
57'-0"

ALL COMPONENTS  LISTED

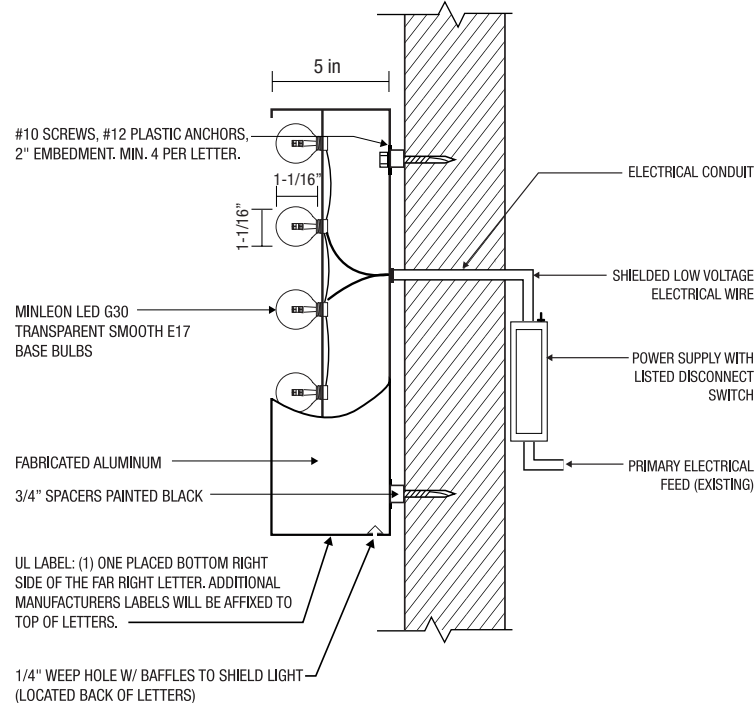

**** ALL BOLTS AND SCREWS ARE STAINLESS STEEL ****
ALL VISIBLE SCREWS MUST BE COUNTERSUNK AND PAINTED TO MATCH ADJACENT LETTER SURFACE

1.2

MOUNTING DETAILS

Scale: NTS

**** EACH SIGN WILL REQUIRE IT'S OWN 110 VOLT 20 AMP DEDICATED CIRCUIT PROVIDED BY OTHERS WITHIN 6' OF THE SIGN AREA AND ON A TIMER AND/OR PHOTOCCELL DEPENDING ON LOCAL SIGN REQUIREMENTS.**

IF NO ELECTRICAL IS PRESENT AT THE TIME OF INSTALLATION, A WHIP WILL BE LEFT FOR OTHERS TO MAKE FINAL ELECTRICAL CONNECTION.**



NIGHT SIMULATION



SIGNDESIGNLAB

Project Management | Signage
signdesignlab.com • sales@signdesignlab.com

(888) 735-7446

PROJECT INFORMATION COMPANY & LOCATION

The Melt
180 El Camino Real
Suite 705
Palo Alto, CA 94304

OVERVIEW

Exterior Signs

DATE PROJECT #

03/11/24 SDLP2538

DESIGNER

JEN

REVISIONS

APPROVAL

- ☐ APPROVED WITH NO CHANGES
☐ APPROVED WITH CHANGES AS NOTED
☐ REVISE AS NOTED AND RESUBMIT

Signature

Date

DESIGN

A11

SHEET

01 of 05

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16 SQ FT

128 in

18 in
6 in
WORLD'S *Meltiest* BURGER

2.1

SECONDARY SIGN ELEVATION

Scale : 5/8" = 1'-0"

COLOR SCHEDULE

-  PMS 1505C
 MATTHEWS WHITE

DETAILS


WORLD'S / BURGER
3" DEEP FRONT-LIT CHANNEL LETTERS
3/16" WHITE ACRYLIC FACE
WHITE TRIM CAPS
.040 ALUMINUM WHITE RETURNS
.063 ALUMINUM BACKS
UL APPROVED WHITE LED ILLUMINATION

MELTIEST
3" DEEP OPEN FACE CHANNEL LETTERS PAINTED ORANGE
RECESSED ALUMINUM FACE W/ ACRYLIC PUSH-THRU
RODS TO SIMULATE BULBS
UL APPROVED AMBER LED ILLUMINATION


57'-0" LINEAR FRONTAGE

ALL COMPONENTS  LISTED

MELTIEST

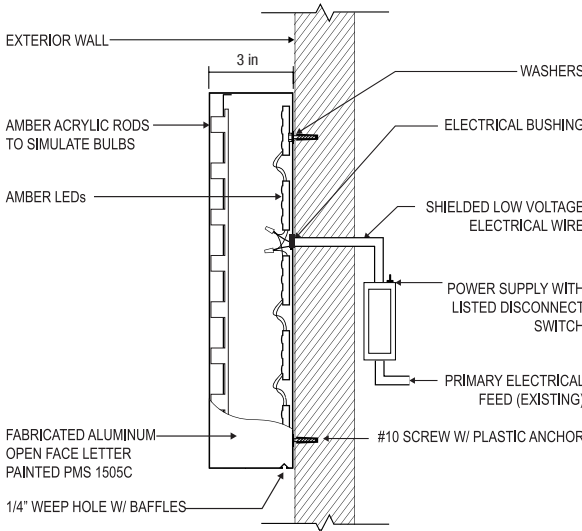

WORLD'S/BURGER

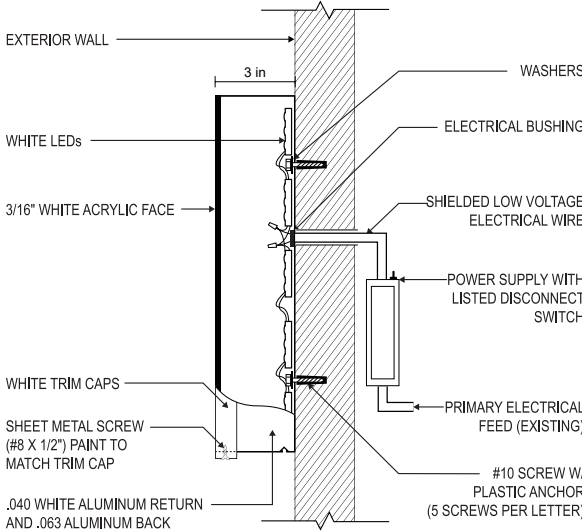

** ALL BOLTS AND SCREWS ARE STAINLESS STEEL **

2.2 MOUNTING DETAILS

Scale: NTS

WORLD'S *Meltiest* BURGER

NIGHT SIMULATION

2.3

PROPOSED FRONT ELEVATION

Scale: NTS



SIGNDESIGNLAB

Project Management | Signage
signdesignlab.com • sales@signdesignlab.com

(888) 735-7446

PROJECT INFORMATION
COMPANY & LOCATION

The Melt
180 El Camino Real
Suite 705
Palo Alto, CA 94304

OVERVIEW

Exterior Signs

DATE PROJECT #

03/11/24 SDLP2538

DESIGNER

JEN

REVISIONS

APPROVAL

- ☐ APPROVED WITH NO CHANGES
☐ APPROVED WITH CHANGES AS NOTED
☐ REVISE AS NOTED AND RESUBMIT

Signature

Date

DESIGN

A11

SHEET


02 of 05

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IF NO ELECTRICAL IS PRESENT AT THE TIME OF INSTALLATION, A WHIP WILL BE LEFT FOR OTHERS TO MAKE FINAL ELECTRICAL CONNECTION.**



End View

COLOR SCHEDULE

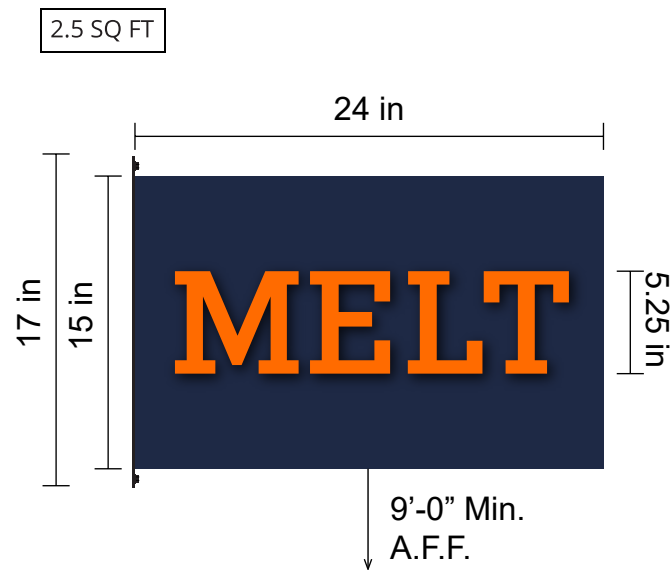- PMS 533C
- PMS 1505C
- MATTHEWS BLACK

DETAILS

3" DEEP FABRICATED ALUMINUM PAINTED PMS 533C
ROUTED-OUT ALUMINUM FACE W/ 1/2" THICK WHITE ACRYLIC PUSH-THRU
LETTERS WITH ORANGE TRANSLUCENT VINYL OVERLAYS
UL APPROVED WHITE LED ILLUMINATION
MOUNTING PLATE PAINTED BLACK

ALL COMPONENTS LISTED


ROUTED ALUMINUM FACE
PAINTED PMS 533C

POWER SUPPLY

1/2" PUSH-THRU WHITE
ACRYLIC WITH ORANGE
TRANSLUCENT VINYL
OVERLAYS

LED MODULES

MOUNTING PLATE
PAINTED BLACK

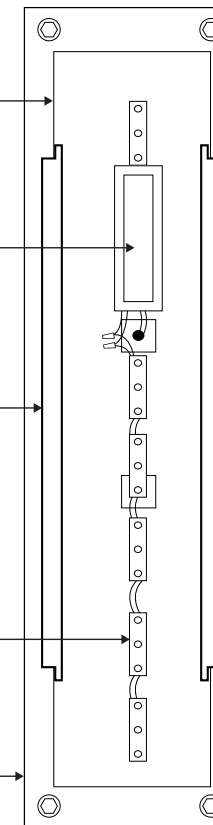

3.2 MOUNTING DETAILS

Scale : NTS

** EACH SIGN WILL REQUIRE IT'S OWN 110 VOLT 20 AMP
DEDICATED CIRCUIT PROVIDED BY OTHERS WITHIN 6' OF
THE SIGN AREA AND ON A TIMER AND/OR PHOTOCCELL
DEPENDING ON LOCAL SIGN REQUIREMENTS.

IF NO ELECTRICAL IS PRESENT AT THE TIME OF INSTALLATION,
A WHIP WILL BE LEFT FOR OTHERS TO MAKE FINAL
ELECTRICAL CONNECTION.**



3.3 PROPOSED SIGN LOCATION

Scale: NTS

MELT

NIGHT SIMULATION



SIGNDESIGNLAB

Project Management | Signage
signdesignlab.com • sales@signdesignlab.com

(888) 735-7446

PROJECT INFORMATION COMPANY & LOCATION

The Melt
180 El Camino Real
Suite 705
Palo Alto, CA 94304

OVERVIEW

Exterior Signs

DATE	PROJECT #
03/11/24	SDLP2538

DESIGNER

JEN

REVISIONS

APPROVAL

- ☐ APPROVED WITH NO CHANGES
- ☐ APPROVED WITH CHANGES AS NOTED
- ☐ REVISE AS NOTED AND RESUBMIT

Signature

Date

DESIGN

A11

SHEET

03 of 05

All original ideas, designs and signage
remain the property of Sign Design Lab
until paid in full.

Colors and designs are representations
of the final product. Final signage colors
and build will be based on
specifications noted on final proofs
and/or invoice.

1.46 SQ FT each

14.5 in

14.5 in



4.1

CIRCLE LOGO VINYL - QTY 2

Scale : 2" = 1'-0"

COLOR SCHEDULE

-  3M KUMQUAT ORANGE 3630-74
-  3M WHITE

DETAILS

- ▶ HP WHITE AND KUMQUAT ORANGE VINYL
- ▶ 2ND SURFACE



4.2

PROPOSED STOREFRONT ELEVATION

Scale : NTS



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Date


DESIGN

A11

SHEET

04 of 05

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5.1 **SITE MAP**
Scale: NTS

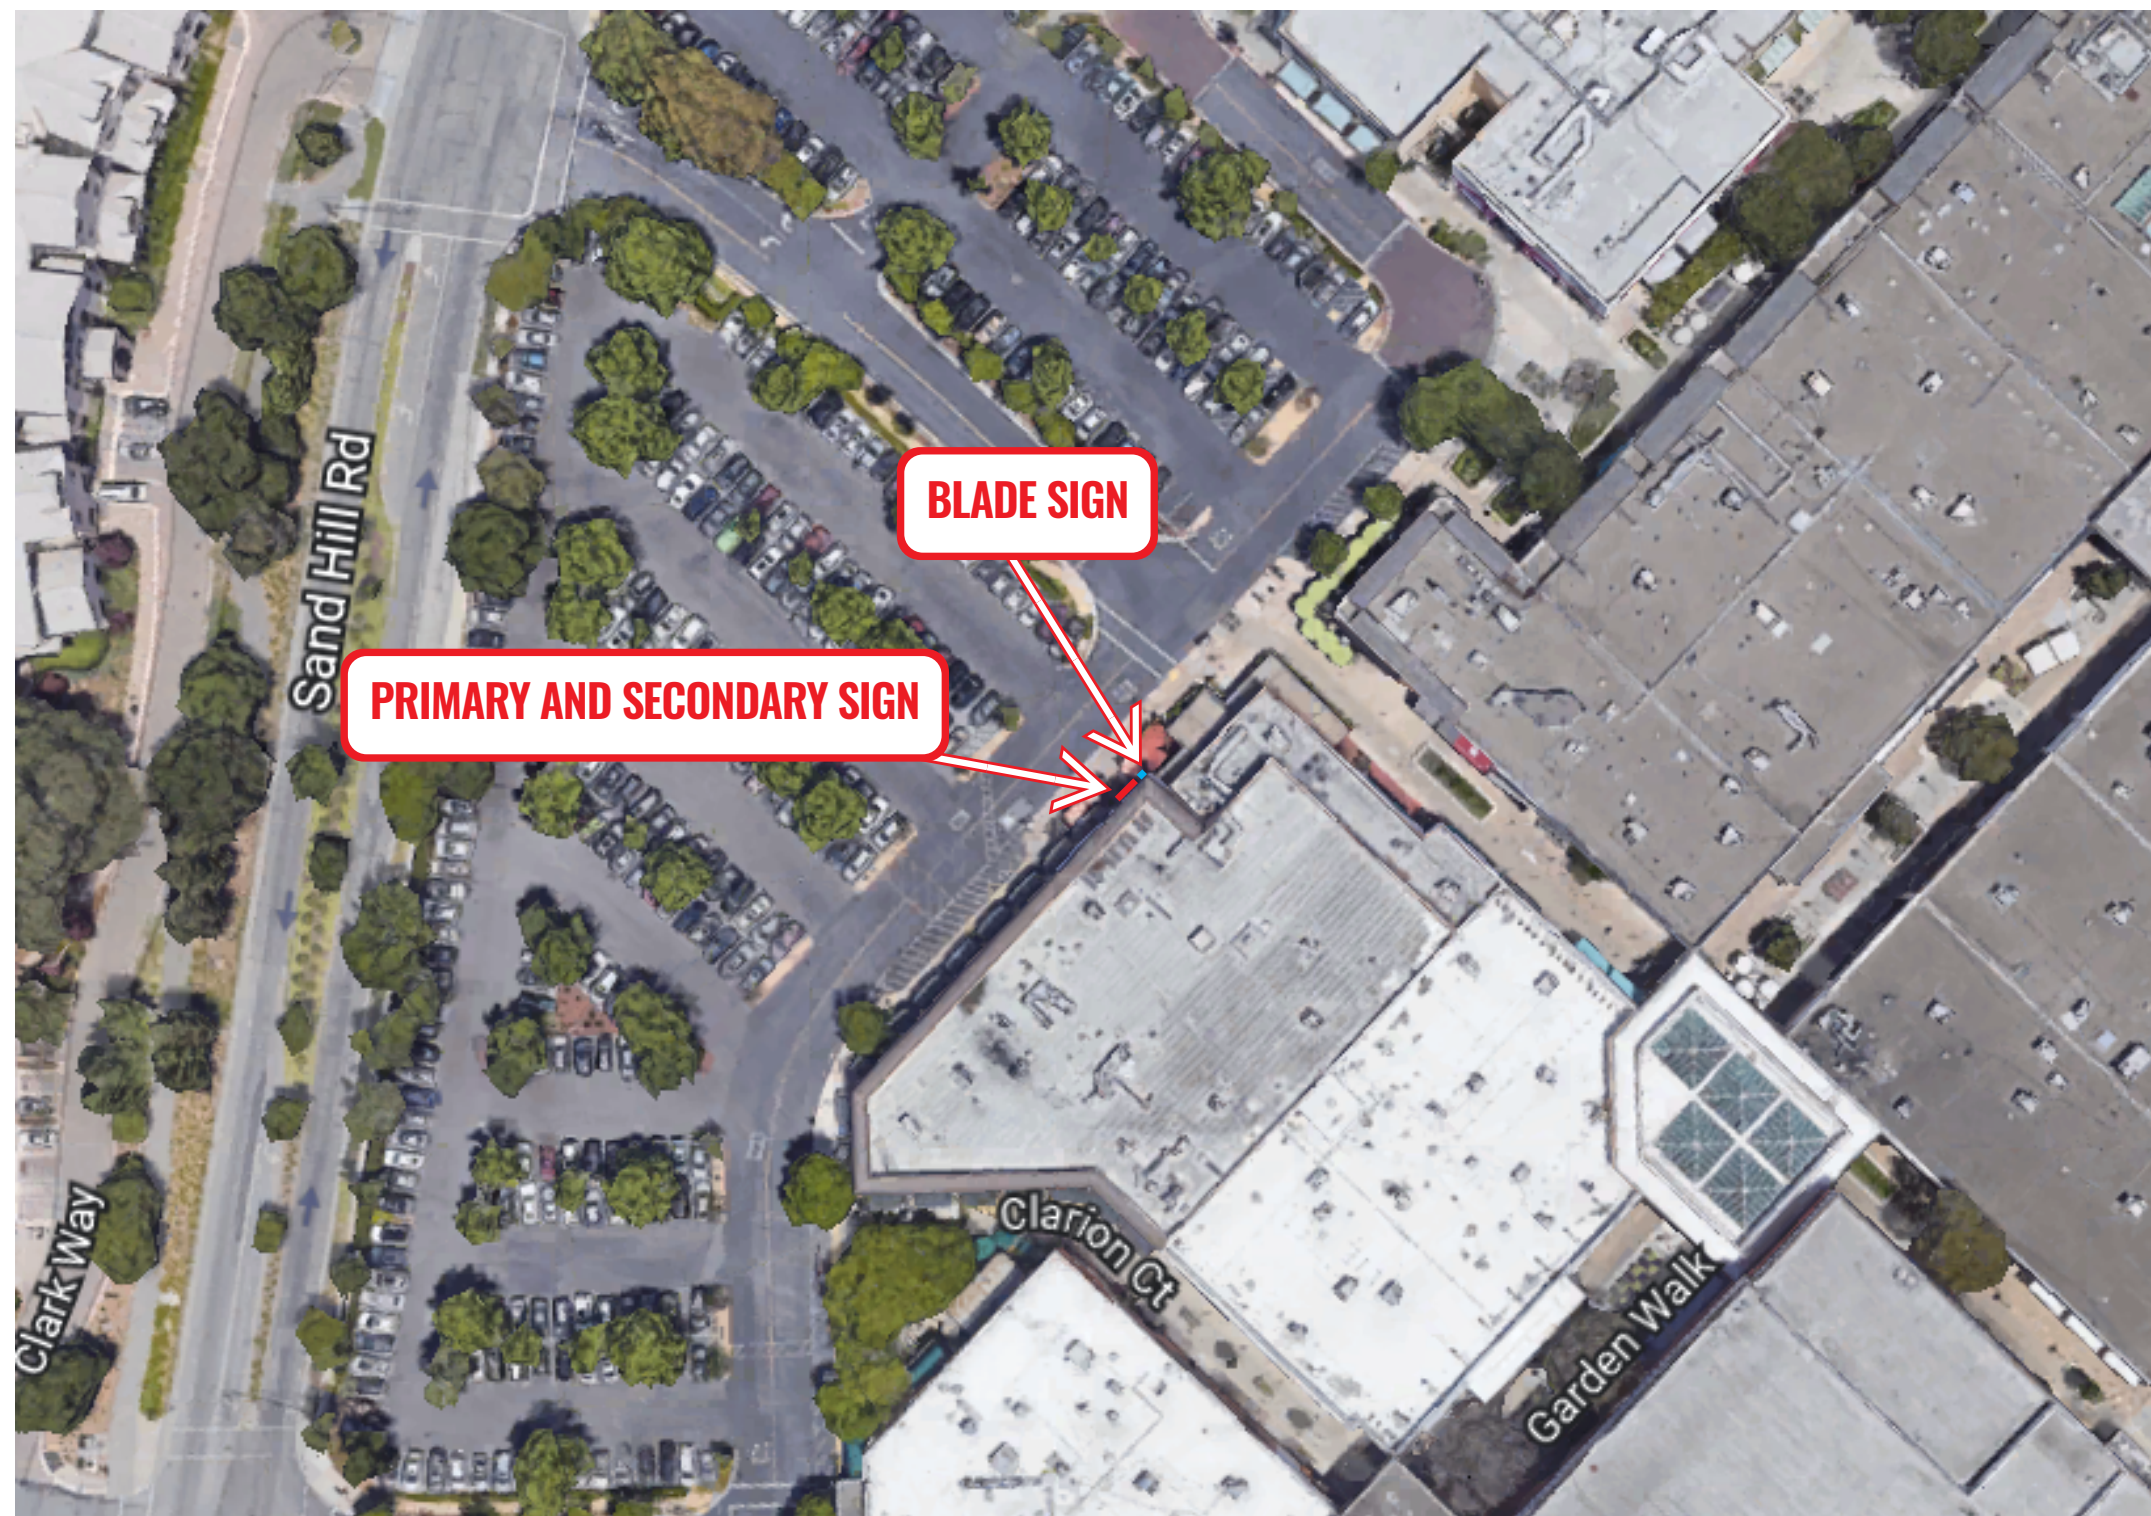Total signage: 35.88 sqft



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Exterior Signs

DATE	PROJECT #
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DESIGNER

JEN

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- ☐ APPROVED WITH CHANGES AS NOTED
- ☐ REVISE AS NOTED AND RESUBMIT

Signature

Date

DESIGN


A11

SHEET


05 of 05

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1 ELEVATION 1
3/8" = 1'-0"

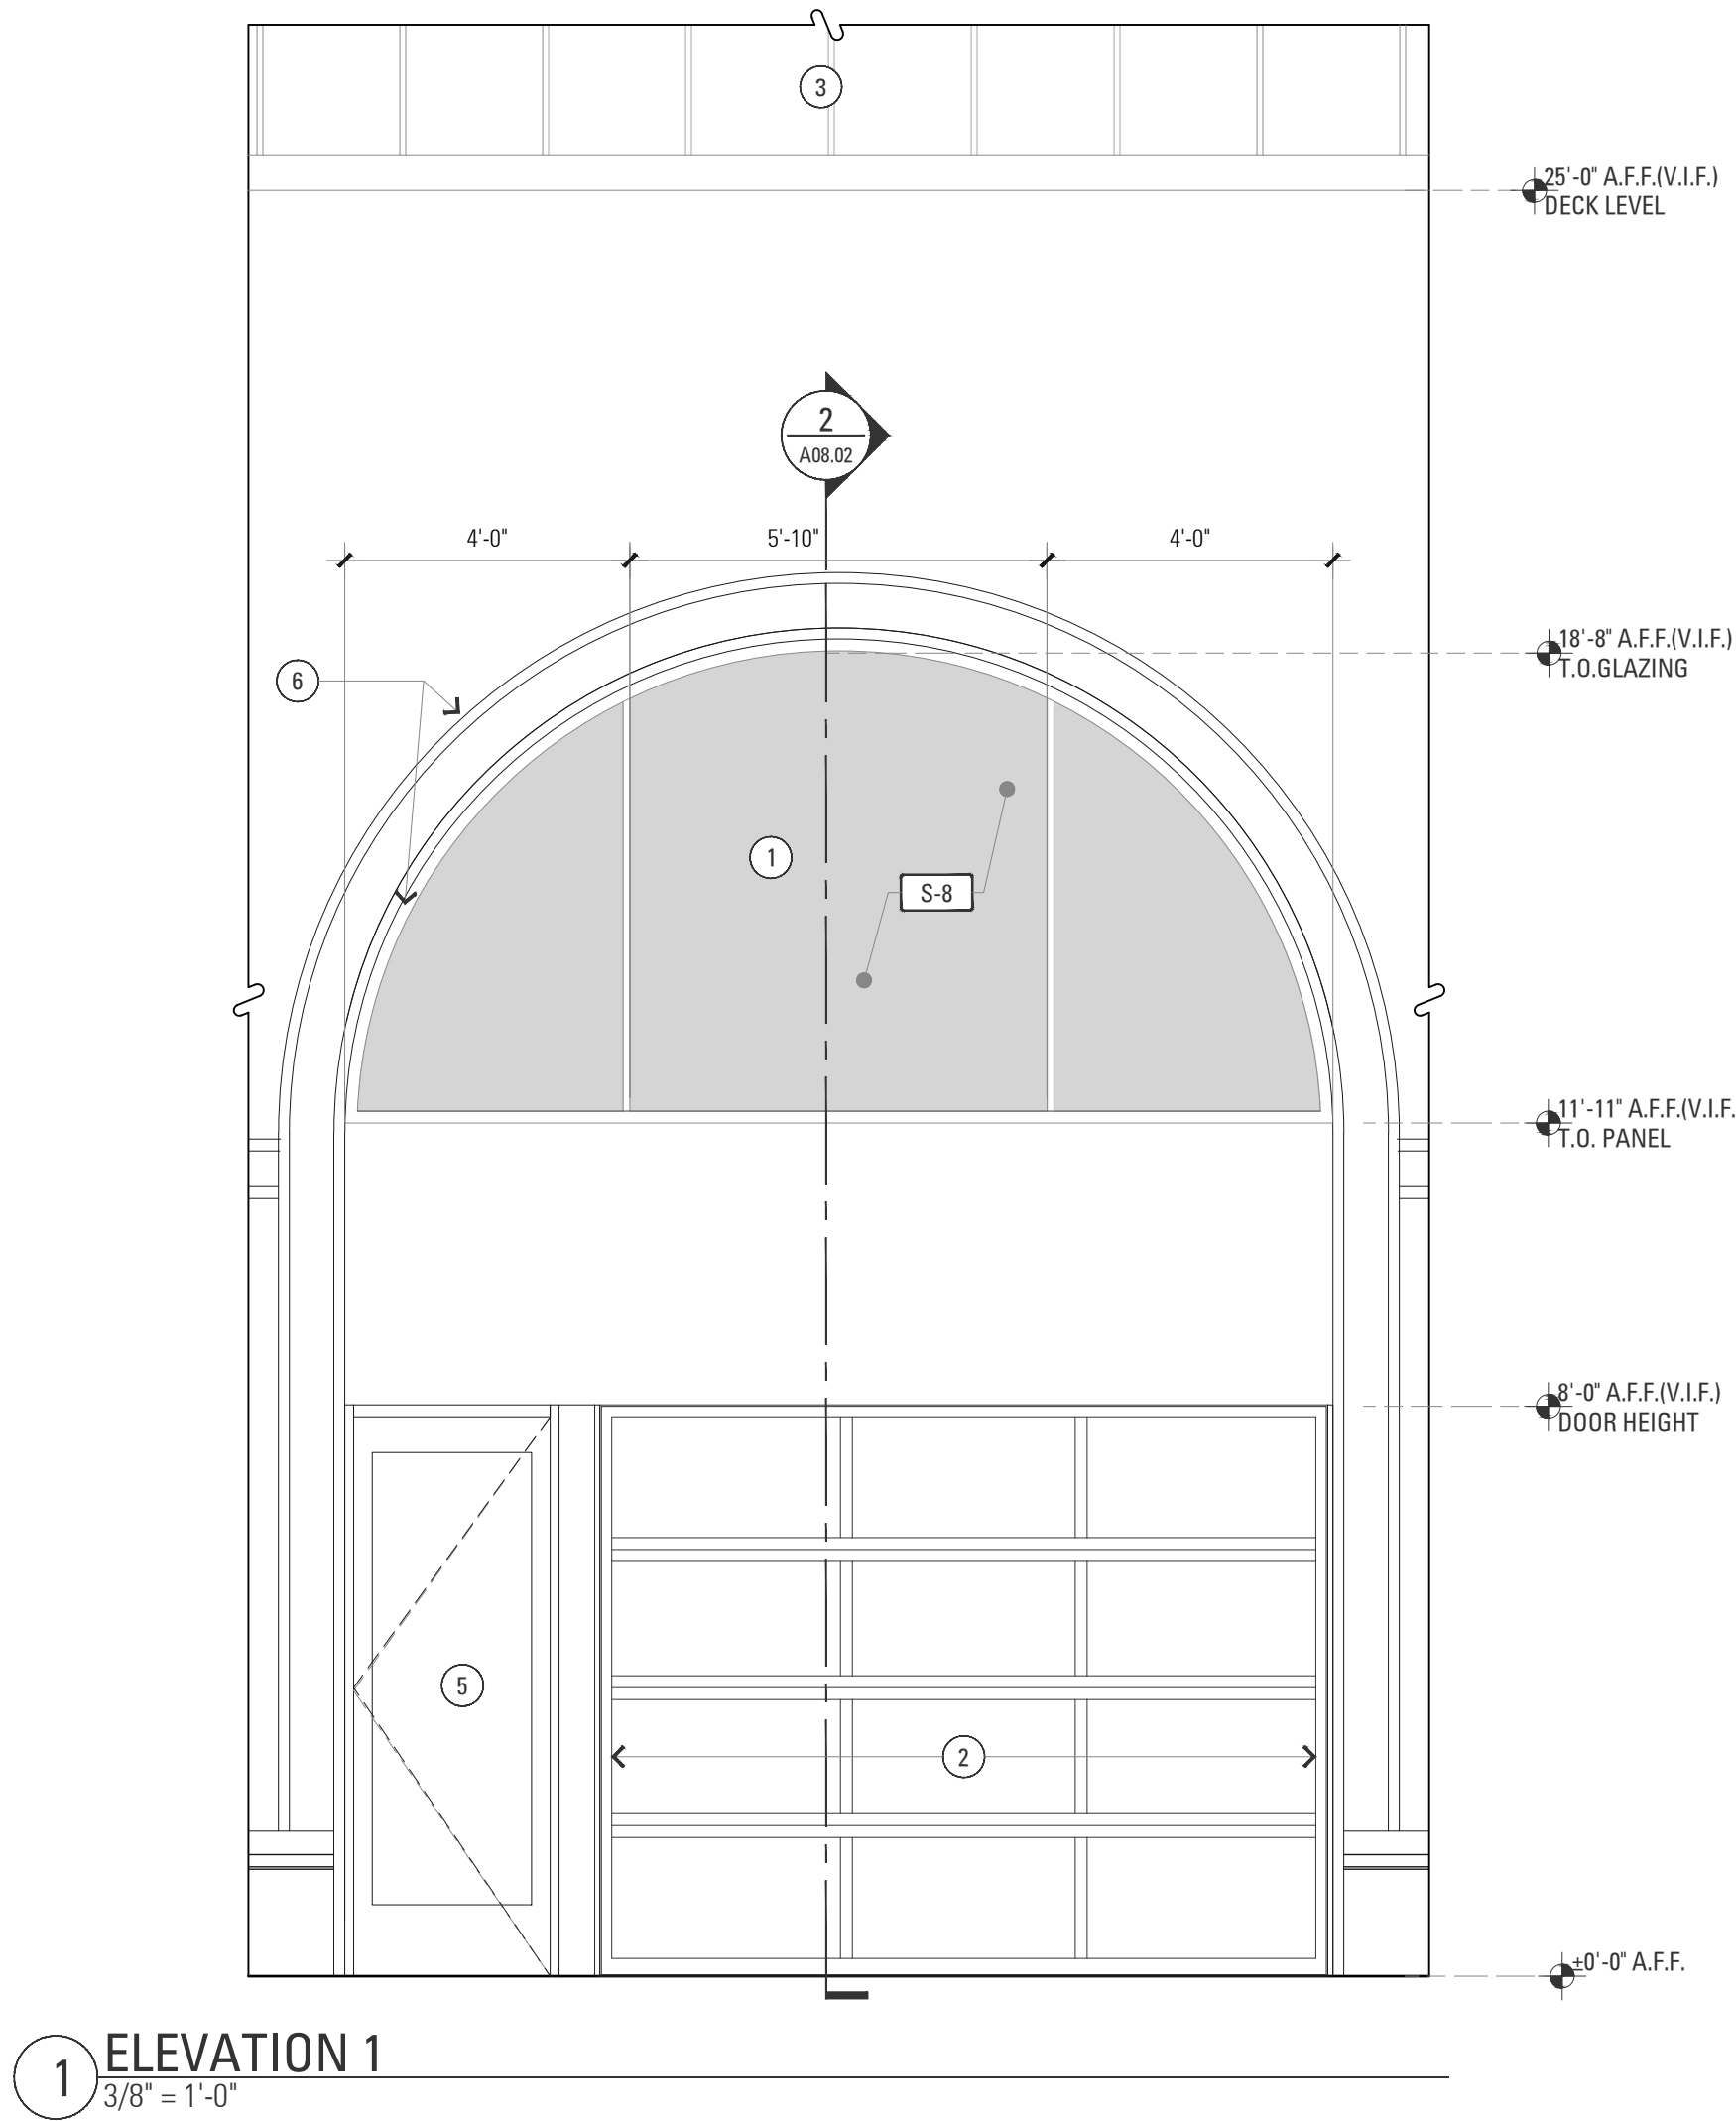


2 SECTION
1/2" = 1'-0"

ELEVATION KEY NOTES

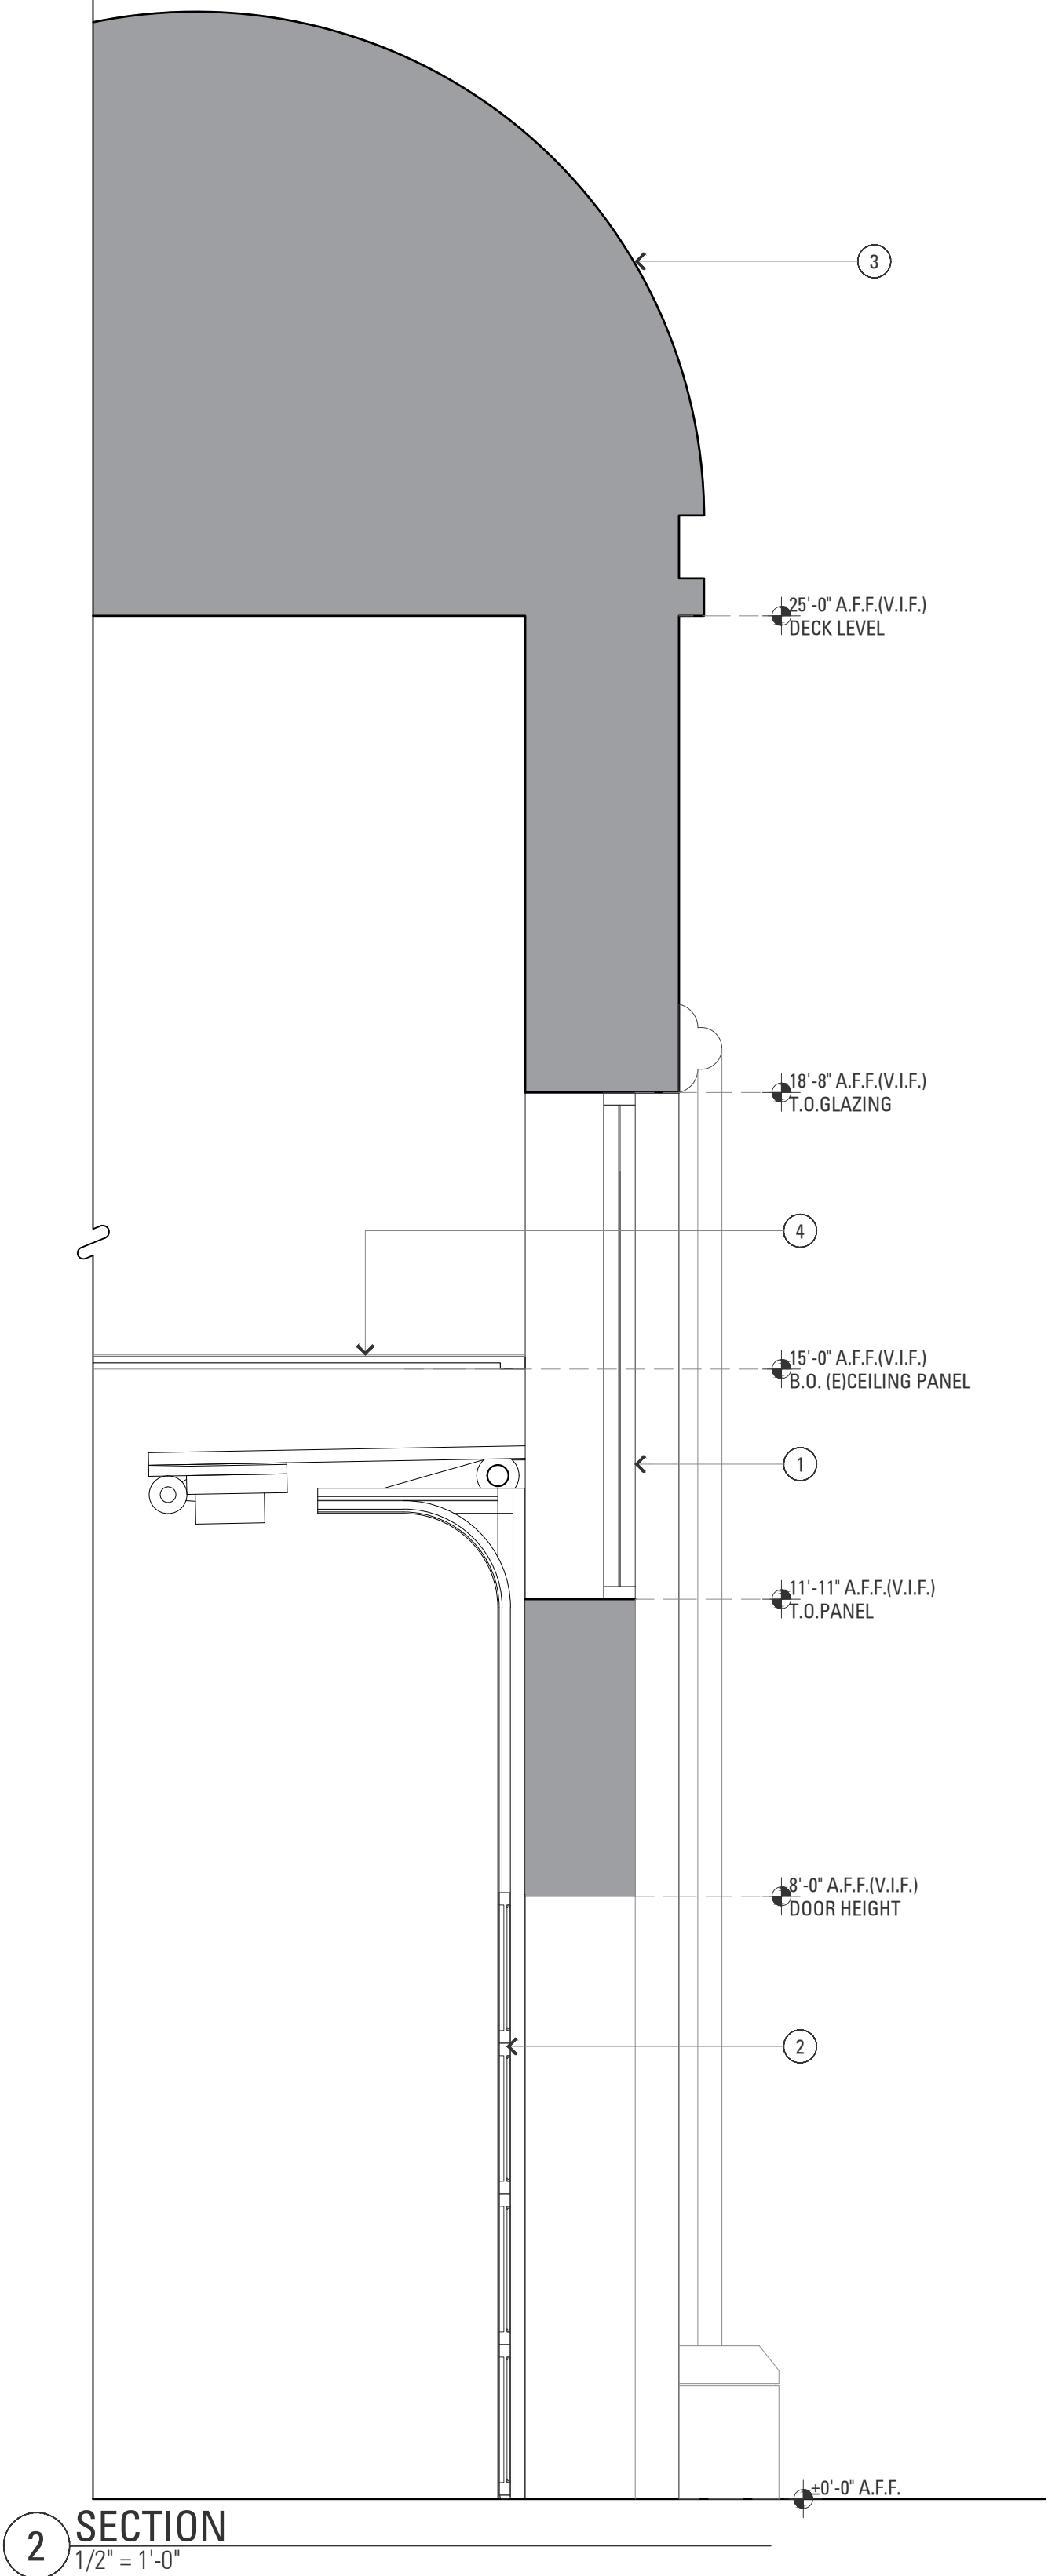- 1 NEW GLAZING
- 2 NEW RAYNOR GARAGE DOOR - D2
- 3 EXISTING METAL CORNICE/ ROOFING TO REMAIN
- 4 EXISTING CEILING
- 5 3' WIDE DOOR
- 6 NEW FLEX TRIM ON INNER AND OUTER CORNER OF EXISTING ARCH. SEE DETAIL 3/A08.02

3 DETAIL - FLEX TRIM MOULDING

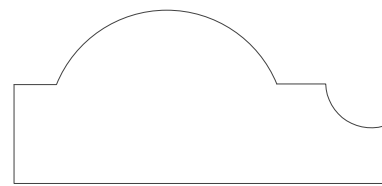

A9
9/16 X 1 1/4 IN.

ARCHITECT:

KATHRYN CULLEY-RAPATA, AIA
CA LICENSE NO. C-31564
CONTACT: KATE CULLEY-RAPATA
PH: 510-459-5136

STAMP & SEAL:

PROJECT CONSULTANT:



globeateliê
2041 EAST STREET PMB 475
CONCORD CA 94520

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CLIENT:

theMELT

THE MELT, STANFORD

180 EL CAMINO REAL, SUITE 705A, BLDG. E,
PALO ALTO, CALIFORNIA 94304

PROJECT:

PROJECT#: GA21-MLT004

DOCUMENT DATE: 06-12-24

DOCUMENT PHASE:

ARB SUBMITTAL REV 03

DATE	ISSUE
07-05-22	ARB SET
09-25-23	REVISION 01
06-12-24	REVISION 02
07-17-24	REVISION 03

DRAWN BY: AA

CHECKED BY: AR

SHEET TITLE

STOREFRONT
DETAILS

SHEET NUMBER

A08.02

ZERO WASTE FOR PROJECT IN PALO ALTO

AS PER PALO ALTO MUNICIPAL CODE 5.20.108 THE SITE IS REQUIRED TO HAVE COLOR-CODED REFUSE CONTAINERS, RELATED COLOR-CODED MILLWORK, AND COLORED SIGNAGE. THE THREE REFUSE CONTAINERS SHALL INCLUDE RECYCLE (BLUE CONTAINER), COMPOST (GREEN CONTAINER), AND GARBAGE (BLACK CONTAINER). APPLICANT SHALL PRESENT ON THE PLAN THE LOCATIONS AND QUANTITY OF BOTH (ANY) INTERNAL AND EXTERNAL REFUSE CONTAINERS, IT'S MILLWORK, ALONG WITH THE SIGNAGE. THIS REQUIREMENT APPLIES TO ANY EXTERNAL OR INTERNAL REFUSE CONTAINERS LOCATED IN COMMON AREAS SUCH AS ENTRANCES, OFFICE, BACK OF THE HOUSE KITCHEN, FRONT OF THE HOUSE DINING AREA, AND ETC. EXCEPT FOR RESTROOMS, COPY AREA, AND MOTHER'S ROOM. MILLWORK TO STORE THE COLOR-CODED REFUSE CONTAINERS MUST HAVE A MINIMUM OF FOUR INCHES IN HEIGHT, WRAPPING AROUND THE FULL WIDTH OF THE MILLWORK. SIGNAGE MUST BE COLOR CODED WITH PHOTOS OR ILLUSTRATIONS OF COMMONLY DISCARDED ITEMS. RESTROOMS MUST HAVE A GREEN COMPOST CONTAINER FOR PAPER TOWELS AND AN OPTIONAL BLACK LANDFILL CONTAINER IF APPLICABLE. COPY AREA MUST HAVE EITHER A RECYCLE BIN ONLY OR ALL THREE REFUSE RECEPTACLES (GREEN COMPOST, BLUE RECYCLE, AND BLACK LANDFILL CONTAINER). MOTHER'S ROOM MUST MINIMALLY HAVE A GREEN COMPOST CONTAINER AND BLACK LANDFILL CONTAINER. PLEASE REFER TO PAMC 5.20.108 AND THE INTERNAL CONTAINER GUIDE. EXAMPLES OF APPROPRIATE SIGNAGE CAN BE FOUND IN THE MANAGING ZERO WASTE AT YOUR BUSINESS GUIDE. ELECTRONIC COPIES OF THESE SIGNAGE CAN BE FOUND ON THE ZERO WASTE PALO ALTO'S WEBSITE, [HTTPS://WWW.CITYOFPALOALTO.ORG/DEPARTMENTS/PUBLIC-WORKS/](https://www.cityofpaloalto.org/departments/public-works/) ZERO-WASTE/ WHAT-GOES-WHERE /TOOLKIT#SECTION-2 AND HARD COPIES CAN BE REQUESTED FROM THE WASTE HAULER, GREENWASTE OF PALO ALTO, (650) 493-4894



1 ZERO WASTE POSTER
N.T.S.

2 ZERO WASTE POSTER
N.T.S.



3 NOT USED
N.T.S.

ARCHITECT:

KATHRYN CULLEY-RAPATA, AIA
CA LICENSE NO. C-31564
CONTACT: KATE CULLEY-RAPATA
PH: 510-459-5136

STAMP & SEAL:

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DRAWN BY: AA
CHECKED BY: AR
SHEET TITLE

ZERO WASTE SHEET

SHEET NUMBER

X.01

The Melt, Stanford Shopping Center – Palo Alto, CA

Shimstone Design Studio
LIGHTING DESIGN

LIGHTING FIXTURE SCHEDULE – PERMIT SET (NOT FOR CONSTRUCTION)					
Type	Location	Description	(Qty) Lamp	Manufacturer, & Series No	Input Watts
XL1	Exterior Façade	Surface-mounted low voltage linear LED tape w/ extruded channel, outdoor rated.	Integral LED, 2700K, CRI 90+	Feelux, FTP15-27K-24V-C90	5.5 W/ft
XL2	Exterior Terrace	Exterior LED string lights	(15) G25 LED, 2700K	Rejuvenation, A4126	375w
XS1	Exterior Terrace	Brass low voltage wall sconce, downlight only	(1) LED MR16, 2700K	Steel Cable: A9915	Allow 60 W
XS2	Exterior Terrace	Terrace Sconce Down Light	Integral LED, 2700K, CRI 90+	Mini Lbs. HL-340S-(finish)-8LED-FL-12V	8 W
				Remarks	
				Provide brackets and accessories as required for complete installation. Field cuttable. IP66 rating for Outdoor use. Remote power supply required. UL listed for Wet locations.	
				UL listed for Wet locations. Provide single lamp for downwards illumination only. Remote 12V transformer required. UL listed for Wet locations. Remote 12V transformer required.	

REJUVENATION



REJUVENATION



Steel Cable & Hooks for Commercial String Lights
Item #A9915
<http://www.rejuvenation.com/b18my6>

Specification	Detail
Item #	A9915
Width	60"
Working Load Limit	100 lbs.
Cable Thickness	1/16"

Price as shown : \$60.00
Shipping and handling not shown

15 G25 Clear LED Bulb String Lights
Item #A4126
<http://www.rejuvenation.com/a18gth>

Specification	Detail
Item #	A4126
Width	48 feet
Sockets	15

Maximum Wattage per Socket 25W MAX per socket
Spacing sockets are 3 feet apart
Price as shown : \$250.00
Shipping and handling not shown

COMPONENTS



Mounting Brackets
_FTP-BRACKET1



FTP Extrusion Line
_FTP-EXL (1200mm)



Indoor Power Cable
_FTP-INPC (200mm) with END CAP



Indoor Direct Connector
_FTP-INCPCL



Shimstone Design Studio
LIGHTING DESIGN

The Melt: Stanford Shopping Center
Palo Alto, CA

FEELUX

FLXible LED Tape Pro

* Finished view

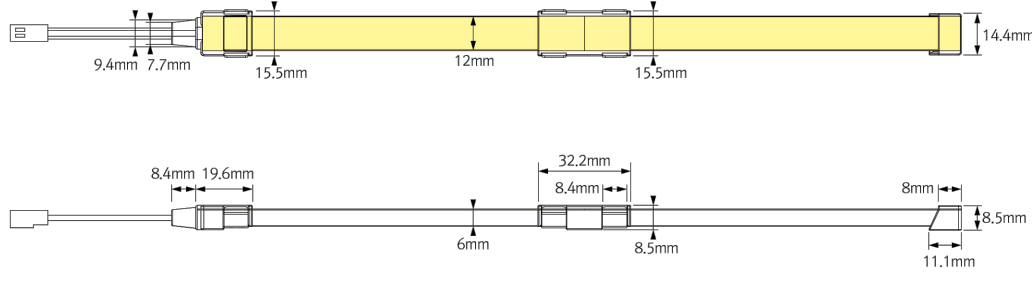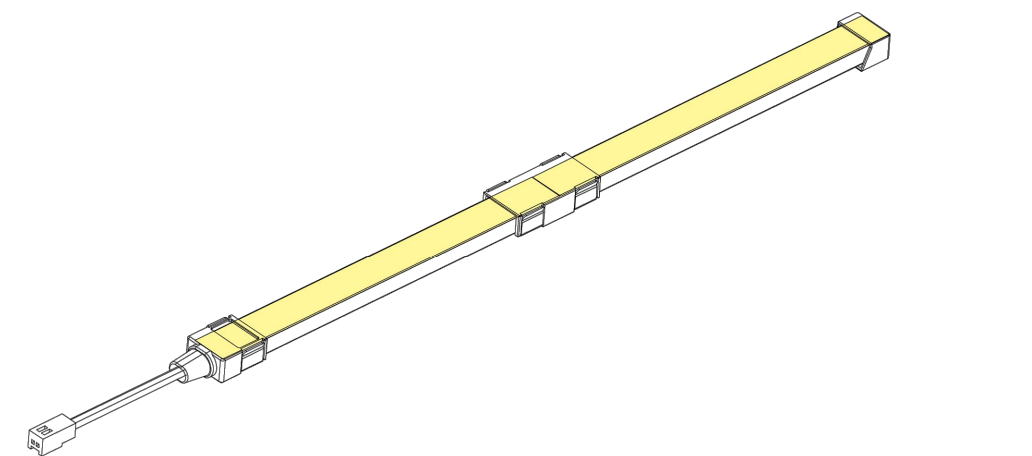

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5

SDS PROJECT #: 0609.0 MODEL #: REFER TO LIGHTING FIXTURE SCHEDULE FOR MODEL NUMBER AND DESCRIPTION TYPE: XL1

Shimstone Design Studio LLC, 7400 1st Avenue, North Bergen, NJ 07047, Tel: 201.861.5390


Shimstone Design Studio
LIGHTING DESIGN

The Melt: Stanford Shopping Center
Palo Alto, CA

FEELUX


FLXible LED Tape Pro

INSTALLATION – Extrusion

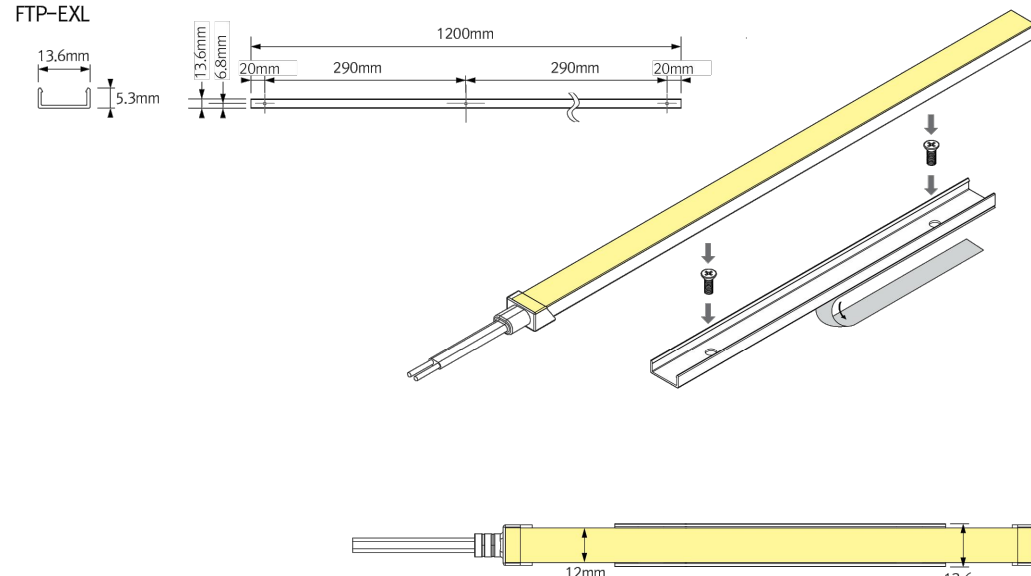

INSTALLATION – Indoor Termination (IP20)

* Components

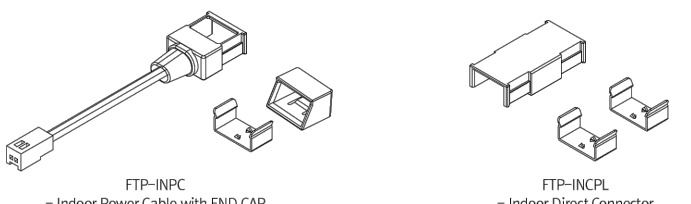

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3

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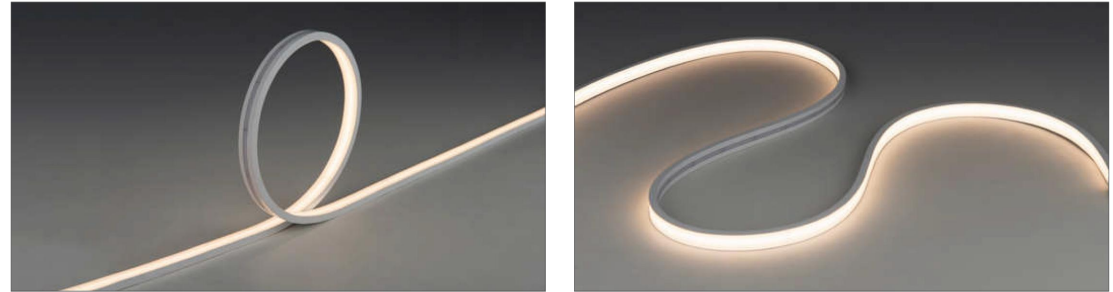
Shimstone Design Studio
LIGHTING DESIGN

The Melt: Stanford Shopping Center
Palo Alto, CA

FEELUX

FLXible LED Tape Pro

PRODUCT IMAGE



PRODUCT FEATURES

- Seamless Dot-Free Illumination
- Ultra Slim
- High Efficiency / High Output
- High CRI (93 S9)
- Clear PMMA Lens
- Bend Direction Vertically
- Color Rendering 90/90
- Operating Temperature Ranges: 0-40°C
- Beam Angle: 110°
- Available in Standard Lengths of 5M reels
- Dimmable


PRODUCT SPECIFICATIONS

IP Rate	IP66 with Factory Termination (Customized Length Available)
Lamp Power	15W/m
Power Input	24V DC
Color Rendering	90/90
Operating Temperature Ranges	0-40°C
Beam Angle	110°
Material	Silicon
Available Color	2700K, 3000K, 3500K, 4000K

SPECIFICATIONS TABLE


Model Number	Color	Lamp Power	Luminous Flux (lm/ft)	Lumen/W
FTP15-27K-24V-C90	2700K	4.2W/ft	415lm	98.24/LW
FTP15-30K-24V-C90	3000K	4.2W/ft	440lm	103.02/LW
FTP15-35K-24V-C90	3500K	4.2W/ft	465lm	109.44/LW
FTP15-40K-24V-C90	4000K	4.4W/ft	476lm	108.77/W

PHYSICAL SPECIFICATIONS

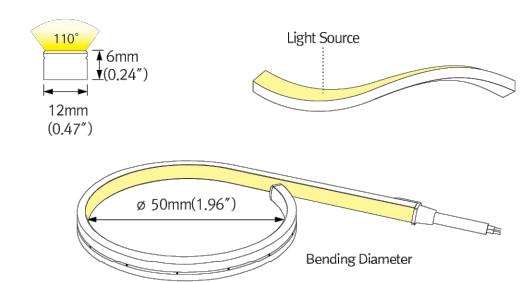

PHYSICAL SPECIFICATIONS

Model Number	A Length	B Cable Core Width	C Ch Width	D Thickness
FTP15-24V-C90	1,013mm (39.84")	33.3mm (1.31")	12mm (0.47")	6mm (0.24")

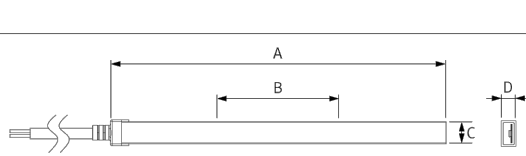

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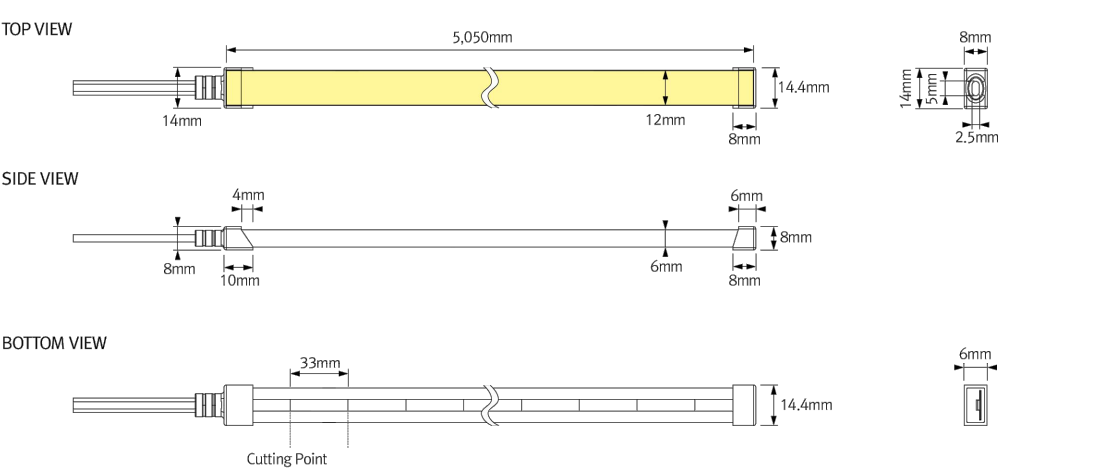
Shimstone Design Studio
LIGHTING DESIGN

The Melt: Stanford Shopping Center
Palo Alto, CA


FEELUX

FLXible LED Tape Pro

DIMENSIONS



INSTALLATION – Bracket

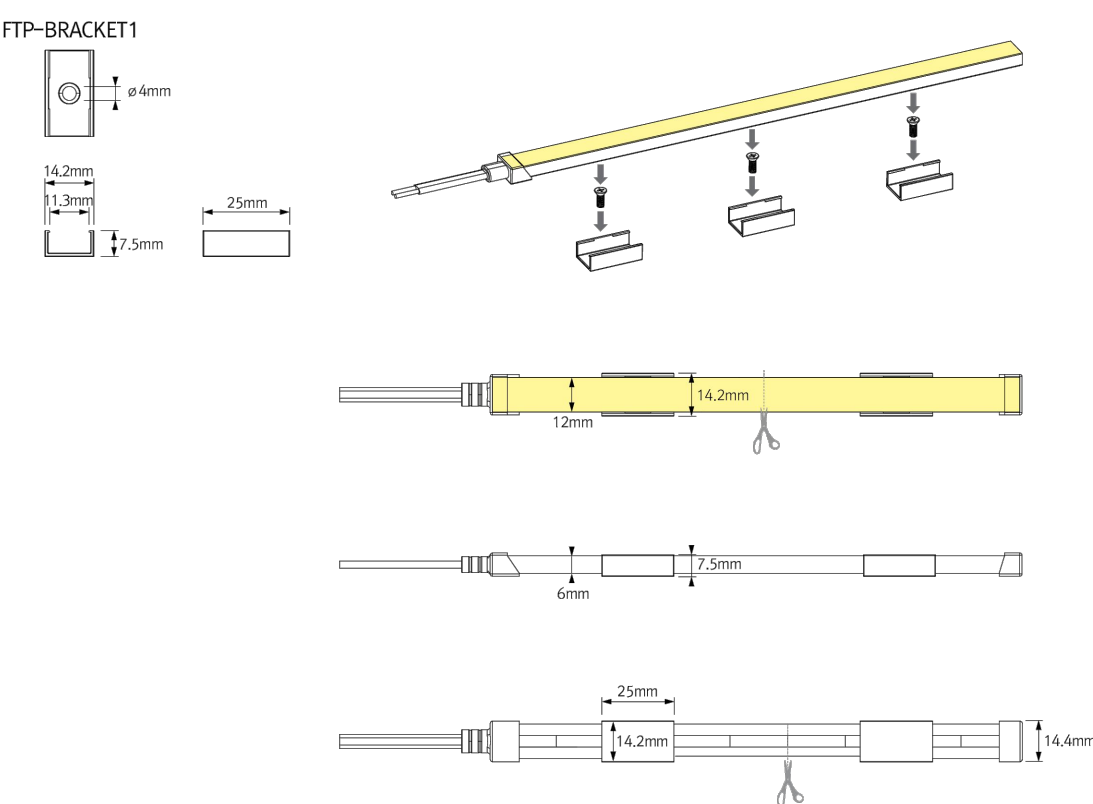

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2

SDS PROJECT #: 0609.0 MODEL #: REFER TO LIGHTING FIXTURE SCHEDULE FOR MODEL NUMBER AND DESCRIPTION TYPE: XL1

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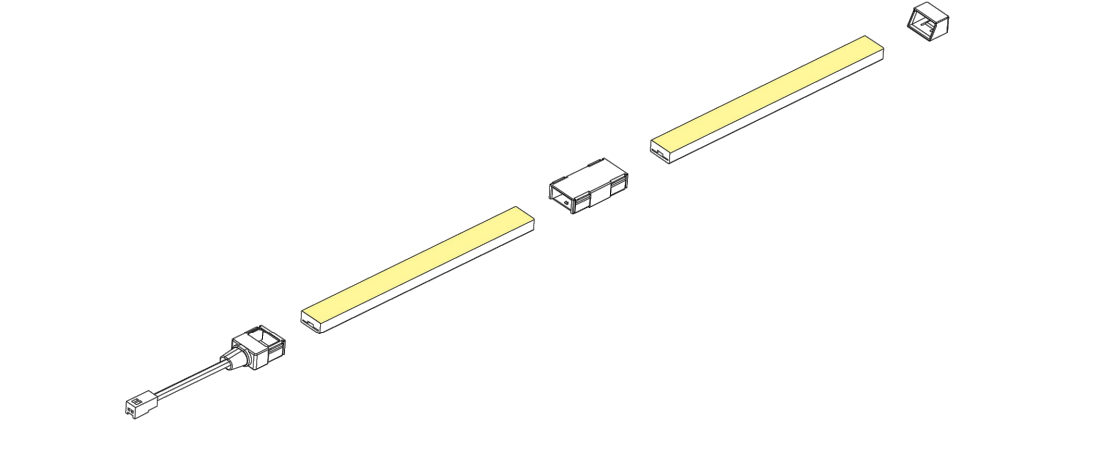
Shimstone Design Studio
LIGHTING DESIGN

The Melt: Stanford Shopping Center
Palo Alto, CA


FEELUX

FLXible LED Tape Pro

* Expanded View



* Installation Method

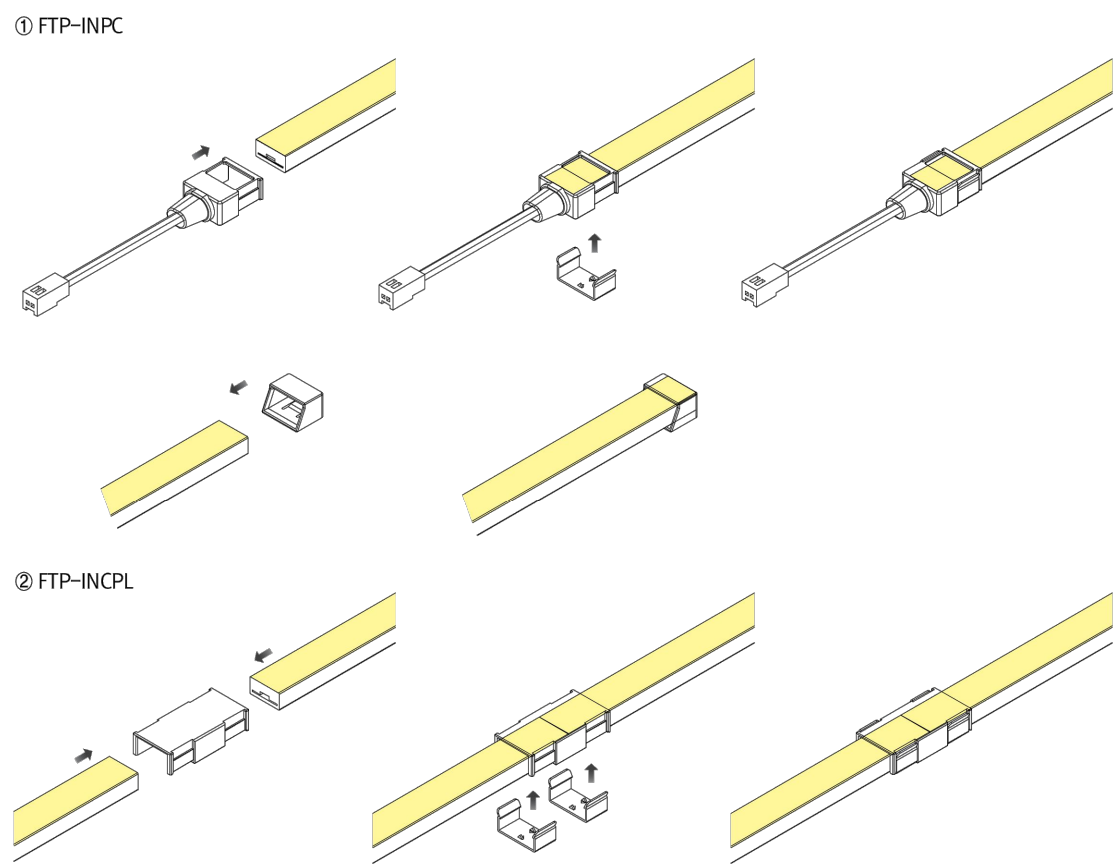

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4

SDS PROJECT #: 0609.0 MODEL #: REFER TO LIGHTING FIXTURE SCHEDULE FOR MODEL NUMBER AND DESCRIPTION TYPE: XL1

Shimstone Design Studio LLC, 7400 1st Avenue, North Bergen, NJ 07047, Tel: 201.861.5390

Shimstone Design Studio
LIGHTING DESIGN

The Melt: Stanford Shopping Center
Palo Alto, CA

PRODUCT SPECIFICATIONS


VOLT®

VOLT® Low Voltage Landscape Lighting
VOLT® Ultra Premium Up/Down Sconce- VHS-650-4-BBZ

Product Description

The Ultra Premium Up/Down Sconce light is probably the finest up/down low voltage landscape lighting sconce on the market. It has many unique features, such as glass lenses that have etched edges, enabling the center of the glass to be flush 1mm above the top of the brass. This feature prevents any water from puddling or collecting on top. The body of the fixture is threaded and screws together tightly with an O-ring seal, making it completely water proof. These luminaires offset further from wall, so light does not get blocked by aggregate surfaces or header cap stones. Plus, the offset also allows for better photometrics/illumination than other sconce designs. These are very heavy at 3 lbs of solid cast brass, with a sturdy 1-piece arm and mounting. They are much larger than what you'd typically find with other brands (7" x 4 1/2"). The Ultra Premium Up/Down Sconce features a bronze finish, has a 16G SPT-2 tinned copper lead wire, beryllium copper sockets, heat shrink tubing over internal splice, UL braided sleeve protectors, and two sockets pre-greased with dielectric grease. Uses two MR16 lamps (sold separately). Comes with a lifetime replacement warranty.

Product Dimensions

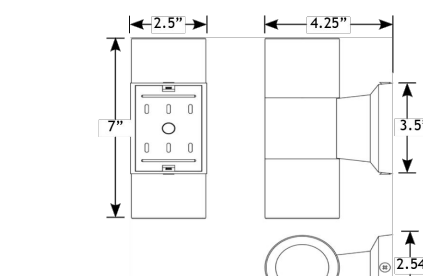

Features & Benefits

- Solid Brass
- Pre-aged finish- a natural patina that does not corrode
- Beryllium copper socket - more corrosion resistant than copper
- Pressure rubber gasket for a moisture tight design

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www.voltlighting.com

SDS PROJECT #: 0609.0 MODEL #: REFER TO LIGHTING FIXTURE SCHEDULE FOR MODEL NUMBER AND DESCRIPTION TYPE: XS1

Shimstone Design Studio LLC, 7400 1st Avenue, North Bergen, NJ 07047, Tel: 201.861.5390

ARCHITECT:

KATHRYN CULLEY-RAPATA, AIA
CA LICENSE NO. C-31564
CONTACT: KATE CULLEY-RAPATA
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DRAWN BY: AA


CHECKED BY: AR

SHEET TITLE

LIGHTING CUT
SHEETS

SHEET NUMBER

X.02

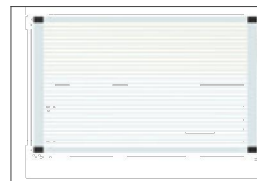

8.0' x 12.0'
2.45m x 3.65m

total height trellis roof (includes 2" base)	total height fixed water resistant roof (includes 2" base)	head clearance	retractable roman shade	maximum width	maximum length	frame length (center to center of columns)	frame width (center to center of columns)	pole section dimensions	bench frame height	bench seat height w/cushion	bench seat depth	cushion thickness	full bed height w/cushion
a	b	c	d	e	f	g	h	i	j	k	l	m	n
(in/cm)	(in/cm)	(in/cm)	(in/cm)	(in/cm)	(in/cm)	(in/cm)	(in/cm)	(in/cm)	(in/cm)	(in/cm)	(in/cm)	(in/cm)	(in/cm)

110/279 114 / 290 106 / 269 104 / 264 144 / 366 96 / 244 140 / 356 92 / 234 4 / 10 14 / 36 18 / 46 34 / 86 4 / 10 n/a

TUUCI SOLANOX CABANA - 12' X 8' WITH HEATER AND FIXED OPEN TRELLIS ROOF

NOTE : SHOWN FOR DESIGN INTENT. STRUCTURAL DRAWINGS TO BE INCLUDED IN TI PERMIT DRAWINGS

1 CABANA SPECIFICATIONS

ocean master **MAX** single cantilever

premium parasols

The Ocean Master MAX Single Cantilever is simply art and engineering harmonizing in a symphony of shade. The polished and anodized marine-grade canopy structure cantilevers from a sturdy, oval-shaped mast inspired by sailing yachts. With the combined features of an ultra strong aluminum filled fulcrum and automatic telescoping mast, the shade canopy easily closes over tables and chairs.

finish options

standard

polished aluminum

powder coat

textured bright white

sea shell white

espresso

ash grey

hammered bronze

jet black

shapes & sizes

square

ft. / m.

8'0" / 2.45

***10'0" / 3.0

***12'0" / 3.65

***13'0" / 4.0

octagon

ft. / m.

8'0" / 2.75

***11'0" / 3.4

***13'0" / 4.0

rectangle

ft. / m.

8'6" x 12' / 2.45 x 3.65

***10' x 14' / 3.0 x 4.25

options

high-wind stabilizers

**optional high-wind stabilizers

***includes high-wind stabilizers

final options

MAX acorn

features:

a. Patented Independent Bracket Hub System

b. Telescoping Mast with "Easy Drive" Crank Lift System

c. Marine Grade Aluminum Components

d. Cantilever Stem Cover Plate

e. V-MAX Reinforced Strut Design

f. Ballistic Reinforced/Screw Pocket Construction

g. Reinforced Strut Joints Connector

h. Cam Lock Lever – Allows 360° Rotation

i. Easily Replaceable Parts

global headquarters

2000 NW 35th Street, Miami, FL 33142 USA | 305.694.5116 | info@tuuci.com

europaen office

Nedenvorder 17, 5061 JP Oisterwijk, The Netherlands | +31.13.522.0471 | info@tuuci.eu

tuuci.com

v.06.13.17

TUUCI OCEAN MASTER MAX CANTILEVER UMBRELLA 8' X 8' & RADIANT HEATER

2 UMBRELLA SPECIFICATIONS

features:

a. Patented Independent Bracket Hub System

b. Telescoping Mast with "Easy Drive" Crank Lift System

c. Marine Grade Aluminum Components

d. Cantilever Stem Cover Plate

e. V-MAX Reinforced Strut Design

f. Ballistic Reinforced/Screw Pocket Construction

g. Reinforced Strut Joints Connector

h. Cam Lock Lever – Allows 360° Rotation

i. Easily Replaceable Parts

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